GO CAR WASH - FAIRPORT PERINTON

FAIRPORT, NY, USA
CAR WASH DESIGN PACKAGE
DRAWING LIST

	DRAWING	
PAGE	NUMBER	DRAWING TITLE
1	SE22-269-TP	TITLE PAGE
2	SE22-269-G1	GENERAL NOTES & RESPONSIBILITIES
3	SE22-269-L	EQUIPMENT LAYOUT - PLAN VIEW
4	SE22-269-L1	EQUIPMENT LAYOUT - SCHEDULE 1
5	SE22-269-EC	ELECTRICAL CONTROLS & LIGHTING - BACKROOM CONDUITS & WASH BAY RUNS
6	SE22-269-EM	ELECTRICAL MOTORS - BACKROOM CONDUITS & WASH BAY RUNS
7	SE22-269-EU	ELECTRICAL UNDERGROUND CONDUITS
8	SE22-269-E1	EQUIPMENT ELECTRICAL - SCHEDULE 1
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10	SE22-269-WU	WATER HARDLINE PLUMBING & UNDERGROUND DRAINS / CHASEWAYS
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14	SE22-269-A1	EQUIPMENT AIR - SCHEDULE 1
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16	SE22-269-T1	TRENCH DETAILS - PLAN & ELEVATION VIEW
17	SE22-269-T2	TRENCH DETAILS - CROSS SECTION ELEVATIONS & EMBEDS
18	SE22-269-T3	TRENCH DETAILS
19	SE22-269-D1	WASH BAY EQUIPMENT INSTALLATION DETAILS 1
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21	SE22-269-D3	WASH BAY EQUIPMENT INSTALLATION DETAILS 3
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23	SE22-269-D5	WASH BAY EQUIPMENT INSTALLATION DETAILS 5

THE PLAN BEARING THIS LEGEND AND THE ACCOMPANYING SPECIFICATIONS HAVE BEEN PREPARED BY MACNEIL WASH SYSTEMS LTD. FOR THE PARTY WHOSE NAME APPEARS IN THE TITLE BOX IN CONNECTION					(G:\Shar	red drives\M	lacNeil\NCS Design Team\M	lacNeil Hub	\Direct Sales P	Projects\Jeff McQuatters\SE2	22-269 GO Car Wash	- Fairport Perinton	GO CAR WASH - FA	AIRPORT PERINTON
WITH THE PROPOSED ERECTION OF AN AUTOMATIC CAR WASH AT THE LOCATION SHOWN THEREON.												90 WELH	•	TITLE: TITLE	PAGE
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THE CAR WASH. WE WILL NOT BE RESPONSIBLE FOR ERRORS OR OMISSIONS HEREIN, NOR LEGAL CODE										DRAWN BY:	CHK'D BY:	DATE:	SCALE:	DRAWING REVISION:	SE22-269-TP
OF UNDERWRITING REQUIREMENTS.	No.	BY I	DESCRIPTION	DATE	No.	BY		DESCRIPTION	DATE	MR		15-09-2022	N.T.S.	RU	

GENERAL CONTRACTOR RESPONSIBILITIES:

- 1. ALL WORK SHALL BE DONE IN CONFORMANCE WITH THE LATEST EDITION OF THE NATIONAL BUILDING CODE AND TO ALL APPLICABLE FEDERAL, STATE AND LOCAL REGULATIONS AND ORDINANCES.
- 2. THE GENERAL CONTRACTOR IS RESPONSIBLE FOR ALL NECESSARY PERMITS AND INSPECTIONS FROM THE LOCAL AUTHORITIES.
- 3. ALL EQUIPMENT AND MATERIALS PROVIDED SHALL BE NEW AND IN CONFORMANCE WITH APPLICABLE PROVISIONS OF N.E.M.A; A.N.S.I; U.L ETC.
- 4. THE GENERAL CONTRACTOR SHALL WAIT FOR APPROVAL FROM THE CAR WASH INSTALLER, ELECTRICIAN, AND PLUMBER PRIOR TO POURING THE CONCRETE FLOOR
- 5. THE SLOPE MEASUREMENTS ON THE TRENCH DRAWINGS ARE FOR RECOMMENDATION PURPOSES ONLY. THE NATIONAL AND LOCAL BUILDING CODES ARE TO BE ABIDE BY AND HAVE PRECEDENCE OVER THESE DRAWINGS.
- 6. THE FINISHED FLOOR MUST SLOPE UPWARD FROM ENTRANCE TO EXIT AT A MINIMUM OF 1/4" PER 10' FEET FOR THE ENTIRE LENGTH OF THE CONVEYOR.
- 7. THE FINISHED FLOOR MUST SLOPE UPWARD 3/16" PER FOOT FROM EACH SIDE OF THE CONVEYOR PIT TO BOTH SIDES OF THE INSIDE WALLS (SEE TRENCH DRAWING FOR EXCEPTIONS).
- 8. ALL CONCRETE TO BE A MINIMUM OF 6" THICK.
- 9. FINISH FLOOR TO HAVE A ROUGH TEXTURE. IE. BROOM FINISHED CONCRETE SO THAT BROOM LINES RUN PERPENDICULAR TO CONVEYOR TRENCH (MUST HAVE NON SKID SURFACE. SEE TRENCH DRAWING FOR EXCEPTIONS).
- 10. ALL TIE DOWN PLATES, TIE DOWN ANGLES, DIAMOND PLATE SEAT STEEL, REBAR, GRATING*, DRAINS, CHASE WAYS, PLASTIC SLEEVES AND CONDUITS ARE THE RESPONSIBILITY OF THE GENERAL CONTRACTOR. (*THE GRATING MAY BE SUPPLIED BY BADGERLAND)
- 11. THE FINISHED FLOOR IN THE EQUIPMENT ROOM MUST BE HIGHER THAN THE FINISHED FLOOR IN THE WASH BAY TO PREVENT WATER ENTERING THE ROOM.
- 12. THE GRATE MEASUREMENTS ARE FOR REFERENCE ONLY. EXACT MEASUREMENTS WILL BE DETERMINED DURING INSTALLATION.
- 13. ALL REBAR ASSOCIATED WITH THE CAR WASH TRENCH WILL MATCH THE SAME SPECIFICATIONS AS THE REBAR IN THE SURROUNDING BUILDING FOUNDATIONS. ANY DEVIATIONS FROM THIS NOTATION MUST BE APPROVED BY A LICENSED ENGINEER FOR THE PROJECT.

PLUMBER RESPONSIBILITIES:

- 1. THE PLUMBER IS RESPONSIBLE FOR THE EQUIPMENT SUPPLY AND INSTALLATION OF THE WATER MAIN SHUTOFF AND BACK FLOW PREVENTER (IF APPLICABLE) AND WATER SOFTENER HEADER (IF APPLICABLE).
- 2. THE PLUMBER IS RESPONSIBLE FOR THE SUPPLY AND INSTALLATION OF ALL THE HARD PLUMBING: WATER, AIR, AND DRAIN LINES FOR THE MECHANICAL ROOM EQUIPMENT AND THE RECLAIM SYSTEM & UNDERGROUND TANKS (IF APPLICABLE) AS INDICATED ON THE DRAWINGS.
 - a. THIS INCLUDES BUT IS NOT LIMITED TO THE SUPPLY AND INSTALLATION OF ALL THE HARD PLUMBING: PIPES, HOSES, DRAINS (FLOOR, RECLAIM, AND SANITARY), AIRLINES, CONNECTORS, ELBOWS, SHUTOFF VALVES, END CAPS, BACK FLOW PREVENTER'S, ETC...
- 3. THE PLUMBER IS RESPONSIBLE FOR THE SUPPLY AND INSTALLATION OF ALL THE CONVEYOR TRENCH AND THE CORRELATOR PIT PENETRATIONS FOR THE AIR, CHEMICAL, AND WATER PVC: CONDUITS AND DRAINS THAT ARE REQUIRED FOR THE CONNECTION TO THE RECLAIM SYSTEM AND UNDERGROUND TANKS (IF APPLICABLE), CITY SANITARY SEWER, WASH BAY EQUIPMENT (IF APPLICABLE), AND MECHANICAL ROOM EQUIPMENT AS INDICATED ON THE DRAWINGS.
 - a. THIS INCLUDES BUT IS NOT LIMITED TO THE SUPPLY AND INSTALLATION OF ALL THE UNDERGROUND: DRAINS, CONDUITS, ELBOWS, FITTINGS, SLEEVES, BACK FLOW PREVENTER'S, TRAPS, MOUNTING HARDWARE, ETC...
- 4. THE PLUMBER IS RESPONSIBLE FOR THE SUPPLY AND INSTALLATION OF THE WASH BAY EQUIPMENT STUBS UPS (IF APPLICABLE): AIR, CHEMICAL, AND WATER LINES.
- 5. IN ADDITION TO THE ABOVE, THE PLUMBER MUST PROVIDE ANY OTHER PLUMBING COMPONENTS THAT ARE REQUIRED TO FACILITATE THE EQUIPMENT PLUMBING CONNECTIONS, IN ORDER TO COMPLETE THE INSTALLATION TO THE ACCEPTABLE LOCAL AND STATE PLUMBING CODE REQUIREMENTS.

PLUMBER GENERAL NOTES:

- 1. ALL WORK SHALL BE DONE IN CONFORMANCE WITH THE LATEST EDITION OF THE NATIONAL PLUMBING CODE AND TO ALL APPLICABLE FEDERAL, STATE AND LOCAL REGULATIONS AND ORDINANCES.
- 2. THE PLUMBER IS RESPONSIBLE FOR ALL NECESSARY PERMITS AND INSPECTIONS FROM THE LOCAL AUTHORITIES.
- 3. ALL EQUIPMENT AND MATERIALS PROVIDED SHALL BE NEW AND IN CONFORMANCE WITH APPLICABLE PROVISIONS OF N.E.M.A; A.N.S.I; U.L ETC.
- 4. THESE DRAWINGS ARE FOR DIAGRAMMATIC PURPOSES ONLY AND INDICATE GENERAL LAYOUT OF THE PLUMBING SYSTEM. FIELD VERIFICATIONS OF DIMENSIONS MUST BE DETERMINED. PLUMBER IS RESPONSIBLE TO COORDINATE WITH THE CAR WASH INSTALLER WHAT IS THE BEST POSSIBLE ROUTING ON SITE FOR THE PIPING.
- 5. ALL PLUMBING PVC SLEEVES PENETRATING THE CONVEYOR TRENCH MUST BE LOCATED 16" BELOW FINISHED FLOOR.
- 6. ALL STUB-UPS TO BE 1" FROM WALL UNLESS OTHERWISE INDICATED.
- 7. THE PLUMBER MUST COORDINATE HIS WORK WITH THAT OF OTHER TRADES IN ORDER TO AVOID INTERFERENCE.
- 8. ALL STRUT, CLAMPS AND FASTENER UTILIZED WITHIN THE TUNNEL MUST BE MADE OF A NON- CORROSIVE MATERIAL. STRUTS SHALL BE STAINLESS STEEL. CLAMPS SHALL BE STAINLESS STEEL, PVC OR COMPOSITE. ALL FASTENERS SHALL BE STAINLESS STEEL.
- 9. THE DRAIN PIPE SIZES PROVIDED ON THESE DRAWINGS ARE FOR RECOMMENDATION PURPOSES ONLY. THE NATIONAL AND LOCAL PLUMBING CODES ARE TO BE ABIDE BY AND HAVE PRECEDENCE OVER THIS DRAWING.
- 10. DRAINS CAN BE ON EITHER SIDE OF TRENCH DEPENDING ON LOCATION OF THE RECLAIM SYSTEM UNDERGROUND TANKS (IF APPLICABLE), SAND / OIL SEPARATOR (IF APPLICABLE), AND THE CITY SANITARY SEWER.

DISTRIBUTOR OR CUSTOMER RESPONSIBILITIES:

- 1. THE DISTRIBUTOR OR CUSTOMER IS RESPONSIBLE FOR THE SUPPLY AND INSTALLATION OF ALL OF THE WASH BAY EQUIPMENT, MECHANICAL ROOM EQUIPMENT, PAY STATION GATES & TERMINALS (IF APPLICABLE), AND VACUUMS (IF APPLICABLE) UNLESS OTHERWISE NOTED.
- 2. THE DISTRIBUTOR OR CUSTOMER IS RESPONSIBLE FOR THE SUPPLY AND INSTALLATION OF ALL OF THE SOFT AIR, CHEMICAL, AND WATER: LINES, HOSES, CONNECTORS, FITTINGS, AND MOUNTING HARDWARE FOR ALL OF THE CONNECTIONS BETWEEN THE MECHANICAL ROOM EQUIPMENT AND THE CAR WASH BAY EQUIPMENT UNLESS OTHERWISE NOTED.

ELECTRICIAN RESPONSIBILITIES:


- 1. THE ELECTRICIAN IS RESPONSIBLE FOR THE EQUIPMENT SUPPLY AND INSTALLATION OF ALL THE DISTRIBUTION PANELS, BREAKERS, ALL MCC MAIN BREAKER, TRANSFORMER'S, WARNING HORNS AND START & EMERGENCY STOP BUTTONS.
- 2. THE ELECTRICIAN IS RESPONSIBLE FOR THE SUPPLY AND INSTALLATION OF ALL THE THREE & SINGLE PHASE POWER, CONTROL, AND COMMUNICATION: WIRING, TERMINATIONS, AND CONDUIT WORK TO THE EQUIPMENT IN THE WASH BAY, MECHANICAL ROOM, PAY STATION GATES & TERMINALS (IF APPLICABLE), AND VACUUMS (IF APPLICABLE) AS INDICATED ON THE DRAWINGS.
 - a. THIS INCLUDES BUT IS NOT LIMITED TO THE SUPPLY AND INSTALLATION OF ALL THE ELECTRICAL: WIRES, WATER TIGHT CONNECTORS, JUNCTION BOXES, DISCONNECT SWITCHES, RECEPTACLES, LIGHT SWITCHES, TERMINALS, GUTTERS, WIRE NUTS, HARDWARE, SPLIT BOLTS, ETC...
- b. THIS ALSO INCLUDES BUT IS NOT LIMITED TO THE SUPPLY AND INSTALLATION OF ALL THE OVERHEAD AND UNDERGROUND: CONDUITS, ELBOWS, FITTINGS, SLEEVES, MOUNTING HARDWARE, ETC...
- 3. IN ADDITION TO THE ABOVE, THE ELECTRICIAN MUST PROVIDE ANY OTHER ELECTRICAL COMPONENTS THAT ARE REQUIRED TO FACILITATE THE EQUIPMENT ELECTRICAL CONNECTIONS, IN ORDER TO COMPLETE THE INSTALLATION TO THE ACCEPTABLE LOCAL AND STATE ELECTRICAL CODE REQUIREMENTS.
- 4. SEE THE EQUIPMENT MANUFACTURER'S DRAWINGS & SPECIFICATIONS FOR FURTHER ELECTRICAL WIRING AND POWER REQUIREMENTS.

ELECTRICIAN GENERAL NOTES:

- 1. ALL WORK SHALL BE DONE IN CONFORMANCE WITH THE LATEST EDITION OF THE NATIONAL ELECTRICAL CODE AND TO ALL APPLICABLE FEDERAL, STATE AND LOCAL REGULATIONS AND ORDINANCES.
- 2. THE ELECTRICIAN IS RESPONSIBLE FOR ALL NECESSARY PERMITS AND INSPECTIONS FROM THE LOCAL AUTHORITIES.
- 3. ALL EQUIPMENT AND MATERIALS PROVIDED SHALL BE NEW AND IN CONFORMANCE WITH APPLICABLE PROVISIONS OF N.E.M.A, A.N.S.I, U.L, ETC...
- 4. THESE DRAWINGS ARE FOR DIAGRAMMATIC PURPOSES ONLY AND INDICATE GENERAL LAYOUT OF THE ELECTRICAL SYSTEM. FIELD VERIFICATIONS OF DIMENSIONS MUST BE DETERMINED. THE ELECTRICIAN IS RESPONSIBLE TO COORDINATE WITH THE CAR WASH INSTALLER WHAT IS THE BEST POSSIBLE ROUTING ON SITE FOR THE CONDUITS.
- 5. ALL ELECTRICAL WIRING CONDUITS PENETRATING THE CONVEYOR TRENCH MUST BE LOCATED 16" BELOW FINISHED FLOOR.
- 6. ALL STUB-UPS TO BE 1" FROM WALL UNLESS OTHERWISE INDICATED.
- 7. THE ELECTRICIAN MUST COORDINATE HIS WORK WITH THAT OF OTHER TRADES IN ORDER TO AVOID INTERFERENCE.
- 8. ONLY FULLY WATERPROOF (NEMA4X) ELECTRICAL ENCLOSURES ARE TO BE USED.
- 9. THE ELECTRICIAN MUST VERIFY CORRECT MOTOR ROTATION FOR ALL 3 PHASE MOTORS FROM MOTOR CONTROL CENTER (MCC) TO THE EQUIPMENT MOTORS.
- 10. SPLIT BOLTS ARE REQUIRED ON ALL MOTOR CONNECTIONS FOR BLOWERS, AIR COMPRESSOR'S, HIGH PRESSURE PUMPS, AND ANY OTHER MOTORS OVER 5 H.P.
- 11. ALL MOTOR AND CONTROL WIRES TO BE **THHN/THWN STRANDED** OR EQUIVALENT. NO SOLID WIRE WILL BE ACCEPTED FOR ANY ASPECT OF THE CAR WASH EQUIPMENT. WIRE SIZES BASED ON 75 CELSIUS, CU WIRING.
- 12. ALL STRUT, CLAMPS AND FASTENERS UTILIZED WITHIN THE TUNNEL MUST BE MADE OF A NON- CORROSIVE MATERIAL. STRUTS SHALL BE STAINLESS STEEL. CLAMPS SHALL BE STAINLESS STEEL, PVC OR COMPOSITE. ALL FASTENERS SHALL BE STAINLESS STEEL.
- 13. ALL CONDUCTORS FROM VARIABLE FREQUENCY DRIVES TO MOTORS MUST BE VFD RATED, BELDEN 29502, 29503, 29504, or 29505 MULTI-CONDUCTOR SHIELDED CABLES.
- 14. EVERY MOTOR FED FROM A VFD MUST HAVE IT'S OWN DEDICATED CONDUIT. CONDUCTORS USED TO FEED MOTORS MUST BE RATED FOR USE WITH VFD'S. FAILURE TO MEET THIS REQUIREMENT WILL **VOID THE WARRANTY** ON BOTH THE EFFECTED MOTOR AND VFD.
- 15. DO NOT DRILL THROUGH OR PIERCE THE TOP OF THE MCC CABINET. FAILURE TO COMPLY WITH THIS WARNING WILL VOID WARRANTY.
- 16. ALL EQUIPMENT MUST BE PROPERLY GROUNDED & BONDED WHERE APPLICABLE

	RESPONSIBILITY MATRIX												
EQUIPMENT DESCRIPTION	EQUIPMENT SUPPLIED BY	EQUIPMENT INSTALLED BY	ELECTRICAL BY	PLUMBING BY	CONCRETE BY								
ALL BACKROOM EQUIPMENT	DISTRIBUTOR OR CUSTOMER	CAR WASH INSTALLER	ELECTRICIAN	PLUMBER	GENERAL CONTRACTOR								
ALL WASH BAY EQUIPMENT	DISTRIBUTOR OR CUSTOMER	CAR WASH INSTALLER	ELECTRICIAN	PLUMBER	GENERAL CONTRACTOR								
DISTRIBUTION PANELS	ELECTRICIAN	ELECTRICIAN	ELECTRICIAN										
CIRCUIT BREAKERS	ELECTRICIAN	ELECTRICIAN	ELECTRICIAN										
STEP DOWN TRANSFORMER	ELECTRICIAN	ELECTRICIAN	ELECTRICIAN										
WARNING HORN	ELECTRICIAN	ELECTRICIAN	ELECTRICIAN										
EMERGENECY STOP BUTTONS	ELECTRICIAN	ELECTRICIAN	ELECTRICIAN										
BACK FLOW PREVENTER'S	PLUMBER	PLUMBER		PLUMBER									

GO CAR WASH - FAIRPORT PERINTON G:\Shared drives\MacNeil\NCS Design Team\MacNeil Hub\Direct Sales Projects\Jeff McQuatters\SE22-269 GO Car Wash - Fairport Perinton THE PLAN BEARING THIS LEGEND AND THE ACCOMPANYING SPECIFICATIONS HAVE BEEN PREPARED BY MACNEIL WASH SYSTEMS LTD. FOR THE PARTY WHOSE NAME APPEARS IN THE TITLE BOX IN CONNECTION 90 WELHAM ROAD, WITH THE PROPOSED ERECTION OF AN AUTOMATIC CAR WASH AT THE LOCATION SHOWN THEREON. **GENERAL NOTES &** SAME ARE THE EXCLUSIVE PROPERTY OF MACNEIL WASH SYSTEMS LTD. AND ARE SUBJECT TO RETURN BARRIE ONTARIO. **RESPONSIBILITIES** UPON DEMAND. BY THE ACCEPTANCE HEREOF. THE PROSPECTIVE CUSTOMER THEREBY AGREES NOT TO **L4N 8Y4** SITE LOCATION: DIVULGE. USE OR COPY THE SAME WITHOUT THE WRITTEN CONSENT OF MACNEIL WASH SYSTEMS LTD. CANADA FAIRPORT, NY R0 MR ISSUED FOR CONSTRUCTION 15-09-2022 GREAT IDEAS • GREAT RESULTS THE INFORMATION CONTAINED HEREIN IS SUBMITTED IN GOOD FAITH AS AN ASSISTANCE IN LAYING OUT SE22-269-G1 THE CAR WASH. WE WILL NOT BE RESPONSIBLE FOR ERRORS OR OMISSIONS HEREIN, NOR LEGAL CODE **DRAWING REVISION: DRAWN BY:** CHK'D BY: SCALE: R0 OF UNDERWRITING REQUIREMENTS. 15-09-2022 N.T.S. No. BY **DESCRIPTION** DATE No. BY **DESCRIPTION** DATE

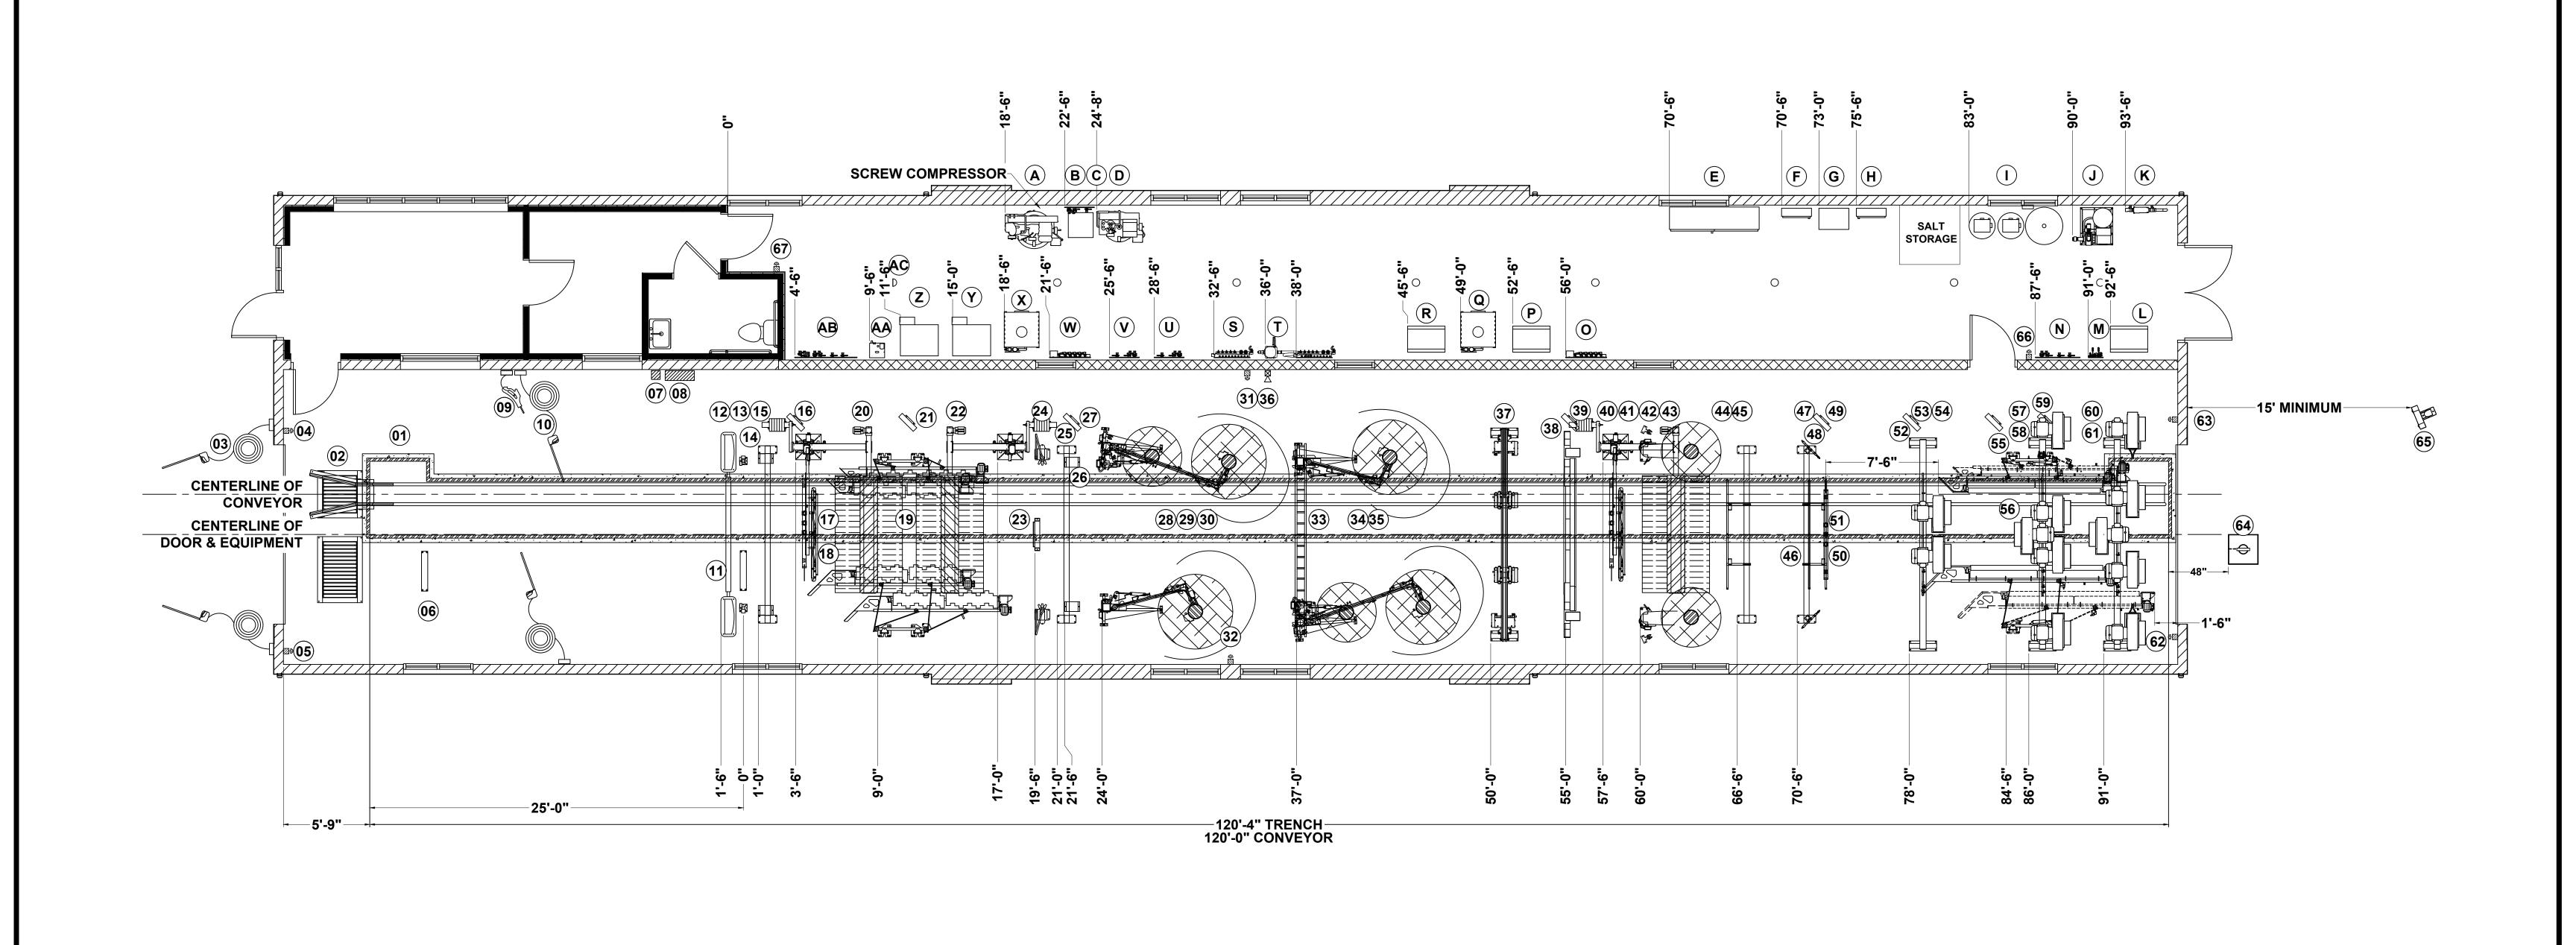

SEE PAGE "GENERAL NOTES & RESPONSIBILITIES" FOR YOUR OUTLINED NOTES AND DUTIES.

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FAIRPORT, NY DIVULGE, USE OR COPY THE SAME WITHOUT THE WRITTEN CONSENT OF MACNEIL WASH SYSTEMS LTD. DRAWING NUMBER: **CANADA** R0 MR ISSUED FOR CONSTRUCTION 15-09-2022 GREAT IDEAS · GREAT RESULTS DRAWING REVISION: THE INFORMATION CONTAINED HEREIN IS SUBMITTED IN GOOD FAITH AS AN ASSISTANCE IN LAYING OUT SE22-269-L SCALE: N.T.S. THE CAR WASH. WE WILL NOT BE RESPONSIBLE FOR ERRORS OR OMISSIONS HEREIN, NOR LEGAL CODE DRAWN BY: CHK'D BY: 15-09-2022 OF UNDERWRITING REQUIREMENTS. No. BY DATE No. BY **DESCRIPTION DESCRIPTION** DATE

ITEM#	EQUIPMENT DESCRIPTION	MODEL	REFERENCE FILE NAME
01	CONVEYOR	XR1000	MACNEIL \ CONVEYOR - XR1000
02	CORRELATOR	XR120	MACNEIL \ CORRELATOR - XR120
03	PREP GUNS	-	
04	EMERGENCY STOP BUTTONS	-	
05	EMERGENCY STOP BUTTONS	-	MACNELL \ TARE CVALITOLI
06	TAPE SWITCH FOR ROLLER UP	-	MACNEIL \ TAPE SWITCH
07 08	MANUAL ROLLER UP BUTTON PUSH BUTTON STATION - E-STOP / POWER	PBS4000	
09	BUG PREP GUN	-	
10	PREP GUNS	-	
11	TAPE SWITCH FOR CTA'S	-	MACNEIL \ TAPE SWITCH
12	BIG ASS ARCH	-	
13	DOUBLE PHOTO EYES	IR-110-2	MACNEIL \ PHOTO EYES - IR-110
14	CHEMICAL TIRE APPLICATOR - WHEEL RITE PRECISION	СТА	MACNEIL \ CHEMICAL TIRE APPLICATOR - WHEEL RITE
15	UTILITY ARCH	-	
16	GO BATH ADVERTISING SIGN	-	
17	EVOLUTION TOP REACH	ETR	MACNEIL \ EVOLUTION TOP REACH
18	FOAMING RAIN BAR	-	
19	MAGNUM WHEEL BOSS WITH BRISTLE BRUSH	MW2000	MACNEIL \ WHEEL BOSS - MW2000
20	TOP BRUSH WITH 94 INCH CORE	RS1000	MACNEIL \ TOP BRUSH - RS-1000
21	WHEEL CLEARNER SIGN	- DC4000	MACNEII \ TOD DDIIGH DC 4000
22	TOP BRUSH WITH 94 INCH CORE LOW PRESSURE UNDERCARRIAGE SPRAY	RS1000 RW-100	MACNEIL \ TOP BRUSH - RS-1000 MACNEIL \ UNDERCARRIAGE SPRAY - RW-100
24	WHEEL BLASTER - 6 NOZZLES WITH FOLLOWING FEATURE	WB-600-FF	MACNEIL \ MAGNUM WHEEL BLASTER
25	UTILITY ARCH		WACKLIE (WACKOW WITELE DEADTER
26	CHEMICAL TIRE APPLICATOR - WHEEL RITE PRECISION	СТА	MACNEIL \ CHEMICAL TIRE APPLICATOR - WHEEL RITE
27	TRIPLE FOAM SIGN	-	
28	LOW SIDE WASHER WITH 30" CORE - QUADPACK	RS400	MACNEIL \ ROCKER PANEL WASHER - RS-400
29	SINGLE BOOMERANG FOAMERS SQUARE MOUNTED	-	
30	SUPERFLEX WRAP AROUND - LONG & SHORT ARM	RS701	MACNEIL \ SUPERFLEX WRAP-AROUND - RS-701
31	EMERGENCY STOP BUTTONS	-	
32	EMERGENCY STOP BUTTONS	-	
33	CABLE TRAY	RW200P	MACNEIL \ PLUMBING ARCH
34	SINGLE BOOMERANG FOAMERS SQUARE MOUNTED	-	
35	SUPERFLEX WRAP AROUND - SHORT & LONG ARM	RS701	MACNEIL \ SUPERFLEX WRAP-AROUND - RS-701
36	WARNING HORN	-	
37 38	MAGNUM FORCE - OSCILLATING ARCH WITH 4 HEADS PRIME DRY SIGN	-	
39	PREMIER ARCH	-	
40	EVOLUTION TOP REACH	ETR	MACNEIL \ EVOLUTION TOP REACH
41	FOAMING RAIN BAR	-	MACREIE (EVOLUTION TOT REACT)
42	LOW SIDE WASHER WITH 30" CORE	RS400	MACNEIL \ ROCKER PANEL WASHER - RS-400
43	TOP BRUSH WITH 94 INCH CORE	RS1000	MACNEIL \ TOP BRUSH - RS-1000
44	RAIN BAR	RW112	MACNEIL \ RAIN BAR - RW-112
45	UTILITY ARCH	-	
46	RAIN BAR	RW112	MACNEIL \ RAIN BAR - RW-112
47	UTILITY ARCH	-	
48	MIRROR RINSE	-	
49	GO WAX SIGN	- DW440	MACNELL V DAINI DAD DIAL 440
50	RAIN BAR	RW112	MACNEIL \ RAIN BAR - RW-112
51 52	LIGHT BAR KIT CERAMIC SIGN	-	
52	IDC DRYERS ON X-WIDE PROBUILD ARCH	-	MACNEIL \ TECH 21 DRYING SYSTEMS
54	LIGHT BAR KIT	-	INITOIALIL (ILOII Z I DIVINIO 3 I 3 I ENNO
55	TOTAL BODY SIGN	-	
56	GLOSS BOSS 9' BRUSH	MT2500	MACNEIL \ GLOSS BOSS - MT2500
57	IDC DRYERS ON X-WIDE PROBUILD ARCH	-	MACNEIL \ TECH 21 DRYING SYSTEMS
58	LIGHT BAR KIT	-	
59	SHINY TIRES ADVERTISING SIGN	-	
60	IDC DRYERS & AIR KNIVES ON X-WIDE PROBUILD ARCH	-	MACNEIL \ TECH 21 DRYING SYSTEMS
61	LIGHT BAR KIT	-	
62	EMERGENCY STOP BUTTONS	-	
63	EMERGENCY STOP BUTTONS	-	
64	ANTI COLLISION PAD	-	MACNEIL \ ANTI-COLLISION PAD
65	TRAFFIC COMMANDER 2SECTIONS	-	
66	EMERGENCY STOP BUTTONS	-	
67	EMERGENCY STOP BUTTONS	-	

TEM#	EQUIPMENT DESCRIPTION	MODEL	REFERENCE FILE NAME
Α	AIR COMPRESSOR - SCREW COMPRESSOR	-	
В	AIR DRYER	-	
С	AIR DISTRIBUTION - SUPPLY	-	
D	AIR COMPRESSOR	-	
E	MASTER CONTROL CENTER	MCC	
F	208V/110V SECONDARY PANEL - BY OTHERS	SDP	
G	SECONDARY DISTRIBUTION TRANSFORMER - BY OTHERS	STX	
Н	MAIN ELECTRICAL PANEL - BY OTHERS	MDP	
I	WATER SOFTENER	-	
J	BOOSTER PUMP	BP-5HP60G60 P	
K	WATER MAIN / BACKFLOW PREVENTER - BY OTHERS	-	
L	HYDRAULIC POWERPACK	-	
M	GLOSS BOSS CHEMICAL PANEL	-	MACNEIL \ GLOSS BOSS - MT2500
N	AIR DISTRIBUTION PANEL 2	-	
0	CAROLINA PRIDE - 5 PORT WATER DISTRIBUTION PANEL 2	-	
Р	HYDRAULIC POWERPACK	-	
Q	MAGNUM HIGH PRESSURE PUMP 15HP	M2000R	MACNEIL \ MAGNUM PUMPING STATION
R	HYDRAULIC POWERPACK	-	
S	HYDRAFLEX CHEMICAL PANELS XD X2	-	HYDRAFLEX
T	HYDRAFLEX GRUNDFOS PUMP	-	HYDRAFLEX
U	AIR DISTRIBUTION - RS701	-	
V	AIR DISTRIBUTION - RS701	-	
W	CAROLINA PRIDE - 7 PORT WATER DISTRIBUTION PANEL 1	-	
Χ	MAGNUM HIGH PRESSURE PUMP 15HP	M2000R	MACNEIL \ MAGNUM PUMPING STATION
Υ	CAROLINA PRIDE PUMPING STATION	-	
Z	CAROLINA PRIDE PUMPING STATION	-	
AA	HYDRAFUSE - DOUBLE PUMP - NON-FOAMING	-	MACNEIL \ HYDRAFUSE HYDROMINDERS
AB	AIR DISTRIBUTION PANEL	-	
AC	BACKROOM TRENCH - HUB DRAIN	-	

SEE PAGE "GENERAL NOTES & RESPONSIBILITIES" FOR YOUR OUTLINED NOTES AND DUTIES.

THE PLAN BEARING THIS LEGEND AND THE ACCOMPANYING SPECIFICATIONS HAVE BEEN PREPARED BY MACNEIL WASH SYSTEMS LTD. FOR THE PARTY WHOSE NAME APPEARS IN THE TITLE BOX IN CONNECTION WITH THE PROPOSED ERECTION OF AN AUTOMATIC CAR WASH AT THE LOCATION SHOWN THEREON. SAME ARE THE EXCLUSIVE PROPERTY OF MACNEIL WASH SYSTEMS LTD. AND ARE SUBJECT TO RETURN UPON DEMAND. BY THE ACCEPTANCE HEREOF, THE PROSPECTIVE CUSTOMER THEREBY AGREES NOT TO DIVULGE, USE OR COPY THE SAME WITHOUT THE WRITTEN CONSENT OF MACNEIL WASH SYSTEMS LTD. THE INFORMATION CONTAINED HEREIN IS SUBMITTED IN GOOD FAITH AS AN ASSISTANCE IN LAYING OUT THE CAR WASH. WE WILL NOT BE RESPONSIBLE FOR ERRORS OR OMISSIONS HEREIN, NOR LEGAL CODE OF UNDERWRITING REQUIREMENTS.

G:\Shared drives\MacNeil\NCS Design Team\MacNeil Hub\Direct Sales Projects\Jeff McQuatters\SE22-269 GO Car Wash - Fairport Perinton R0 MR ISSUED FOR CONSTRUCTION 15-09-2022 **DESCRIPTION** No. BY DATE No. BY **DESCRIPTION** DATE





90 WELHAM ROAD, BARRIE ONTARIO, **L4N 8Y4 CANADA** DATE: 15-09-2022

GO CAR WASH - FAIRPORT PERINTON **EQUIPMENT LAYOUT** SCHEDULE 1


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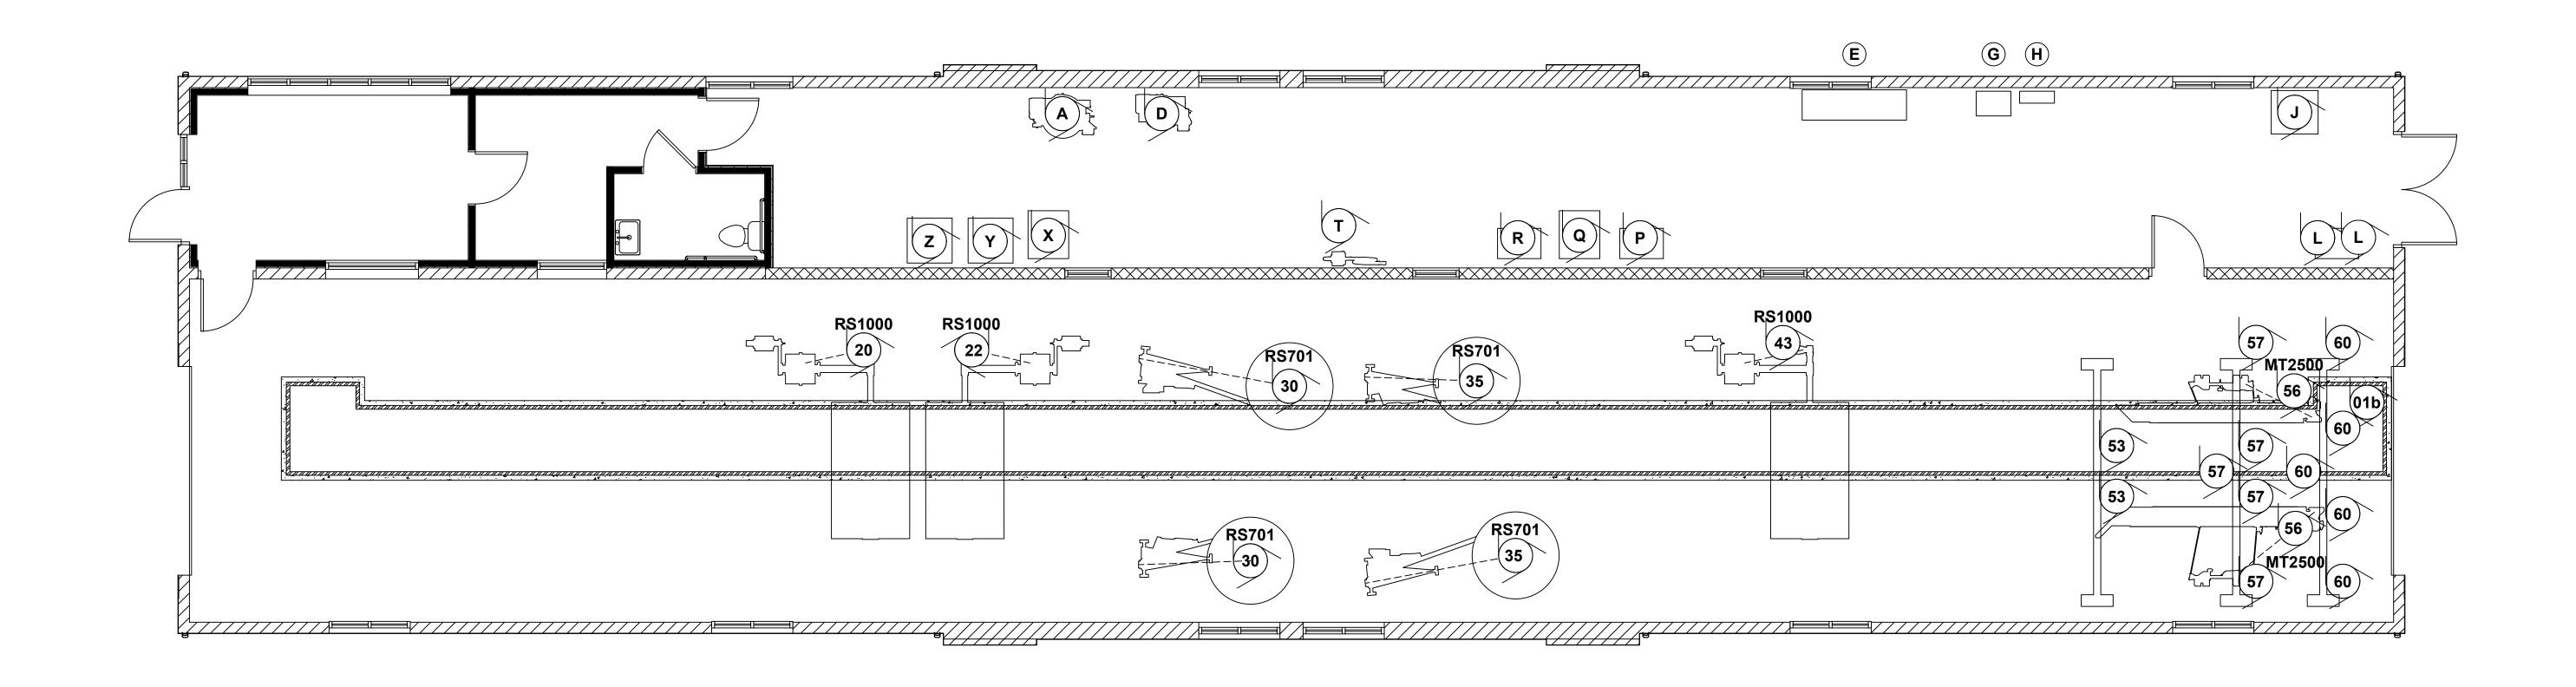
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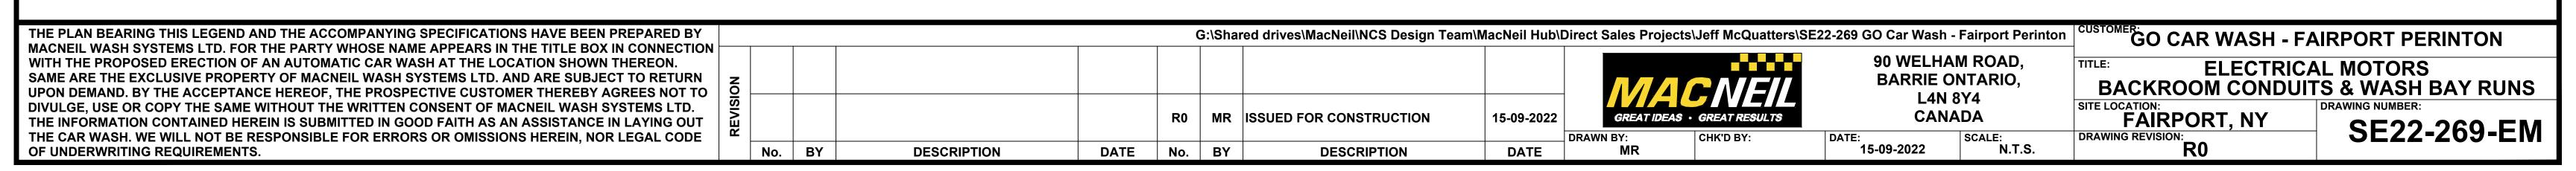


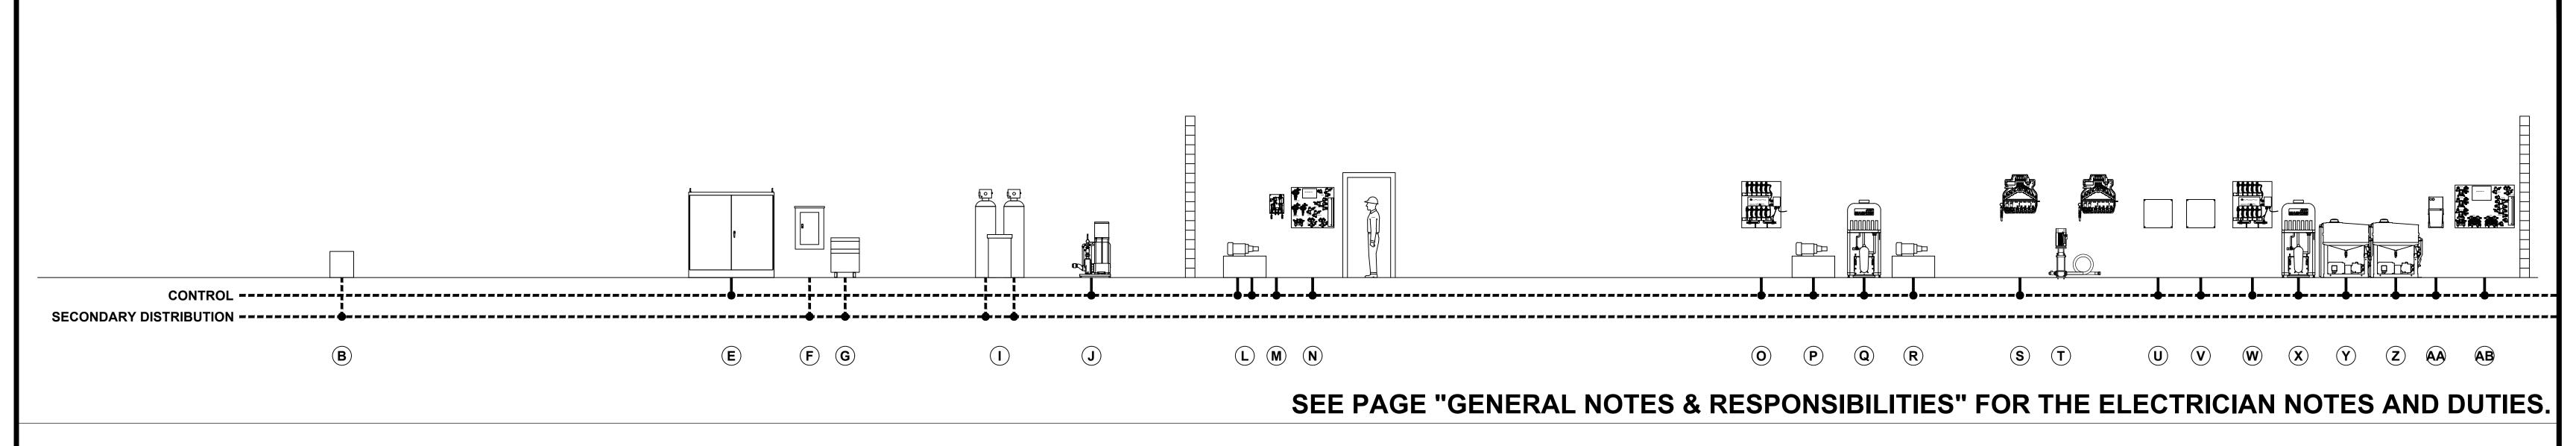



GO CAR WASH - FAIRPORT PERINTON G:\Shared drives\MacNeil\NCS Design Team\MacNeil Hub\Direct Sales Projects\Jeff McQuatters\SE22-269 GO Car Wash - Fairport Perinton THE PLAN BEARING THIS LEGEND AND THE ACCOMPANYING SPECIFICATIONS HAVE BEEN PREPARED BY MACNEIL WASH SYSTEMS LTD. FOR THE PARTY WHOSE NAME APPEARS IN THE TITLE BOX IN CONNECTION 90 WELHAM ROAD, WITH THE PROPOSED ERECTION OF AN AUTOMATIC CAR WASH AT THE LOCATION SHOWN THEREON. TITLE: ELECTRICAL CONTROLS & LIGHTING SAME ARE THE EXCLUSIVE PROPERTY OF MACNEIL WASH SYSTEMS LTD. AND ARE SUBJECT TO RETURN **BARRIE ONTARIO, BACKROOM CONDUITS & WASH BAY RUNS** UPON DEMAND. BY THE ACCEPTANCE HEREOF, THE PROSPECTIVE CUSTOMER THEREBY AGREES NOT TO L4N 8Y4 DIVULGE, USE OR COPY THE SAME WITHOUT THE WRITTEN CONSENT OF MACNEIL WASH SYSTEMS LTD. **CANADA** FAIRPORT, NY R0 MR ISSUED FOR CONSTRUCTION 15-09-2022 GREAT IDEAS · GREAT RESULTS DRAWING REVISION: THE INFORMATION CONTAINED HEREIN IS SUBMITTED IN GOOD FAITH AS AN ASSISTANCE IN LAYING OUT **SE22-269-EC** SCALE: N.T.S. THE CAR WASH. WE WILL NOT BE RESPONSIBLE FOR ERRORS OR OMISSIONS HEREIN, NOR LEGAL CODE DRAWN BY: OF UNDERWRITING REQUIREMENTS. 15-09-2022 DATE No. BY No. BY **DESCRIPTION DESCRIPTION** DATE

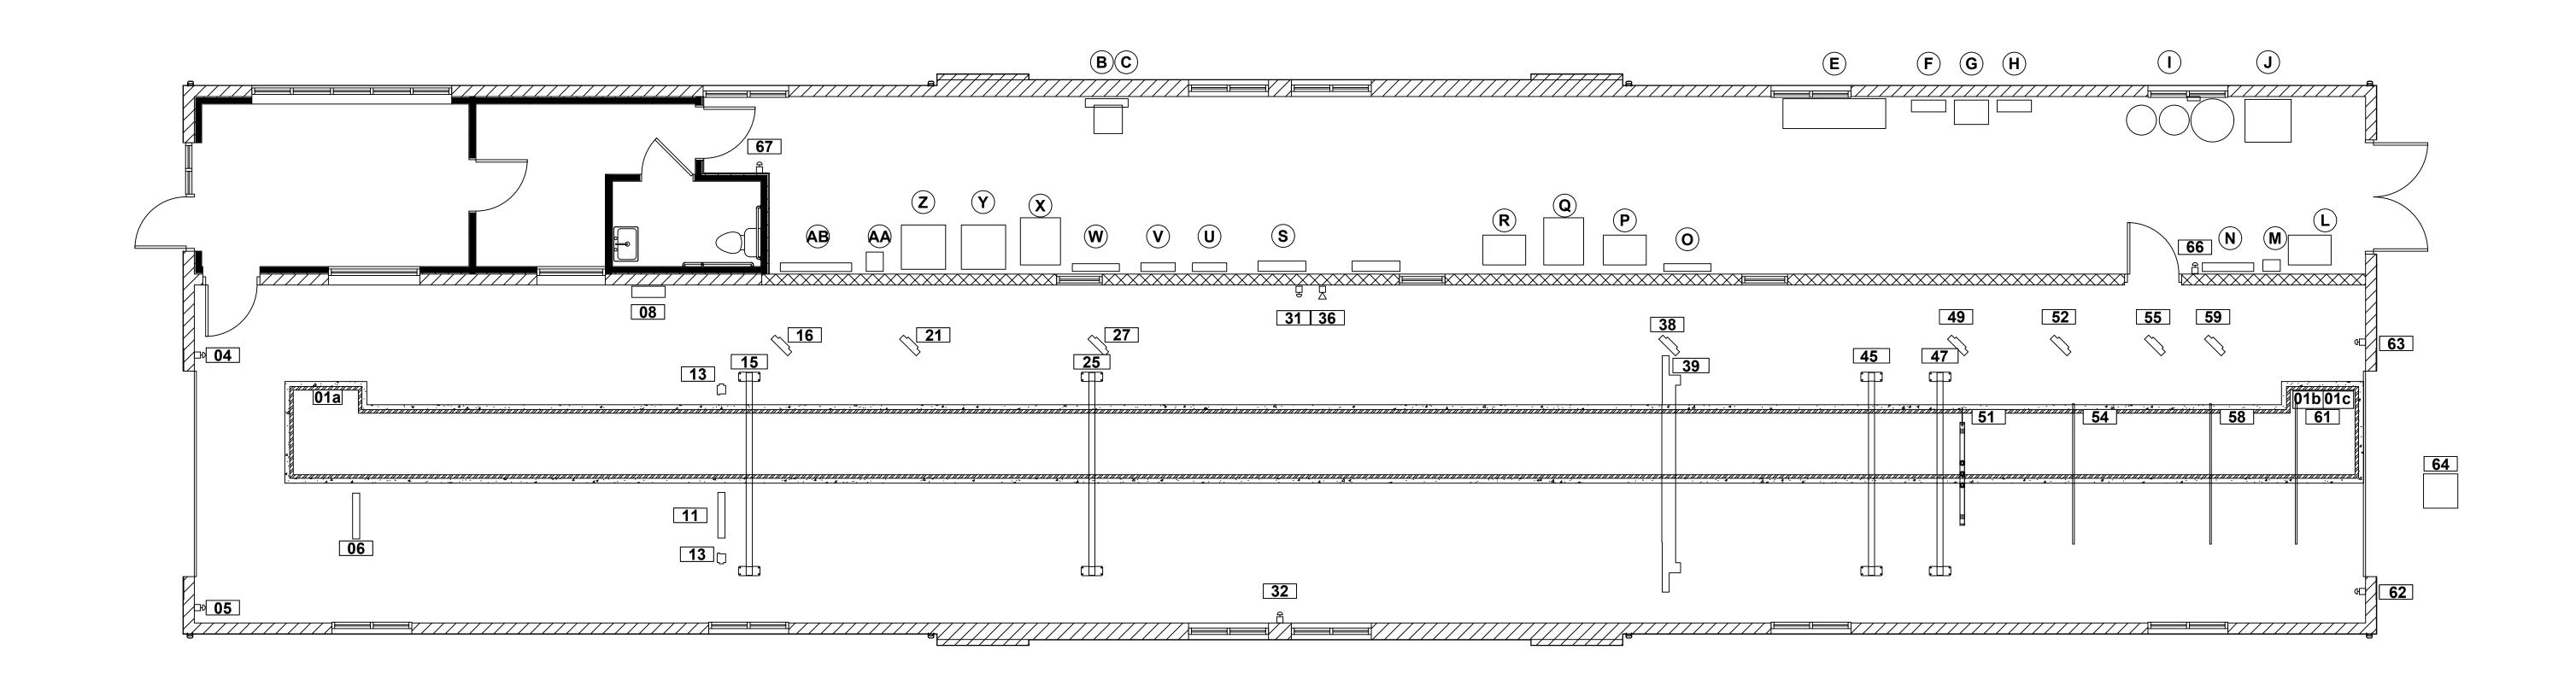




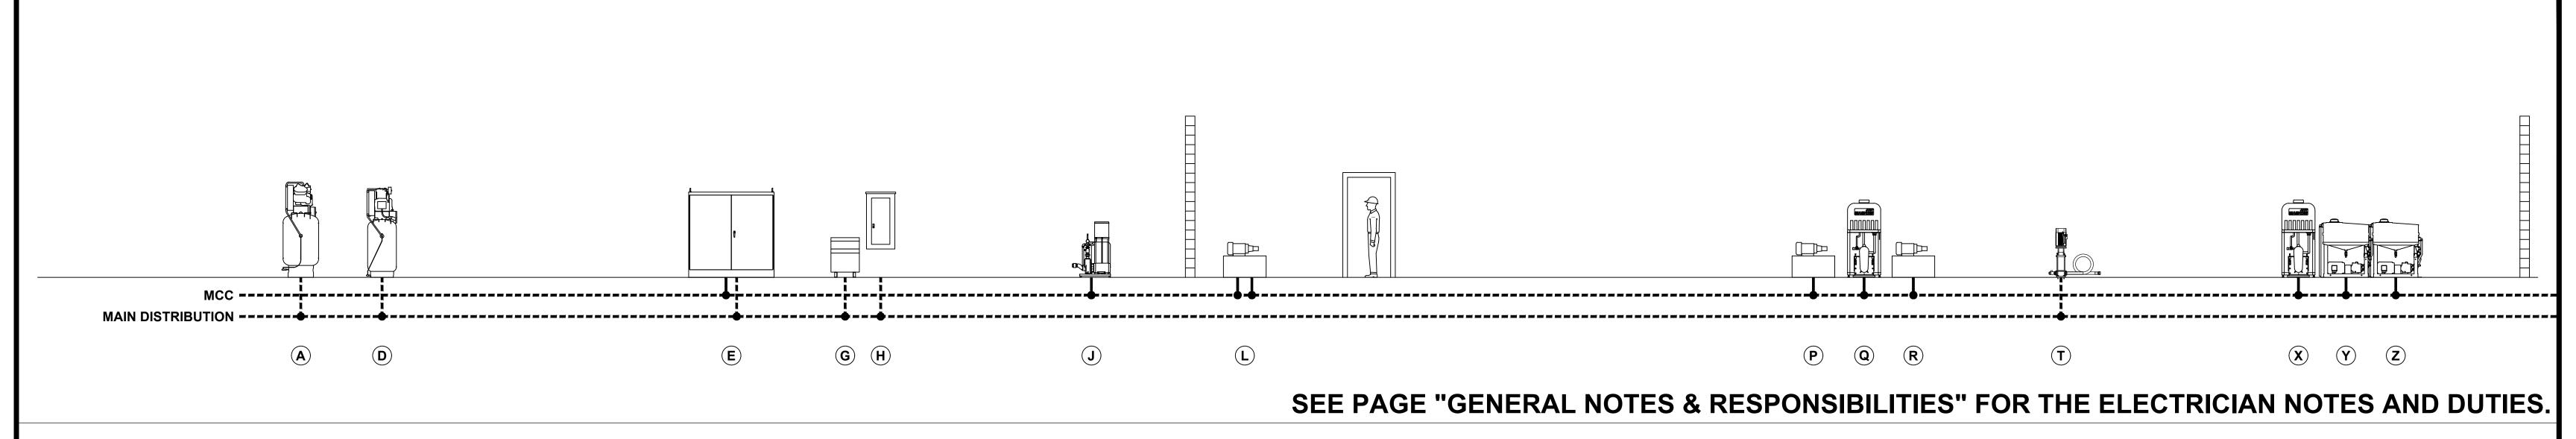

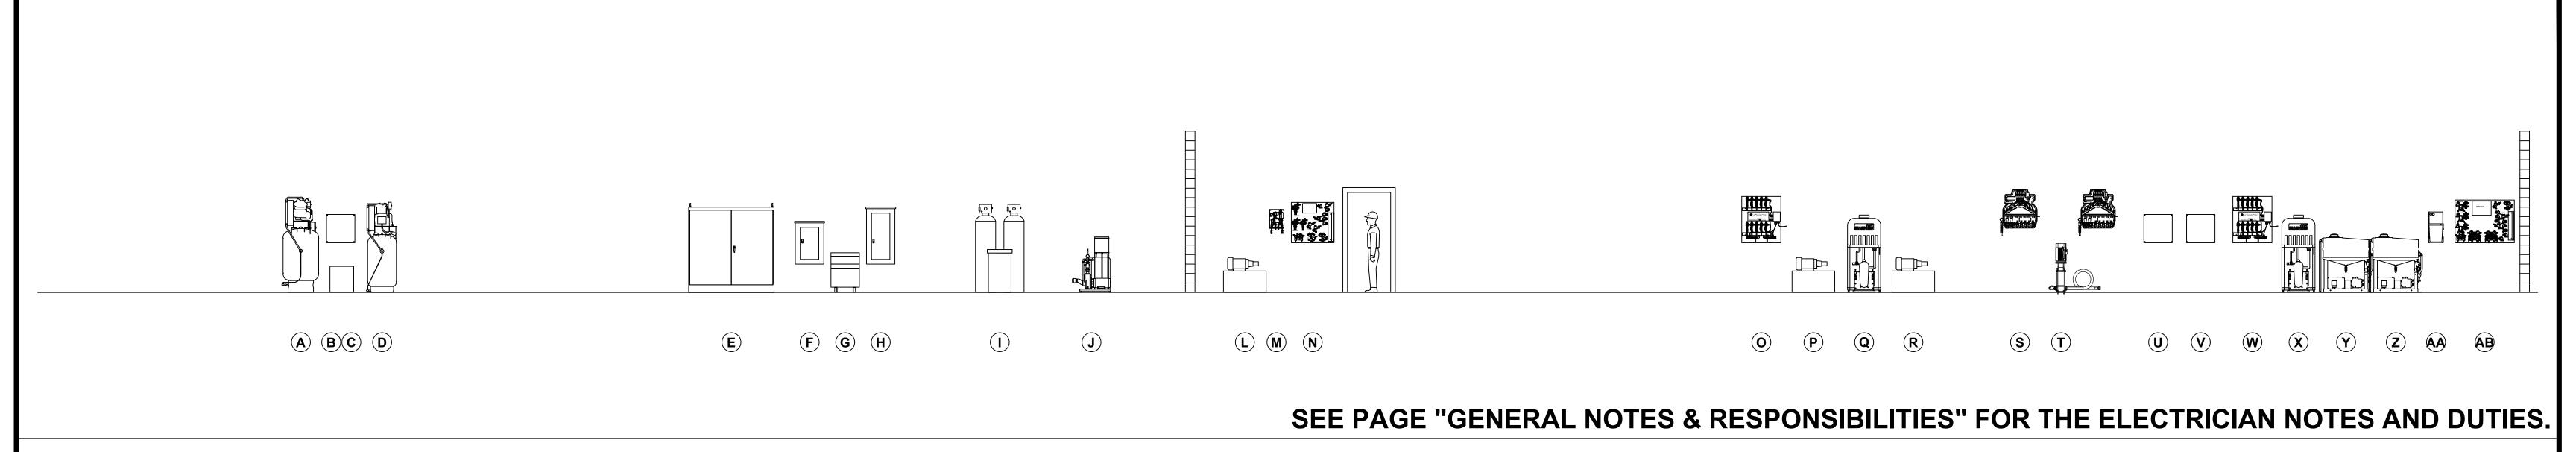

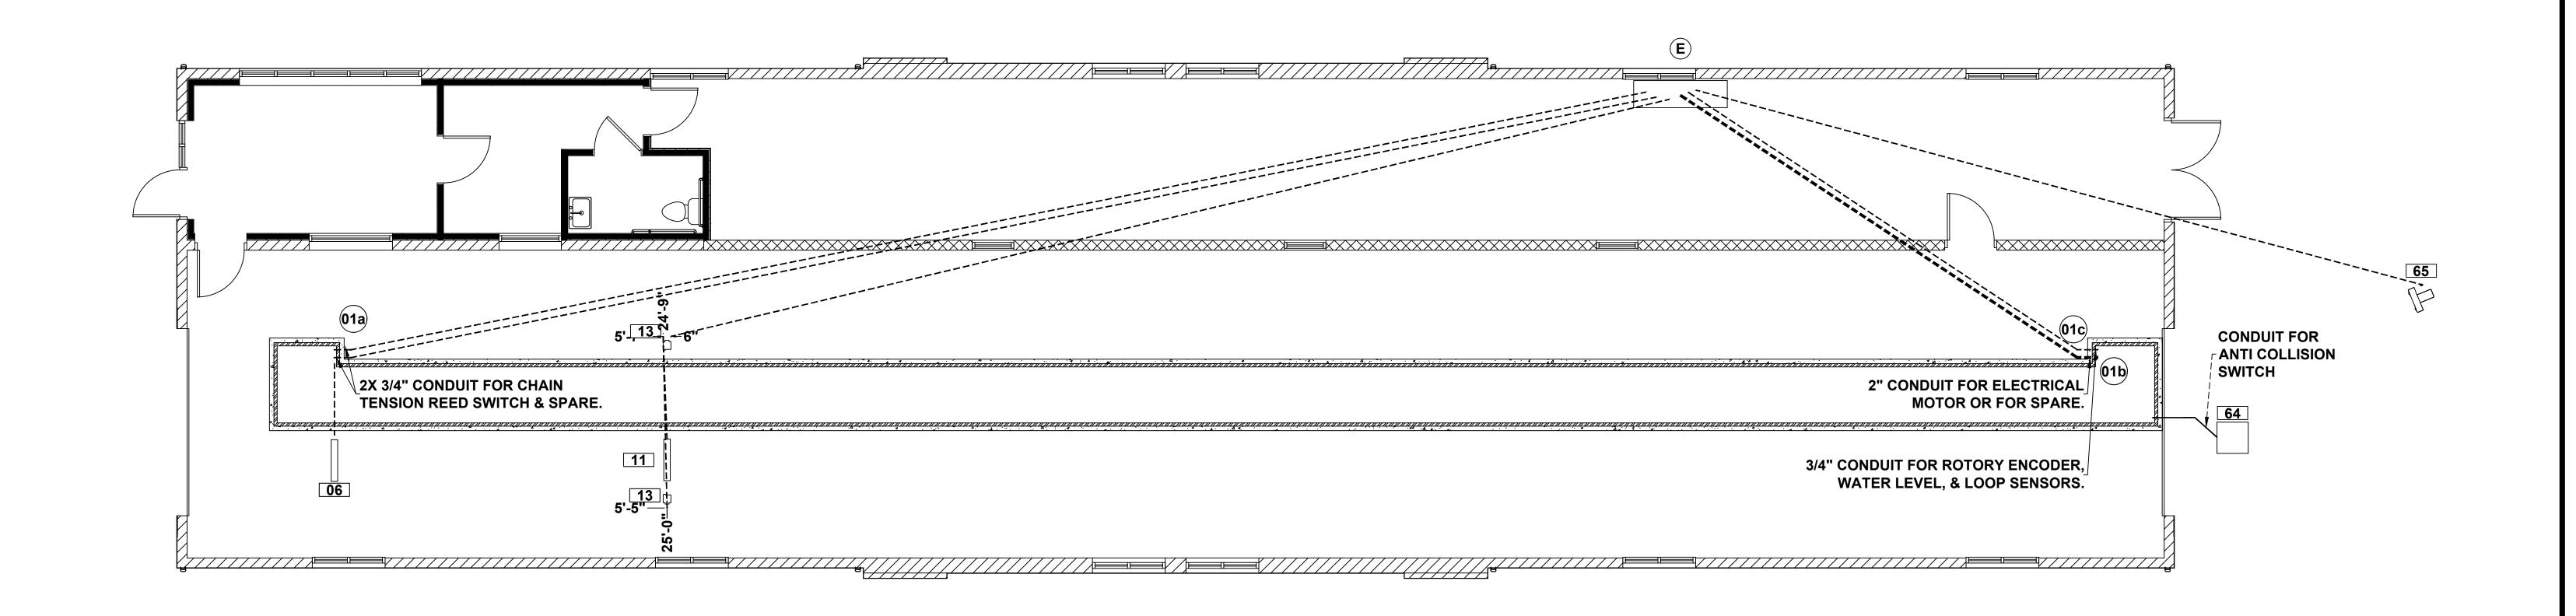

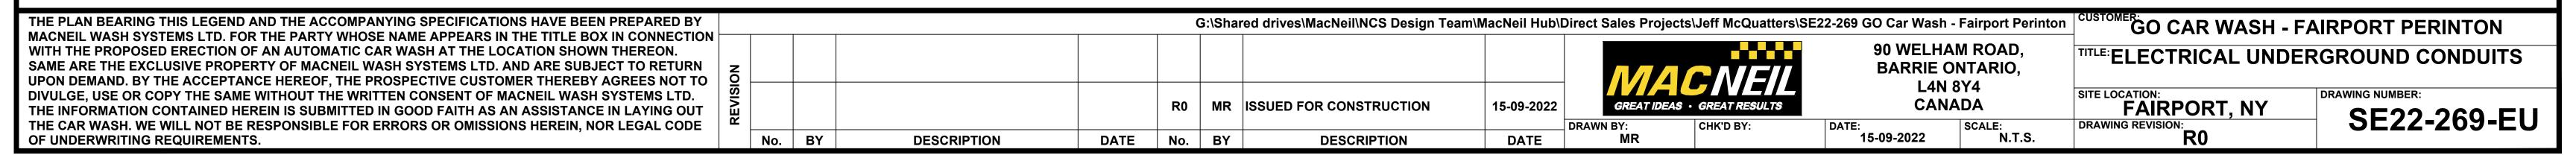

01-a 01-b 01-c 04 05 06 08 08-a 11 12 12-a 13	CONVEYOR XR-1000 CHAIN TENSION REED SWITCH CONVEYOR MOTOR - *ORDER DEPENDANT SEE NOTES* XR-1000 ROTORY ENCODER & FLOAT SWITCHES	MODEL XR1000	SOURCE #	SOURCE -	(V)	POWER	(A)	PHASE	QUANTITY (AWG)	TOTAL (ft)	SIZE (in)	TOTAL (ft)	NOTES
01-a 01-b 01-c 04 05 06 08 08-a 11 12 12-a 13	XR-1000 CHAIN TENSION REED SWITCH CONVEYOR MOTOR - *ORDER DEPENDANT SEE NOTES*			-									
01-b 01-c 04 05 06 08 08-a 11 12 12-a 13	CONVEYOR MOTOR - *ORDER DEPENDANT SEE NOTES*		 	TC	24	-	-	-	- 2/C#18AWG	-	- 2x 3/4"	-	LOCATED AT CONVEYOR ENTRANCE. SEE PDF EU FOR CONDUIT ROUTING.
01-c 04 05 06 08 08-a 11 12 12-a 13		_	E	VFD	460	3	7.8		4/C#12AWG	_	2 1/2"	_	IF ELECTRICAL MOTOR IS ORDERED PLEASE USE THESE SPECIFICATIONS. LOCATED AT
04 05 06 08 08-a 11 12 12-a 13		-			400	3	7.0		_	-		<u>-</u>	CONVEYOR TRENCH EXIT.
05 06 08 08-a 11 12 12-a 13	EMERGENCY STOP BUTTONS	-	E	TC TC	24	-	<u>-</u>	-	2X 2/C#18AWG 2/C#18AWG	-	3/4" 3/4"	-	LOCATED AT CONVEYOR TRENCH EXIT. SEE PDF EU FOR CONDUIT ROUTING. ELECTRICIAN TO RUN HOME RUN CABLES FROM EACH EMERGENCY STOP BUTTON TO TC.
06 08 08-a 11 12 12-a 13	EMERGENCY STOP BUTTONS EMERGENCY STOP BUTTONS	-	E	TC	24	-	<u> </u>	-	2/C#18AWG	_	3/4"	-	ELECTRICIAN TO RUN HOME RUN CABLES FROM EACH EMERGENCY STOP BUTTON TO TC.
08-a 11 12 12-a 13	TAPE SWITCH FOR ROLLER UP	-	E	TC	24	-	-	-	2/C#18AWG	-	3/4"	_	CAN BE RAN IN SAME CONDUIT AS THE CHAIN TENSION REED SWITCH.
11 12 12-a 13	PUSH BUTTON STATION - E-STOP / POWER	PBS4000	E	TC	24	-	-	-	4/C#18AWG	-	3/4"	-	
12 12-a 13	PBS4000 PUSH BUTTON STATION - NETWORKING	PBS4000	E	TC	24	-	-	-	1X CAT5E	-	3/4"	-	REQUIRES 1X CAT5E FOR COM WIRED TO MODEM IN TC.
12-a 13	TAPE SWITCH FOR CTA'S	-	E	TC	24	-	-	-	2/C#18AWG	-	3/4"	-	CEE MANUEACTURERIS CRECIEICATIONS FOR WIRING & DOWER REQUIREMENTS
13	BIG ASS ARCH CONTROL SIGNAL WIRES	-	F	TC TC	24 / 110 24 / 110	_	~11	1	3/C#14AWG 12/C#18AWG	-	3/4"	-	SEE MANUFACTURER'S SPECIFICATIONS FOR WIRING & POWER REQUIREMENTS.
	DOUBLE PHOTO EYES	IR-110-2	E	TC	24	_	<u>-</u>	-	SEE NOTE	-	3/4"	_	2X 3/C/18AWG REQUIRED FOR RECEIVERS & 2X 2/C/18AWG REQUIRED FOR EMITTERS.
15	UTILITY ARCH	-	-	-	-	-	-	-	-	-	-	-	
	LED RGBW LIGHT	-	E	TC	110	-	~3	1	3/C#14AWG	-	3/4"	-	
	GO BATH ADVERTISING SIGN	-	E	TC	110	-	~1	1	3/C#14AWG	-	3/4"	-	
	EVOLUTION TOP REACH	ETR		TC	110	-	<u>-</u> ~2	-	- 2/C#14AWG	-	3/4"	-	
	TOP BRUSH WITH 94 INCH CORE	RS1000	E	VFD	460	1	2.9	3	3/C#14AWG 4/C#12AWG	-	1 1/4"	-	FEED VFD RATED CABLES DIRECT TO MOTORS & GEL PACK MOTOR ENCLOSURE.
	WHEEL CLEARNER SIGN	-	E	TC	110	-	~1	1	3/C#14AWG	-	3/4"	-	
	TOP BRUSH WITH 94 INCH CORE	RS1000	E	VFD	460	1	2.9	3	4/C#12AWG		1 1/4"	-	FEED VFD RATED CABLES DIRECT TO MOTORS & GEL PACK MOTOR ENCLOSURE.
25	UTILITY ARCH	-	-	-	•	-	<u> </u>	-	-	-	-	-	
	LED RGBW LIGHT	-	<u> </u>	TC	110	-	~3	1	3/C#14AWG	-	3/4"	-	
	TRIPLE FOAM SIGN SUPERFLEX WRAP AROUND - LONG & SHORT ARM	- RS701	E	TC VFD	110 460	2X 1	~1 2X 2.9	7	3/C#14AWG 2X 4/C#12AWG	-	3/4" 2X 1 1/4"	-	FEED VFD RATED CABLES DIRECT TO MOTORS & GEL PACK MOTOR ENCLOSURE.
	EMERGENCY STOP BUTTONS		E	TC	24	-	<u> </u>	-	2/C#18AWG	-	3/4"	-	ELECTRICIAN TO RUN HOME RUN CABLES FROM EACH EMERGENCY STOP BUTTON TO TC.
	EMERGENCY STOP BUTTONS	-	E	TC	24	-	-	-	2/C#18AWG	-	3/4"	-	ELECTRICIAN TO RUN HOME RUN CABLES FROM EACH EMERGENCY STOP BUTTON TO TC.
35	SUPERFLEX WRAP AROUND - SHORT & LONG ARM	RS701	E	VFD	460	2X 1	2X 2.9	3	2X 4/C#12AWG	-	2X 1 1/4"	-	FEED VFD RATED CABLES DIRECT TO MOTORS & GEL PACK MOTOR ENCLOSURE.
	WARNING HORN	-	E	TC	24 / 110	-	~1	1	3/C#14AWG	-	3/4"	-	WARNING HORN SPECIFICATION: EDWARDS 8760GS 24VAC.
	PRIME DRY SIGN	-	E	TC	110	-	~1	1	3/C#14AWG	-	3/4"	-	CICN DACK LIGHTING DOWED CUDDLY DECUIDED
	PREMIER ARCH LED RGBW LIGHT	-	E	TC TC	110 110	_	~11 ~3	1	3/C#14AWG 3/C#14AWG	<u>-</u>	3/4" 3/4"	-	SIGN BACK LIGHTING POWER SUPPLY REQUIRED.
	EVOLUTION TOP REACH	ETR	-	-	-	-	-	-	3/G#14AVVG	-	-	_	
	LIGHT BAR KIT	-	E	TC	110	-	~3	1	3/C#14AWG	-	3/4"	-	
43	TOP BRUSH WITH 94 INCH CORE	RS1000	E	VFD	460	1	2.9	3	4/C#12AWG	-	1 1/4"	-	FEED VFD RATED CABLES DIRECT TO MOTORS & GEL PACK MOTOR ENCLOSURE.
45	UTILITY ARCH	-	-	-	-	-	-	-	-	-	_	-	
	LED RGBW LIGHT	-	E	TC	110	-	~3	1	3/C#14AWG	-	3/4"	-	
	LIGHT BAR KIT	-	F	TC TC	110 110	_	~1 ~3	1	3/C#14AWG 3/C#14AWG	-	3/4" 3/4"	-	SO CORD & 4"X4" WATERTIGHT PVC JUNCTION SUPPLIED & INSTALLED BY ELECTRICIAN.
	CERAMIC SIGN	-	E	TC	110	_	<u>3</u> ~1	1	3/C#14AWG	-	3/4"	_	OO OORD & + X4 WATERTIONT TO SONOTION OOT LEED & INSTALLED BY ELLOTRISIAN.
53	IDC DRYERS ON X-WIDE PROBUILD ARCH	-	E	STARTER MCC	460	2X 15	2X 21	3	2X 4/C#8AWG	-	2X 1 1/2"	-	USE SPLIT BOLT CONNECTORS AT MOTOR JB. WIRE SIZE BASED ON 4/C PER CONDUIT.
54	LIGHT BAR KIT	-	E	TC	110	-	~3	1	3/C#14AWG	-	3/4"	-	SO CORD & 4"X4" WATERTIGHT PVC JUNCTION SUPPLIED & INSTALLED BY ELECTRICIAN.
-	TOTAL BODY SIGN	-	E	TC	110	-	~1	1	3/C#14AWG	-	3/4"	-	OFL DAGK MOTOD ENGLOSUDE
	IDC DRYERS ON X-WIDE PROBUILD ARCH	MT2500	E	VFD STARTER MCC	460	2X 1 5X 15	2X 2.9 5X 21	3	2X 4/C#12AWG 5X 4/C#8AWG	-	2X 1-1/4" 5X 1 1/2"	-	GEL PACK MOTOR ENCLOSURE. USE SPLIT BOLT CONNECTORS AT MOTOR JB. WIRE SIZE BASED ON 4/C PER CONDUIT.
	LIGHT BAR KIT	-	E	TC	110	-	~3	1	3/C#14AWG	-	3/4"	-	SO CORD & 4"X4" WATERTIGHT PVC JUNCTION SUPPLIED & INSTALLED BY ELECTRICIAN.
	SHINY TIRES ADVERTISING SIGN	-	E	TC	110	-	~1	1	3/C#14AWG	-	3/4"	_	
-	IDC DRYERS & AIR KNIVES ON X-WIDE PROBUILD ARCH	-	E	STARTER MCC	460	5X 15	5X 21	3	5X 4/C#8AWG	-	5X 1 1/2"	-	USE SPLIT BOLT CONNECTORS AT MOTOR JB. WIRE SIZE BASED ON 4/C PER CONDUIT.
	LIGHT BAR KIT	-	E	TC	110	-	~3	1	3/C#14AWG	-	3/4"	-	SO CORD & 4"X4" WATERTIGHT PVC JUNCTION SUPPLIED & INSTALLED BY ELECTRICIAN.
	EMERGENCY STOP BUTTONS	-	E	TC	24	-	-	-	2/C#18AWG	-	3/4"	-	ELECTRICIAN TO RUN HOME RUN CABLES FROM EACH EMERGENCY STOP BUTTON TO TC.
0 3	EMERGENCY STOP BUTTONS	-	<u> </u>	TC	24	-	-	-	2/C#18AWG	-	3/4"	-	ELECTRICIAN TO RUN HOME RUN CABLES FROM EACH EMERGENCY STOP BUTTON TO TC. CAN BE RAN IN SAME CONDUIT AS THE ROTORY ENCODER. ELECTRICIAN WILL NEED TO PULL
64	ANTI COLLISION PAD	_	F	TC	24	_	_	_	2/C#18AWG		3/4"	_	SUPPLED CABLE TO TUNNEL CONTROLLER. IF LONGER CABLE IS REQUIRED ELECTRICIAN WILI
	ANTI VOLLIVIONI AD	_		10		_	-	_	LIOTIOAVIG		∪ / T	_	NEED TO SUPPLY & INSTALL TWISTED SHIELDED CABLE IN A CONDUIT & SPLICE IN A
65	TRAFFIC COMMANDER 2SECTIONS	_	E	TC	100-240	_	2X 12	1	5/C#14AWG	_	3/4"	_	WATERTIGHT PVC JUNCTION BOX. LOCATED AT EXIT END OF WASH BAY.
	EMERGENCY STOP BUTTONS	-	E	TC	24	-	- L/\ L	-	2/C#18AWG	-	3/4"	-	ELECTRICIAN TO RUN HOME RUN CABLES FROM EACH EMERGENCY STOP BUTTON TO TC.
	EMERGENCY STOP BUTTONS	-	E	TC	24	-	-	-	2/C#18AWG	-	3/4"	-	ELECTRICIAN TO RUN HOME RUN CABLES FROM EACH EMERGENCY STOP BUTTON TO TC.
	AIR COMPRESSOR - SCREW COMPRESSOR		Н	STARTER DP	460	10	14	3	4/C#12AWG	-	3/4"	-	THE AMPACITY LISTED IS ESTIMATED. ELECTRICIAN TO CONFIRM AMPACITY.
	AIR DRYER	-	F	DP	110	~1/3	~7.2	1	3/C#12AWG	-	3/4"	-	TYPICALLY REQUIRES A 1PH 110VAC 20A CIRCUIT. ELECTRICIAN TO CONFIRM AMPACITY.
	AIR DISTRIBUTION - SUPPLY	-	<u> </u>	TC	24 / 110	-	-	1	TBD	-	1"	-	THE AMPACITY LICTED IS COTIMATED. ELECTRICIAN TO CONCERN AND COT
υ	AIR COMPRESSOR MASTER CONTROL CENTER	MCC	H	STARTER DP DP	46U 460	7.5	11 	3	4/C#12AWG TBD	-	3/4" TBD	_	THE AMPACITY LISTED IS ESTIMATED. ELECTRICIAN TO CONFIRM AMPACITY.
F	208V/110V SECONDARY PANEL - BY OTHERS	SDP	G	STX	208 / 120	-	TBD	3	TBD	-	TBD	-	
					460 : 110 /	_		3		-		_	
	SECONDARY DISTRIBUTION TRANSFORMER - BY OTHERS	STX	Н	DP	208	-	TBD	3	TBD	-	TBD	-	
	MAIN ELECTRICAL PANEL - BY OTHERS	MDP	N/A	N/A	460	-	TBD	3	TBD	-	TBD	-	CONNECTED TO CAR WASHES MAIN POWER SOURCE.
1	WATER SOFTENER	-	F	DP	110	-	SEE NOTE	1	SEE NOTES	-	2x 3/4"	-	ELECTRICIAN TO SUPPLY & INSTALL 2X DEDICATED CIRCUITS WITH 15A OUTLETS
	SEE PAGE "GENERAL NOTES & RESPONSIBILITIES" FOR THE ELECTRICIAN NOTES AND DUTIES.												
IE PI AN	BEARING THIS LEGEND AND THE ACCOMPANYING SPECIFICATIONS HAVE BE	EN PRFPARFN RV					G:\Sharad	drives\Mac	Neil\NCS Design Toom*	acNoil Hub\Diro	ct Sales Projec	te\.loff McQuatt	ers\SE22-269 GO Car Wash - Fairport Perinton GO CAR WASH - FAIRPORT PERINTON

MACNEIL WASH SYSTEMS LTD. FOR THE PARTY WHOSE NAME APPEARS IN THE TITLE BOX IN CONNECTION WITH THE PROPOSED ERECTION OF AN AUTOMATIC CAR WASH AT THE LOCATION SHOWN THEREON. SAME ARE THE EXCLUSIVE PROPERTY OF MACNEIL WASH SYSTEMS LTD. AND ARE SUBJECT TO RETURN UPON DEMAND. BY THE ACCEPTANCE HEREOF, THE PROSPECTIVE CUSTOMER THEREBY AGREES NOT TO DIVULGE, USE OR COPY THE SAME WITHOUT THE WRITTEN CONSENT OF MACNEIL WASH SYSTEMS LTD. R0 MR ISSUED FOR CONSTRUCTION THE INFORMATION CONTAINED HEREIN IS SUBMITTED IN GOOD FAITH AS AN ASSISTANCE IN LAYING OUT THE CAR WASH. WE WILL NOT BE RESPONSIBLE FOR ERRORS OR OMISSIONS HEREIN, NOR LEGAL CODE OF UNDERWRITING REQUIREMENTS. No. BY **DESCRIPTION** DATE No. BY DESCRIPTION



DATE

90 WELHAM ROAD, BARRIE ONTARIO, **L4N 8Y4** CANADA DATE: 15-09-2022 SCALE: N.T.S. GO CAR WASH - FAIRPORT PERINTON EQUIPMENT ELECTRICAL SCHEDULE 1

SITE LOCATION: FAIRPORT, NY DRAWING REVISION:

SE22-269-E1

ITEM#	EQUIPMENT DESCRIPTION	MODEL	ELECTRICAL SOURCE #	ELECTRICAL SOURCE	VOLTAGE (V)	HORSE POWER	AMPACITY (A)	PHASE	WIRE SIZE & QUANTITY (AWG)	WIRE TOTAL (ft)	CONDUIT SIZE (in)	CONDUIT TOTAL (ft)	NOTES
J	BOOSTER PUMP	BP-5HP60G60 P	E	DP	460	5	7.6	3	4/C#12AWG	-	3/4"	-	TYPICALLY REQUIRES A 3PH 460VAC 20A CIRCUIT. ELECTRICIAN TO CONFIRM AMPACITY.
J-a	CONTROL SIGNAL WIRES	-	E	TC	24 / 110	-	-	1	4/C#18AWG	-	3/4"	-	
L	HYDRAULIC POWERPACK	-	E	STARTER MCC	460	2X 10	2X 14	3	2X 4/C#12AWG	-	2X 3/4"	-	
L-a	LOW OIL LEVEL SENSOR	-	E	TC	24	-	-	1	2/C#18AWG	-	3/4"	-	
L-b	CONTROL SIGNAL WIRES	-	E	TC	24 / 110	-	<u>-</u>	1	4/C#18AWG	-	3/4"	-	
M	GLOSS BOSS CHEMICAL PANEL	-	E	TC	24 / 110	-	-	1	3/C#18AWG	-	3/4"	-	
N	AIR DISTRIBUTION PANEL 2	-	E	TC	24 / 110	-	-	1	25/C#18AWG	-	1"	-	
0	CAROLINA PRIDE - 5 PORT WATER DISTRIBUTION PANEL 2	-	E	TC	24 / 110	-	-	1	25/C#18AWG	-	1"	-	
Р	HYDRAULIC POWERPACK	-	E	STARTER MCC	460	10	14	3	4/C#12AWG	-	3/4"	-	
P-a	LOW OIL LEVEL SENSOR	-	E	TC	24	-	-	1	2/C#18AWG	-	3/4"	-	
P-b	CONTROL SIGNAL WIRES	-	E	TC	24 / 110	-	-	1	4/C#18AWG	-	3/4"	-	
Q	MAGNUM HIGH PRESSURE PUMP 15HP	M2000R	E	STARTER MCC	460	15	21	3	4/C#12AWG	-	3/4"	-	
Q-a	LOW WATER LEVEL SENSOR	-	E	TC	24	-	-	1	2/C#18AWG	-	3/4"	-	
R	HYDRAULIC POWERPACK	-	E	STARTER MCC	460	10	14	3	4/C#12AWG	-	3/4"	-	
R-a	LOW OIL LEVEL SENSOR	-	E	TC	24	-	-	1	2/C#18AWG	-	3/4"	-	
R-b	CONTROL SIGNAL WIRES	-	E	TC	24 / 110	-	-	1	4/C#18AWG	-	3/4"	-	
S	HYDRAFLEX CHEMICAL PANELS XD X2	-	E	TC	24 / 110	-	~3	1	M12 CABLE	-	1"	-	CONNECT SUPPLIED HOMERUN CABLES BACK TO MCC.
Т	HYDRAFLEX GRUNDFOS PUMP	-	Н	DP	460	7.5	11	3	4/C#12AWG	-	1 1/4"	-	CONNECT THE 2/C#18AWG TERMPERATURE SWITCH TO THE CONTROL PANEL LOCATED BESIDE THE HFI PANEL.
U	AIR DISTRIBUTION - RS701	-	E	TC	24 / 110	-	-	1	TBD	-	1"	-	
V	AIR DISTRIBUTION - RS701	-	E	TC	24 / 110	-	-	1	TBD	-	1"	-	
W	CAROLINA PRIDE - 7 PORT WATER DISTRIBUTION PANEL 1	-	E	TC	24 / 110	-	-	1	25/C#18AWG	-	1"	-	
X	MAGNUM HIGH PRESSURE PUMP 15HP	M2000R	E	STARTER MCC	460	15	21	3	4/C#12AWG	-	3/4"	-	
X-a	LOW WATER LEVEL SENSOR	-	E	TC	24	-	-	1	2/C#18AWG	-	3/4"	-	
Υ	CAROLINA PRIDE PUMPING STATION	-	E	STARTER MCC	460	7.5	11	3	4/C#12AWG	-	3/4"	-	
Y-a	LOW WATER LEVEL SENSOR	-	E	TC	24	-	-	1	2/C#18AWG	-	3/4"	-	
Z	CAROLINA PRIDE PUMPING STATION	-	E	STARTER MCC	460	7.5	11	3	4/C#12AWG	-	3/4"	-	
Z-a	LOW WATER LEVEL SENSOR	-	E	TC	24	-	-	1	2/C#18AWG	-	3/4"	-	
AA	HYDRAFUSE - DOUBLE PUMP - NON-FOAMING	-	E	TC	24 / 110	-	-	1	3/C#18AWG	-	3/4"	-	
AB	AIR DISTRIBUTION PANEL	-	E	TC	24 / 110	-	-	1	25/C#18AWG	-	1"	-	
_													

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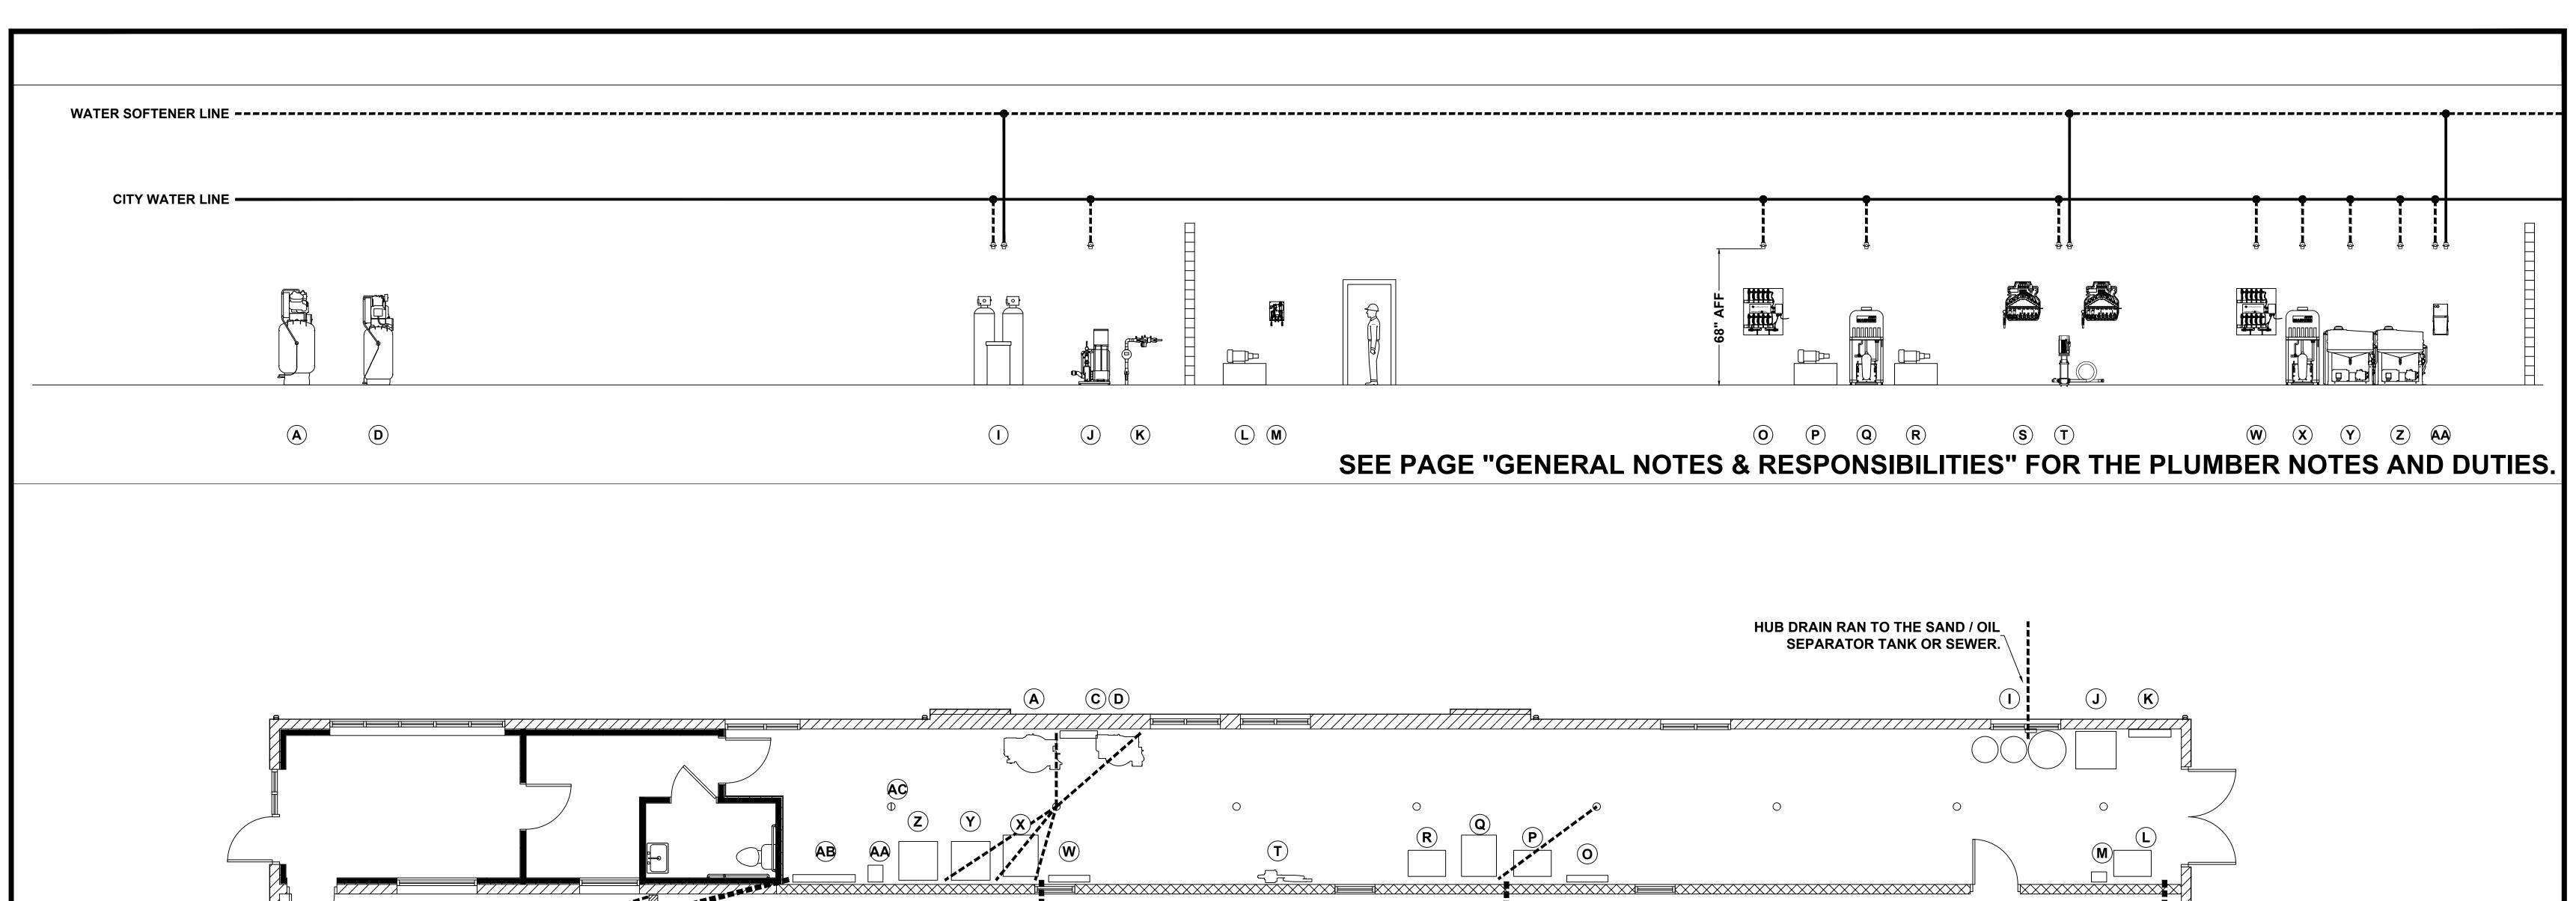
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ISION										MEIL	90 WELHAI BARRIE OI	NTARIO,	T
REVISI					R0	MR	ISSUED FOR CONSTRUCTION	15-09-2022		GREAT RESULTS	L4N 8 CANA		S
Œ	No.	BY	DESCRIPTION	DATE	No.	BY	DESCRIPTION	DATE	DRAWN BY: MR	CHK'D BY:	DATE: 15-09-2022	SCALE: N.T.S.	D




GO CAR WASH - FAIRPORT PERINTON EQUIPMENT ELECTRICAL SCHEDULE 2

DRAWING REVISION: SCALE: N.T.S. DATE: 15-09-2022

SITE LOCATION: FAIRPORT, NY SE22-269-E2



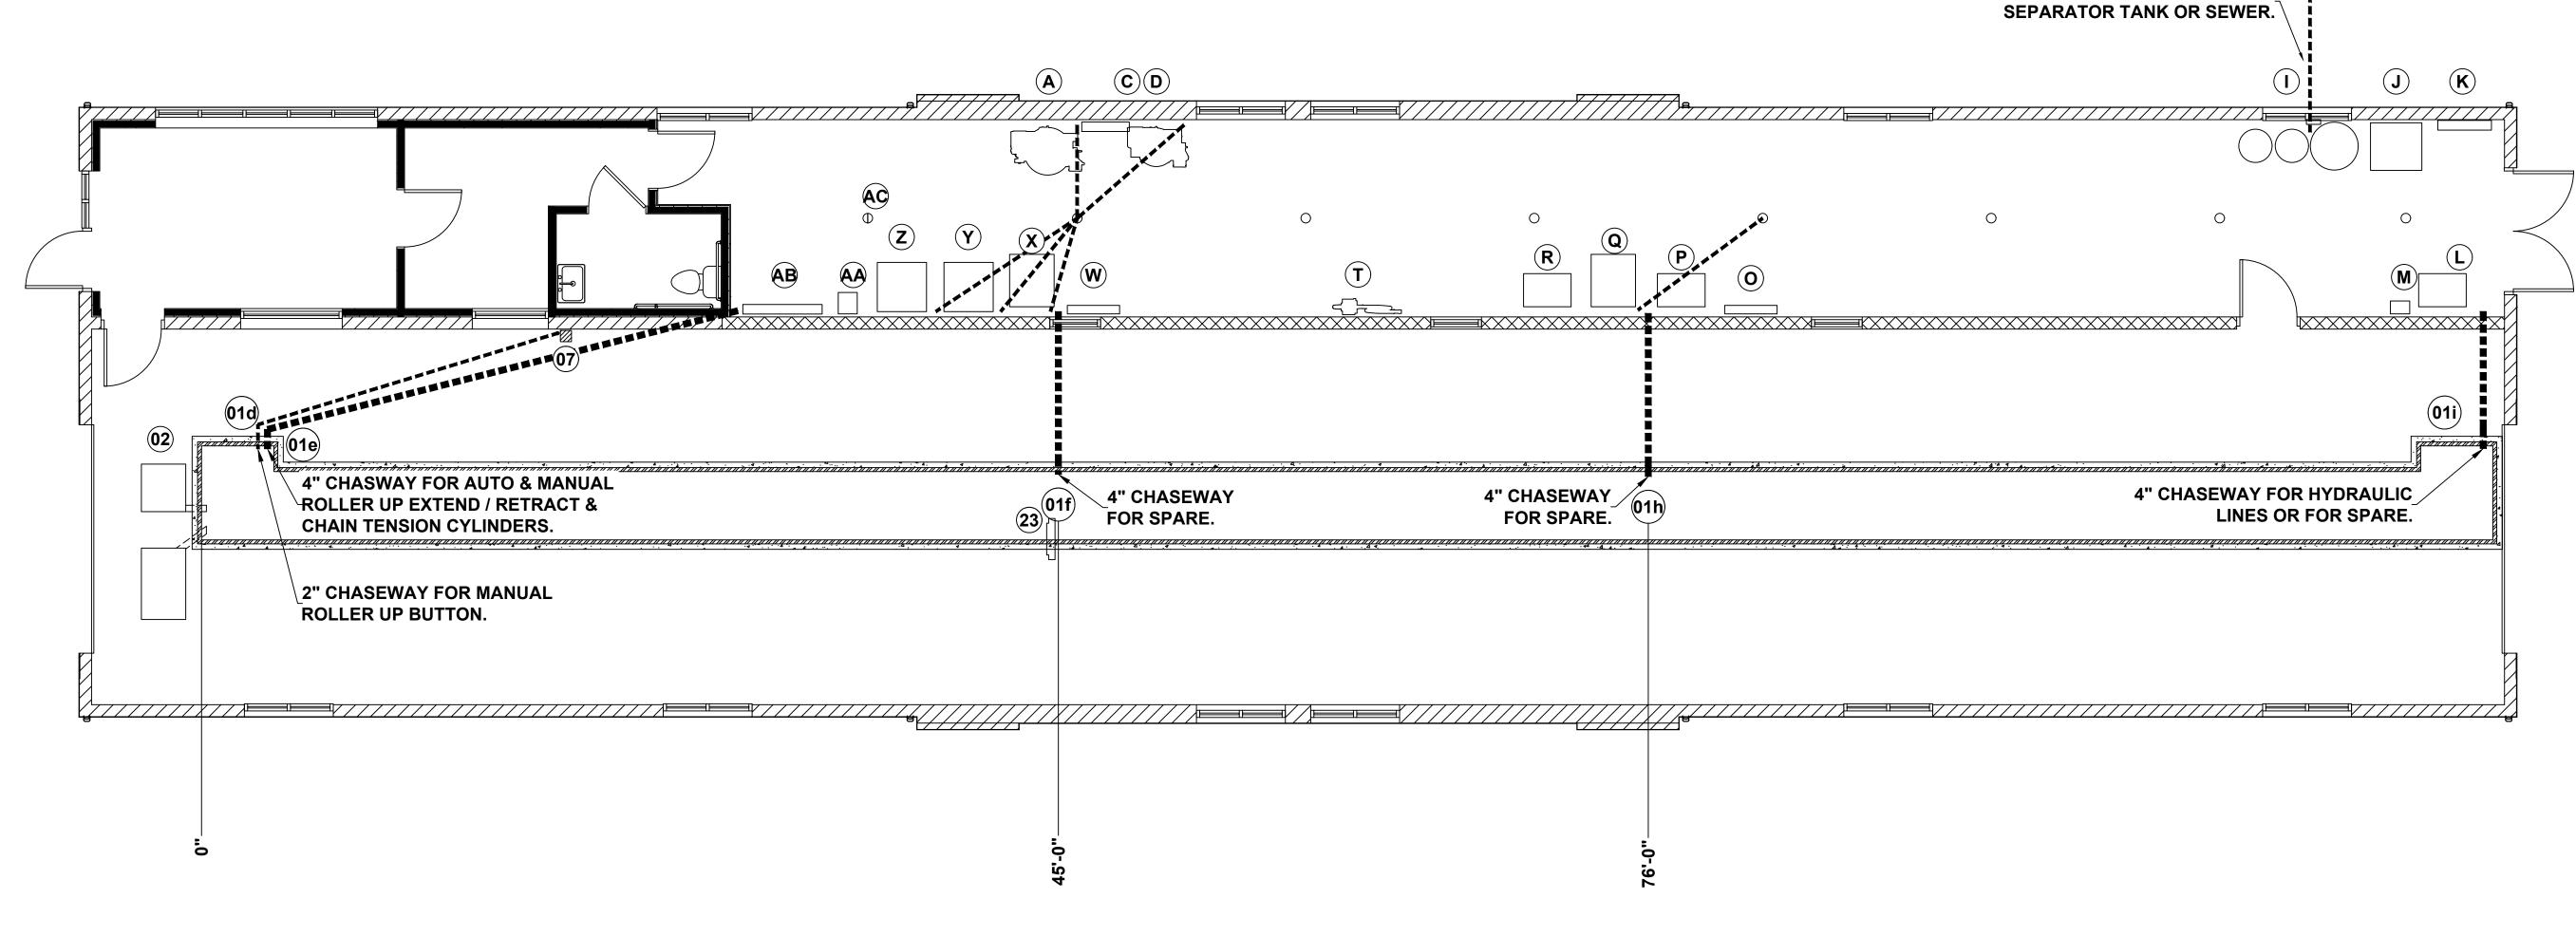


G:\Shared drives\MacNeil\NCS Design Team\MacNeil Hub\Direct Sales Projects\Jeff McQuatters\SE22-269 GO Car Wash - Fairport Perinton GO CAR WASH - FAIRPORT PERINTON THE PLAN BEARING THIS LEGEND AND THE ACCOMPANYING SPECIFICATIONS HAVE BEEN PREPARED BY MACNEIL WASH SYSTEMS LTD. FOR THE PARTY WHOSE NAME APPEARS IN THE TITLE BOX IN CONNECTION WITH THE PROPOSED ERECTION OF AN AUTOMATIC CAR WASH AT THE LOCATION SHOWN THEREON. 90 WELHAM ROAD, WATER HARDLINE PLUMBING & SAME ARE THE EXCLUSIVE PROPERTY OF MACNEIL WASH SYSTEMS LTD. AND ARE SUBJECT TO RETURN **BARRIE ONTARIO**, **UNDERGROUND DRAINS CHASEWAYS** UPON DEMAND. BY THE ACCEPTANCE HEREOF, THE PROSPECTIVE CUSTOMER THEREBY AGREES NOT TO L4N 8Y4 DIVULGE, USE OR COPY THE SAME WITHOUT THE WRITTEN CONSENT OF MACNEIL WASH SYSTEMS LTD. SITE LOCATION: **CANADA FAIRPORT, NY** R0 MR ISSUED FOR CONSTRUCTION 15-09-2022 GREAT IDEAS · GREAT RESULTS DRAWING REVISION: THE INFORMATION CONTAINED HEREIN IS SUBMITTED IN GOOD FAITH AS AN ASSISTANCE IN LAYING OUT **SE22-269-WU** THE CAR WASH. WE WILL NOT BE RESPONSIBLE FOR ERRORS OR OMISSIONS HEREIN, NOR LEGAL CODE DRAWN BY: SCALE: CHK'D BY: OF UNDERWRITING REQUIREMENTS. 15-09-2022 N.T.S. No. BY **DESCRIPTION** DATE No. BY **DESCRIPTION** DATE

ITEM # EQUIPMENT DESCRIPTION	MODEL	WATER SOURCE #	SIZE	QUANTITY	TOTAL LENGTH	PLUMBING TYPE	FITTING TYPE	INITIAL PSI	GPM	WATER NOTES
01 CONVEYOR	XR1000	-	-	-	-	-	-	-	-	
01-b CONVEYOR MOTOR - *ORDER DEPENDANT SEE NOTES*	-	L	1/2"	2	-		-	1000	-	IF HYDRAULIC MOTOR IS ORDERED PLEASE USE THESE SPECIFICATIONS & RUN 2X 1/2" STAINLESS STEEL JIC HYDRAULIC LINES TO CONVEYOR TRENCH EXIT.
01-f CONVEYOR TRENCH MIDDLE - SPARE CHASEWAY	-	TBD	4"	1	-	SCH 40	-	-	-	CHASEWAY RAN FROM THE BACKROOM TO THE TRENCH FOR SPARE AIR & WATER LINES.
01-g CONVEYOR TRENCH MIDDLE - SPARE CHASEWAY	-	TBD	4"	1	-	SCH 40	-	-	-	CHASEWAY RAN FROM THE BACKROOM TO THE TRENCH FOR SPARE AIR & WATER LINES.
01-h CONVEYOR TRENCH MIDDLE - SPARE CHASEWAY	-	TBD	4"	1	-	SCH 40	-	-	-	CHASEWAY RAN FROM THE BACKROOM TO THE TRENCH FOR SPARE AIR & WATER LINES.
01-i CONVEYOR TRENCH MIDDLE - SPARE CHASEWAY	- VD400	TBD	4"	1	-	SCH 40	-	-	-	CHASEWAY RAN FROM THE BACKROOM TO THE TRENCH FOR SPARE AIR & WATER LINES.
02 CORRELATOR 02-a CORRELATOR - EXCESS RUN OFF DRAIN LINES	XR120	- 01	2X 4"	-	<u>-</u>	- SCH 40	-	-	-	REQUIRES DRAIN PIPES FROM CORRELATOR PIT TO TRENCH ENTRANCE.
03 PREP GUNS	-	Z	3/8"	2		HP HOSE	-	600-1000	8	REQUIRES BRAINT II EST ROM SORRELATORTH TO TRENST ENTRAISE.
09 BUG PREP GUN	-	AA	3/8"	1	-	POLY	-	100	4	
10 PREP GUNS	-	Y	3/8"	2	-	HP HOSE	-	600-1000	8	
14 CHEMICAL TIRE APPLICATOR - WHEEL RITE PRECISION	СТА	S	3/8"	1-2	-	POLY	-	40-80	4	
15 UTILITY ARCH 15-b 2X SINGLE BOOMERANG FOAMERS	-		1/2"	1-2	-	POLY	-	- 175-200	-	
15-b 2X SINGLE BOOMERANG FOAMERS 15-c SINGLE HOLE FOAMING RAIN BAR	-	<u>s</u> s	1/2"	1-2	<u> </u>	POLY	-	40-80	6.75-9.75	
18 FOAMING RAIN BAR	-	S	1/2"	1	-	LP HOSE	-	40-80	6-12	
19 MAGNUM WHEEL BOSS WITH BRISTLE BRUSH	MW2000	-	-	-	-	-	-	-	-	
19-c HYDRAULIC LINES	-	R	1/2"	3	-	SS JIC	-	800-900	4	RUN 2X 1/2" STAINLESS STEEL JIC HYDRAULIC LINES TO HYDRAULIC POWERPACK AND RUN A 1/2" STAINLESS STEEL JIC HYDRAULIC LINE INBETWEEN THE DRIVER SIDE AND PASSENGER SIDE OF THE EQUIPMENT.
19-d HYDRAULIC LINES CHASEWAY	- DC4000	R	4"	1	-	SCH 40	-	40.90	-	4" CHASEWAY RAN FROM THE HYDRAULIC POWER PACK.
20 TOP BRUSH WITH 94 INCH CORE 22 TOP BRUSH WITH 94 INCH CORE	RS1000 RS1000	0	3/8"	1	<u>-</u> -	POLY	-	40-80 40-80	2	
23 LOW PRESSURE UNDERCARRIAGE SPRAY	RW-100	0	3/4"	1	<u>-</u>	LP HOSE	-	40-80	9	
24 WHEEL BLASTER - 6 NOZZLES WITH FOLLOWING FEATURE	WB-600-FF	X	SEE NOTES	1-2	-	HP HOSE	-	600-1000	16	3/4" SUPPLY LINE UP TO 50' & 1" SUPPLY LINE OVER 50'.
25 UTILITY ARCH	-	-	-	-	-	-	-	-	-	
25-b RAIN BAR WITH MOUNTING BRACKETS (3X FOAM GENERATOR)	-	<u> </u>	1/2"	1	-	POLY	-	40-80	6.75-9.75	
26 CHEMICAL TIRE APPLICATOR - WHEEL RITE PRECISION 28 LOW SIDE WASHER WITH 30" CORE - QUADPACK	CTA RS400	S 	3/8" 1/2"	1-2 1-2	-	POLY	-	40-80 40-80	4.8	
28-d HYDRAULIC LINES	-	R	1/2"	3	-	SS JIC	-	800-900	4.8	RUN 2X 1/2" STAINLESS STEEL JIC HYDRAULIC LINES TO HYDRAULIC POWERPACK AND RUN A 1/2" STAINLESS STEEL JIC HYDRAULIC LINE INBETWEEN THE DRIVER SIDE AND PASSENGER SIDE OF THE EQUIPMENT.
29 SINGLE BOOMERANG FOAMERS SQUARE MOUNTED	-	S	1/2"	1-2	-	POLY	-	175-200	2	
30 SUPERFLEX WRAP AROUND - LONG & SHORT ARM	RS701	W	1/2"	1-2	-	POLY	-	40-80	3.2	
34 SINGLE BOOMERANG FOAMERS SQUARE MOUNTED	-	S	1/2"	1-2	-	POLY	-	175-200	2	
35 SUPERFLEX WRAP AROUND - SHORT & LONG ARM 37 MAGNUM FORCE - OSCILLATING ARCH WITH 4 HEADS	RS701	W	1/2" 1/2"	1-2	-	POLY SS JIC	-	40-80 800-900	3.2	RUN 6X 1/2" STAINLESS STEEL JIC HYDRAULIC LINES TO HYDRAULIC POWERPACK.
37-a BASKET NOZZLES	-	<u>Р</u>	1/2	1	<u> </u>	HP HOSE	-	600-1000	24	3/4" SUPPLY LINE UP TO 50' & 1" SUPPLY LINE OVER 50'.
39 PREMIER ARCH	-	-	-	-	-	-	-	-	-	
39-b RAIN BAR WITH MOUNTING BRACKETS (FOAM GENERATOR)	-	S	1/2"	1	-	POLY	-	40-80	6.75-9.75	
41 FOAMING RAIN BAR	-	S	1/2"	1	-	LP HOSE	-	40-80	6-12	
42 LOW SIDE WASHER WITH 30" CORE	RS400	W	1/2"	1-2	-	POLY	-	40-80	4.8	RUN 2X 1/2" STAINLESS STEEL JIC HYDRAULIC LINES TO HYDRAULIC POWERPACK AND RUN A 1/2" STAINLESS
42-c HYDRAULIC LINES	-	P	1/2"	3	-	SS JIC	-	800-900	4	STEEL JIC HYDRAULIC LINE INBETWEEN THE DRIVER SIDE AND PASSENGER SIDE OF THE EQUIPMENT.
43 TOP BRUSH WITH 94 INCH CORE	RS1000	0	3/8"	1	-	POLY	-	40-80	2	
44 RAIN BAR	RW112	0	3/4"	1	-	LP HOSE	-	40-80	6-12	
45 UTILITY ARCH	-	-	-	-	-	-	-	475.000	-	
45-b 2X SINGLE BOOMERANG FOAMERS 45-c 2X SINGLE BOOMERANG FOAMERS	-	S	1/2"	1-2 1-2	<u>-</u>	POLY	-	175-200 175-200	2	
46 RAIN BAR	RW112	0	3/4"	1	<u> </u>	LP HOSE	-	40-80	6-12	
48 MIRROR RINSE	-	0	1/2"	1-2	-	POLY	-	40-80	TBD	
50 RAIN BAR	RW112	0	3/4"	1	-	LP HOSE	-	40-80	6-12	
56 GLOSS BOSS 9' BRUSH	MT2500	M	3/8"	4	-	POLY	-	-	<1	
A AIR COMPRESSOR - SCREW COMPRESSOR	-	- A.C	2"	-	-	- CCU 40	-	-	-	DRAIN DAN TO THE BACKBOOM TRENCH FOR CONDENSATION DUN OFF
A-a AIR COMPRESSOR - CONDENSATION RUNOFF D AIR COMPRESSOR	-	AC -		-	<u> </u>	SCH 40 -	-	-	-	DRAIN RAN TO THE BACKROOM TRENCH FOR CONDENSATION RUN OFF.
D-a AIR COMPRESSOR - CONDENSATION RUNOFF	-	AC	2"	1	-	SCH 40	-	-	-	DRAIN RAN TO THE BACKROOM TRENCH FOR CONDENSATION RUN OFF.
I WATER SOFTENER	-	J	2x 2"	2	-	CU PIPE	-	40	TBD	PLUMBER TO SUPPLY & INSTALL 2" HOSE FOR BACK FLUSH, 2X 3/8" TUBE FOR BRINE WATER, & 2X 1" HOSE FOR REJECT WATER.
I-a REGENERATION / OVERFLOW	- DD #UD4444	AC	2" + 2X 1"	3	-	SCH 40 / LP HOSE	-	-	-	DRAIN RAN TO THE BACKROOM TRENCH FOR REGENERATION / OVERFLOW.
J BOOSTER PUMP	BP-5HP60G60 P	K	2"	1	-	CU PIPE	-	60	60	
K WATER MAIN / BACKFLOW PREVENTER - BY OTHERS L HYDRAULIC POWERPACK	-	CITY N/A	2"	1		CU PIPE	_	40-80	TBD	
M GLOSS BOSS CHEMICAL PANEL	-	N/A N/A	1/2"	1	<u> </u>	POLY	-	N/A	- <1	CONNECTED TO CHEMICAL BARREL
O CAROLINA PRIDE - 5 PORT WATER DISTRIBUTION PANEL 2	-	J	1"	1	-	CU PIPE	-	TBD	TBD	
P HYDRAULIC POWERPACK	-	N/A	-	-	-	-	-	-	-	

SEE PAGE "GENERAL NOTES & RESPONSIBILITIES" FOR THE PLUMBER NOTES AND DUTIES.

THE PLAN BEARING THIS LEGEND AND THE ACCOMPANYING SPECIFICATIONS HAVE BEEN PREPARED BY MACNEIL WASH SYSTEMS LTD. FOR THE PARTY WHOSE NAME APPEARS IN THE TITLE BOX IN CONNECTION lueWITH THE PROPOSED ERECTION OF AN AUTOMATIC CAR WASH AT THE LOCATION SHOWN THEREON. SAME ARE THE EXCLUSIVE PROPERTY OF MACNEIL WASH SYSTEMS LTD. AND ARE SUBJECT TO RETURN UPON DEMAND. BY THE ACCEPTANCE HEREOF, THE PROSPECTIVE CUSTOMER THEREBY AGREES NOT TO DIVULGE, USE OR COPY THE SAME WITHOUT THE WRITTEN CONSENT OF MACNEIL WASH SYSTEMS LTD. THE INFORMATION CONTAINED HEREIN IS SUBMITTED IN GOOD FAITH AS AN ASSISTANCE IN LAYING OUT THE CAR WASH. WE WILL NOT BE RESPONSIBLE FOR ERRORS OR OMISSIONS HEREIN, NOR LEGAL CODE OF UNDERWRITING REQUIREMENTS.

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REVISION					R0	MR	ISSUED FOR CONSTRUCTION	15-09-2022
	No.	BY	DESCRIPTION	DATE	No.	BY	DESCRIPTION	DATE

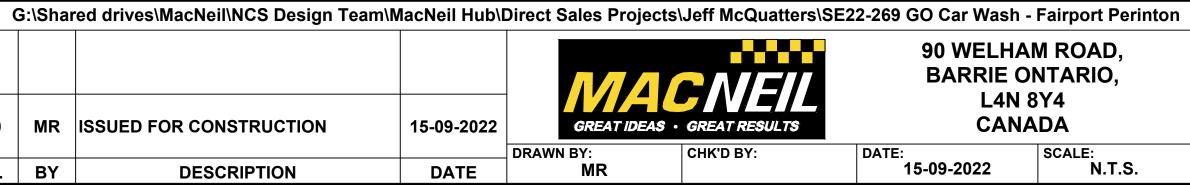

90 WELHAM ROAD, BARRIE ONTARIO, **L4N 8Y4** CANADA DATE: 15-09-2022

GO CAR WASH - FAIRPORT PERINTON **EQUIPMENT WATER** SCHEDULE 1

DRAWING REVISION: SCALE: N.T.S.

SITE LOCATION: FAIRPORT, NY SE22-269-W1

ITEM # EQUIPMENT DESCRIPTION	MODEL	WATER SOURCE #	SIZE	QUANTITY	TOTAL LENGTH	PLUMBING TYPE	FITTING TYPE	INITIAL PSI	GPM	WATER NOTES
Q MAGNUM HIGH PRESSURE PUMP 15HP	M2000R	J	1"	3	-	CU PIPE / SCH80 PVC	-	1000	20	REQUIRES A 1" CU PIPE, 1" SCH80 PVC DROP FOR FILL TANK & 1" SUPPLIED LP HOSE FOR OVERFLOW TO DRAIN.
Q-b DRAIN / OVERFLOW	-	AC	2"	1	-	SCH 40	-	-	-	DRAIN RAN TO THE BACKROOM TRENCH FOR MAINTENACE / OVERFLOW.
R HYDRAULIC POWERPACK	-	N/A	-	-	-	-	-	-	-	
S HYDRAFLEX CHEMICAL PANELS XD X2	-	T	1"	2	-	HP HOSE	-	175-200	TBD	CONNECT THE SUPPLIED 1/2" HP HOSE FROM PUMP TO PANELS
T HYDRAFLEX GRUNDFOS PUMP	-	J/I	2"	1	-	CU PIPE	-	40-80	40	
W CAROLINA PRIDE - 7 PORT WATER DISTRIBUTION PANEL 1	-	J	1"	1	-	CU PIPE	-	TBD	TBD	
X MAGNUM HIGH PRESSURE PUMP 15HP	M2000R	J	1"	3	-	CU PIPE / SCH80 PVC	-	1000	20	REQUIRES A 1" CU PIPE, 1" SCH80 PVC DROP FOR FILL TANK & 1" SUPPLIED LP HOSE FOR OVERFLOW TO DRAIN.
X-b DRAIN / OVERFLOW	-	AC	2"	1	-	SCH 40	-	-	-	DRAIN RAN TO THE BACKROOM TRENCH FOR MAINTENACE / OVERFLOW.
Y CAROLINA PRIDE PUMPING STATION	-	J	SEE NOTE	2	-	CU PIPE	-	100-1600	8	REQUIRES A 3/4" CU PIPE DROP FOR FILL TANK & 1" SUPPLIED LP HOSE FOR OVERFLOW TO DRAIN.
Y-b DRAIN / OVERFLOW	-	AC	2"	1	-	SCH 40	-	-	-	DRAIN RAN TO THE BACKROOM TRENCH FOR MAINTENACE / OVERFLOW.
Z CAROLINA PRIDE PUMPING STATION	-	J	SEE NOTE	2	-	CU PIPE	-	100-1600	8	REQUIRES A 3/4" CU PIPE DROP FOR FILL TANK & 1" SUPPLIED LP HOSE FOR OVERFLOW TO DRAIN.
Z-b DRAIN / OVERFLOW	-	AC	2"	1	-	SCH 40	-	-	-	DRAIN RAN TO THE BACKROOM TRENCH FOR MAINTENACE / OVERFLOW.
AA HYDRAFUSE - DOUBLE PUMP - NON-FOAMING	-	J/I	3/4"	1	-	CU PIPE	-	40-80	6	
AC BACKROOM TRENCH - HUB DRAIN	-	N/A	2"	1	-	SCH 40	-	-	-	HUB DRAIN RAN TO THE SAND / OIL SEPARATOR TANK.

SEE PAGE "GENERAL NOTES & RESPONSIBILITIES" FOR THE PLUMBER NOTES AND DUTIES.

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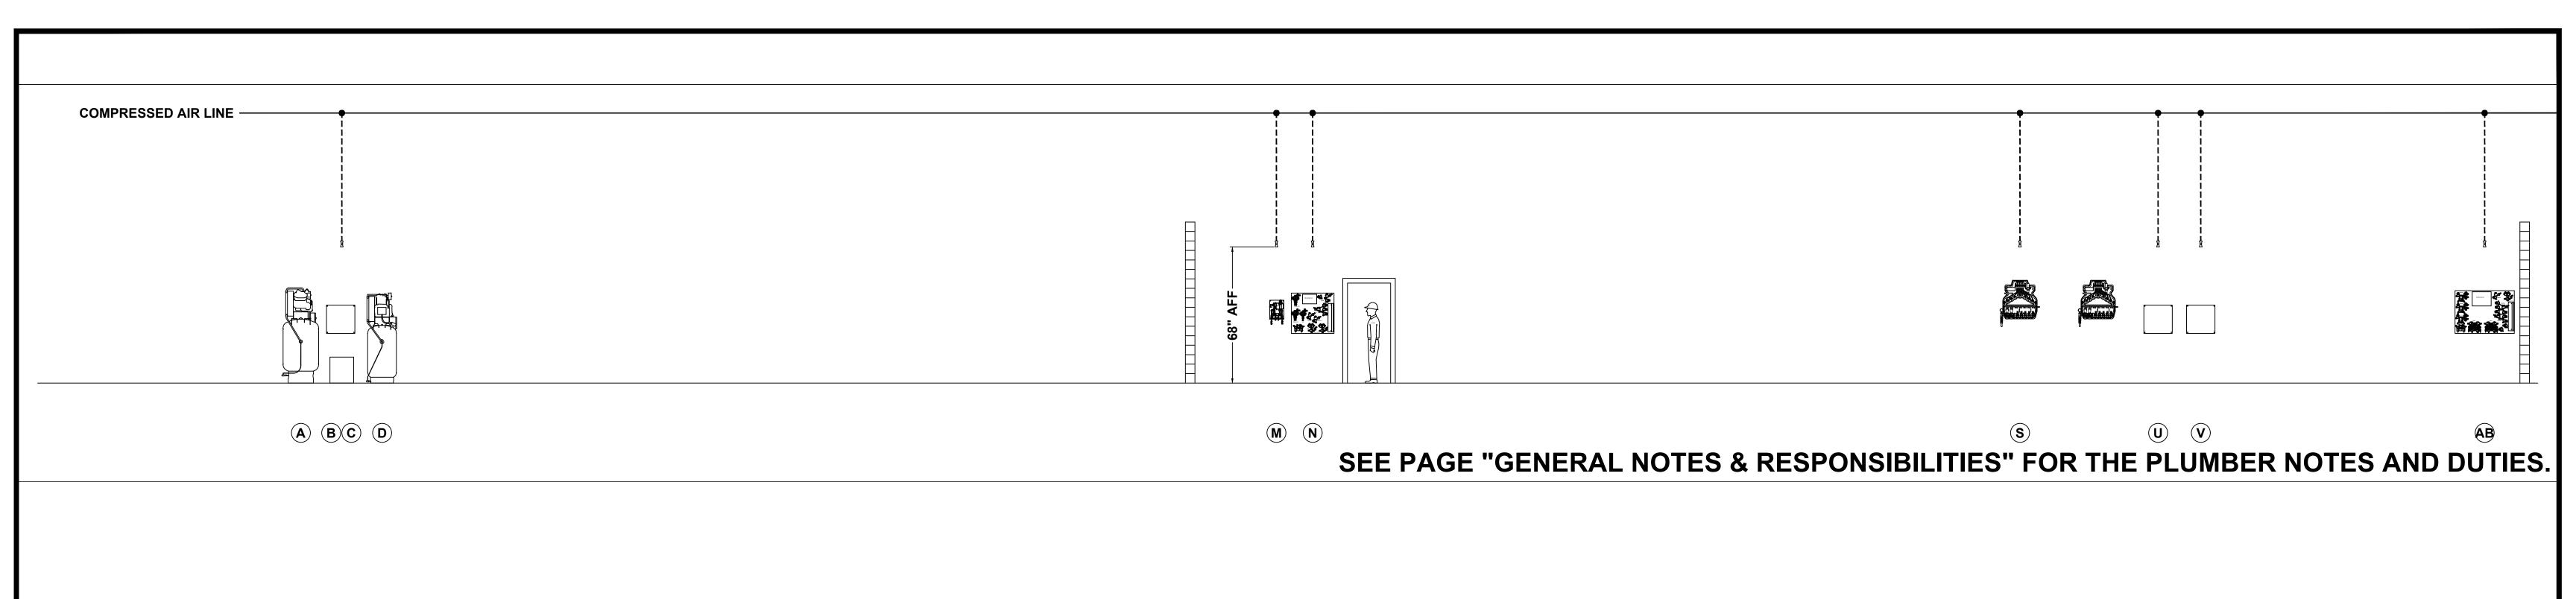



90 WELHAM ROAD, BARRIE ONTARIO, **L4N 8Y4** CANADA SCALE: N.T.S. 15-09-2022

SITE LOCATION:
FAIRPORT, NY

GO CAR WASH - FAIRPORT PERINTON **EQUIPMENT WATER SCHEDULE 2**

DRAWING REVISION: SE22-269-W2



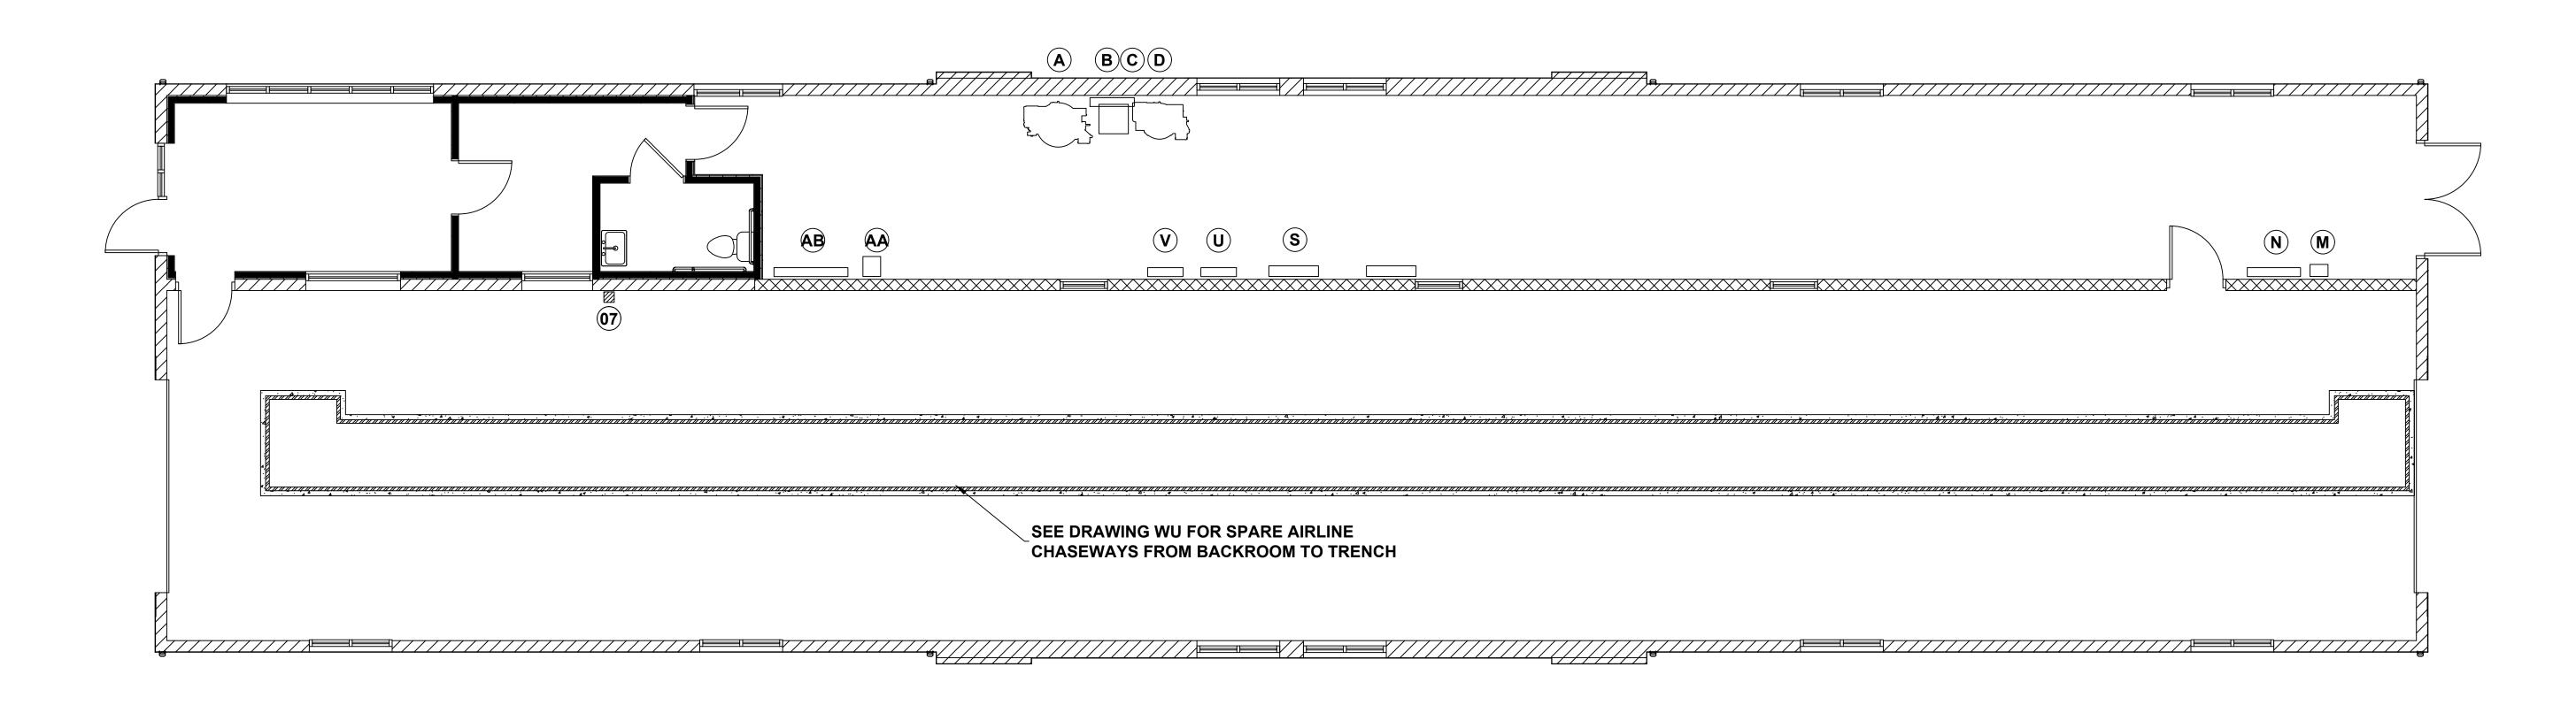


GO CAR WASH - FAIRPORT PERINTON G:\Shared drives\MacNeil\NCS Design Team\MacNeil Hub\Direct Sales Projects\Jeff McQuatters\SE22-269 GO Car Wash - Fairport Perinton THE PLAN BEARING THIS LEGEND AND THE ACCOMPANYING SPECIFICATIONS HAVE BEEN PREPARED BY MACNEIL WASH SYSTEMS LTD. FOR THE PARTY WHOSE NAME APPEARS IN THE TITLE BOX IN CONNECTION 90 WELHAM ROAD, WITH THE PROPOSED ERECTION OF AN AUTOMATIC CAR WASH AT THE LOCATION SHOWN THEREON. AIR HARDLINE PLUMBING & SAME ARE THE EXCLUSIVE PROPERTY OF MACNEIL WASH SYSTEMS LTD. AND ARE SUBJECT TO RETURN BARRIE ONTARIO, **UNDERGROUND CHASEWAYS** UPON DEMAND. BY THE ACCEPTANCE HEREOF, THE PROSPECTIVE CUSTOMER THEREBY AGREES NOT TO L4N 8Y4 DIVULGE, USE OR COPY THE SAME WITHOUT THE WRITTEN CONSENT OF MACNEIL WASH SYSTEMS LTD. SITE LOCATION: **CANADA** FAIRPORT, NY R0 MR ISSUED FOR CONSTRUCTION 15-09-2022 THE INFORMATION CONTAINED HEREIN IS SUBMITTED IN GOOD FAITH AS AN ASSISTANCE IN LAYING OUT **SE22-269-AU** SCALE: N.T.S. THE CAR WASH. WE WILL NOT BE RESPONSIBLE FOR ERRORS OR OMISSIONS HEREIN, NOR LEGAL CODE DRAWING REVISION: DRAWN BY: OF UNDERWRITING REQUIREMENTS. 15-09-2022 No. BY **DESCRIPTION** DATE No. BY **DESCRIPTION** DATE

ITEM#	EQUIPMENT DESCRIPTION	MODEL	AIR	SIZE	QUANTITY	TOTAL	PLUMBING	FITTING	COLOR	INITIAL PSI	AIR NOTES
			SOURCE #		- QUARTITI	LENGTH	TYPE	TYPE			AIN NOTES
	CONVEYOR CONVEYOR TRENCH ENTRANCE - AIRLINE CHASEWAY	XR1000	07	2"	1	-	SCH 40	-	-	-	2" CHASEWAY RAN FROM TRENCH ENTRANCE TO THE MANUAL ROLLER UP BUTTON.
				4 "	1		SCH 40	'		+	4" CHASEWAY RAN FROM TRENCH ENTRANCE TO AIR PANEL FOR MAIN CALL UP & CHAIN TENSIONER
	CONVEYOR TRENCH ENTRANCE - AIRLINE CHASEWAY	-	AB	4	1			-		-	CYLINDERS.
	XR-1000 MAIN CALL UP CYLINDER - EXTEND PRESSURE	-	AB	1/4"	1	-	POLY	-	GREEN	-	
	XR-1000 MAIN CALL UP CYLINDER - RETRACT PRESSURE	-	AB	1/4"	1 1		POLY	- '	RED	-	
	XR-1000 CHAIN TENSION CYLINDERS - SUPPLY PRESSURE XR-1000 MANUAL PUSH BUTTON - SUPPLY PRESSURE	-	AB AB	1/4" 1/4"	1	-	POLY POLY	-	ORANGE BLACK	-	
			AD			-		-,		-	1X TUBE FROM THE LCI BOX AND 2X TUBES FROM THE CONVEYOR BACK UP CYLINDER RAN TO THE MANUAL
07	MANUAL ROLLER UP BUTTON	-	N	1/4"	3	-	POLY	-	BLACK	80-100	ROLLER UP BUTTON. AIR SOLENOID LOCATED AT THE LCI BOX.
	BACK UP CALL UP CYLINDER - EXTEND PRESSURE	-	AB	1/4"	1	-	POLY	-	YELLOW	-	
	BACK UP CALL UP CYLINDER - RETRACT PRESSURE	-	AB	1/4"	1	-	POLY	-	BLUE	-	
	BUG PREP GUN	-	AA	3/8"	1		POLY	-	BLACK	50-60	
	CHEMICAL TIRE APPLICATOR - WHEEL RITE PRECISION	СТА	<u> </u>	3/8"	1-2	-	POLY	- '	BLACK	20-25	
	UTILITY ARCH 2X SINGLE BOOMERANG FOAMERS	-		3/8"	1-2	-	POLY	-	- BLACK	5-20	
	SINGLE HOLE FOAMING RAIN BAR	-	<u> </u>	3/8"	1-2	-	POLY	-	BLACK	20-25	
	FOAMING RAIN BAR	-	S	3/8"	2	-	POLY	-	BLACK	5-20	
	MAGNUM WHEEL BOSS WITH BRISTLE BRUSH	MW2000	AB	1/4"	3-4	_	POLY	-	BLACK	40-100	
	DS & PS BRUSHES - EXTEND PRESSURE	-	AB	1/4"	1	-	POLY	-	RED	20-25	
	DS & PS BRUSHES - RETRACT PRESSURE		AB	1/4"	1	_	POLY		BLACK	40-50	
20	TOP BRUSH WITH 94 INCH CORE	RS1000	AB	1/4"	3		POLY		BLACK	80-100	
	TOP BRUSH - CUSHION PRESSURE	-	AB	1/4"	1	-	POLY	- ,	BLACK	5-7	(CLEAR COLOR ON TOP BRUSH)
	TOP BRUSH - WASH PRESSURE	-	AB	1/4"	1	-	POLY	- '	BLUE	25-30	
	TOP BRUSH - RETRACT	-	AB	1/4"	1 1	-	POLY	- '	RED	60-70	
	TOP BRUSH WITH 94 INCH CORE	RS1000	AB	1/4"	3	-	POLY	-	BLACK	80-100	The second of th
	TOP BRUSH - CUSHION PRESSURE	-	AB	1/4"	1 1		POLY	- '	BLACK	5-7	(CLEAR COLOR ON TOP BRUSH)
	TOP BRUSH - WASH PRESSURE	-	AB AB	1/4"	1		POLY	-	BLUE	25-30 60-70	
	TOP BRUSH - RETRACT WHEEL BLASTER - 6 NOZZLES WITH FOLLOWING FEATURE	- WB-600-FF	AB N	1/4" 1/4"	2-4	-	POLY POLY	-	RED BLACK	60-70 30-100	
	EXTEND PRESSURE	VVD-000-i i	N N	1/4"	1	-	POLY	-	RED	30-100 20-25	
-	RETRACT PRESSURE	-	N	1/4"	1	-	POLY	-	RED	20-25	
	UTILITY ARCH	-	-	-	-	_	-	_	-	-	
	RAIN BAR WITH MOUNTING BRACKETS (3X FOAM GENERATOR)	-	S	3/8"	1	_	POLY	-	BLACK	20-25	
	CHEMICAL TIRE APPLICATOR - WHEEL RITE PRECISION	СТА	S	3/8"	1-2		POLY		BLACK	20-25	
28	LOW SIDE WASHER WITH 30" CORE - QUADPACK	RS400	AB	1/4"	4	-	POLY		BLACK	80-100	
	DS BRUSH - EXTEND PRESSURE	-	AB	1/4"	1	-	POLY		BLUE	15	
	PS BRUSH - EXTEND PRESSURE		AB	1/4"	1	-	POLY	- '	BLUE	25	
	DS & PS BRUSHES - RETRACT PRESSURE	-	AB	1/4"	1	-	POLY	-	RED	40-50	
	SINGLE BOOMERANG FOAMERS SQUARE MOUNTED	- DS704	<u> </u>	3/8"	2	-	POLY	- '	BLACK	5-20	· · · · · · · · · · · · · · · · · · ·
	SUPERFLEX WRAP AROUND - LONG & SHORT ARM DS & DS WRAP AROUNDS SHORT ARMS - SEALING DRESSURE	RS701	V	1/4"	9-10		POLY POLY	- '	BLACK	80-100 30-45	
	DS & PS WRAP AROUNDS SHORT ARMS - SEALING PRESSURE DS & PS MAIN ARM - EXTEND PRESSURE	-	V V	1/4" 1/4"	1	-	POLY	- '	CLEAR BLACK	30-45 5-10	
	DS & PS MAIN ARM - EXTEND PRESSURE DS & PS SECONDARY ARM - EXTEND PRESSURE		V	1/4" 1/4"	1	-	POLY		GREEN	5-10 25-40	
	DS & PS SECONDARY ARM - EXTEND PRESSURE DS & PS MAIN ARM - RETRACT PRESSURE	-	V	1/4"	1		POLY	<u>-</u>	RED	25-40 25-40	<u>, </u>
	DS & PS MAIN ARM - RETRACT PRESSURE DS & PS SECONDARY ARM - RETRACT PRESSURE	_	\ \ \ \ \ \ \ \ \ \ \ \ \ \ \ \ \ \ \	1/4"	1	_	POLY		BLUE	25-40	
	DS & PS WRAP AROUNDS - BOOST PRESSURE	-		1/4"	1	_	POLY	-	N/A	25-40	
	SINGLE BOOMERANG FOAMERS SQUARE MOUNTED	-	S	3/8"	2	_	POLY	-	BLACK	5-20	
	SUPERFLEX WRAP AROUND - SHORT & LONG ARM	RS701	U	1/4"	9-10		POLY		BLACK	80-100	
35-a	DS & PS WRAP AROUNDS SHORT ARMS - SEALING PRESSURE	-	U	1/4"	1	-	POLY		CLEAR	30-45	
35-b	DS & PS MAIN ARM - EXTEND PRESSURE	-	U	1/4"	1	-	POLY		BLACK	5-10	
	DS & PS SECONDARY ARM - EXTEND PRESSURE	-	U	1/4"	1	-	POLY	- ,	GREEN	25-40	
	DS & PS MAIN ARM - RETRACT PRESSURE	-	U	1/4"	1	-	POLY	-	RED	25-40	
	DS & PS SECONDARY ARM - RETRACT PRESSURE		<u>U</u>	1/4"	1 1	-	POLY	- '	BLUE	25-40	
	DS & PS WRAP AROUNDS - BOOST PRESSURE	-	U AD	1/4"	1	-	POLY	-	N/A	25-40	
	MAGNUM FORCE - OSCILLATING ARCH WITH 4 HEADS	-	AB	3/8"			POLY	- '	BLACK	40-100	
	PREMIER ARCH RAIN BAR WITH MOUNTING BRACKETS (FOAM GENERATOR)	-		3/8"	- 1		POLY	- '	- BLACK	20-25	
	FOAMING RAIN BAR	-	-	3/8"	2	-	POLY	-	BLACK	20-25 5-20	
	LOW SIDE WASHER WITH 30" CORE	RS400	AB	1/4"	3-4		POLY		BLACK	5-20 80-100	
	DS & PS BRUSHES - EXTEND PRESSURE	- K5400	AB	1/4"	1	-	POLY	-	BLUE	25	
	DS & PS BRUSHES - RETRACT PRESSURE	_	AB	1/4"	1	_	POLY	_	RED	40-50	
	TOP BRUSH WITH 94 INCH CORE	RS1000	AB	1/4"	3	_	POLY	-	BLACK	80-100	
	TOP BRUSH - CUSHION PRESSURE		AB	1/4"	1		POLY		BLACK	5-7	(CLEAR COLOR ON TOP BRUSH)
	TOP BRUSH - WASH PRESSURE	-	AB	1/4"	1	-	POLY		BLUE	25-30	
	TOP BRUSH - RETRACT	-	AB	1/4"	1	-	POLY	-	RED	60-70	
	UTILITY ARCH	-	-	-	-	-	-	-	-	-	
	2X SINGLE BOOMERANG FOAMERS		S	3/8"	1-2	-	POLY	- '	BLACK	5-20	
45-c	2X SINGLE BOOMERANG FOAMERS	-	S	3/8"	1-2	-	POLY	- '	BLACK	5-20	
1											SEE PAGE "GENERAL NOTES & RESPONSIBILITIES" FOR THE PLUMBER NOTES AND DUTII
THE DI AL	THE ACCOMPANYING SPECIFICATIONS HAVE REEN	TOTAL DEL DV						THE PAGE DOG	- MaraNail		
	N BEARING THIS LEGEND AND THE ACCOMPANYING SPECIFICATIONS HAVE BEEN P WASH SYSTEMS LTD. FOR THE PARTY WHOSE NAME APPEARS IN THE TITLE BOX \parallel		4			T	G:\Sharea arives	MacNell/NC2 Design	gn leam\wacnen	Hub\Direct Sales F	Projects\Jeff McQuatters\SE22-269 GO Car Wash - Fairport Perinton CUSTOMER: GO CAR WASH - FAIRPORT PERINTON
	EDPODOSED EDECTION OF AN AUTOMATIC CAD WASH AT THE LOCATION SHOWN T		i I i i			- 1 i			İ		90 WELHAM ROAD TITLE.

MACNEIL WASH SYSTEMS LTD. FOR THE PARTY WHOSE NAME APPEARS IN THE TITLE BOX IN CONNECTION WITH THE PROPOSED ERECTION OF AN AUTOMATIC CAR WASH AT THE LOCATION SHOWN THEREON. SAME ARE THE EXCLUSIVE PROPERTY OF MACNEIL WASH SYSTEMS LTD. AND ARE SUBJECT TO RETURN UPON DEMAND. BY THE ACCEPTANCE HEREOF, THE PROSPECTIVE CUSTOMER THEREBY AGREES NOT TO DIVULGE, USE OR COPY THE SAME WITHOUT THE WRITTEN CONSENT OF MACNEIL WASH SYSTEMS LTD. THE INFORMATION CONTAINED HEREIN IS SUBMITTED IN GOOD FAITH AS AN ASSISTANCE IN LAYING OUT THE CAR WASH. WE WILL NOT BE RESPONSIBLE FOR ERRORS OR OMISSIONS HEREIN, NOR LEGAL CODE OF UNDERWRITING REQUIREMENTS.

No.	BY	DESCRIPTION	DATE	No.	BY	DESCRIPTION	DATE
				R0	MR	ISSUED FOR CONSTRUCTION	15-09-2022

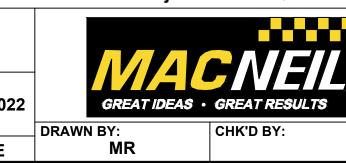

90 WELHAM ROAD,
BARRIE ONTARIO,
L4N 8Y4
CANADA

DATE:
15-09-2022
SCALE:
N.T.S.

TITLE: EQUIPMENT AIR
SCHEDULE 1

SITE LOCATION: DRAWING NUMBER:

SCHEDULE OF SITE LOCATION:
FAIRPORT, NY
DRAWING REVISION:
R0

SE22-269-A1

ITEM # EQUIPMENT DESCRIPTION	MODEL	AIR SOURCE#	SIZE	QUANTITY	TOTAL LENGTH	PLUMBING TYPE	FITTING TYPE	COLOR	INITIAL PSI	AIR NOTES
53 IDC DRYERS ON X-WIDE PROBUILD ARCH	-	N N	1/4"	2	-	POLY	-	BLACK	80-100	
56 GLOSS BOSS 9' BRUSH	MT2500	N	1/4"	3-4	-	POLY	-	BLACK	40-100	
56-a DS BRUSHES - EXTEND PRESSURE	-	N	1/4"	1	-	POLY	-	RED	4-7	
56-b PS BRUSHES - EXTEND PRESSURE	-	N	1/4"	1	-	POLY	-	RED	9-12	
57 IDC DRYERS ON X-WIDE PROBUILD ARCH	-	N	1/4"	5	-	POLY	-	BLACK	80-100	
60 IDC DRYERS & AIR KNIVES ON X-WIDE PROBUILD ARCH	-	N	1/4"	5	-	POLY	-	BLACK	80-100	
A AIR COMPRESSOR - SCREW COMPRESSOR	-	N/A	3/4"	1	-	HP HOSE	-		175	HP HOSE REQUIRED TO AIR DRYER OR BALL VALVE.
B AIR DRYER	-	A/D	3/4"	1	-	CU PIPE	-		150-200	
C AIR DISTRIBUTION - SUPPLY	-	В	1/2"	1	-	CU PIPE	-		80-100	
D AIR COMPRESSOR	-	N/A	3/4"	1	-	HP HOSE	-		175	HP HOSE REQUIRED TO AIR DRYER OR BALL VALVE.
M GLOSS BOSS CHEMICAL PANEL	-	С	1/4"	1	-	CU PIPE	-		50-80	
N AIR DISTRIBUTION PANEL 2	-	С	1/2"	1	-	CU PIPE	-		80-100	
S HYDRAFLEX CHEMICAL PANELS XD X2	-	С	2X 1/2"	2	-	CU PIPE	-		80-100	
U AIR DISTRIBUTION - RS701	-	С	1/2"	1	-	CU PIPE	-		80-100	
V AIR DISTRIBUTION - RS701	-	С	1/2"	1	-	CU PIPE	-		80-100	
AB AIR DISTRIBUTION PANEL	-	С	1/2"	1	-	CU PIPE	-		80-100	

SEE PAGE "GENERAL NOTES & RESPONSIBILITIES" FOR THE PLUMBER NOTES AND DUTIES.

THE PLAN BEARING THIS LEGEND AND THE ACCOMPANYING SPECIFICATIONS HAVE BEEN PREPARED BY MACNEIL WASH SYSTEMS LTD. FOR THE PARTY WHOSE NAME APPEARS IN THE TITLE BOX IN CONNECTION lueeWITH THE PROPOSED ERECTION OF AN AUTOMATIC CAR WASH AT THE LOCATION SHOWN THEREON. SAME ARE THE EXCLUSIVE PROPERTY OF MACNEIL WASH SYSTEMS LTD. AND ARE SUBJECT TO RETURN UPON DEMAND. BY THE ACCEPTANCE HEREOF, THE PROSPECTIVE CUSTOMER THEREBY AGREES NOT TO DIVULGE, USE OR COPY THE SAME WITHOUT THE WRITTEN CONSENT OF MACNEIL WASH SYSTEMS LTD. THE INFORMATION CONTAINED HEREIN IS SUBMITTED IN GOOD FAITH AS AN ASSISTANCE IN LAYING OUT THE CAR WASH. WE WILL NOT BE RESPONSIBLE FOR ERRORS OR OMISSIONS HEREIN, NOR LEGAL CODE OF UNDERWRITING REQUIREMENTS.


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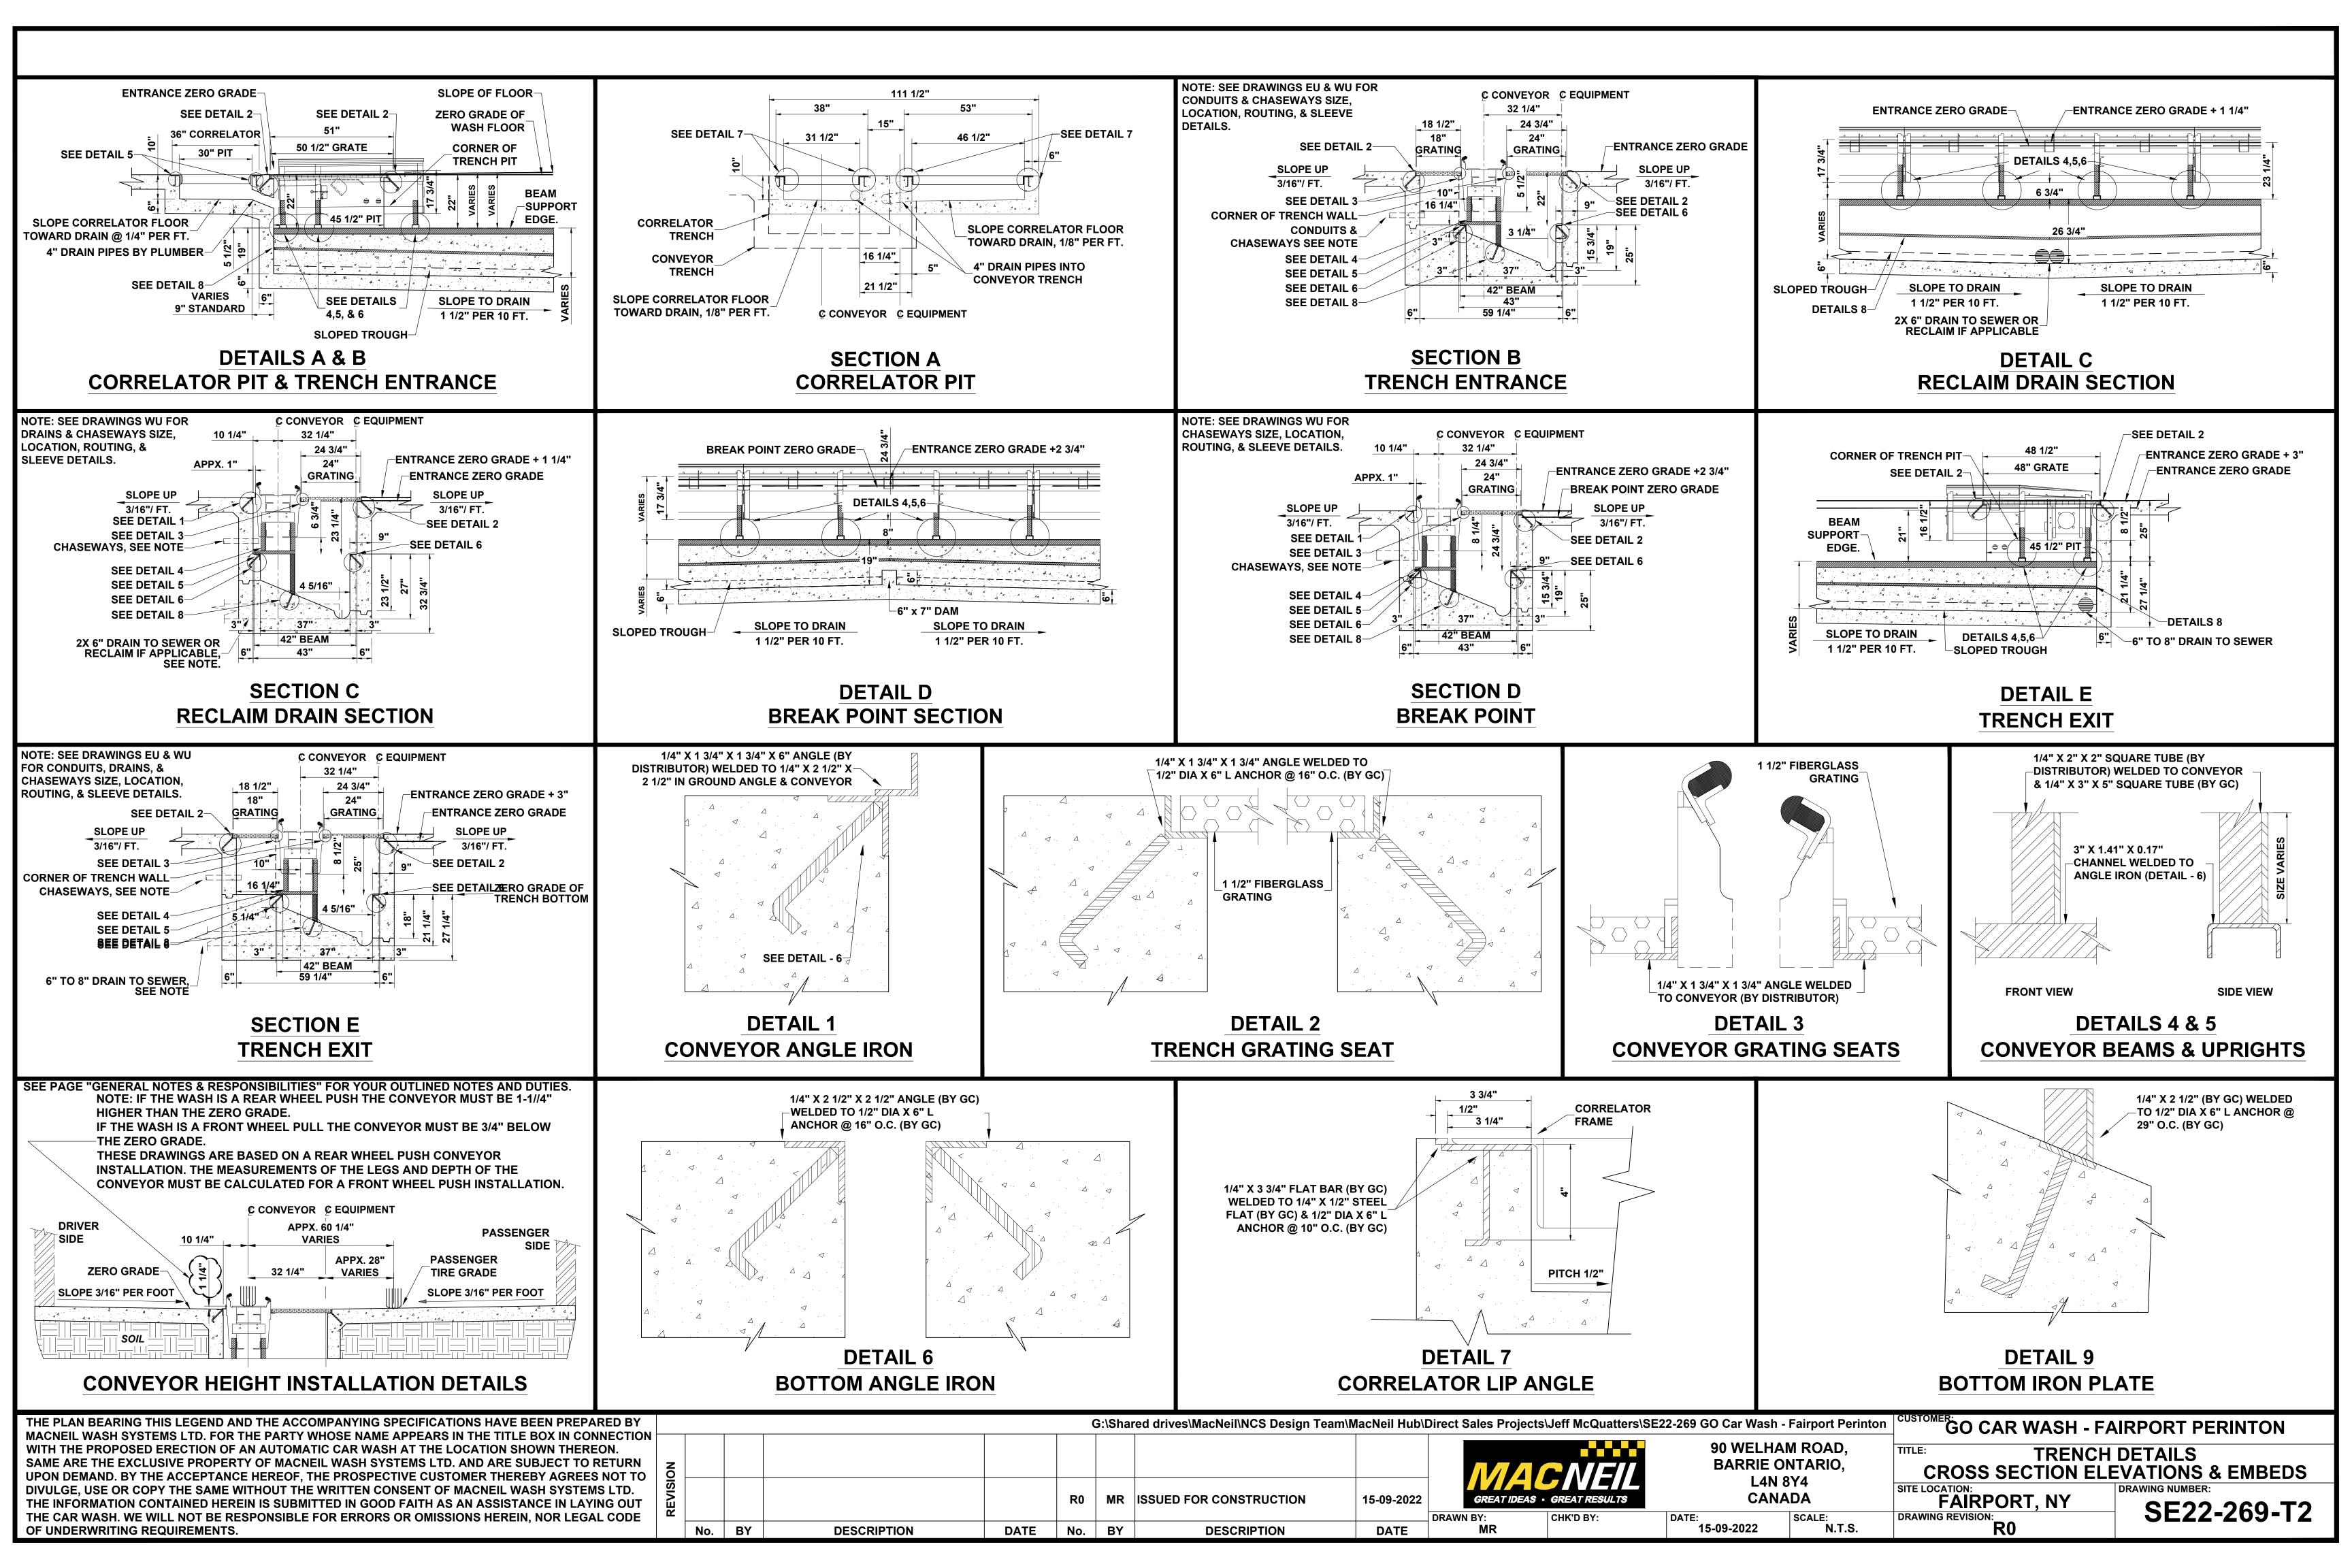


90 WELHAM ROAD, BARRIE ONTARIO, **L4N 8Y4** CANADA SCALE: N.T.S. DATE: 15-09-2022


GO CAR WASH - FAIRPORT PERINTON EQUIPMENT AIR SCHEDULE 2 SITE LOCATION:
FAIRPORT, NY DRAWING NUMBER: SE22-269-A2

DRAWING REVISION:




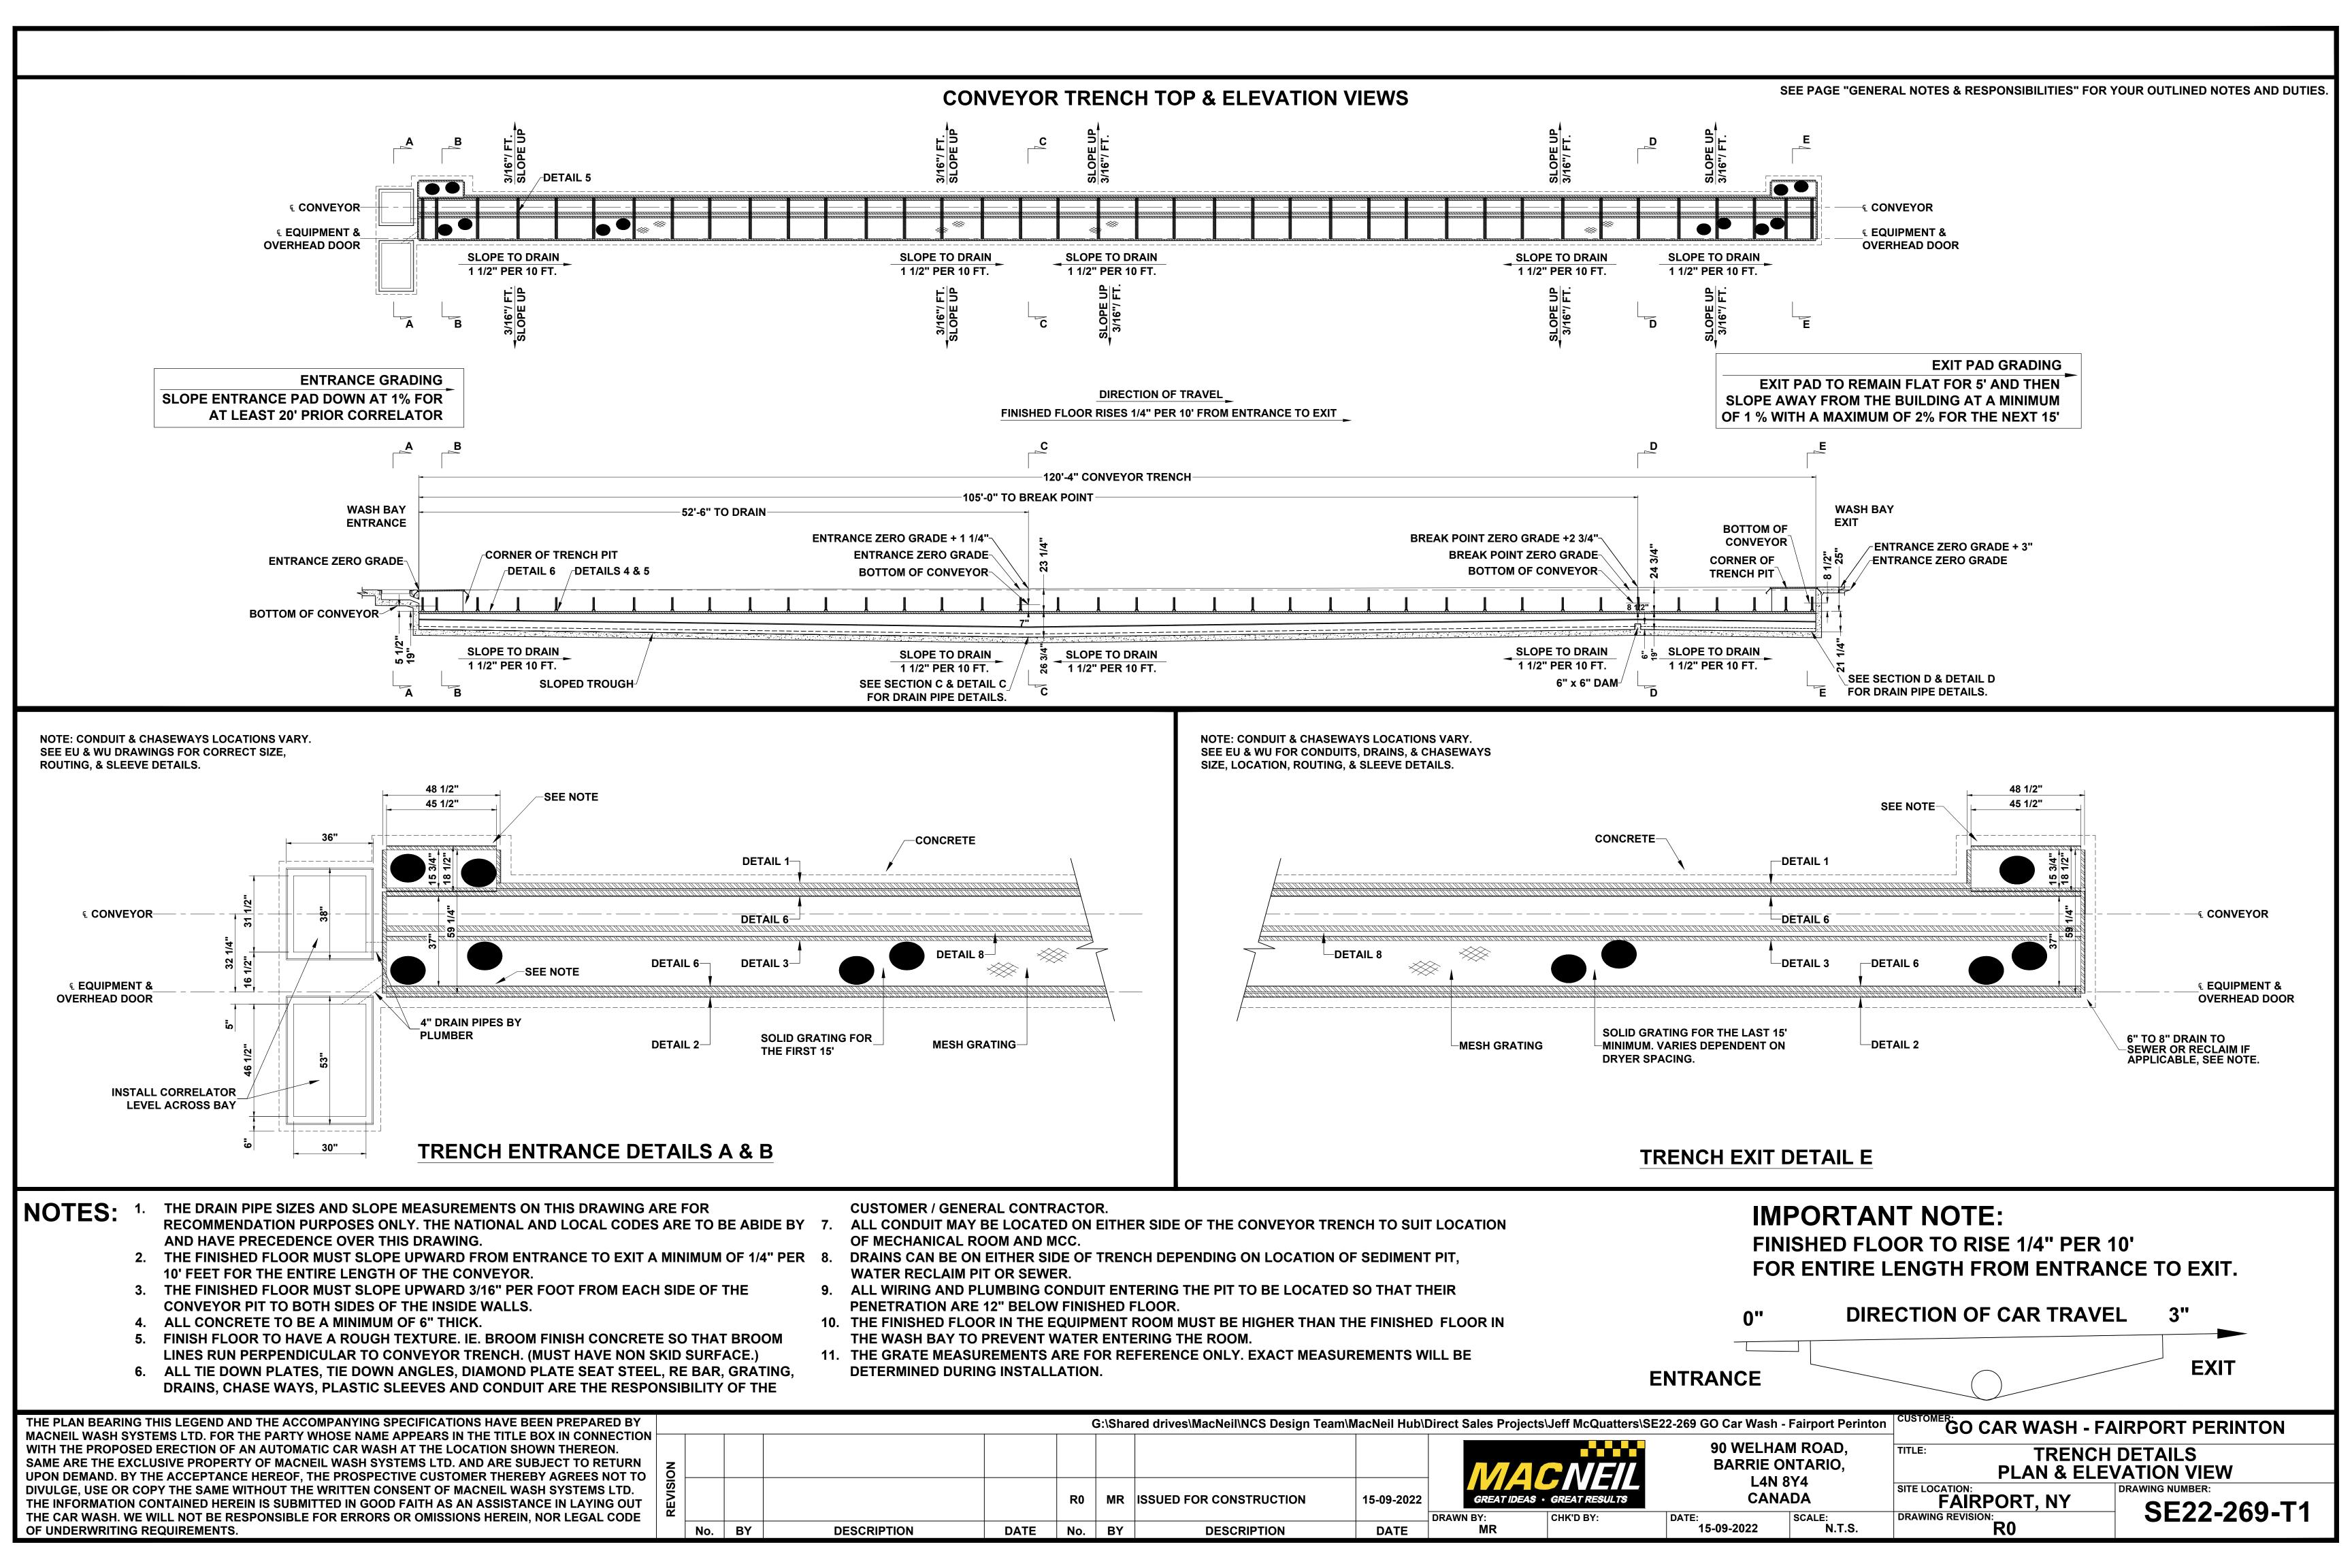



WOOD BOARD (2" X 22" X 8') TEMPLATE ENTRANCE SECTION FORM DETAIL

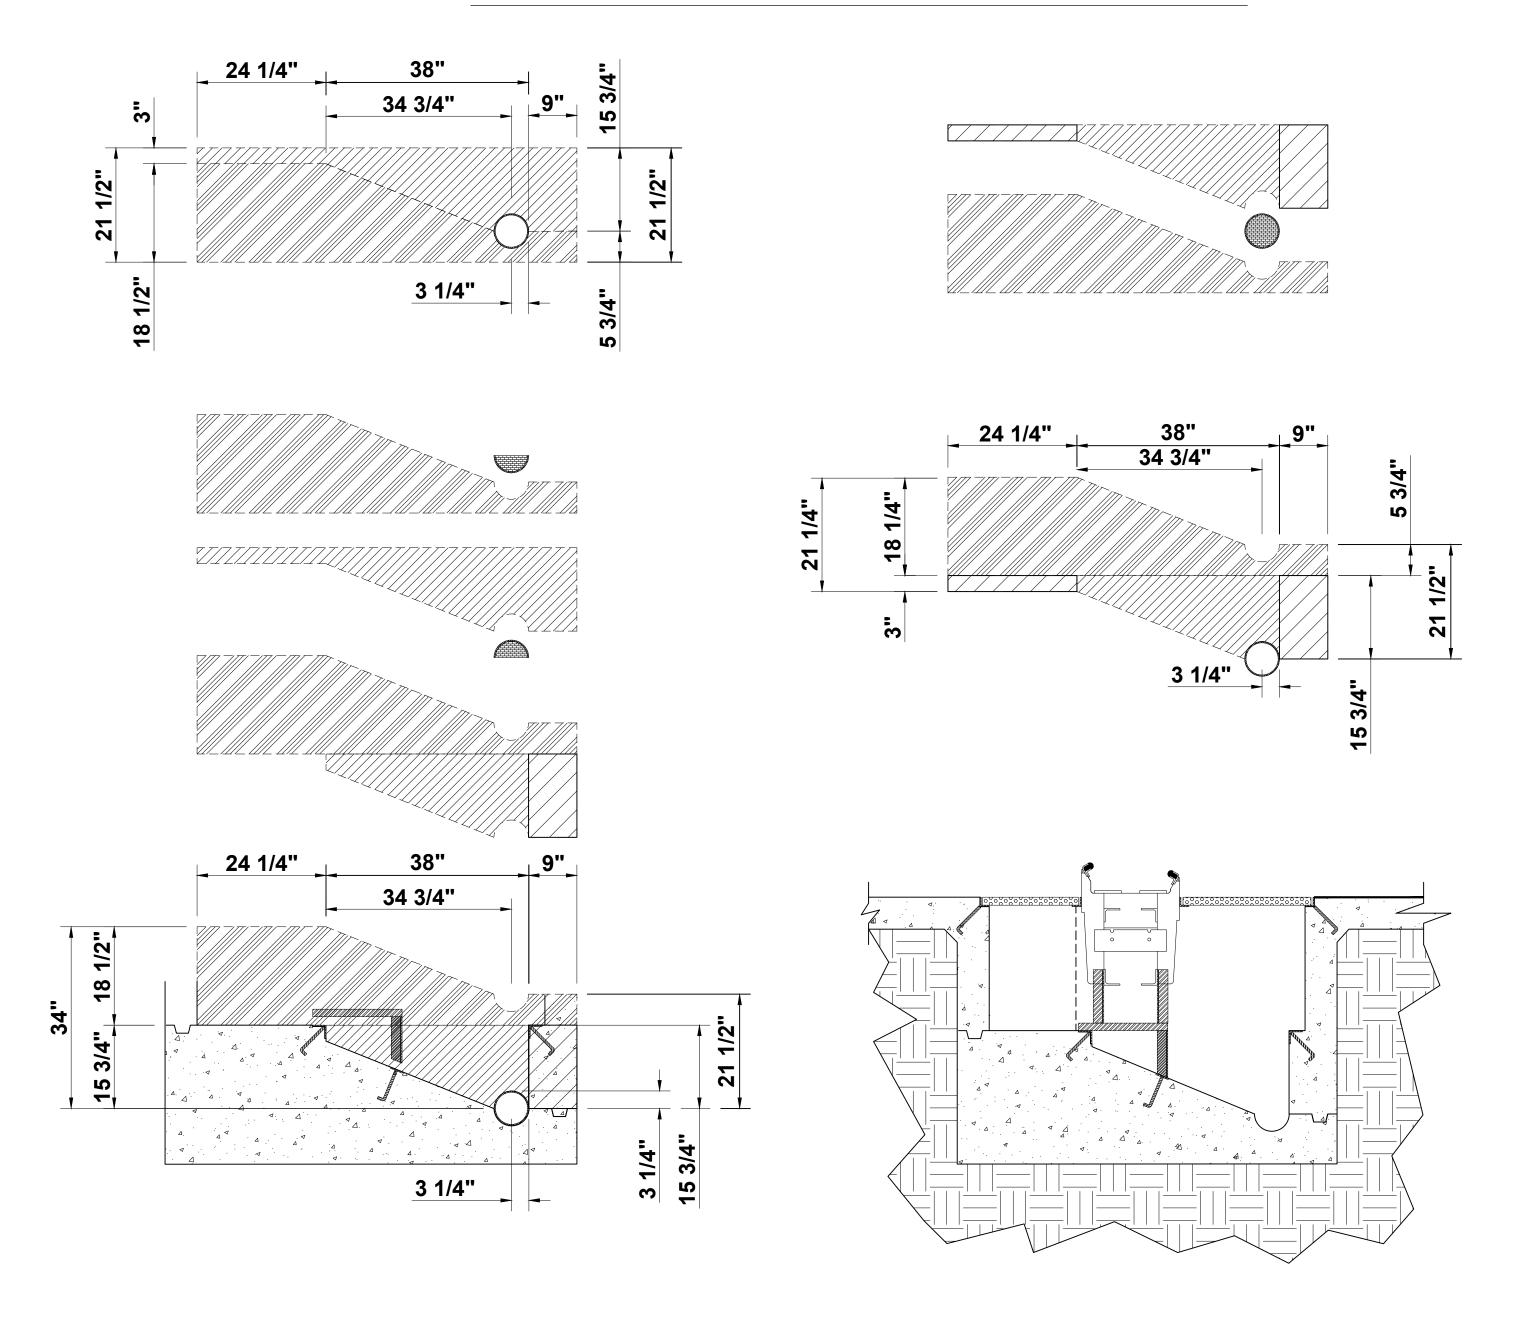



WOOD BOARD (2" X 22" X 8') TEMPLATE EXIT SECTION FORM DETAIL

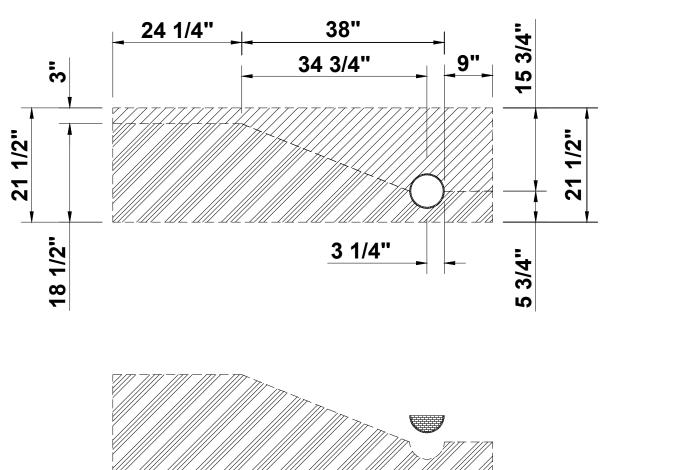

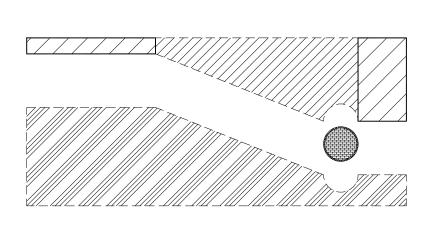

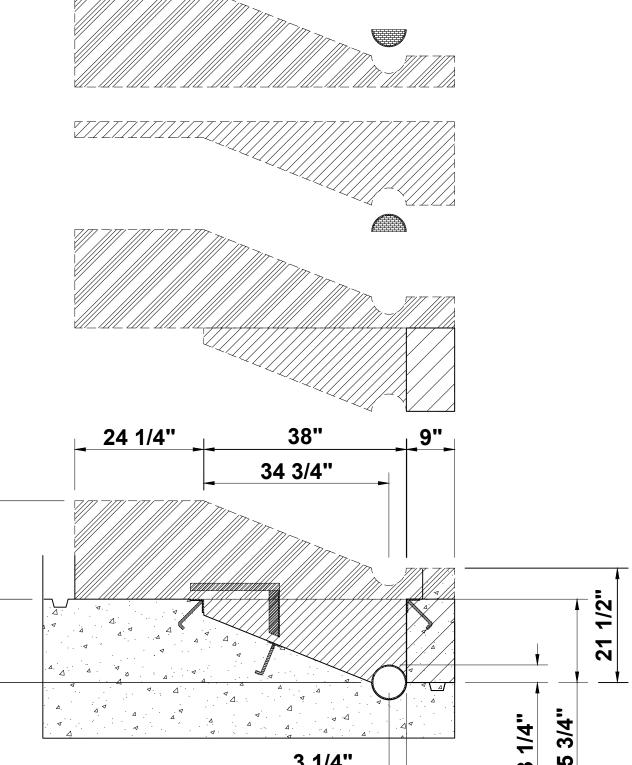

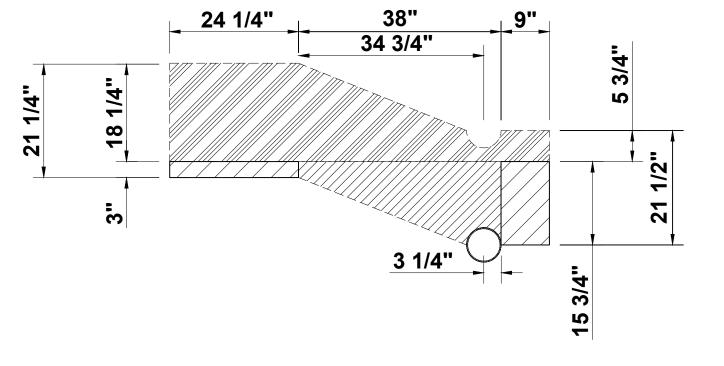

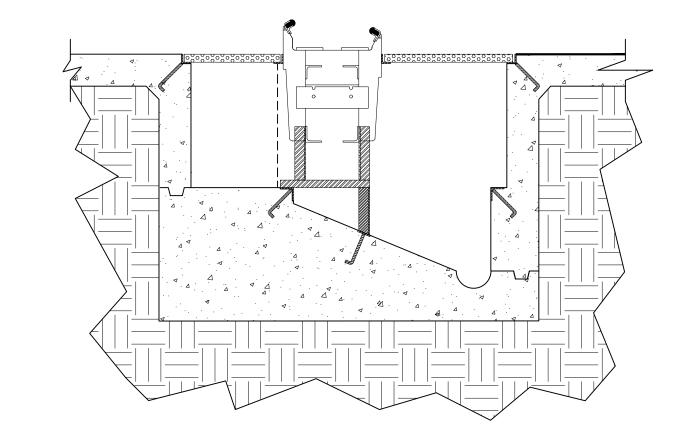



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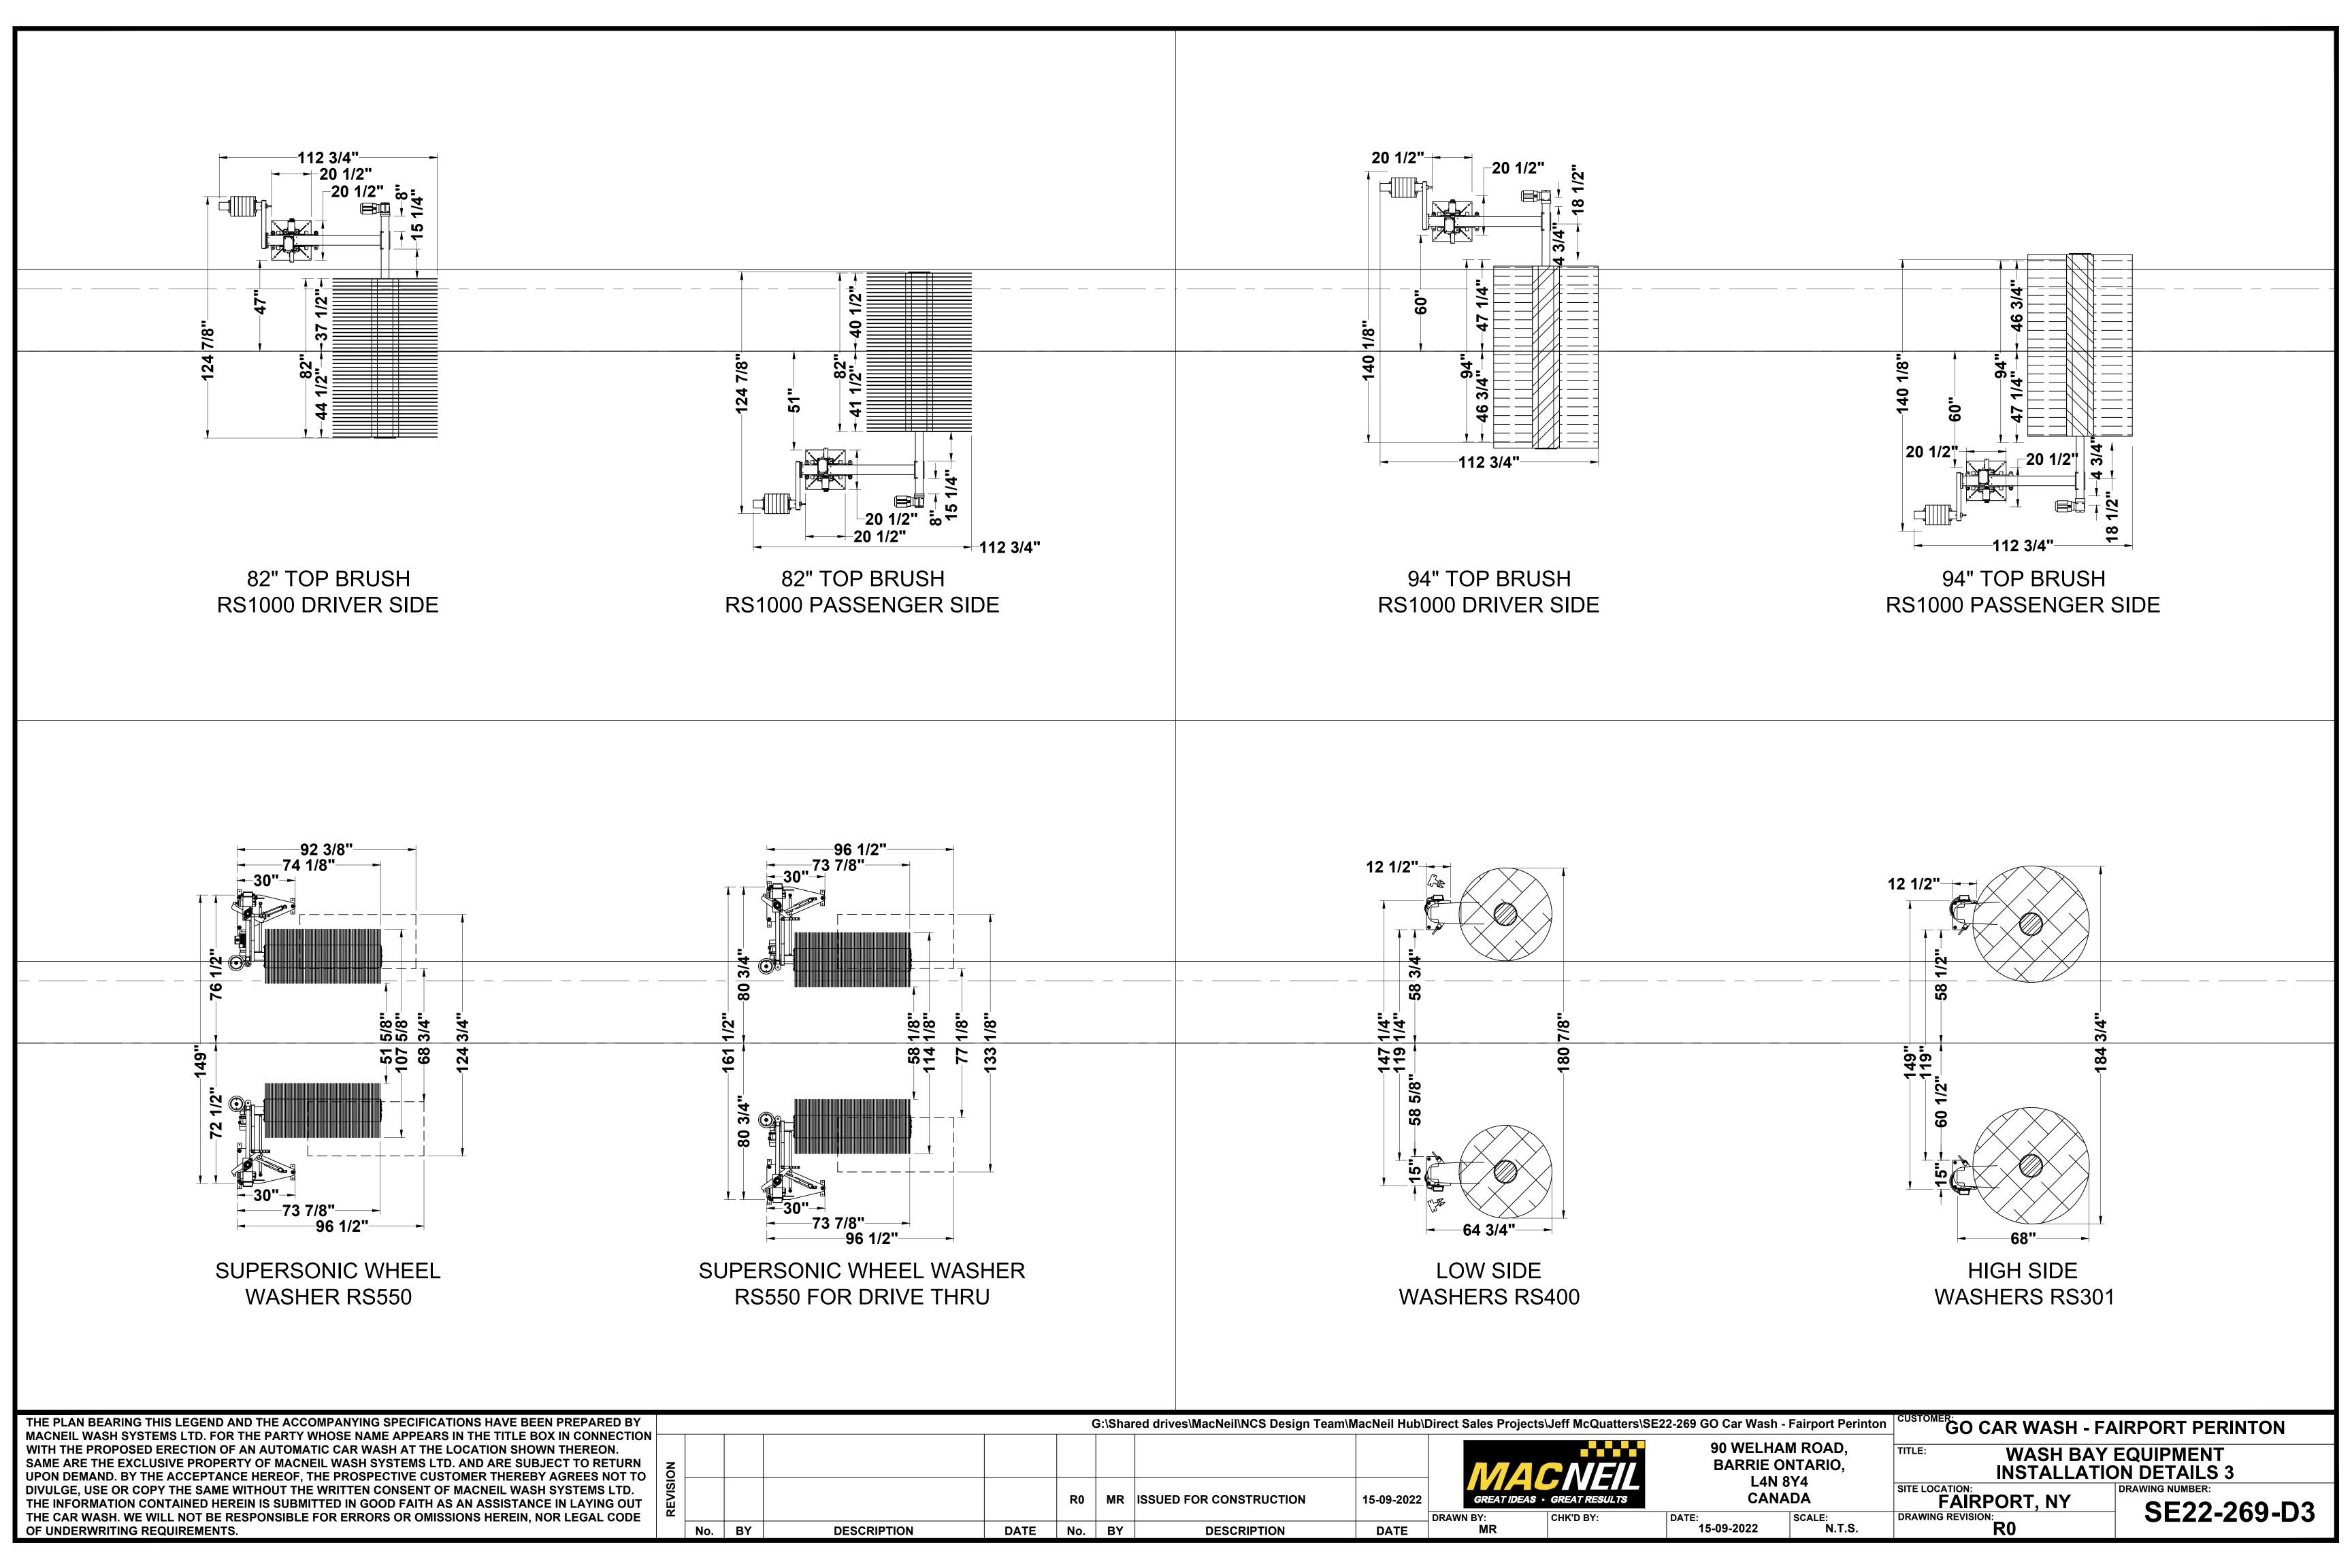
- 1. THIS DRAWING AND THE PROCESS DEPICTED HEREIN ARE FOR REFERENCE ONLY. MACNEIL WASH SYSTEMS LTD MAKES NO REPRESENTATION THAT THIS IS THE ONLY OR BEST METHOD OF CONSTRUCTING THE FORMS NECESSARY TO POUR THE CAR WASH CONVEYOR TRENCH. IT IS THE RESPONSIBILITY OF THE GENERAL CONTRACTOR AND HIS CONCRETE CONTRACTOR TO DETERMINE WHAT WORKS BEST FOR THEIR APPLICATION.
- 2. THIS DRAWING ASSUMES A STANDARD 2 X 8 WILL BE USED FOR FORM CROSS MEMBERS. MACNEIL WASH SYSTEMS LTD MAKES NO REPRESENTATION THAT THIS IS THE CORRECT CHOICE OF MATERIAL FOR THIS PROJECT. IT'S THE RESPONSIBILITY OF THE GENERAL CONTRACTOR AND HIS CONCRETE CONTRACTOR TO DETERMINE THE VIABILITY OF CERTAIN MATERIALS AND UTILIZE WHAT THEY DEEM BEST FOR THE APPLICATION.
- 3. DEPENDING ON FORM MATERIAL AND METHOD OF SECURING CROSS MEMBERS TO FORMS THE OVERALL WIDTH MAY VARY. IT IS THE RESPONSIBILITY OF THE GENERAL CONTRACTOR AND HIS CONCRETE CONTRACTOR TO ADAPT THIS GENERAL DESIGN TO THEIR SPECIFIC APPLICATION.
- 4. SHOULD THE GENERAL CONTRACTOR OR HIS CONCRETE CONTRACTOR HAVE ANY PROBLEMS OR QUESTIONS PERTAINING TO THESE TRENCH DRAWINGS PLEASE CONTACT THE EQUIPMENT DISTRIBUTOR/SUPPLIER OR MACNEIL WASH SYSTEMS LTD WELL IN ADVANCE OF POURING CONCRETE.


SEE PAGE "GENERAL NOTES & RESPONSIBILITIES" FOR YOUR OUTLINED NOTES AND DUTIES.


G:\Shared drives\MacNeil\NCS Design Team\MacNeil Hub\Direct Sales Projects\Jeff McQuatters\SE22-269 GO Car Wash - Fairport Perinton THE PLAN BEARING THIS LEGEND AND THE ACCOMPANYING SPECIFICATIONS HAVE BEEN PREPARED BY GO CAR WASH - FAIRPORT PERINTON MACNEIL WASH SYSTEMS LTD. FOR THE PARTY WHOSE NAME APPEARS IN THE TITLE BOX IN CONNECTION 90 WELHAM ROAD, WITH THE PROPOSED ERECTION OF AN AUTOMATIC CAR WASH AT THE LOCATION SHOWN THEREON. **TRENCH DETAILS** SAME ARE THE EXCLUSIVE PROPERTY OF MACNEIL WASH SYSTEMS LTD. AND ARE SUBJECT TO RETURN BARRIE ONTARIO, UPON DEMAND. BY THE ACCEPTANCE HEREOF, THE PROSPECTIVE CUSTOMER THEREBY AGREES NOT TO **L4N 8Y4** SITE LOCATION: DIVULGE, USE OR COPY THE SAME WITHOUT THE WRITTEN CONSENT OF MACNEIL WASH SYSTEMS LTD. **CANADA** FAIRPORT, NY R0 MR ISSUED FOR CONSTRUCTION 15-09-2022 THE INFORMATION CONTAINED HEREIN IS SUBMITTED IN GOOD FAITH AS AN ASSISTANCE IN LAYING OUT SE22-269-T3 THE CAR WASH. WE WILL NOT BE RESPONSIBLE FOR ERRORS OR OMISSIONS HEREIN, NOR LEGAL CODE DRAWN BY: 15-09-2022 N.T.S. OF UNDERWRITING REQUIREMENTS. No. BY **DESCRIPTION** DATE No. BY **DESCRIPTION** DATE



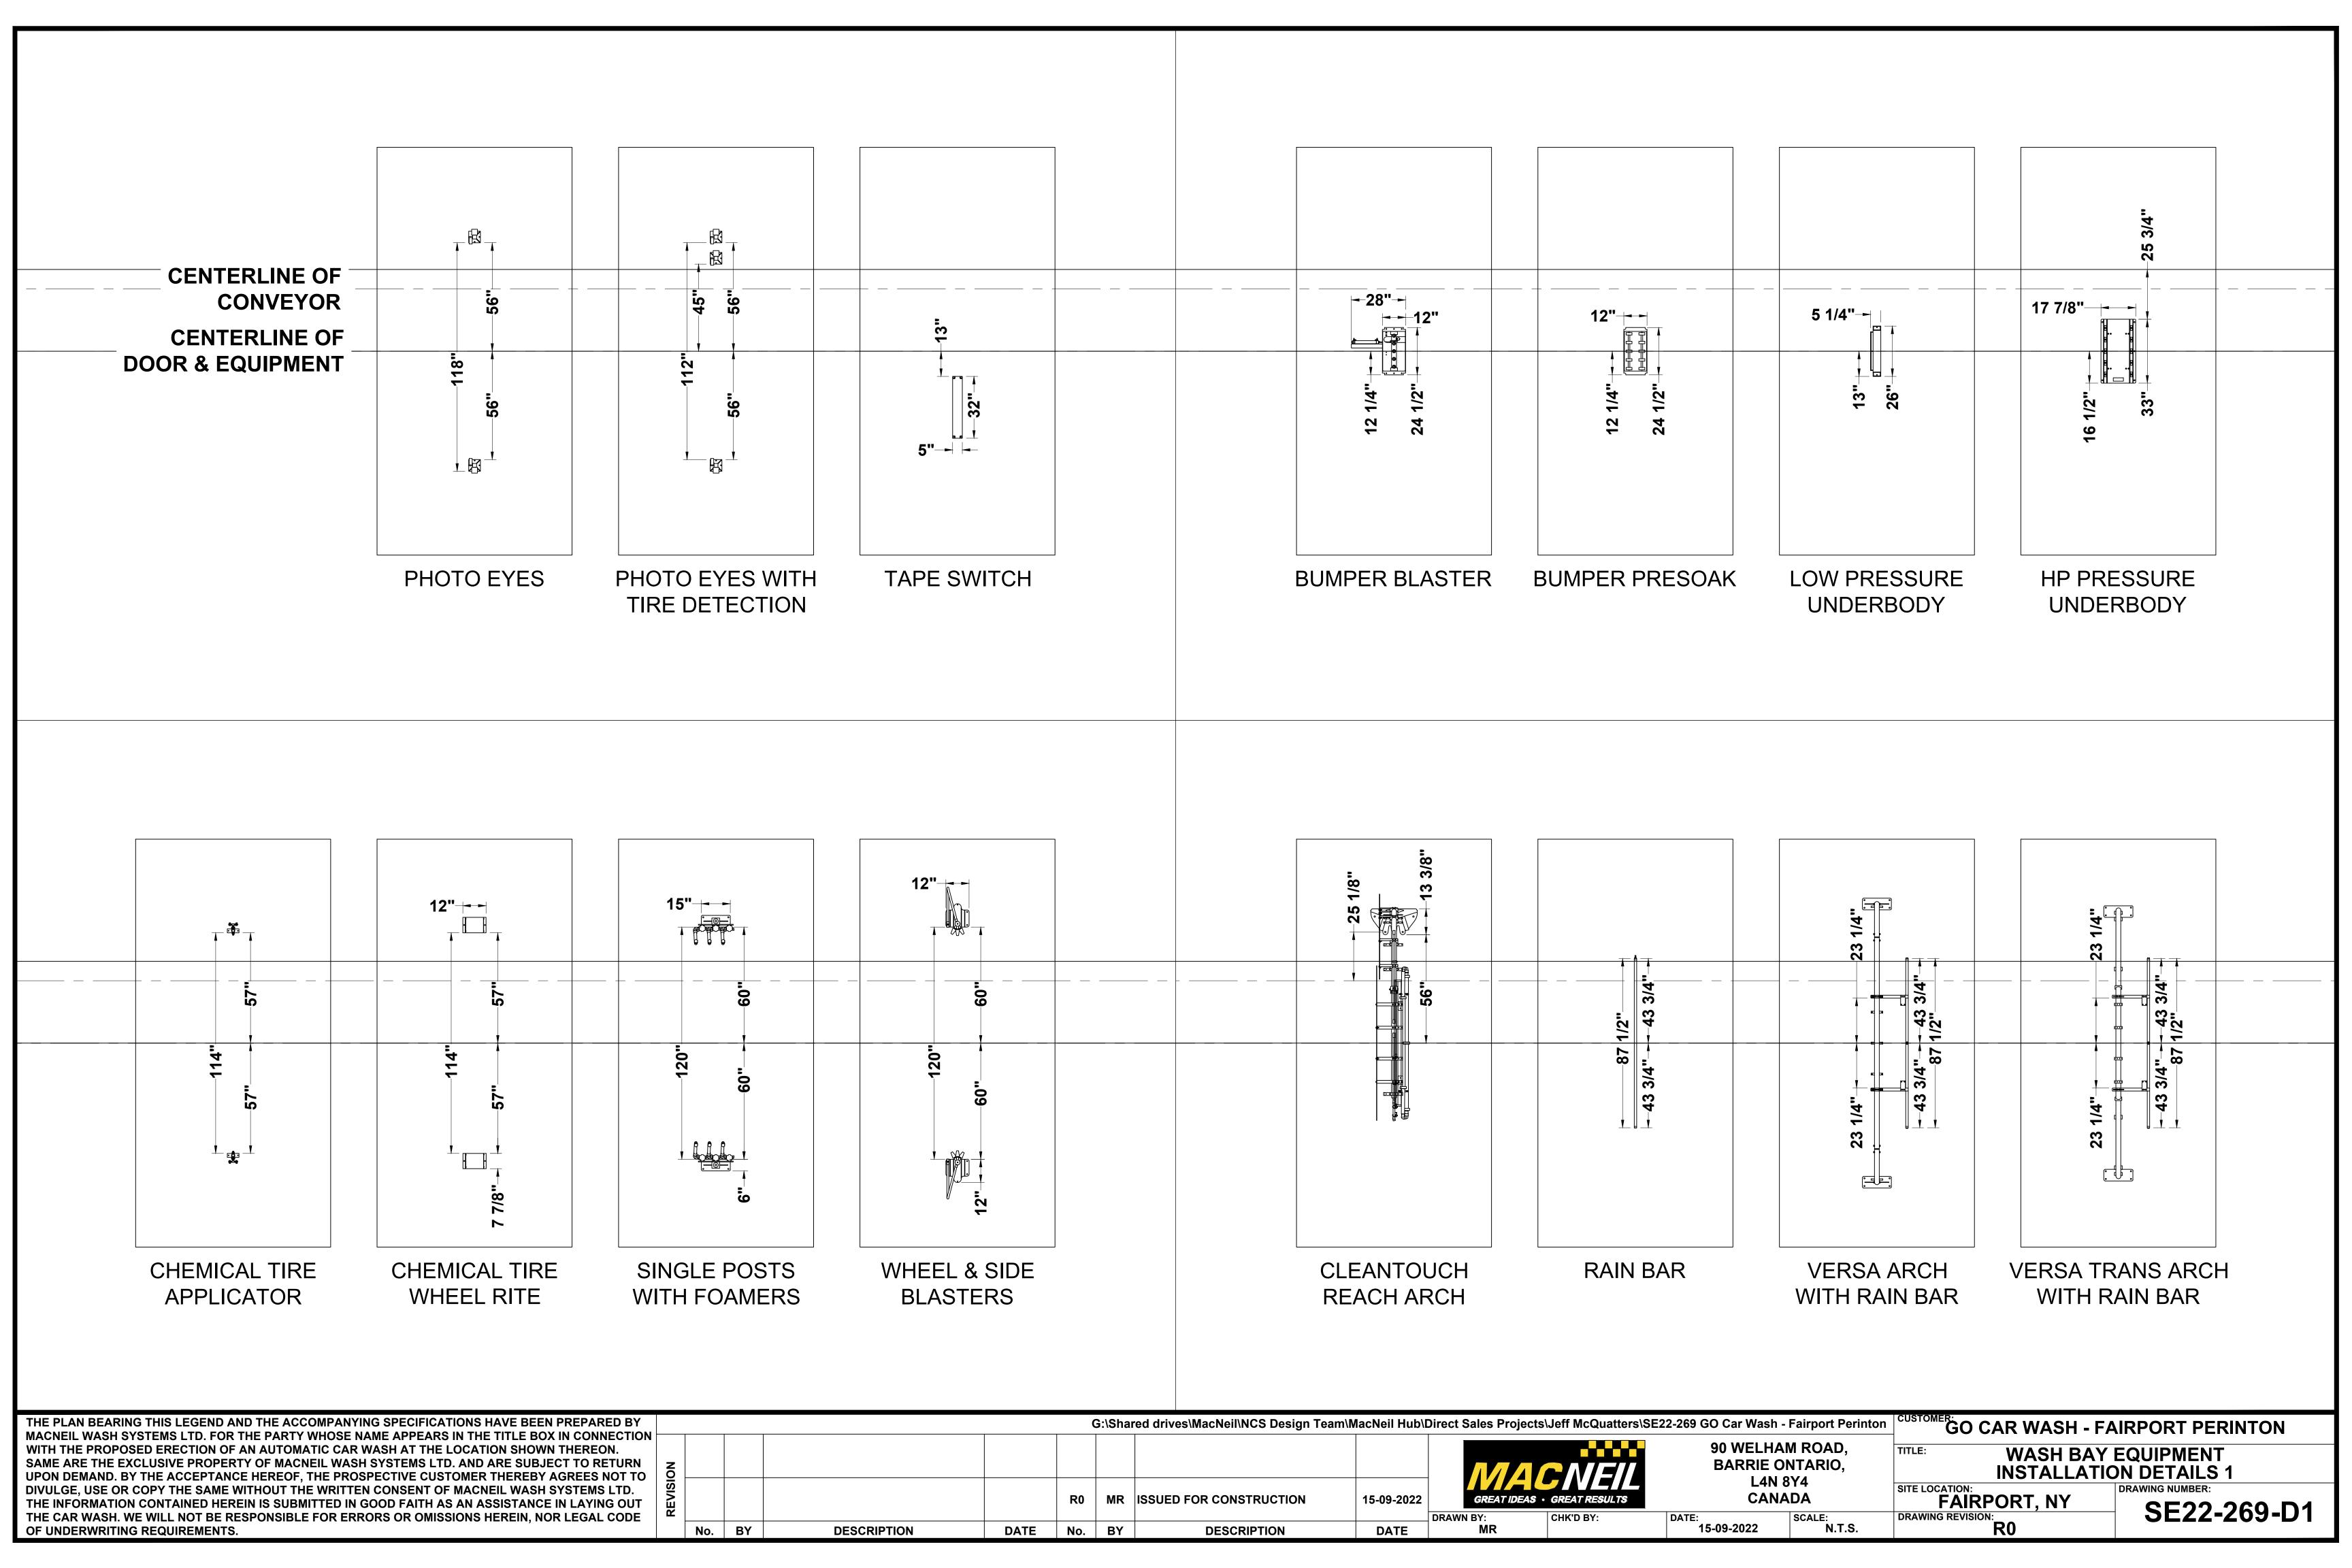

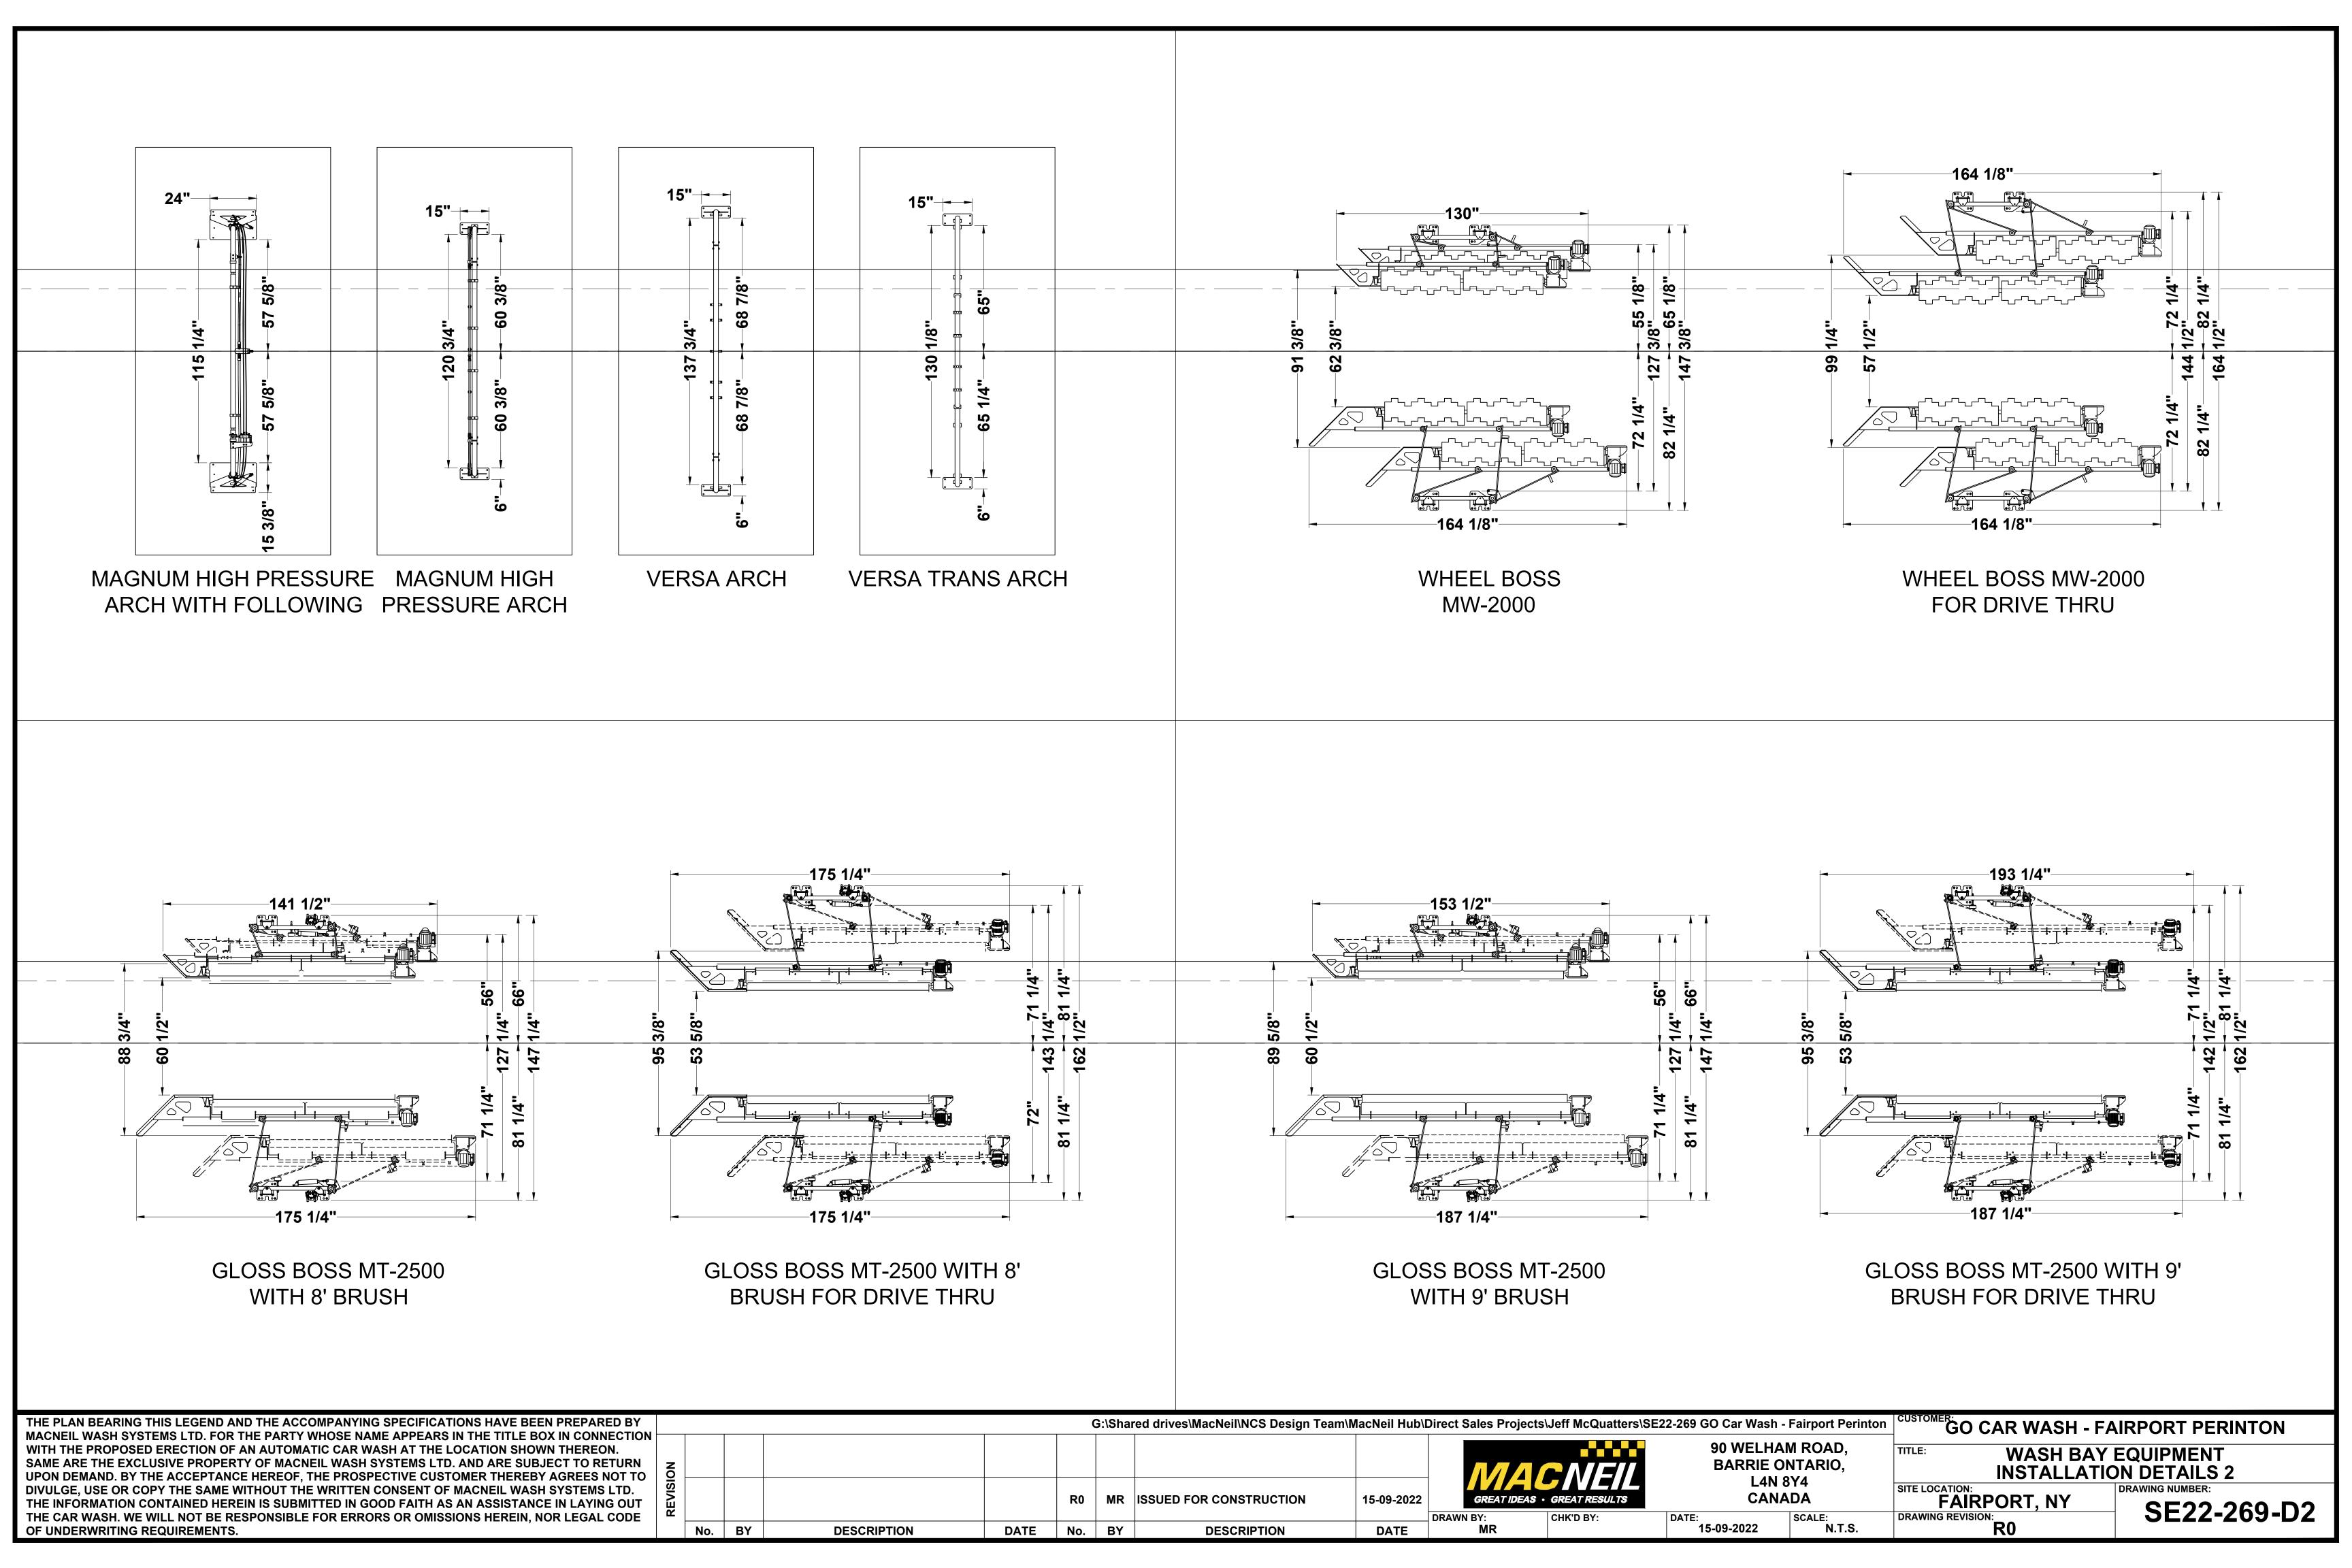

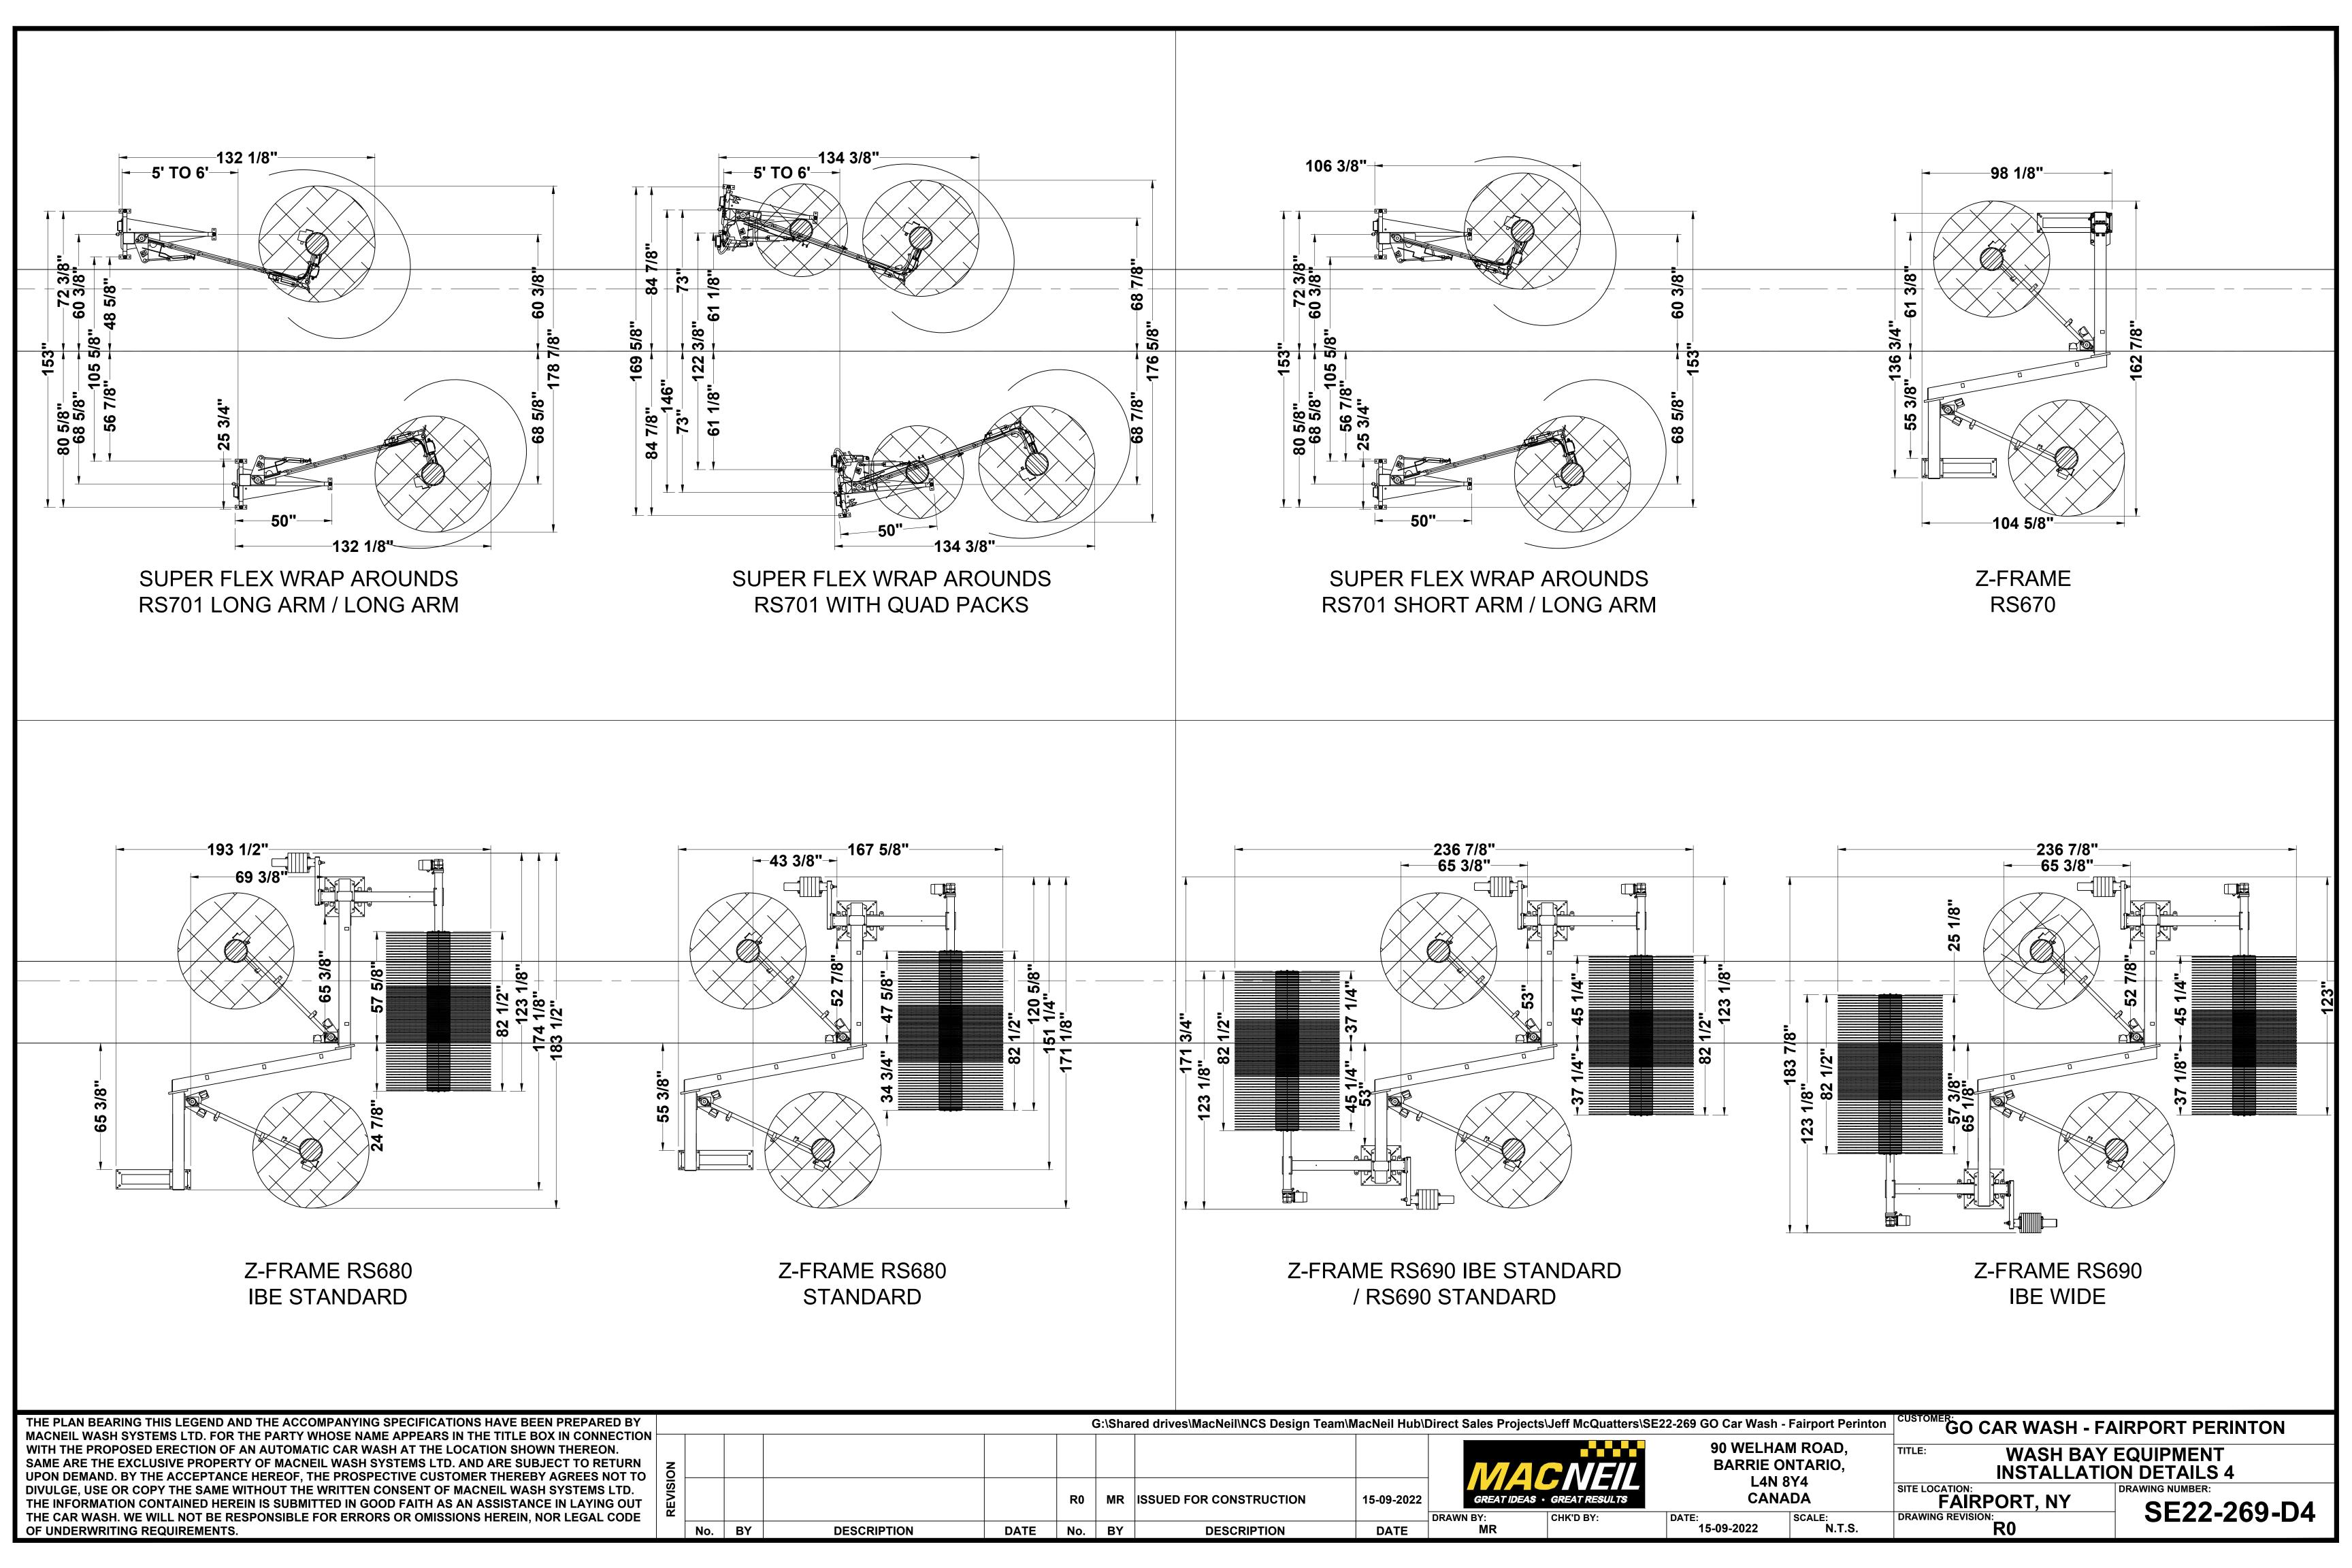

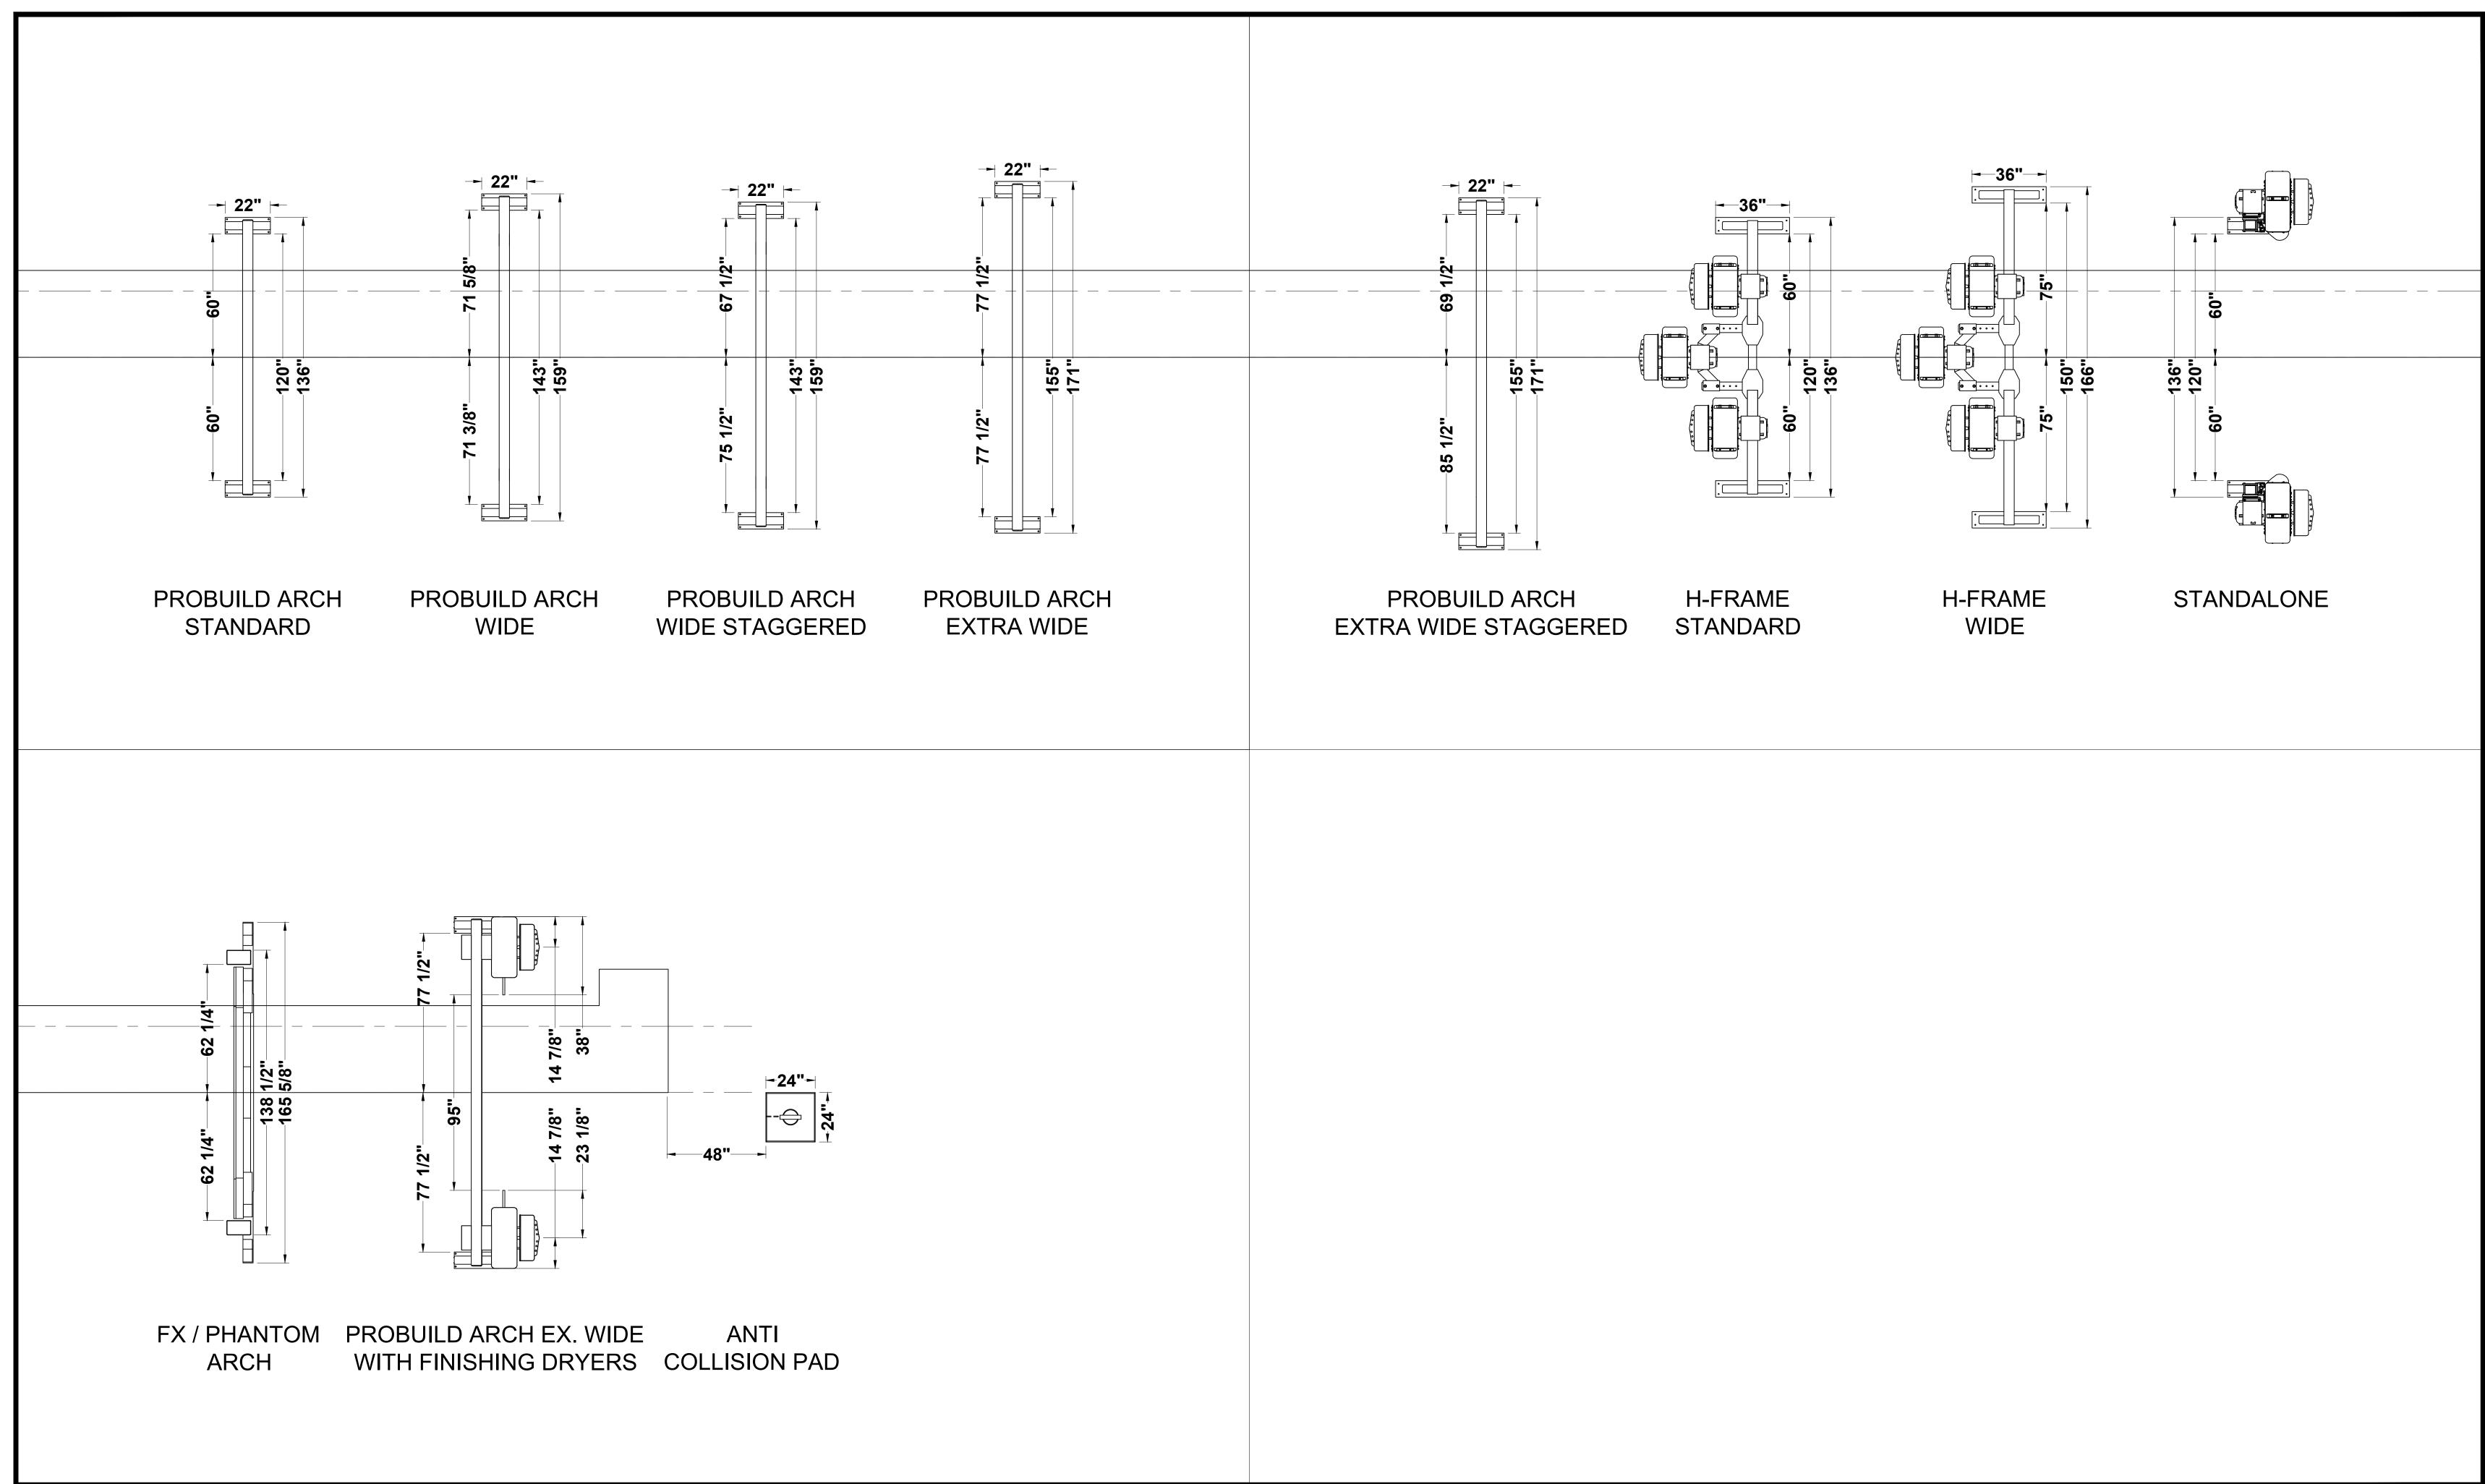

GO CAR WASH - FAIRPORT PERINTON G:\Shared drives\MacNeil\NCS Design Team\MacNeil Hub\Direct Sales Projects\Jeff McQuatters\SE22-269 GO Car Wash - Fairport Perinton THE PLAN BEARING THIS LEGEND AND THE ACCOMPANYING SPECIFICATIONS HAVE BEEN PREPARED BY MACNEIL WASH SYSTEMS LTD. FOR THE PARTY WHOSE NAME APPEARS IN THE TITLE BOX IN CONNECTION WITH THE PROPOSED ERECTION OF AN AUTOMATIC CAR WASH AT THE LOCATION SHOWN THEREON. 90 WELHAM ROAD, WASH BAY EQUIPMENT SAME ARE THE EXCLUSIVE PROPERTY OF MACNEIL WASH SYSTEMS LTD. AND ARE SUBJECT TO RETURN UPON DEMAND. BY THE ACCEPTANCE HEREOF, THE PROSPECTIVE CUSTOMER THEREBY AGREES NOT TO BARRIE ONTARIO, **INSTALLATION DETAILS 5** L4N 8Y4 SITE LOCATION: DIVULGE, USE OR COPY THE SAME WITHOUT THE WRITTEN CONSENT OF MACNEIL WASH SYSTEMS LTD. **CANADA FAIRPORT, NY** R0 MR ISSUED FOR CONSTRUCTION 15-09-2022 DRAWING REVISION: THE INFORMATION CONTAINED HEREIN IS SUBMITTED IN GOOD FAITH AS AN ASSISTANCE IN LAYING OUT SE22-269-D5 SCALE: N.T.S. THE CAR WASH. WE WILL NOT BE RESPONSIBLE FOR ERRORS OR OMISSIONS HEREIN, NOR LEGAL CODE DRAWN BY: OF UNDERWRITING REQUIREMENTS. 15-09-2022 No. BY **DESCRIPTION** DATE No. BY **DESCRIPTION** DATE