
650 RIDGE RD - BUILDING IMPROVEMENTS
650 RIDGE ROAD, LACKAWANNA, NY 14218 26 Mississippi St., Suite 300 Buffalo, New York 14203 DRAWING LIST . . ,A001 . . . DEMOLITION PLANS NEW WORK PLANS OVERALL REFLECTED CEILING PLANS WALL TYPES & DETAILS FLOOR FINISH AND PATTERN PLAN P100 BASEMENT AND FIRST LEVEL PLANS BASEMENT AND FIRST LEVEL FIRE PROTECTION PLANS SYMBOLS LEGEND AND CONTRACTOR NOTES H000 H201 BASEMENT FLOOR HVAC NEW WORK AND DEMOLITION PLAN VICINITY MAP **LOCATION MAP** CONSULTANTS **OWNER** OLV Human Services 790 Ridge Rd Lackawanna NY 14218 **ARCHITECT**


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26 Mississippi St. Buffalo, New York 14203 Tel: (800) 274-9000 Fax: (716) 852-2120

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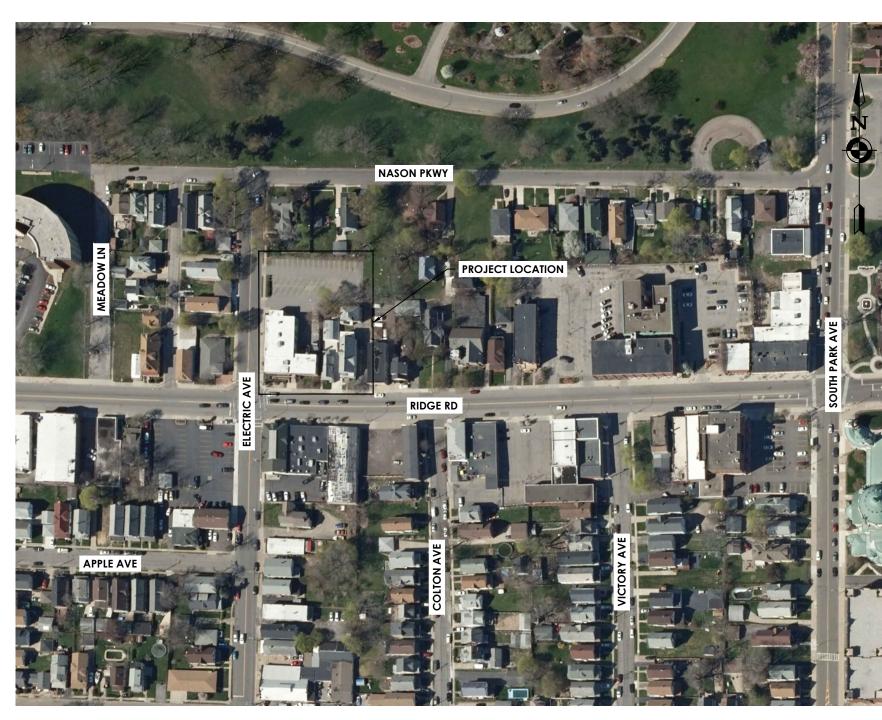
OLV G000



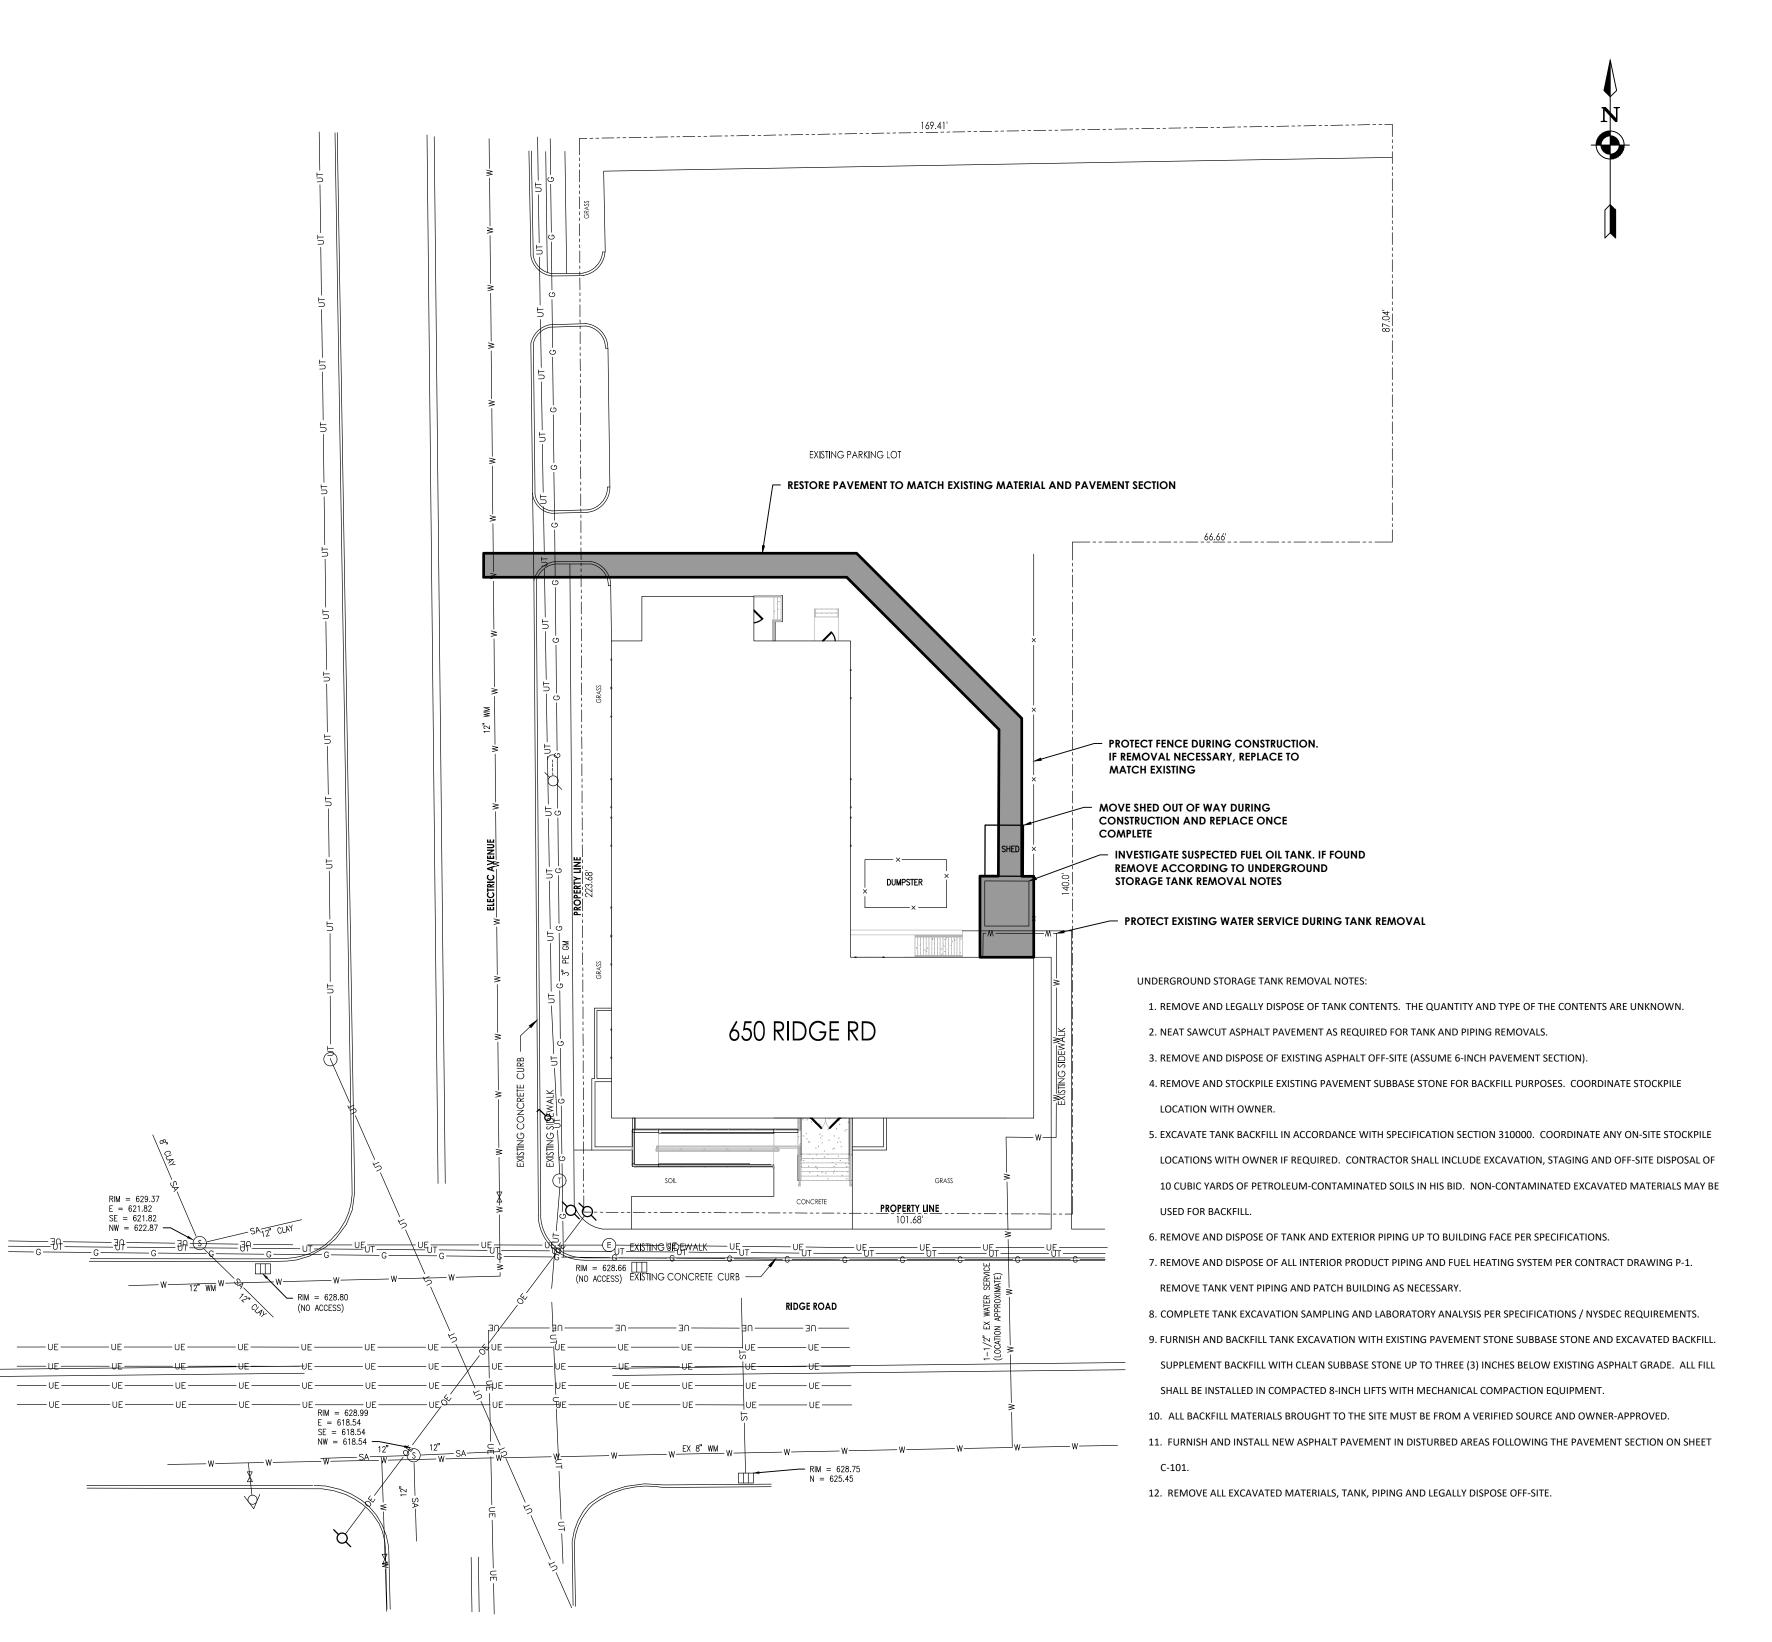

PROPOSED WATER SERVICE

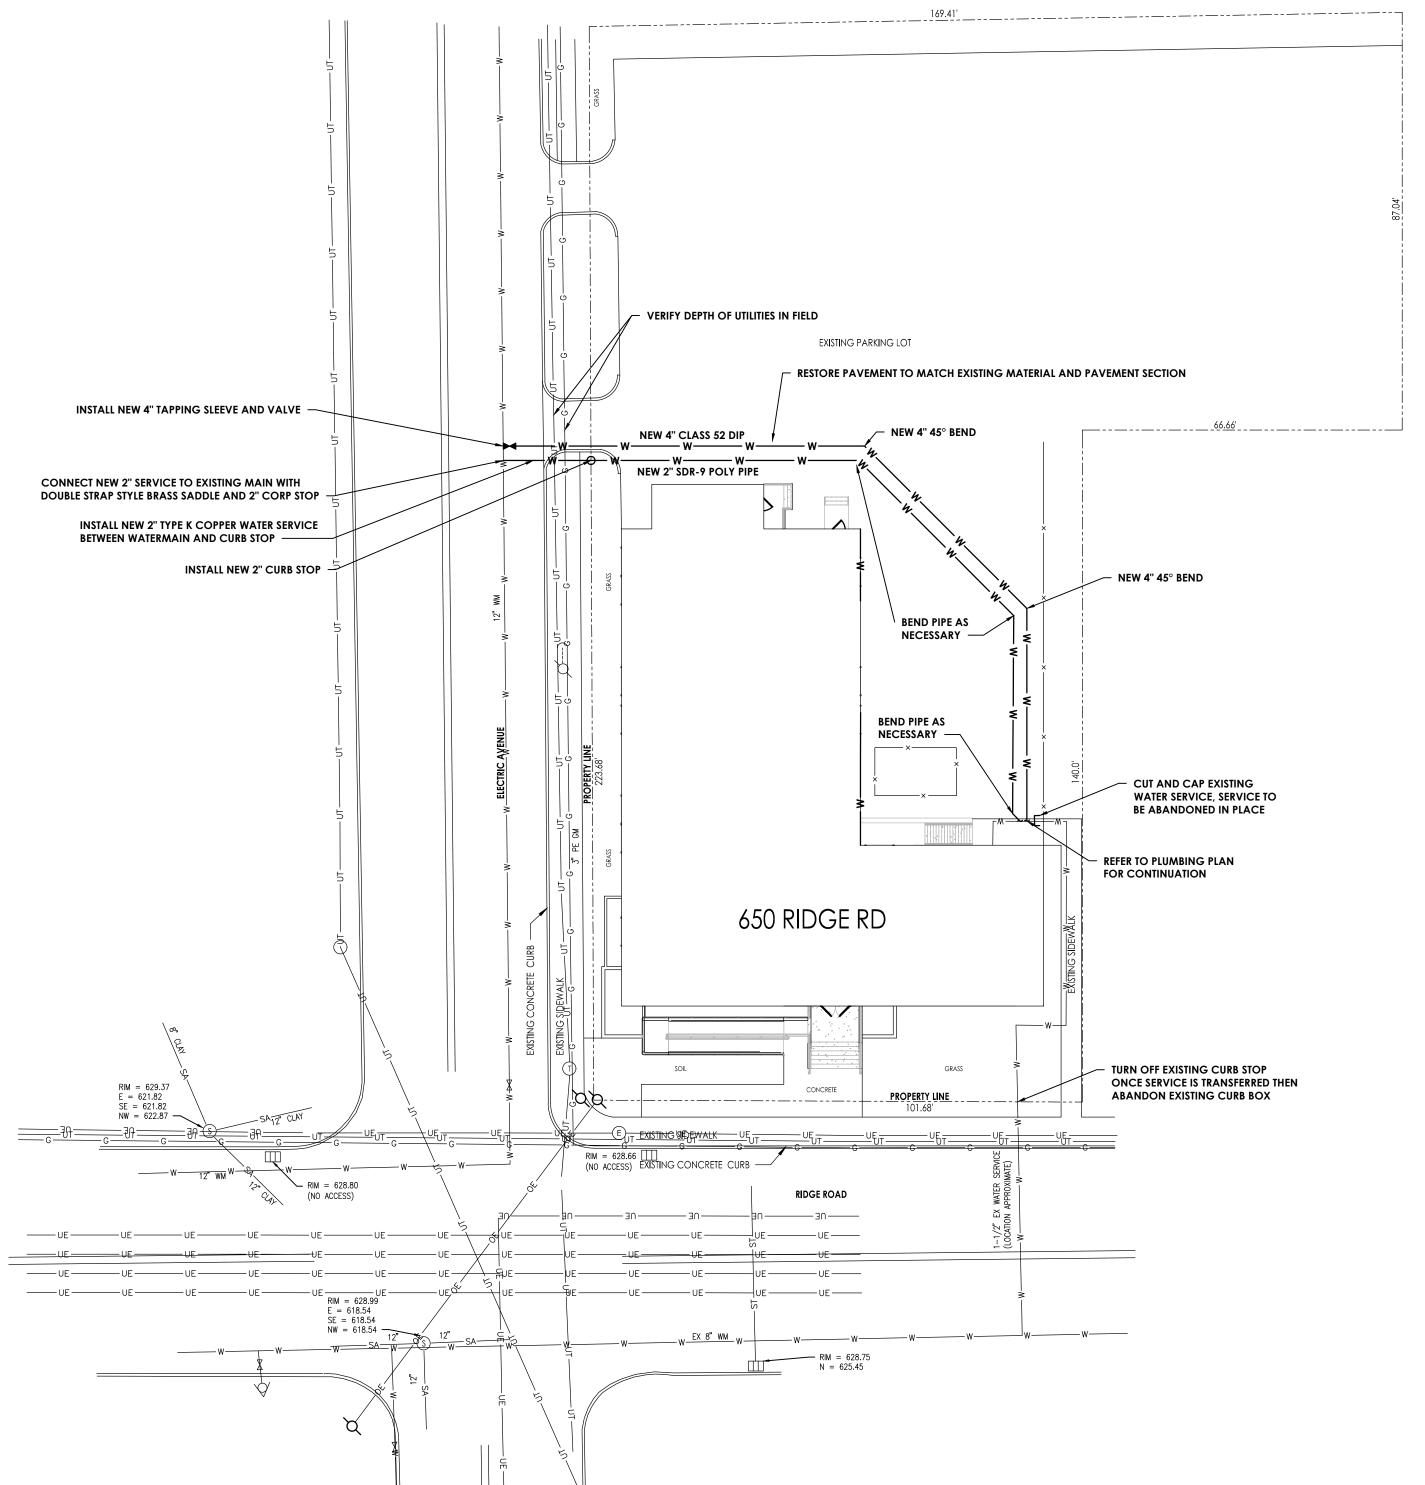SYMBOL LEGEND LINETYPE LEGEND ----×----× EXISTING FENCE T TELEPHONE MANHOLE C---- GUY ANCHOR WIRE ---- -- -- EXISTING PARCEL LINE — — — — — — — EXISTING PARCEL BOUNDARY LOTS CATCH BASIN SQUARE (E) ELECTRIC MANHOLE PROPOSED WATER SHUT OFF PROPOSED WATER VALVE ——UT——UT——UT——UT—— EXISTING UNDERGROUND TELEPHONE -----w----w------w EXISTING UNDERGROUND WATER SUPPLY W PROPOSED UNDERGROUND WATER SUPPLY



SCALE 1" = 2000'

GENERAL NOTES

- 1. ALL WORK IS TO BE COMPLETED IN ACCORDANCE WITH NYSDOH, OSHA, NYSDOT, ERIE COUNTY DOH, AND LOCAL COMMUNITY REQUIREMENTS.
- THE LOCATIONS, SIZES AND ELEVATIONS OF EXISTING UTILITIES ARE BASED ON INFORMATION COMPILED BY THE ENGINEER FROM RECORD DRAWINGS OF RECORDS AND INFORMATION FURNISHED BY THE VARIOUS UTILITIES. WITH FIELD VERIFICATION WHERE NECESSARY AND POSSIBLE. THE ACCURACY OF THIS INFORMATION IS NOT GUARANTEED AND MAY BE APPROXIMATE ONLY. IT IS THE CONTRACTOR'S RESPONSIBILITY TO HAVE THIS INFORMATION VERIFIED AND LOCATED PRIOR TO CONSTRUCTION. NO CONSTRUCTION EXCAVATION, BORING, OR BLASTING SHALL BE DONE WITHOUT CERTIFICATION OF THE DEPTH AND LOCATION OF UTILITIES. CALL UFPO AT 1-(800)-962-7962 AT LEAST 48 HOURS PRIOR TO COMMENCING WORK.
- 4. THE CONTRACTOR SHALL EXPOSE EXISTING UTILITIES, SERVICES, SEWERS AND LATERALS AHEAD OF PIPE LAYING OR OTHER WORK OPERATIONS SO THAT IF MINOR ADJUSTMENTS MUST BE MADE IN ELEVATION AND/OR ALIGNMENT, DUE TO INTERFERENCE, THESE CHANGES CAN BE MADE IN ADVANCE OF THE
- MINIMUM COVER ON ALL NEW WATER MAIN SHALL BE FIVE (5) FEET, MEASURED FROM FINISH GROUND SURFACE EXCEPT AS OTHERWISE NOTED.
- WHERE THE CLEARANCE BETWEEN THE WATER MAIN AND ANY EXISTING UTILITY OR SERVICE CONNECTIONS (EXCEPT SANITARY SEWER CROSSING) IS LESS THAN ONE (1) FOOT, SELECT FILL SHALL BE PROVIDED AT NO ADDITIONAL COST TO THE OWNER.
- 7. ALL FITTINGS SHALL BE PROPERLY RESTRAINED AND ALL UNDERGROUND FITTINGS SHALL UTILIZE FLUOROCARBON BOLTS.
- 8. ROAD AND HIGHWAY DRAINAGE SHALL BE MAINTAINED THROUGHOUT THE PERIOD OF CONSTRUCTION. THE ROADS SHALL BE KEPT CLEAN OF MUD AND
- 9. SAFE AND CONTINUOUS THROUGH TRAFFIC AND INGRESS AND EGRESS FOR ADJACENT OWNER DRIVEWAYS, SERVICE ROADS AND PUBLIC STREETS SHALL BE MAINTAINED THROUGHOUT THE PERIOD OF CONSTRUCTION.
- 10. R.O.W. MARKERS AND PROPERTY PINS SHALL NOT DISTURBED. THE CONTRACTOR SHALL LOCATE, FLAG AND PRESERVE SURVEY MONUMENTS AND PROPERTY CORNER MARKERS. IF CONTRACTOR DISTURBS R.O.W. MARKERS OR PROPERTY PINS, THE PINS OR MARKERS SHALL BE REPLACED IN THE ORIGINAL LOCATION AND DOCUMENTED AND STAMPED BY A NYS LICENSED SURVEYOR AT THE CONTRACTORS EXPENSE.
- 11. WHEN INSTALLING HYDRANTS OR BLOW-OFFS, SHOULD GROUND WATER BE ENCOUNTERED WITHIN 7 FEET OF THE FINISH GRADE, WEEP HOLES (DRAINS) SHALL BE PLUGGED AS ORDERED BY ENGINEER. IF WEEPS ARE PLUGGED, HYDRANTS AND BLOW-OFFS SHALL BE SO LABELED, PER LOCAL JURISDICTION REQUIREMENTS, AND THE WATER DISTRICT SUPERINTENDENT AND LOCAL FIRE DEPARTMENT SHALL BE NOTIFIED IN WRITING.
- 12. MINIMUM VERTICAL SEPARATION BETWEEN WATER MAINS AND SEWER LINES SHALL BE 18 INCHES MEASURED FROM THE OUTSIDE OF THE PIPE AT THE POINT OF CROSSING. MINIMUM HORIZONTAL SEPARATION BETWEEN PARALLEL WATER MAINS AND SEWER PIPE (INCLUDING MANHOLES AND VAULTS) SHALL BE 10 FEET MEASURED FROM THE OUTSIDE OF THE PIPES, MANHOLES OR VAULTS. ONE FULL STANDARD LAYING LENGTH OF WATER MAIN SHALL BE CENTERED UNDER OR OVER THE SEWER SO THAT BOTH JOINTS WILL BE AS FAR FROM THE SEWER AS POSSIBLE. IN ADDITION, WHEN THE WATER MAIN PASSES UNDER THE SEWER, ADEQUATE STRUCTURAL SUPPORT (COMPACTED SELECTED FILL) SHALL BE PROVIDED FOR THE SEWER TO PREVENT EXCESSIVE DEFLECTION OF THE JOINTS AND SETTLING TO THE SEWER ON THE WATER MAIN.

- 13. A 30 INCH MINIMUM CLEARANCE SHALL BE MAINTAINED BETWEEN OUTSIDE EDGE OF UTILITY POLES AND OUTSIDE EDGE OF WATER MAIN. UTILITY POLES SHALL BE SUPPORTED, WHERE WORK IS WITHIN 36" OF POLE, AS NECESSARY, AT NO ADDITIONAL COST TO THE OWNER.
- 14. CONTRACTOR SHALL PRESERVE AND PROTECT FROM DAMAGE ALL TREES, FENCES AND OTHER OBSTACLES WITHIN THE ROW AND EASEMENT.
- 15. WHERE INDICATED, DRIVEWAYS SHALL BE NEATLY SAWCUT AND REPLACED FROM THE CURB OR EDGE OF PAVED SHOULDER TO THE OUT SIDE OF THE EXCAVATION. DRIVEWAYS SHALL BE GRADED TO DRAIN WITH NO PONDING WATER.
- 16. TO PROTECT NEW OR EXISTING WORK, SHEETING OR SHORING (IF REQUIRED DURING CONSTRUCTION) SHALL BE PROVIDED AT NO COST TO THE OWNER. 17. WHEREVER MAILBOXES, POSTS, FENCES, SHRUBBERY, ETC. ARE IN CONFLICT WITH THE PROPOSED CONSTRUCTION, THEY SHALL BE REMOVED AND RESET AS
- ORDERED BY THE ENGINEER AND INCLUDED IN THE APPROPRIATE ITEMS IN THE BID. NO DIRECT PAYMENT WILL BE MADE FOR THIS. 18. CONTRACTOR SHALL BE RESPONSIBLE FOR PROPER DISPOSAL OF EXCAVATED MATERIAL FROM THE SITE.
- 19. ALL THRUST BLOCKS SHALL BE INSTALLED AGAINST UNDISTURBED SOIL.
- 20. NO EXCAVATIONS ARE TO BE LEFT OPEN OVERNIGHT.
- 21. THE OWNER WILL OBTAIN ALL EASEMENTS AND PERMITS OUTLINED IN THE PROJECT SPECIFICATIONS. 22. THE CONTRACTOR SHALL VERIFY THAT THERE WILL BE NO DISRUPTION TO MAIL DELIVERY THROUGHOUT CONSTRUCTION. COORDINATION WITH THE
- PROPERTY OWNERS AND THE POSTAL SERVICE MAY BE REQUIRED.
- 23. THE CONTRACTOR SHALL RETAIN THE SERVICES OF A QUALIFIED TREE EXPERT TO REMOVE, WHERE NECESSARY, BRANCHES THAT INTERFERE WITH THE CONSTRUCTION OPERATIONS, OR REPAIR TREES HAVING SUFFERED DAMAGE BY CONSTRUCTION ACTIVITIES. THE COST IS TO BE INCLUDED IN THE BID PRICE
- 24. ALL DAMAGE CAUSED DIRECTLY OR INDIRECTLY BY THE CONTRACTOR'S OPERATIONS SHALL BE REPAIRED AT THE CONTRACTOR'S EXPENSE.
- ALL OFFSETS PROVIDED IN THE PLANS ARE MEASURED PERPENDICULAR TO THE ROAD CENTERLINE, UNLESS OTHERWISE NOTED.
- 26. THE CONTRACTOR'S WORK AREA SHALL BE CONFINED TO THE LIMITS OF THE PROJECT PROPERTY AND TO THE RIGHT-OF-WAYS AND EASEMENTS. SHOULD THE CONTRACTOR REQUIRE ADDITIONAL AREA TO ACCOMMODATE HIS OPERATIONS, HE SHALL BE RESPONSIBLE FOR OBTAINING THE NECESSARY
- 27. CONSTRUCTION EQUIPMENT AND MATERIALS SHALL BE SECURELY STORED WITHIN THE PROJECT SITE EACH NIGHT.

CPL | Architecture Engineering Planning

26 MISSISSIPPI ST. SUITE 100 BUFFALO, NY 14203 CPLteam.com

PROJECT INFORMATION

13321.00 Client Name Baker Academy

Project Number

Project Name 650 Ridge Road -Building Improvements

OLV Human Services Project Address 650 RIDGE ROAD LACKAWANNA, NY 14218 SED Number


REVISION SCHEDULE


IT IS A VIOLATION OF THE NEW YORK STATE EDUCATION LAW AND THE COMMISSIONER'S REGULATIONS FOR ANY PERSON, UNLESS ACTING UNDER THE DIRECTION OF A LICENSED ARCHITECT, ENGINEER OR LAND SURVEYOR, TO ALTER AN ITEM IN ANY WAY.


IF AN ITEM BEARING THE SEAL OF AN ARCHITECT, ENGINEER OR SURVEYOR IS ALTERED, THE ALTERING PARTY SHALL AFFIX TO THE ITEM THEIR SEAL AND THE NOTATION "ALTERED BY" FOLLOWED BY THEIR SIGNATURE AND THE DATE OF SUCH ALTERATION, AND A SPECIFIC DESCRIPTION OF THE ALTERATION.


SHEET INFORMATION 5/18/21


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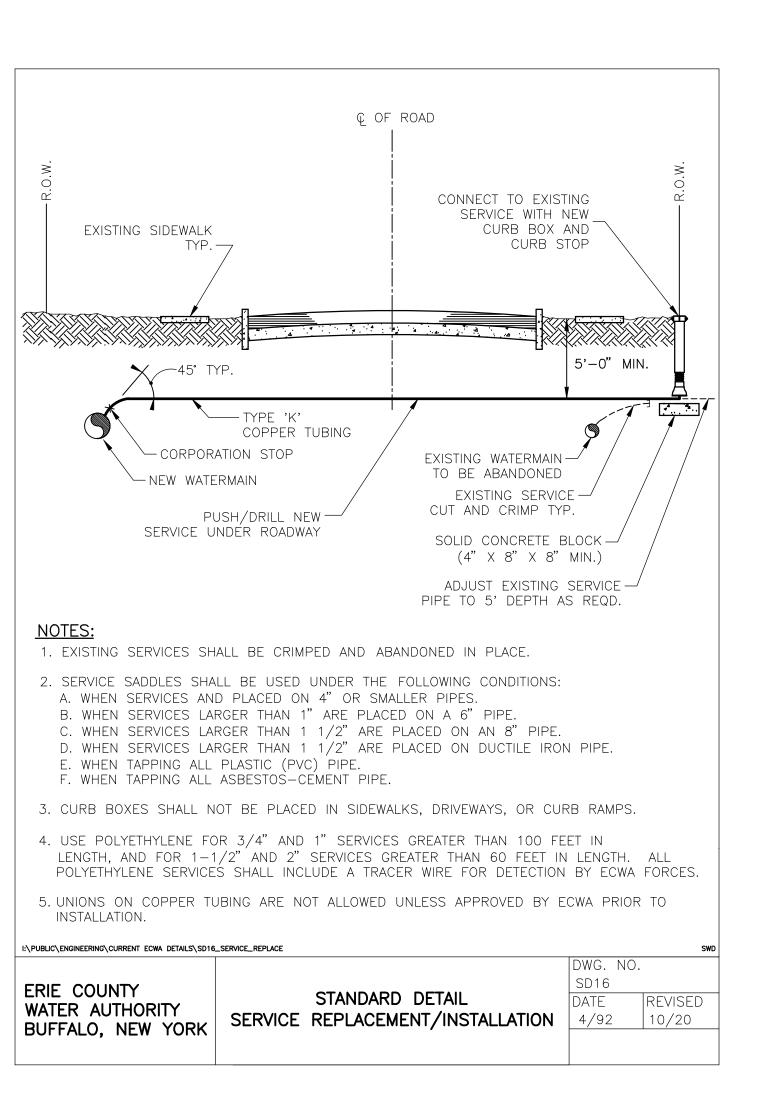


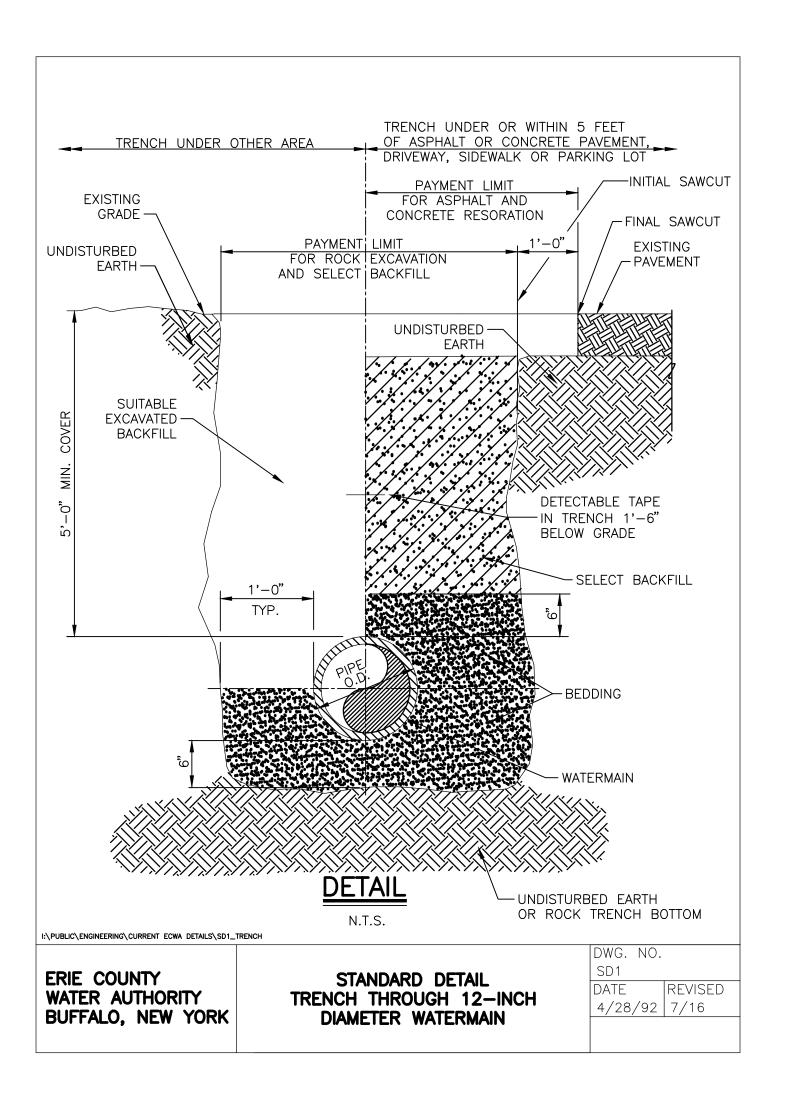


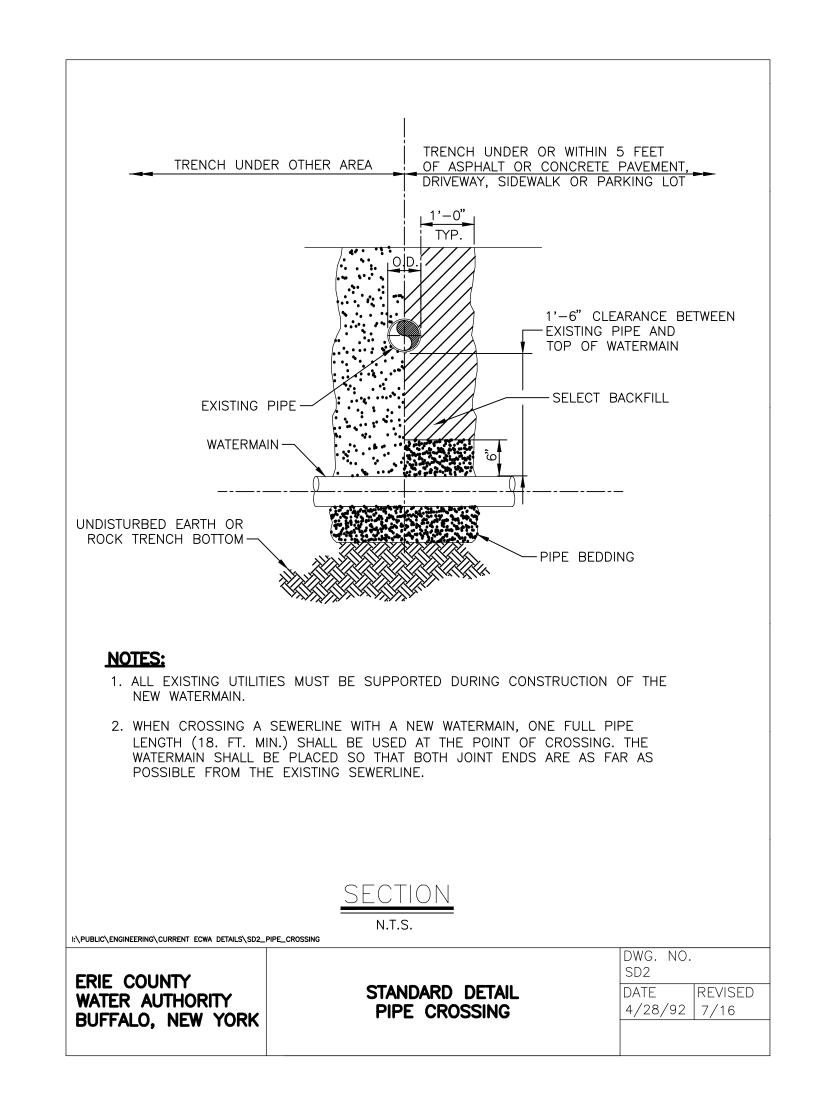


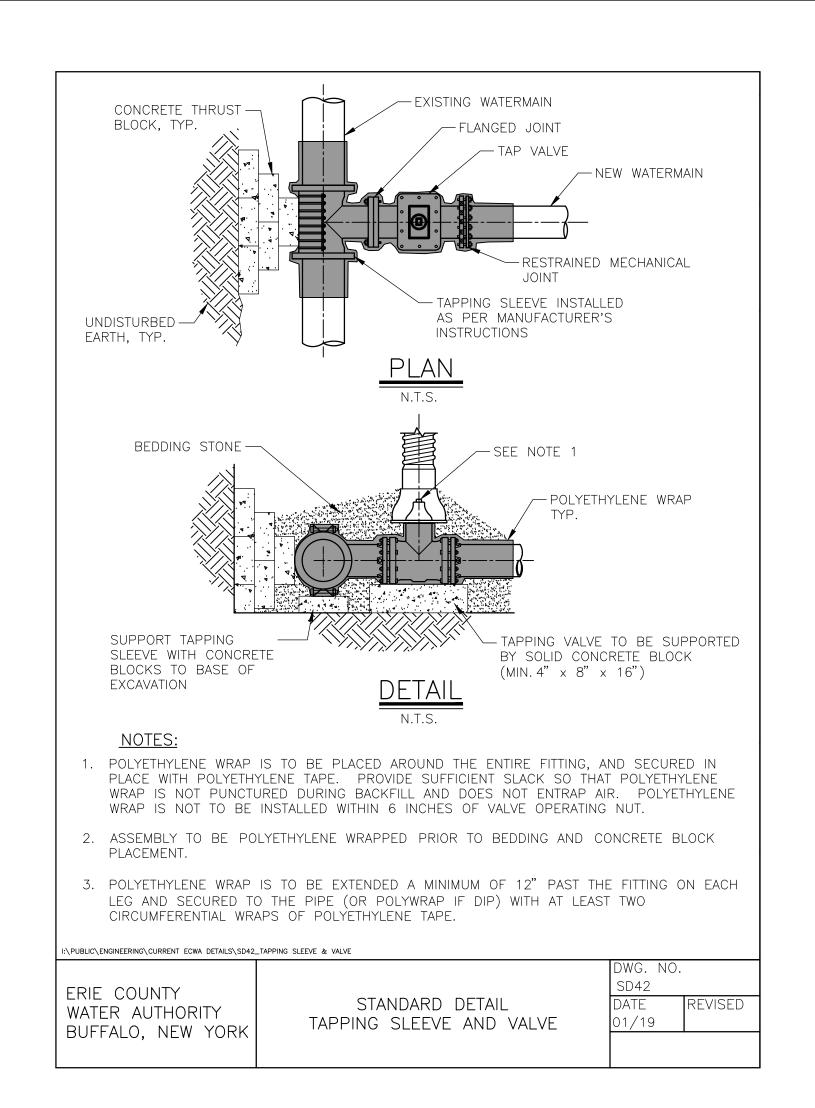


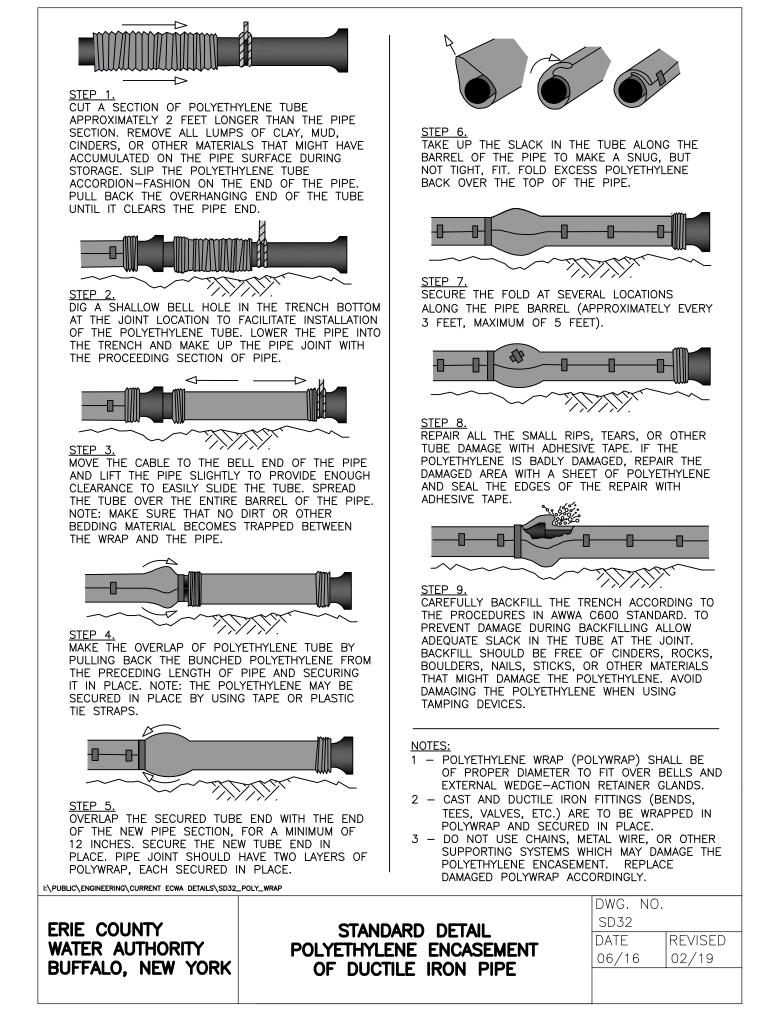

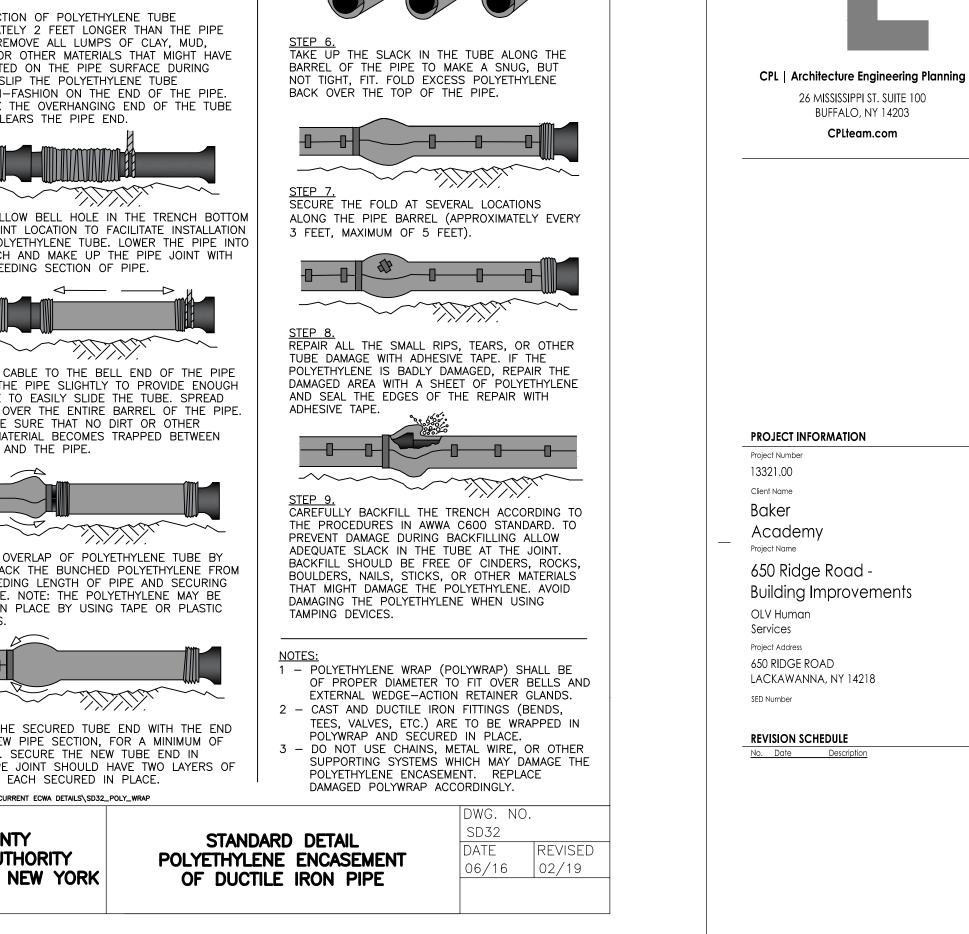

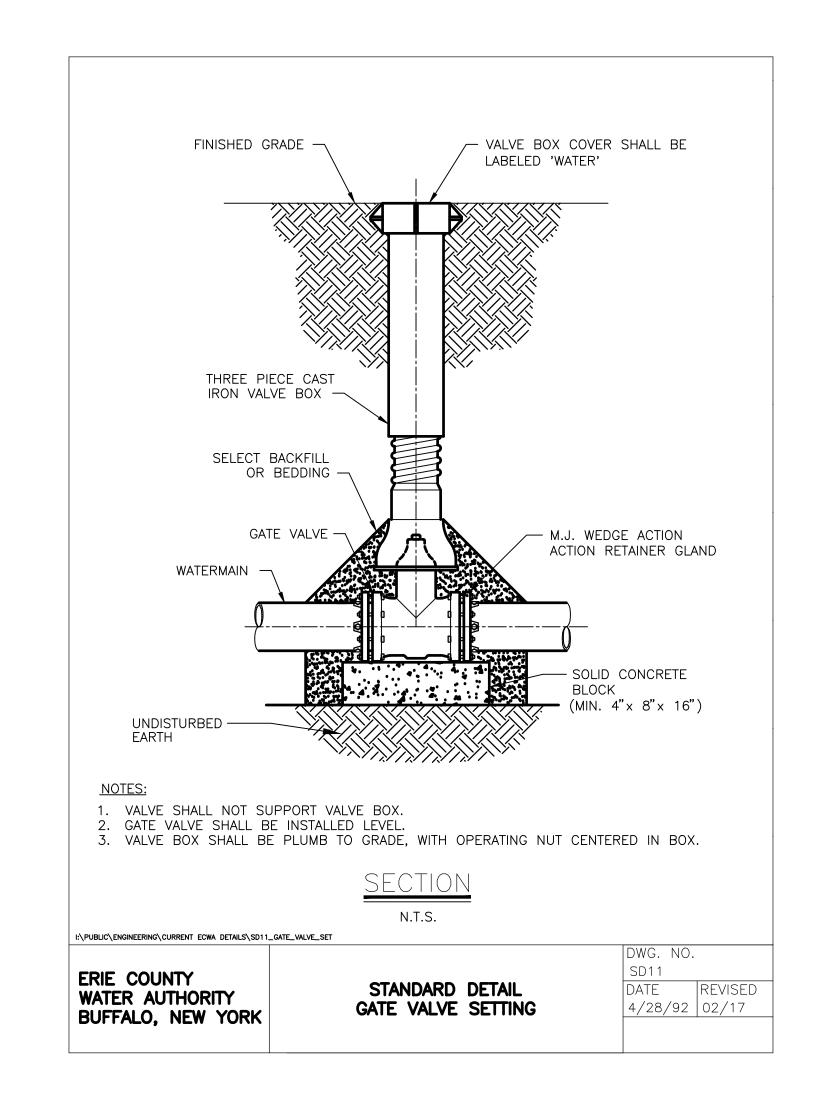

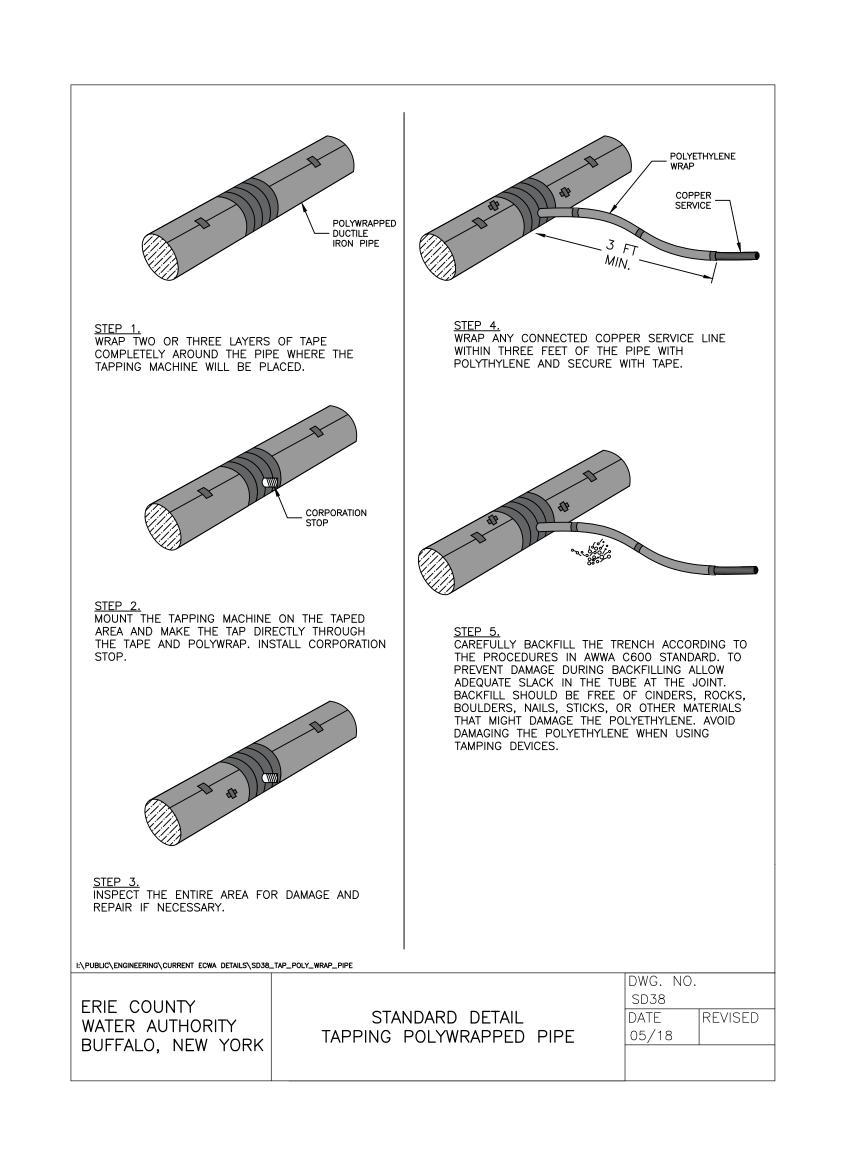

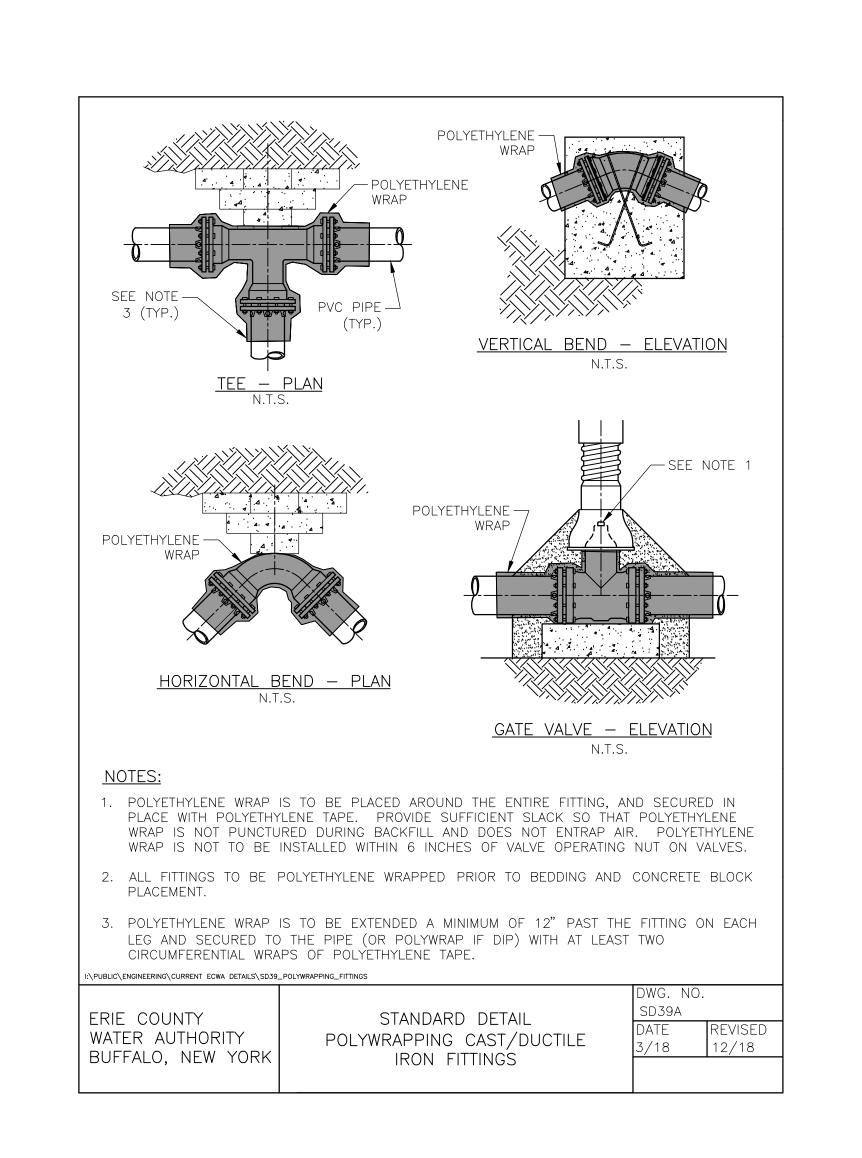






IT IS A VIOLATION OF THE NEW YORK STATE EDUCATION LAW AND ACTING UNDER THE DIRECTION OF A LICENSED ARCHITECT IF AN ITEM BEARING THE SEAL OF AN ARCHITECT, ENGINEER OR SURVEYOR IS ALTERED, THE ALTERING PARTY SHALL AFFIX TO THE ITEM THEIR SEAL AND THE NOTATION "ALTERED BY" FOLLOWED BY THEIR SIGNATURE AND THE DATE OF SUCH ALTERATION, AND A SPECIFIC DESCRIPTION OF THE ALTERATION.


SHEET INFORMATION 5/18/21 Drawing Title

CIVIL - DETAILS

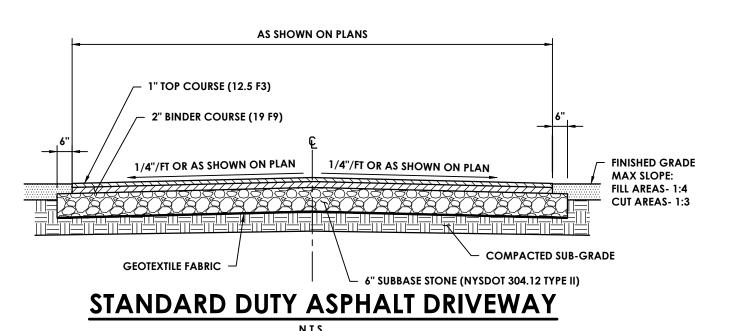

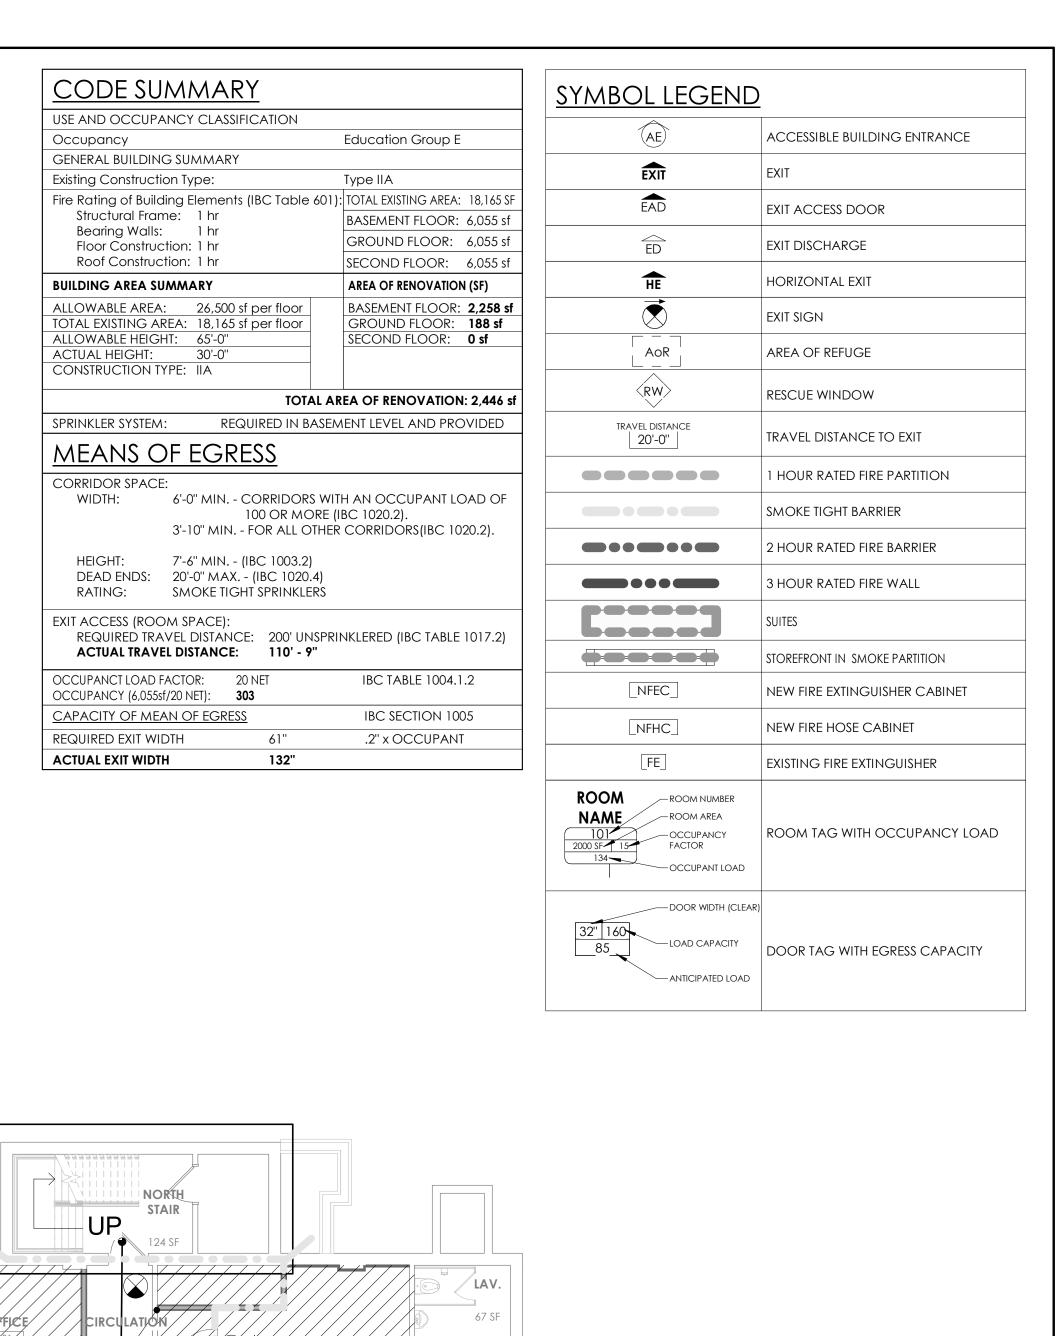

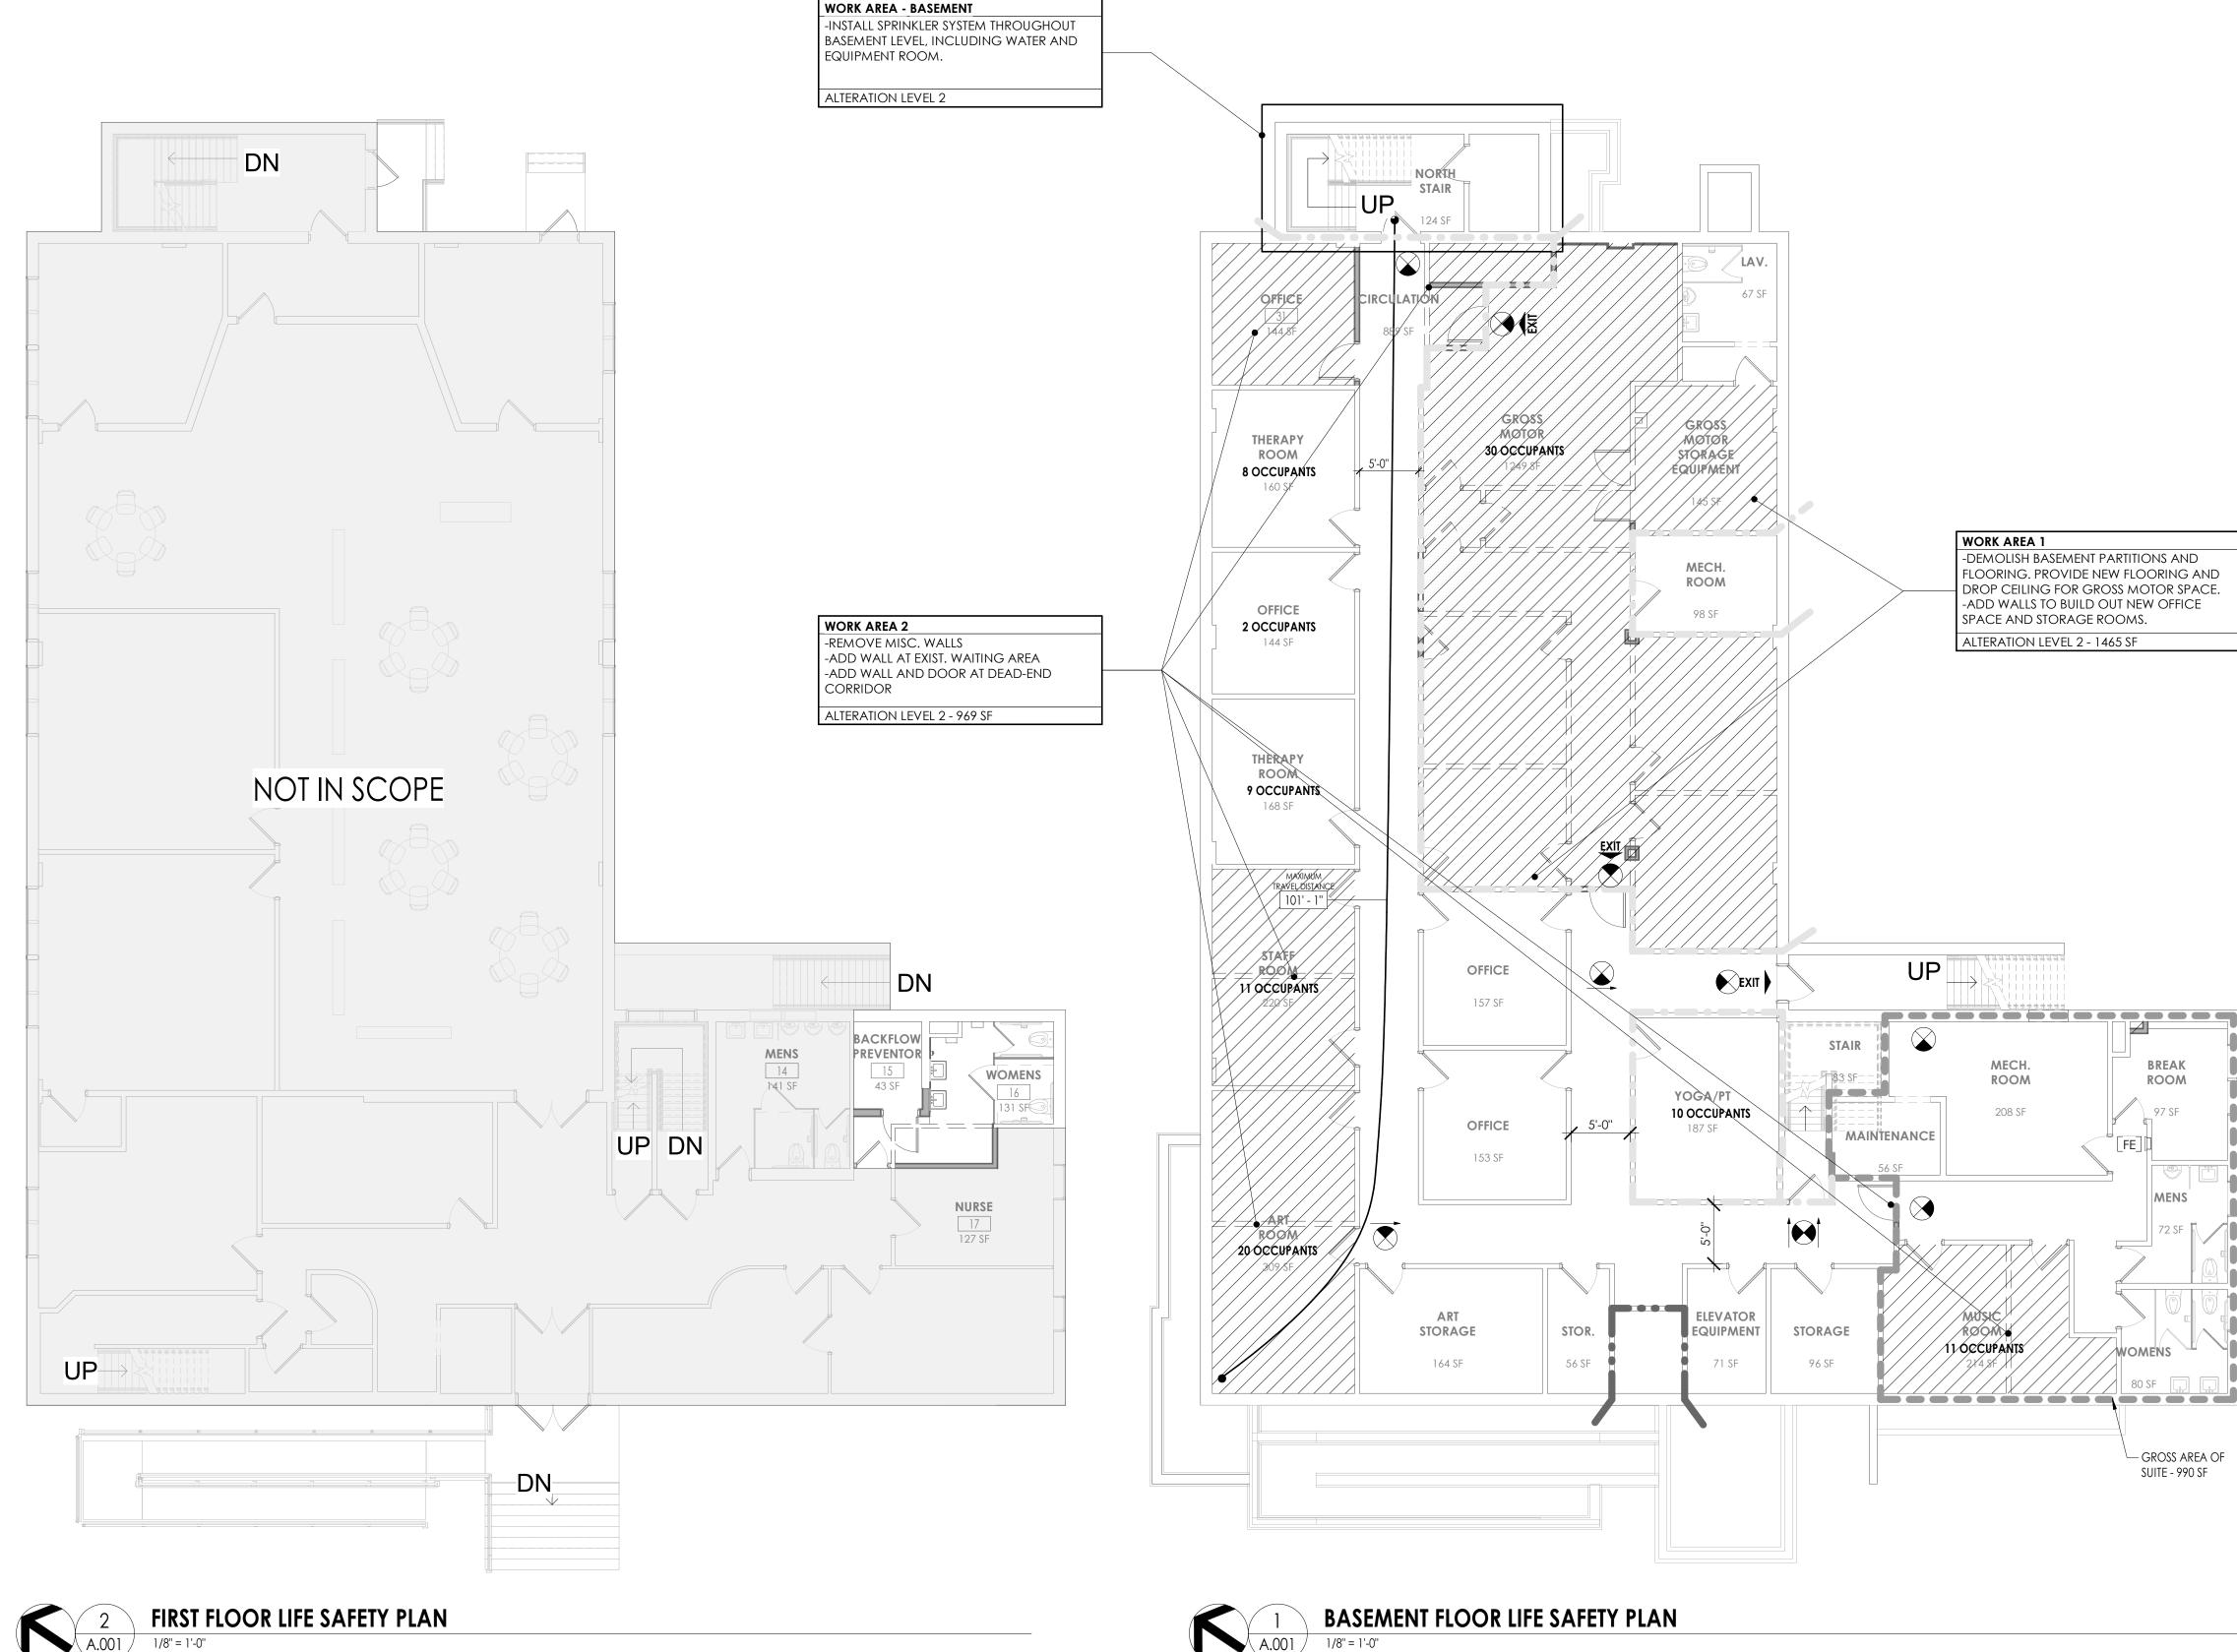

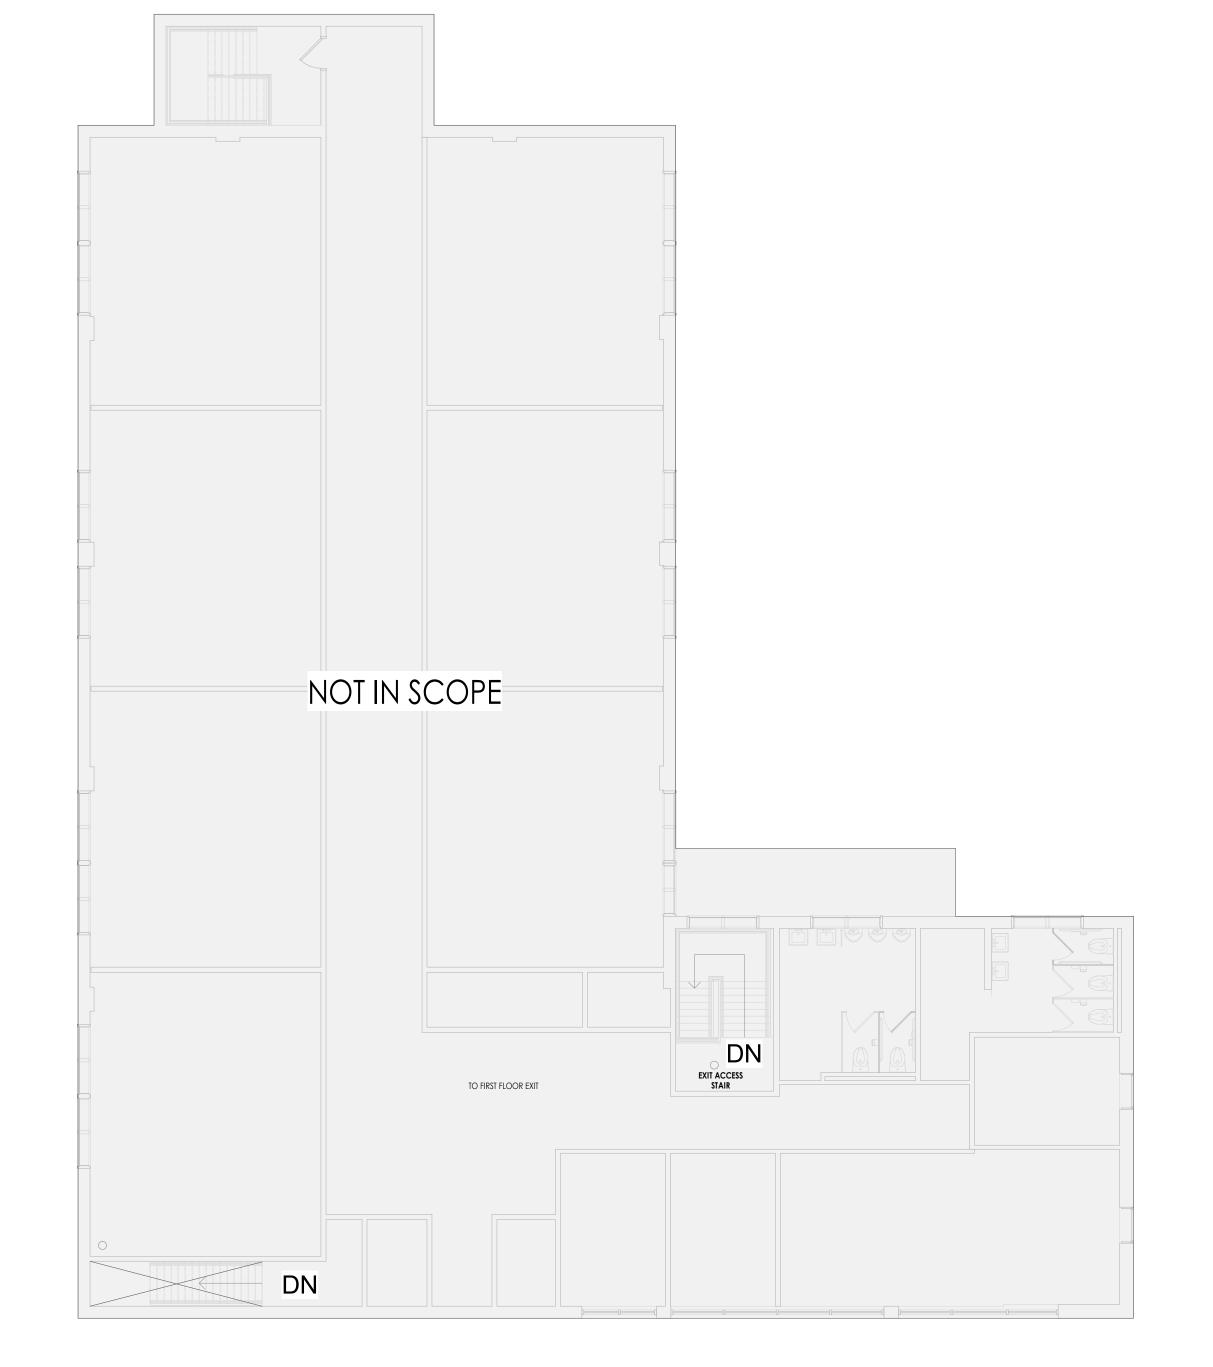

SECOND FLOOR LIFE SAFETY PLAN



FIRST FLOOR LIFE SAFETY PLAN

1/8" = 1'-0"



05/14/2021 AJT MEE
scale As indicated CODE SHEET

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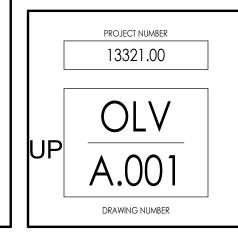
26 Mississippi St., Suite 300


Buffalo, New York 14203

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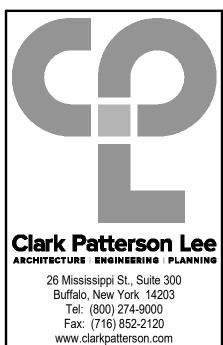
NOT IN SCOPE

DEMOLITION GENERAL NOTES

- 1. IT IS THE CONTRACTORS RESPONSIBILITY TO FAMILIARIZE THEMSELVES WITH ALL DETAILS INVOLVED IN THE DEMOLITION CONTRACT. SPECIFIC INSTRUCTION ON EACH ITEM WILL NOT BE GIVEN.
- 2. GC IS TO PROVIDE DUST CONTROL BARRIERS AT ALL AREAS OF CONSTRUCTION. 3. GC WILL SALVAGE ANY ITEMS PER OWNERS LIST (TBD).
- 4. PATCH WALLS, FLOORS AND CEILINGS AT ALL WALL REMOVALS, TO MATCH SCHEDULED FINISHES.
- 5. WORK AREAS SHALL BE MAINTAINED AND LEFT BROOM CLEANED AT END OF EACH
- 6. EXISTING BUILDING AND STRUCTURE TO REMAIN EXCEPT AS NOTED. 7. DIMENSIONS OF EXISTING ELEMENTS ARE APPROXIMATE. CONTRACTOR TO VERIFY.
- 8. CONTRACTOR TO COORDINATE WITH OWNER ON REMOVING OR RELOCATING EXISTING FURNITURE, SHELVING, AND ANY OTHER ASSOCIATED ITEMS PRIOR TO CONSTRUCTION.


DEMOLITION KEY NOTES

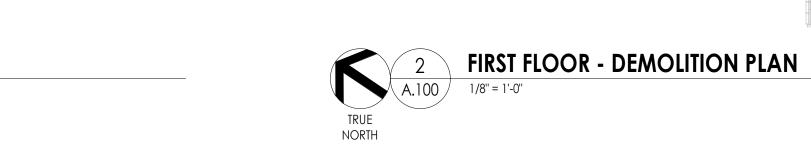- REMOVE SUSPENDED CEILING SYSTEM & LIGHT FIXTURES IN THEIR ENTIRETY. PRESEVE & PROTEXT EXISTING MEP ABOVE
- SELECTIVELY REMOVE PORTION OF EXISTING PLASTER CEILING. PREPARE FOR NEW GYPSUM CEILING TO MATCH EXISTING
- SELECTIVELY REMOVE 36"X36" PORTION OF EXISTING PLASTER CEILING FOR INSTALLATION OF PROPOSED SPRINKLER HEADS. PREPARE FOR NEW GYPSUM CEILING TO MATCH EXISTING. COORDINATE WITH PLUMBING & ELECTRICAL
- REMOVE & DISPOSE OF DOOR, FRAME, HARDWARE, & ALL ASSOCIATED ン MATERIALS IN THEIR ENTIRETY
- REMOVE DOOR, FRAME, & ALL ASSOCIATED MATERIALS. PRESERVE & PREPARE OPENING FOR NEW FIRE RATED DOOR
- REMOVE EXISTING FINISH FLOORING DOWN TO SUBFLOOR. PREPARE FOR NEW
- (F2) REMOVE CERAMIC TILE FLOORING TO SUBFLOOR. PREPARE FOR NEW FLOORING. lacksquare
- REMOVE EXISTING STUD FRAMED PARTITION IN ITS ENTIRETY. REFER TO FLOOR
- WI) PLANS. PROTECT ADJACENT WALLS TO REMAIN REMOVE STUD PARITION WALL. PATCH & PAINT ANY DAMAGE TO ADJACENT
- WZ) WALLS AND FLOORING REMOVE BLOCK WALL AND GLAZED CERAMIC TILE FINISH TO THE UNDERSIDE OF DECK. PATCH ANY DAMAGE TO ADJACENT WALLS AND FLOORING
- REMOVE SLIDING PARTITION, TRACK, AND ALL ASSOCIATED HARDWARE IN ITS
- REMOVE SINK, SALVAGE TO BE REUSED. REF. NEW WORK PLANS. SEAL OPENINGS
- in wall with stainless steel caps
- REMOVE & DISPOSE OF METAL FRAMED TILE COUNTER TOP. CLEAN EXISTING WALL TO REMAIN AND PATCH ATTACHMENT HOLES REMOVE & DISPOSE OF METAL FRAMED TILE COUNTER TOP. CLEAN EXISTING WALL TO REMAIN AND PATCH ATTACHMENT HOLES



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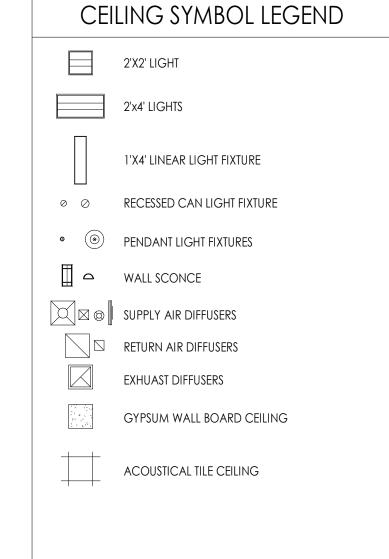
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EXISTING 12" DEEP WIDE FLANGE BEAM EXISTING 12" DEEP WIDE FLANGE BEAM EXISTING 6" DEEP WIDE FLANGE BEAM EXISTING 6" DEEP WIDE FLANGE BEAM EXISTING 6" DEEP WIDE FLANGE BEAM - ALUM. CLG GRID SYSTEM HEIGHT TRANSITION TRIM - SUSP. ACT CEILING SYSTEM _____ ACT SUSP. CEILING 1 1/2" = 1'-0" 3 5/8" METAL STUDS @ 4'-0"O.C. CROSS BRACING AS 5/8" GYP. BD. ON 3 5/8"METAL STUDS @16" O.C. RE: A600s SCHEDULED CLG. VARIES RE: A600'S — GYP. BD. SOFFIT, CORNER BEADS (PAINT) RE A600'S 2 **BULKHEAD DETAIL**A.600 1 1/2" = 1'-0" **BASEMENT FLOOR - RCP**

GENERAL CEILING NOTES

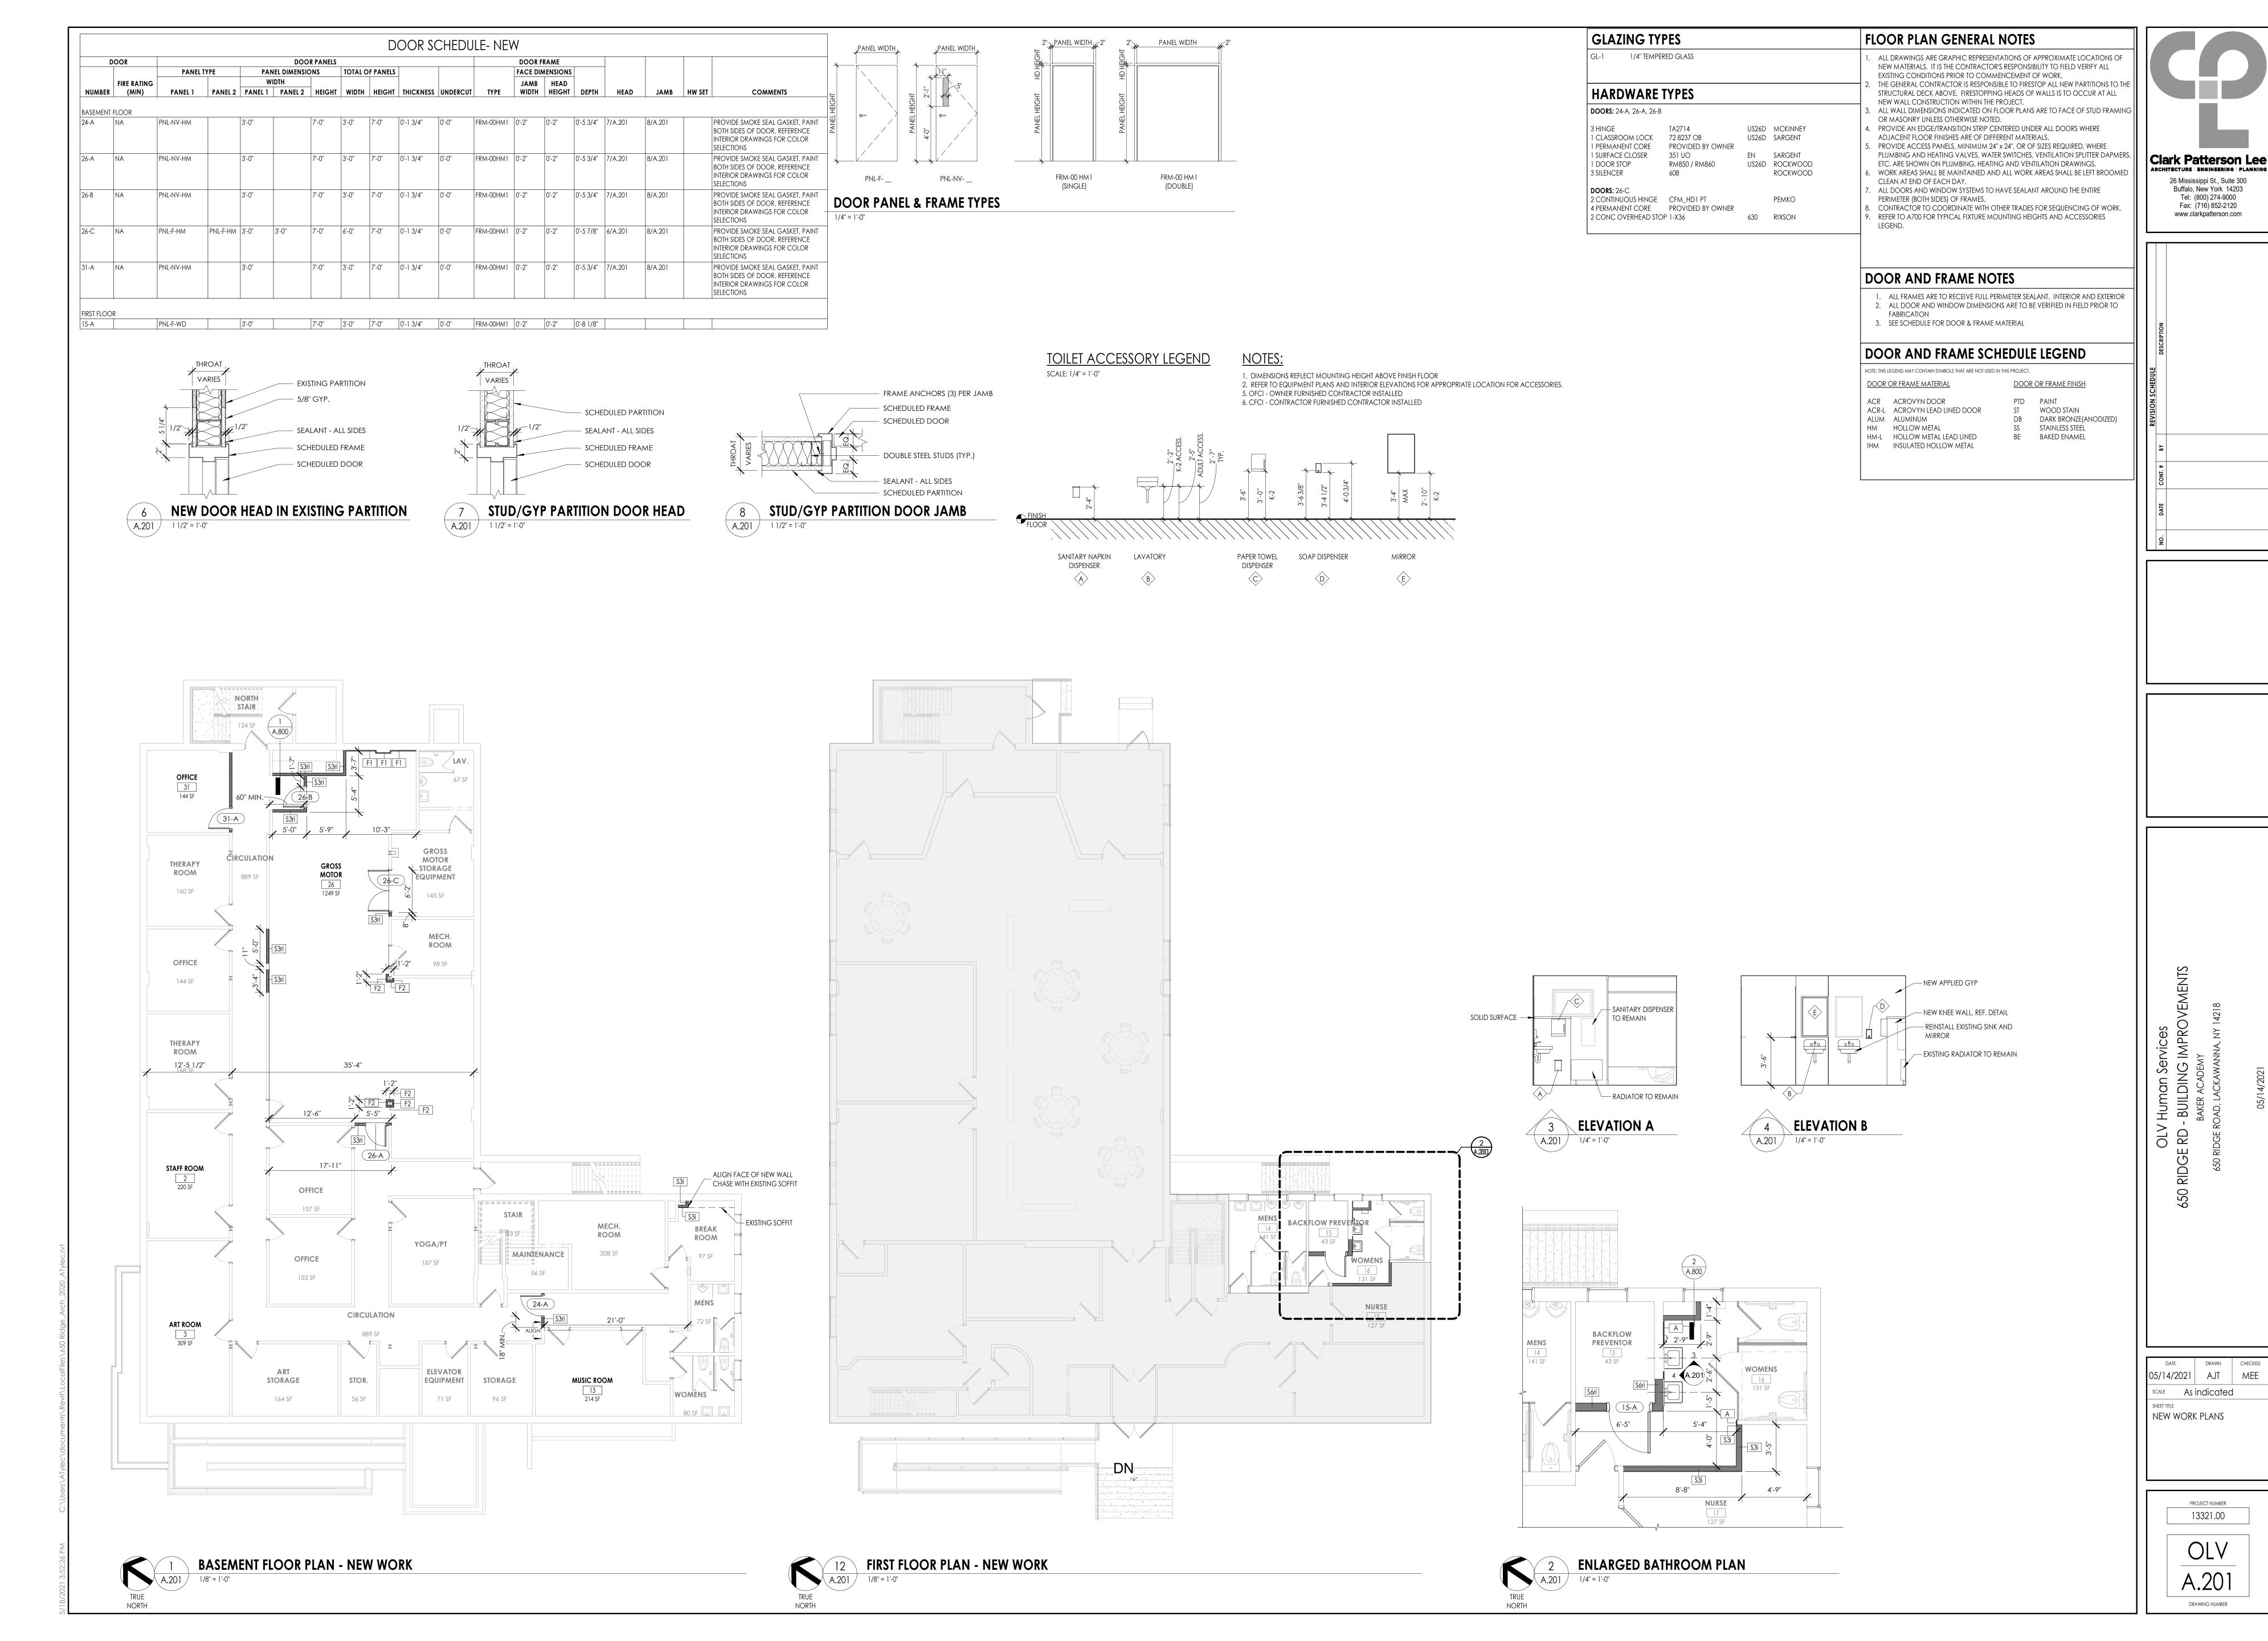- 1. ALL DRAWINGS ARE GRAPHIC REPRESENTATION OF APPROXIMATE LOCATIONS OF NEW MATERIALS FOR CONSTRUCTION. IT IS THE CONTRACTOR'S RESPONSIBILITY TO FIELD VERIFY ALL CONDITIONS PRIOR TO COMMENCEMENT OF WORK.
- 2. REFER TO A200 SERIES FOR FLOOR PLAN. 3. FOR ANY DISCREPENCY BETWEEN THE REFLECTED CEILING PLAN AND THE
- FLOOR PLAN: THE FLOOR PLAN SHALL TAKE PRECEDENCE. ANY DISCREPENCIES SHALL BE CALLED TO THE ATTENTION OF THE ARCHITECT. 4. IT IS THE CONTRACTOR'S RESPONSIBILITY TO FIRE STOP MECHANICAL, ELECTRICAL AND PLUMBING ITEMS, INCLUDING BUT NOT LIMITED TO
- DUCTWORK AND CONDUIT PENETRATIONS THROUGH FLOORS AND 5. THE CONTRACTOR SHALL COORDINATE CEILING INSTALLATIONS WITH
- MECHANICAL, ELECTRICAL AND PLUMBING DRAWINGS. 6. REFER TO "H" SERIES DRAWINGS FOR DIFFUSERS AND GRILLE LOCATIONS.
- 7. REFER TO "E" SERIES DRAWINGS FOR LIGHTING TYPES AND CONTROLS. 8. REFER TO "P" SERIES DRAWINGS FOR SPRINKLER HEAD LOCATIONS. 9. WORK AREAS SHALL BE MAINTAINED AND ALL WORK AREAS SHALL BE LEFT BROOMED CLEAN AT THE END OF EACH DAY.
- 10. CENTER CEILING GRID (EACH WAY) IN ROOMS SCHEDULED TO RECEIVE ACOUSTICAL CEILING SYSTEMS UNLESS OTHERWISE NOTED.
- 11. CONTRACTOR TO VERIFY WITH ARCHITECT THE INSTALLATION OF ANY CEILING TILES LESS THAN 4" IN WIDTH.
- 12. PROVIDE MOISTURE RESISTANT GYP. BD. AT ALL TOILET ROOM, JANITOR'S CLOSET AND OTHER WET LOCATION CEILING ASSEMBLIES. 13. ALL GYP. BD. CEILINGS AND SOFFITS SHALL BE PRIMED AND PAINTED
- SCHEDULED COLOR ON ALL FACES AND UNDERSIDE SURFACE. 14. CONTRACTOR TO VERIFY SOFFIT SIZE WITH MILLWORK SHOP DRAWINGS.
- PROVIDE 2" OVERHANG ON EXPOSED EDGES UNLESS NOTED OTHERWISE. 15. WHERE APPLICABLE ALL FIXTURES AND DEVICES SHALL BE CENTERED ON A CEILING TILE.



ACT-1 CEILING TYPE AND CEILING HEIGHT ABOVE FINISHED FLOOR

CUBICLE CURTAIN TRACK SEE DETAIL 21/A805

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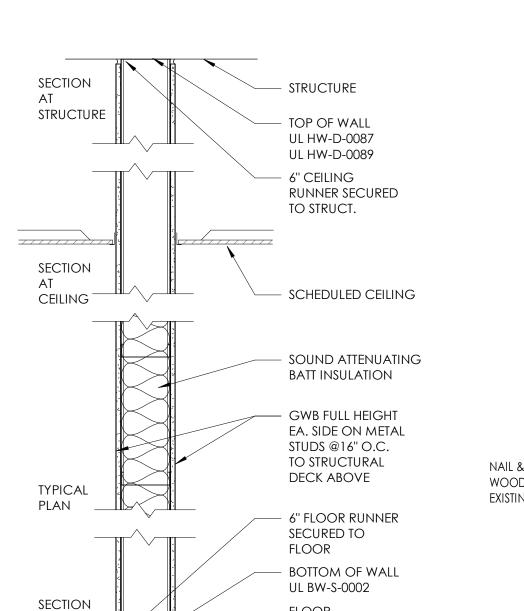
Tel: (800) 274-9000


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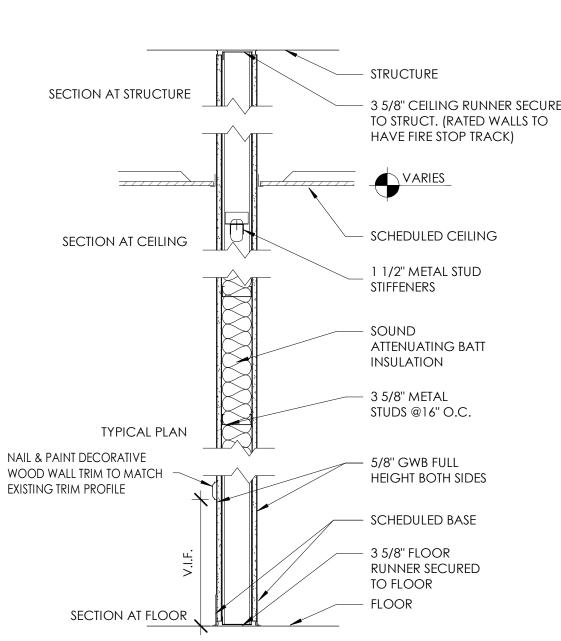
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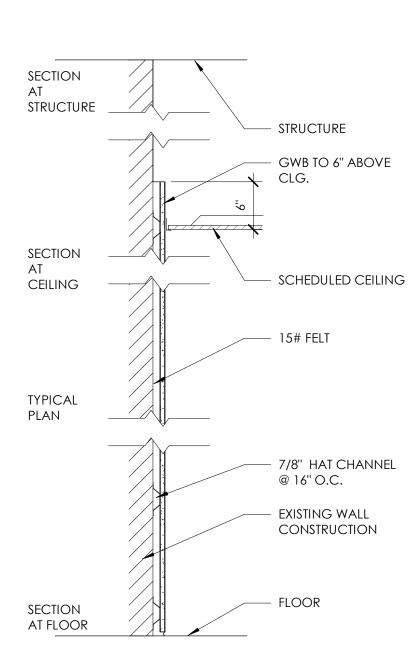





AT FLOOR




	1 -			
TYPE	FIRE TEST LAB DESIGN NUMBER	FIRE RATING	STC	NOTES
S3i	NA	NR	49	
S3ri	UL - U465	1HR	49	FIRE SEALANT AT TOP AND BOTTOM

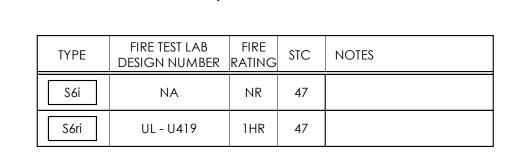


TYPE	FIRE TEST LAB DESIGN NUMBER	FIRE RATING	STC	NOTES
F1	NA	NR	NA	

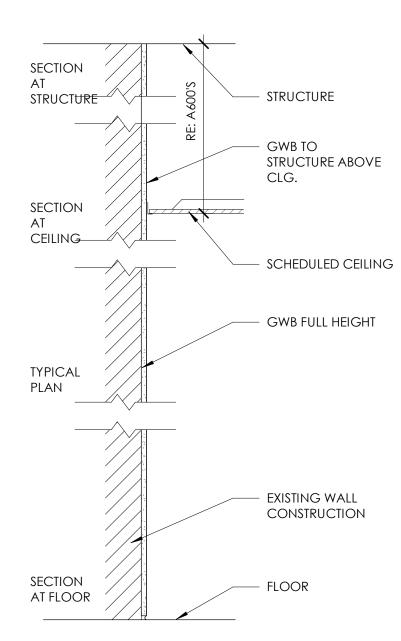

TYPE	FIRE TEST LAB DESIGN NUMBER	FIRE RATING	STC	NOTES
А	NA	NR	NA	

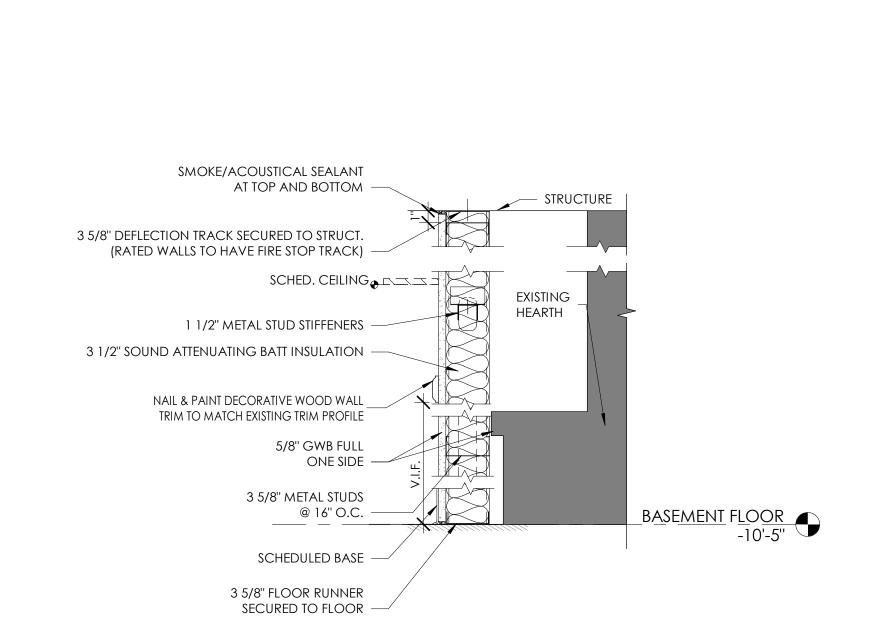

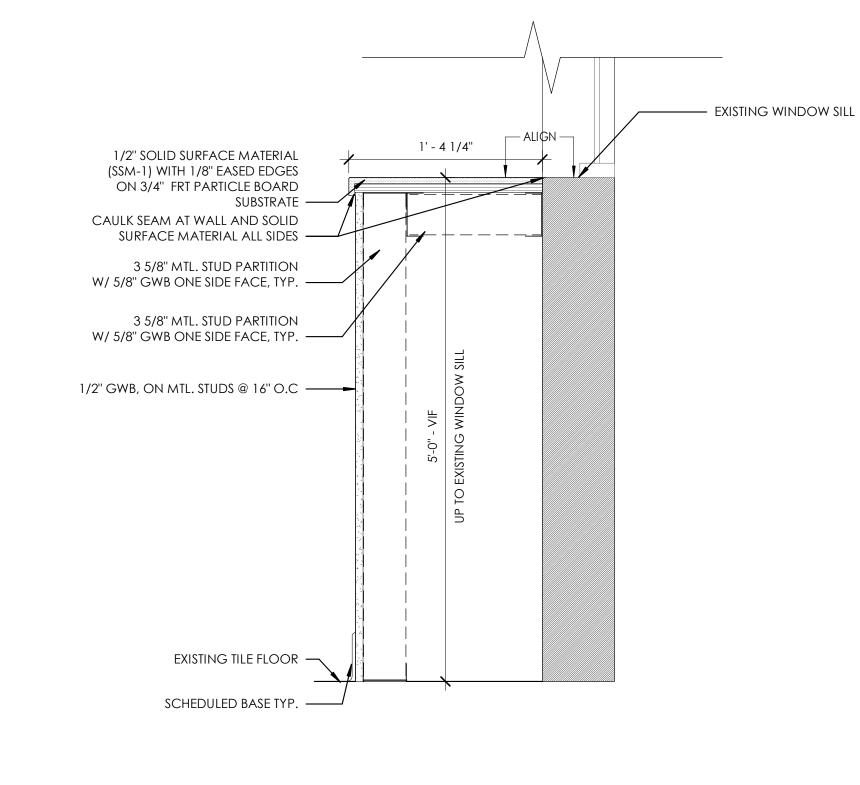




PARTITION GENERAL NOTES

- UNLESS NOTED OTHERWISE ALL PARTITIONS ARE FULL HEIGHT, EXTEND & SECURE TO UNDERSIDE OF CONCRETE OR METAL DECK ABOVE.
- 2. PROVIDE UL APPROVED JOINT AT ALL TOP OF WALL AND WALL TO WALL CONDITIONS AT ALL RATED WALLS.
- 3. PROVIDE DEFLECTION TRACKS AT METAL STUD PARTITIONS THAT TERMINATE AT THE UNDERSIDE OF STRUCTURE AND DECK.
- 4. ALL PENETRATIONS IN FIRE RATED PARTITIONS TO BE FIRE STOPPED AND SEALED.
 REFER TO SPEC DIVISION 7.
- ALL PARTITIONS SHALL BE SEALED TO PREVENT PASSAGE FOR SMOKE.
 CONTRACTOR TO REFER TO CODE/LIFE SAFETY DRAWINGS FOR RATED PARTITIONS AND UL ASSEMBLIES.
- 7. REFER TO INTERIOR DRAWINGS FOR LOCATIONS OF WALL TILE, AND OTHER SPECIALTY WALL FINISHES.
- SPECIALTY WALL FINISHES.

 8. PARTITION TYPES WITH ONE SIDE OF DOUBLE DRYWALL TO BE PLACED SO THAT THE DOUBLE SIDE IS ON CORRIDOR AND/OR HIGH TRAFFIC SIDE OF WALL.
- REFER TO SPECIFICATIONS FOR METAL STUD GAUGE REQUIREMENTS.
 CONTRACTOR IS RESPONSIBLE TO COORDINATE ALL PARTITION ACCESSORIES (APPLIED FINISHES, RESILIENT CHANNEL, ADDITIONAL LAYERS OF SHEATHING, SHIELDING, ETC.) ITEMS SHOWN IN TYPICAL WALL CONSTRUCTION DETAILS MAY HAVE TO BE ARRANGED ON DIFFERENT SIDES OF WALL ASSEMBLY TO ACHIEVE FLUSH CONTINUOUS WALL SURFACES. ANY CONFLICTS SHOULD BE BROUGHT TO THE ATTENTION OF THE ARCHITECT.

PARTITION TYPE TAG LEGEND:

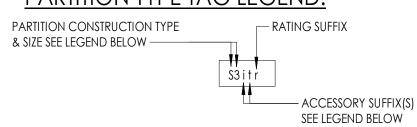

PARTITION TYPE SUFFIX:

ACCESSORIES SUFFIX:

i - SOUND ATTENUATING BATT INSULATION (FIBERGLASS) FRICTION FIT BETWEEN STUDS TO FILL CAVITY

w - SOUND ATTENUATING FIRE BATT INSULATION (ROCK WOOL) FRICTION FIT BETWEEN STUDS TO FILL CAVITY

† - CERAMIC WALL TILE (1) SIDE W/ THINSET MORTAR BED, 5/8" CEMENT BACKER BOARD IN LIEU OF 5/8" GYP. AT TILE LOCATIONS - SEE INTERIOR ELEVATIONS FOR TILE EXTENTS

th - Ceramic Wall tile (2) sides W/ Thinset Mortar Bed, 5/8" Cement Backer Board in Lieu of 5/8" Gyp. at tile locations - See interior elevations for tile extents

b - Interior veneer masonry/stone applied finish, refer to details for construction, and interior elevations for extents

g - CMU WALL GROUT CORES SOLID

5/8" TYPE X GYP.

s - ADD 1/2" RC1 RESILIENT SOUND CHANNEL BEHIND SPECIFIED SHEATHING

k - ADD ADDITIONAL (1) LAYER OF 5/8" GYP BOARD, TO ONE SIDE OF WALL

kk - ADD ADDITIONAL (2) LAYERS OF 5/8" GYP BOARD, (1) EA. SIDE OF WALL

e - ADD ADDITIONAL (1) LAYER OF 5/8" FRT PLYWOOD BOLTED TO WALL FOR MOUNTING OF ELECTRICAL PANELS/ EQUIPMENT WHERE NOTED ON ELEC. DWGS.

v - SUBSTITUE (1) LAYER OF 5/8" SOUNDBLOCK GYP. W/ INTEGRAL VISCOELASTIC POLYMER CORE FOR (1) LAYER OF SPECIFIED 5/8" TYPE X GYP.

vv - SUBSTITUE 5/8" SOUNDBLOCK GYP. W/ INTEGRAL VISCOELASTIC POLYMER CORE FOR ALL LAYER OF SPECIFIED

p - LEAD SHIELDING REFER TO PHYSICIST REPORT FOR REQUIREMENTS

x - COPPER MAGNETIC/RF SHIELDING REFER TO PHYSICIST REPORT FOR REQUIREMENTS

c - WALL FINISH TO TERMINATE 6" ABV. HIGHEST ADJACENT CEILING STUDS TO RUN TO UNDERSIDE OF DECK ABOVE.

y - WALL STRUCTURE TERMINATES 12" ABV. HIGHEST ADJACENT CEILING, PROVIDE STRUCTURAL BRACING AT TOP OF WALL AS REQUIRED.

n - KNEE WALL, REFER TO INTERIOR ELEVATIONS FOR HEIGHT & SILL CONDITION, REFER TO STRUCTURAL DETAILS FOR REQUIRED SUPPLEMENTAL STEEL AND ANCHORING REQUIREMENTS

RATING SUFFIX:

r - 1 HR RATED ASSEMBLY REFER TO UL DETAILS FOR RATED CONSTRUCTION REQUIREMENTS

d - 2 HR RATED ASSEMBLY REFER TO UL DETAILS FOR RATED CONSTRUCTION REQUIREMENTS

rd - 3 HR RATED ASSEMBLY REFER TO UL DETAILS FOR RATED CONSTRUCTION REQUIREMENTS

dd - 4 HR RATED ASSEMBLY REFER TO UL DETAILS FOR RATED CONSTRUCTION REQUIREMENTS

PARTITION CONSTRUCTION TYPE & SIZE LEGEND:

- S# STEEL STUDS

 1 = 1 5/8" C STUD

 2 = 2 1/2" C STUD

 3 = 3 5/8" C STUD

 4 = 4" C STUD

 6 = 6" C STUD

 8 = 8" C STUD
- F# STEEL STUD FURRING FINISH ONE SIDE

 1 = 1 5/8" C STUD

 2 = 2 1/2" C STUD
- 3 = 3 5/8" C STUD
 4 = 4" C STUD
 6 = 6" C STUD
 8 = 8" C STUD
- W# STEEL STUD SHAFT WALL ASSEMBLY
 2 = 2 1/2" CH SHAFTWALL STUD
 4 = 4" CH SHAFTWALL STUD
- 6 = 6" CH SHAFTWALL STUD

 CONSTRUCTION BARRIER/TEMP WALL

 1 = 1 5/8" C STUD
- 1 = 1 5/8" C STUD
 2 = 2 1/2" C STUD
 3 = 3 5/8" C STUD
 4 = 4" C STUD
 6 = 6" C STUD
- M# CONCRETE MASONRY UNIT

 4 = 4" NOMINAL CMU

 6 = 6" NOMINAL CMU

8 = 8" C STUD

- 8 = 8" NOMINAL CMU
 10 = 10" NOMINAL CMU
 12 = 12" NOMINAL CMU
- WOOD STUDS
 4 = 2"x4" NOMINAL WOOD LUMBER STUDS
 6 = 2"x6" NOMINAL WOOD LUMBER STUDS
 8 = 2"x8" NOMINAL WOOD LUMBER STUDS
- A APPLIED FINISH NON SELF SUPPORTING/ATTACHED TO OTHER STRUCTURE

 C# RESILIENT CHANNEL NON SELF SUPPORTING/ATTACHED TO OTHER STRUCTURE
- 1 = 1/2" RC-1 RESILIENT CHANNEL
 2 = 1/2" RC-2 RESILIENT CHANNEL
 HAT CHANNEL NON SELF SUPPORTING/ATTACHED TO OTHER STRUCTURE
 - 1 = 7/8" HAT CHANNEL
 2 = 1 1/2" HAT CHANNEL
 Z# ZEE-FURRING NON SELF SUPPORTING/ATTACHED TO OTHER STRUCTURE
 - Z# ZEE-FURRING NON SELF SUPPORTING/ATTACHED TO OTHE

 1 = 1" ZEE FURRING

 1.5 = 1 1/2" ZEE FURRING

 2 = 2" ZEE FURRING
 - 2 = 2" ZEE FURRING
 2.5 = 2 1/2" ZEE FURRING
 3 = 3" ZEE FURRING

Clark Patterson Lee

26 Mississippi St., Suite 300

Buffalo, New York 14203

Tel: (800) 274-9000

Fax: (716) 852-2120

www.clarkpatterson.com

man services ILDING IMPROVEMENTS er academy Lackawanna, ny 14218

650 RIDGE RD - BUILDING
BAKER ACADEI
650 RIDGE ROAD, LACKAW,

DATE DRAWN CHECKED
05/14/2021 AJT MEE

SCALE As indicated


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WALL TYPES & DETAILS


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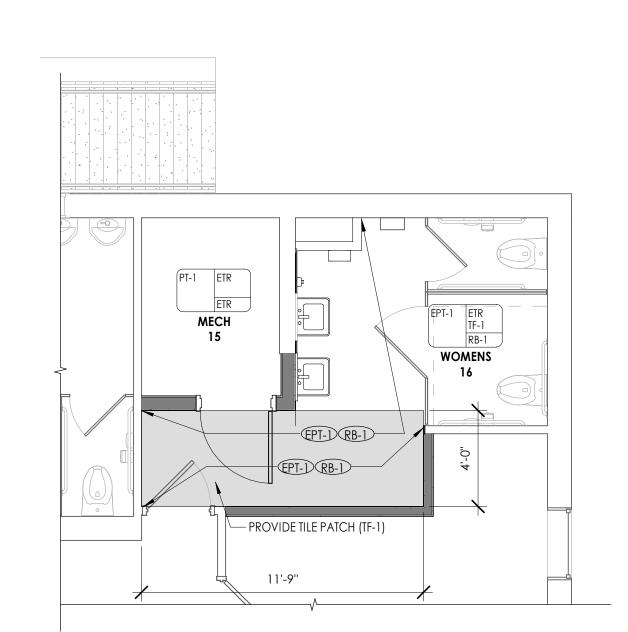
OLV

A.800

DRAWING NUMBER



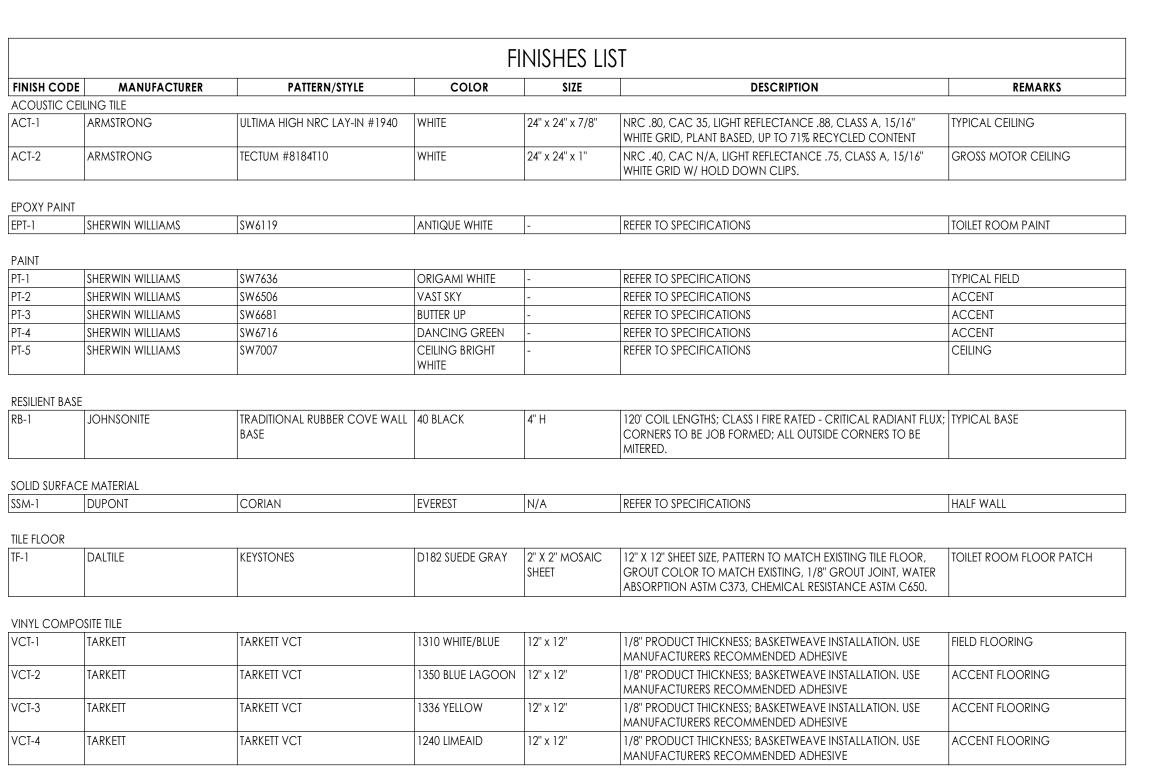

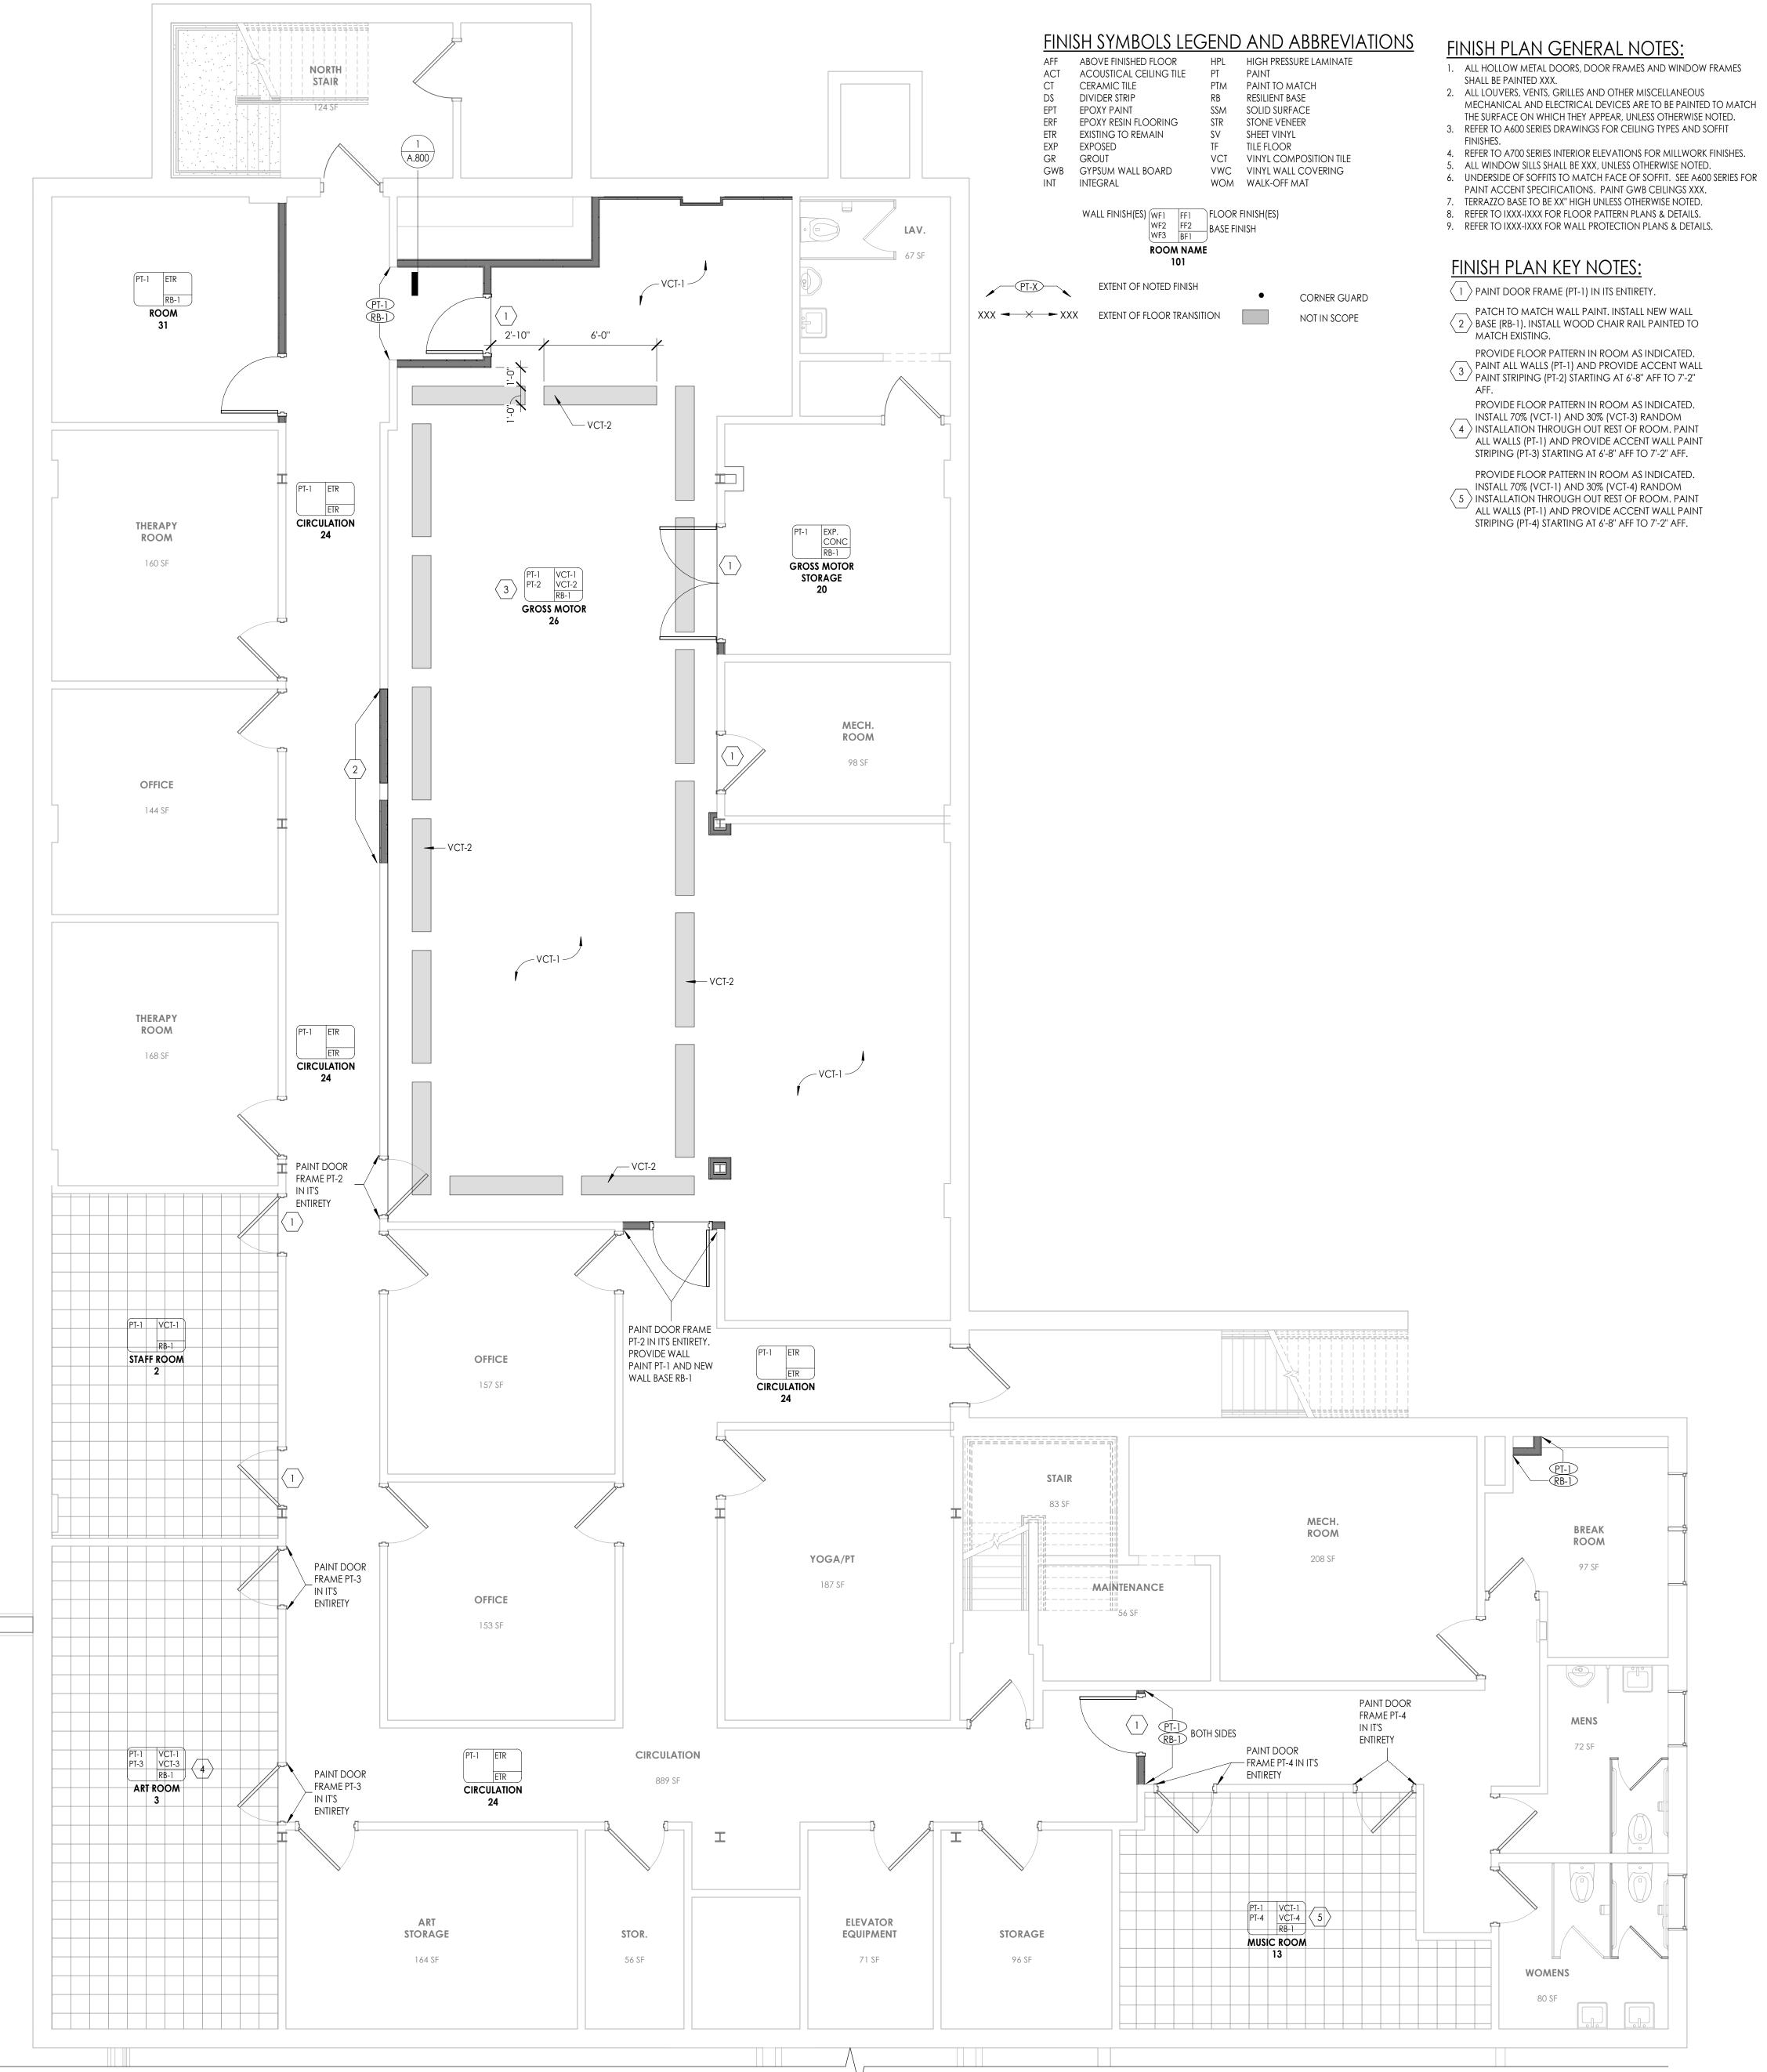

BASEMENT FLOOR - INTERIOR PLAN

2 FIRST FLOOR - INTERIOR PLAN
1.200 1/4" = 1'-0"

13321.00

OLV

1.200

DRAWING NUMBER

05/14/2021 BEN MEE

SCALE As indicated

FLOOR FINISH PLAN


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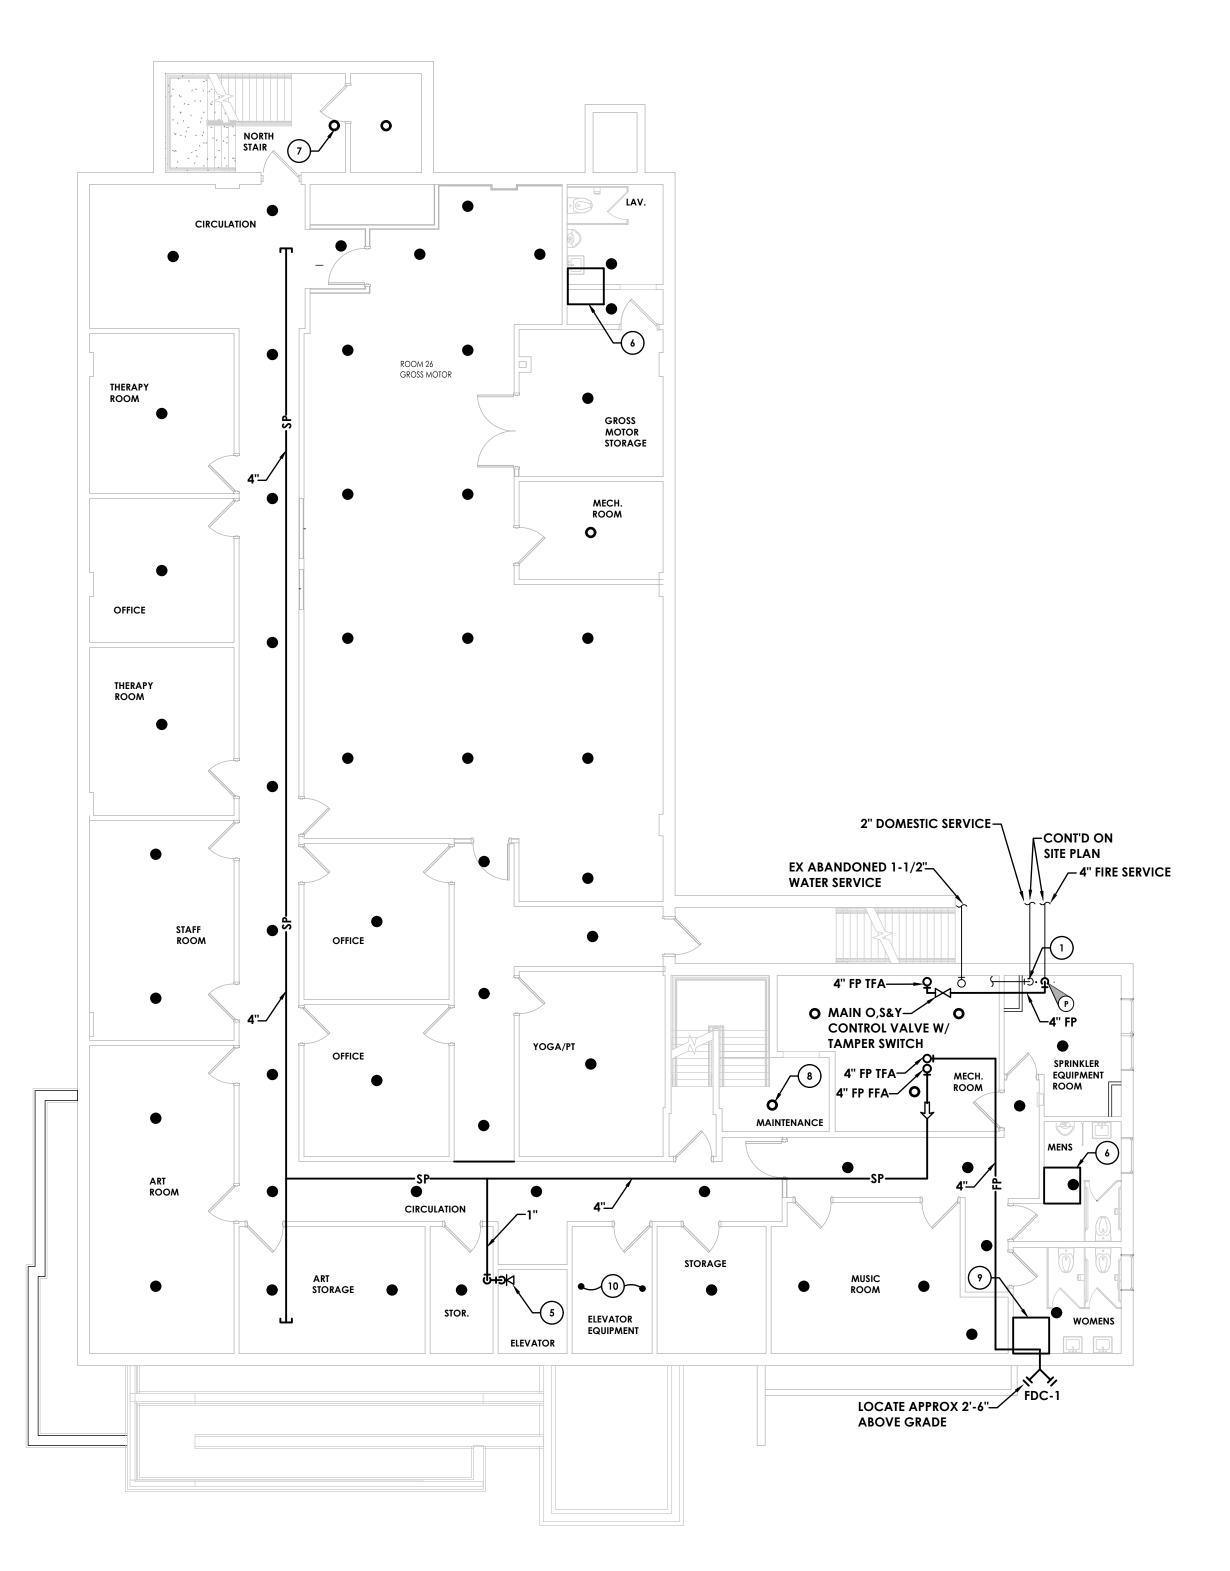
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NOTES

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- 2. PROVIDE ALL PIPING, DEVICES, AND TRIM TO PROVIDE A COMPLETE INSTALLATION OF THE ALARM CHECK VALVE PER MANUFACTURERS RECOMMENDATIONS.
- 3. FIRE SERVICE BACKFLOW PREVENTERS TO BE MOUNTED WITH CLEARANCES AS DESCRIBED IN THE NEW YORK STATE DEPARTMENT OF HEALTH GUIDELINES, UNLESS SPECIFICALLY NOTED OTHERWISE. CLEARANCES TO BE: 12" CLEAR SPACE ABOVE ASSEMBLY; 30" CLEAR SPACE IN FRONT OF ASSEMBLY AND 8" CLEAR SPACE BETWEEN ASSEMBLY AND WALL.






	FIRE PROTECTION EQUIPMENT SCHEDULE									
MARK	EQUIPMENT	WATER	ELEC	DESCRIPTION						
DCDA-1	DOUBLE CHECK DETECTOR ASSEMBLY BACKFLOW PREVENTER	4"	-	WATTS MODEL 709 DCDAOSY						
ACV-1	ALARM CHECK VALVE	4"	-	VIKING MODEL J-1 WITH RETARD CHAMBER AND TRIM KIT						
FDC-1	FIRE DEPARTMENT CONNECTION	4"	-	VIKING MODEL 09-010, SIAMESE TYPE, 4" x 2-1/2" x 2-1/2"						
-	TAMPER SWITCH	-	120/1/60	SYSTEM SENSOR MODEL OSY2						
-	FLOW SWITCH	4"	120/1/60	SYSTEM SENSOR MODEL WFDN						
-	ELECTRIC ALARM BELL	-	120/1/60	SYSTEM SENSOR MODEL SSM/SSV						
-	UPRIGHT SPRINKLER HEAD	1"	-	VIKING MODEL VK100						
-	CONCEALED PENDENT SPRINKLER HEAD	1"	-	VIKING MODEL VK465, WITH WHITE COVER PLATE						
-	CONCEALED HORIZONTAL SIDEWALL SPRINKLER HEAD	1"	-	VIKING MODEL VK481, WITH WHITE COVER PLATE						

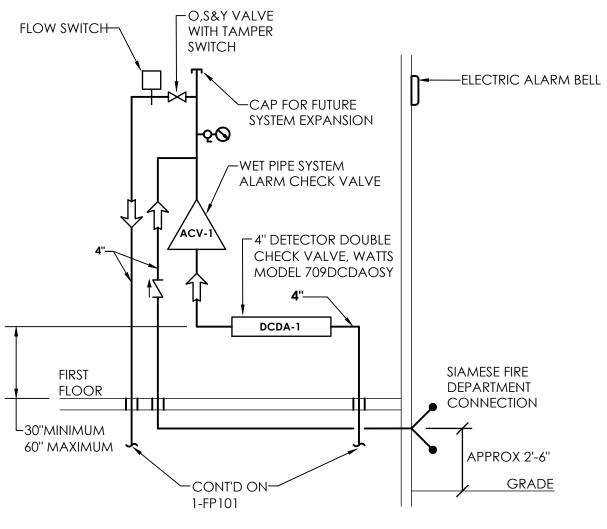
REMARKS

- 1. BACKFLOW PREVENTER INSTALLATION SHALL BE IN CONFORMANCE WITH ALL NY STATE DEPARTMENT OF HEALTH AND WATER PROVIDER REQUIREMENTS.
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2. FIRE DEPARTMENT CONNECTION THREADS SHALL CONFORM WITH LOCAL FIRE DEPARTMENT REQUIREMENTS.



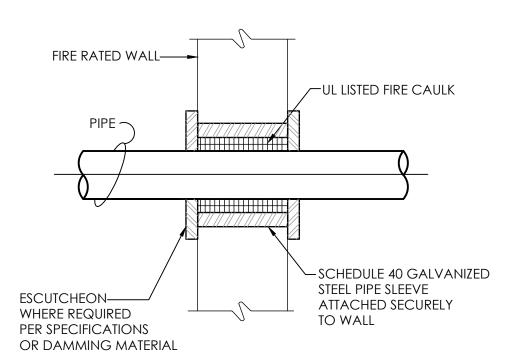




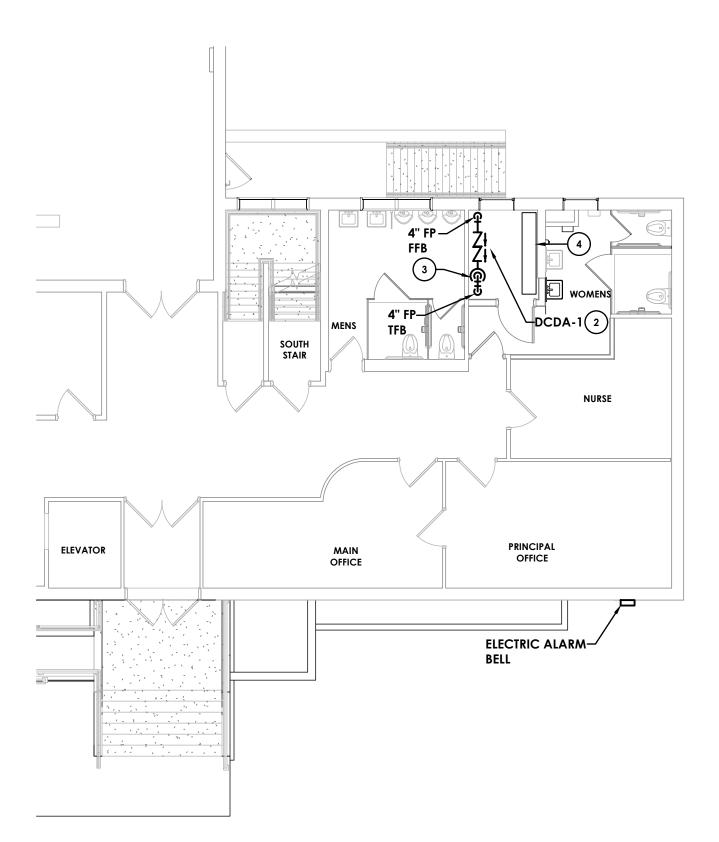



PIPING & FITTINGS LEGEND

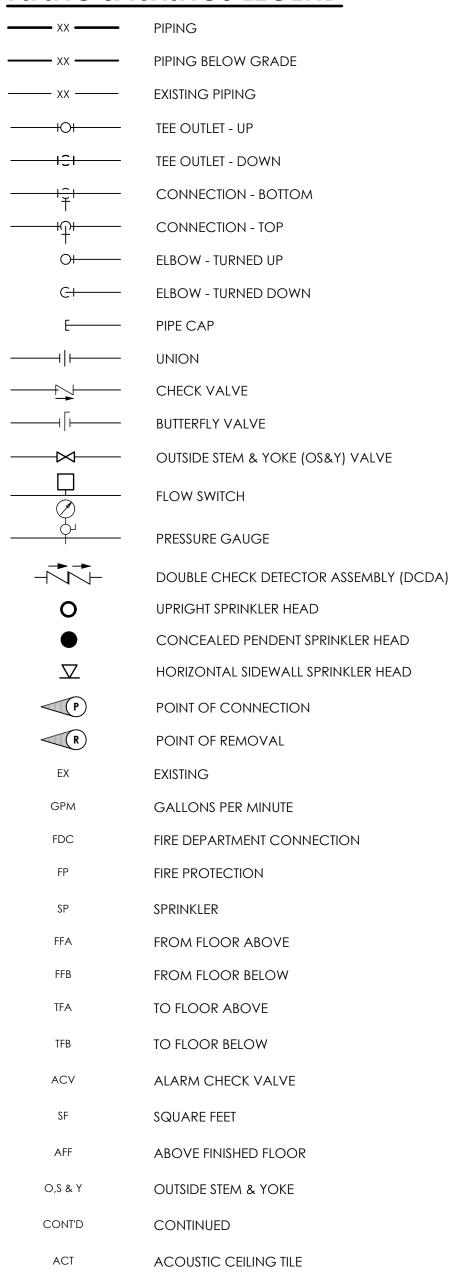

GENERAL SPRINKLER NOTES:

1. IN AREAS WHERE EXISTING ACT CEILING IS NOT BEING REPLACED, THE CONTRACTOR SHALL BE RESPONSIBLE FOR REMOVING AND

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2. MAINS AND SPRINKLER HEADS ARE SHOWN FOR SUGGESTED LOCATION AND SIZING ONLY. CONTRACTOR TO LOCATE MAINS, ALL BRANCH PIPING AND SPRINKLER HEADS, AND SIZE PER NFPA 13 USING HYDRAULIC CALCULATIONS. COORDINATE PIPING AND SPRINKLER HEAD LOCATIONS WITH OTHER TRADES.

3. SUBMIT SHOP DRAWINGS, HYDRAULIC CALCULATIONS, AND PRODUCT DATA FOR REVIEW. PER A HYDRANT FLOW TEST

4. COORDINATE SPRINKLER PLACEMENT WITH CEILING TILES, LIGHT FIXTURES, DIFFUSERS AND SMOKE/HEAT DETECTORS. REFER TO ARCHITECTURAL REFLECTED CEILING PLANS.

5. THESE DRAWINGS DO NOT INDICATE ALL MECHANICAL, PLUMBING, ELECTRICAL AND ARCHITECTURAL FEATURES. CONTRACTOR SHALL INCLUDE ALL NECESSARY COMPONENTS, ACCESSORIES AND FITTINGS AS REQUIRED TO PROVIDE A COMPLETE, OPERABLE AND CODE-COMPLIANT SYSTEM.

6. ALL WORK SHALL COMPLY WITH LOCAL CODES, STATE CODES AND AUTHORITY HAVING JURISDICTION.

7. FIRE PROTECTION PIPING SHALL BE SCHEDULE 40 BLACK STEEL THREADED FOR 2-1/2" AND SMALLER, AND SCHEDULE 10 BLACK STEEL WITH ROLL GROOVED FITTINGS FOR 3" AND LARGER.

8. ALL PIPING AND CONDUIT PENETRATIONS THRU RATED WALLS OR FLOORS SHALL BE PROVIDED WITH FIRE/SMOKE STOPPING.

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ALL NEW PIPING PENETRATIONS SHALL BE FINISHED WITH A FLOOR OR WALL PLATE AND PENETRATIONS
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CPL | Architecture Engineering Planning

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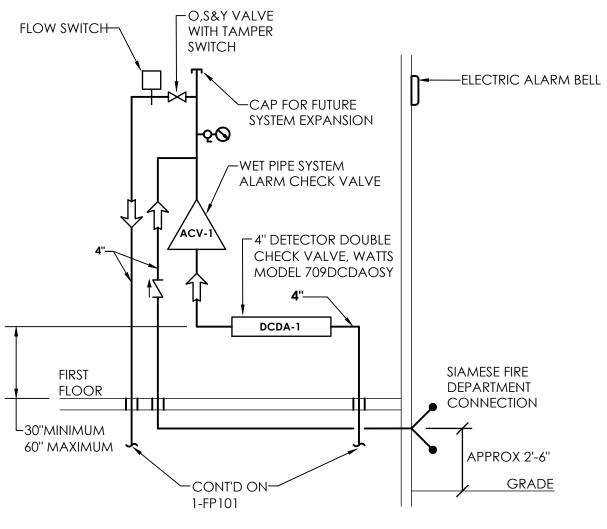
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| SHEET INFORMATION |
Issued	Scale
5/18/21	1/8" = 1'-0"
Drawn By	Checked By

FIRE PROTECTION BASEMENT AND FIRST FLOOR LEVELS

THRST TEOOR LEVELS






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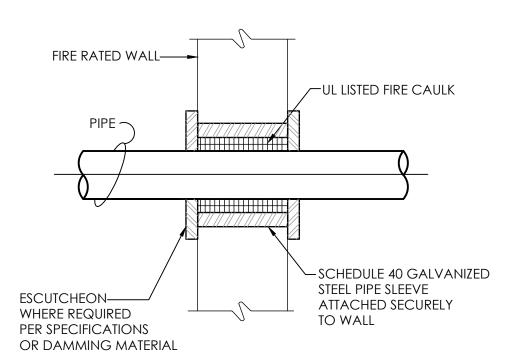


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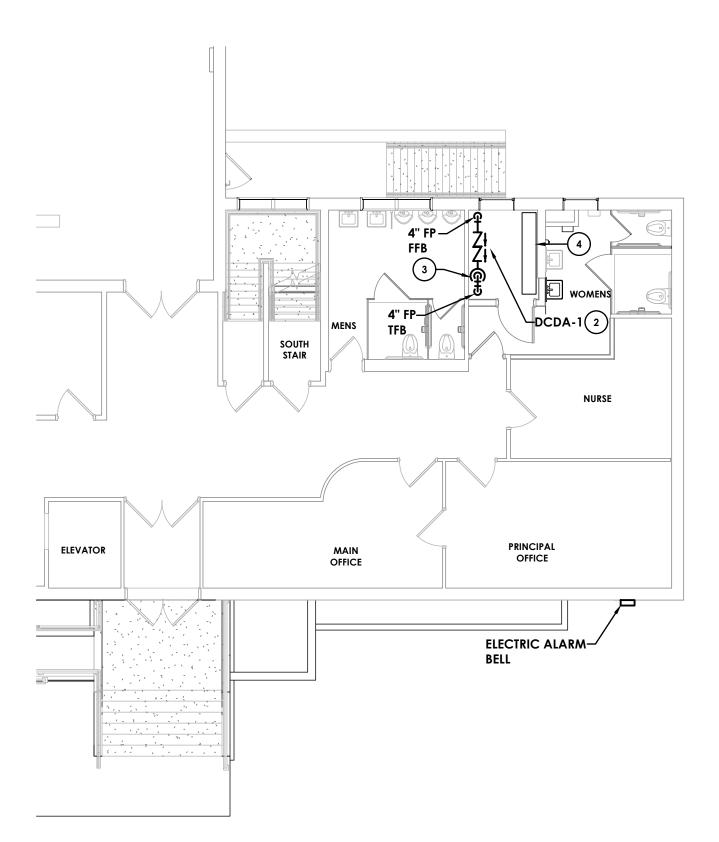
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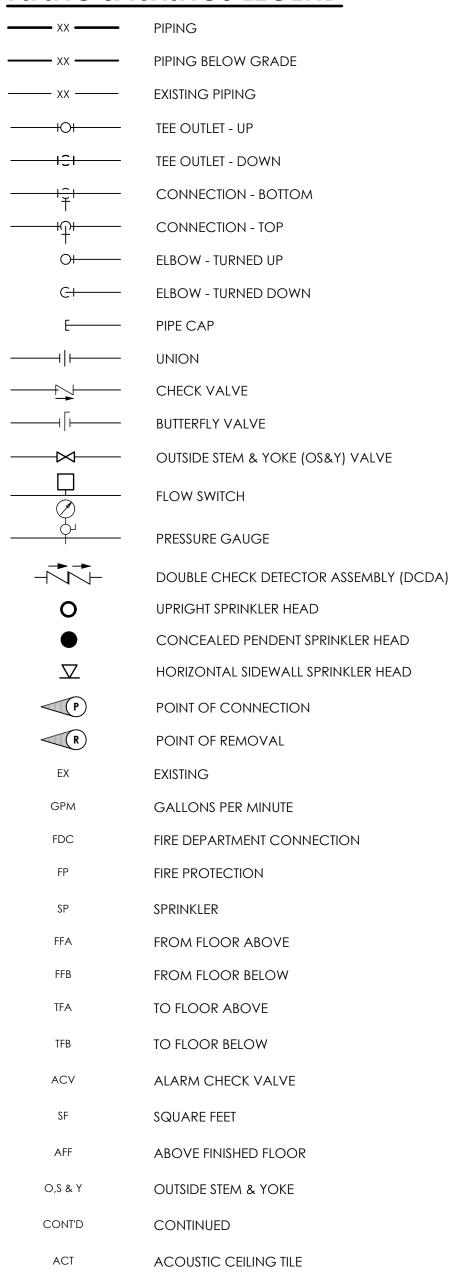




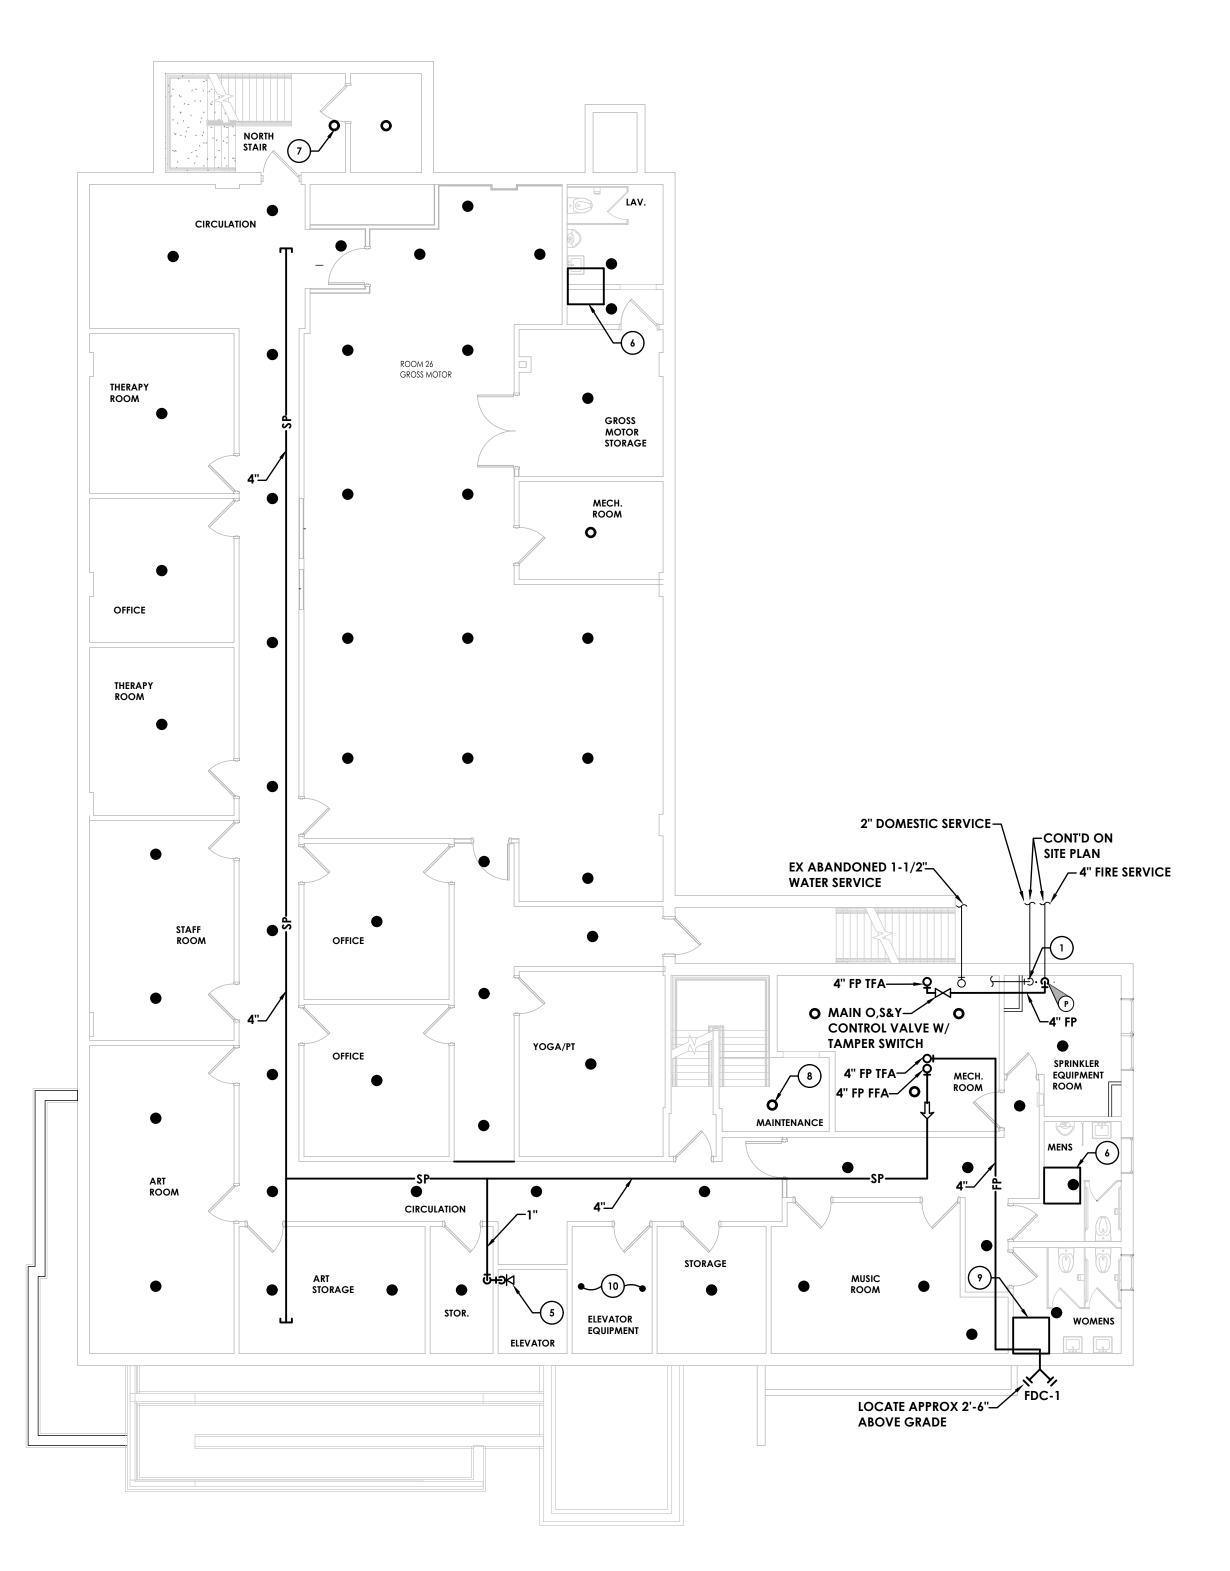



PIPING & FITTINGS LEGEND



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FIRE PROTECTION BASEMENT AND FIRST FLOOR LEVELS

THRST TEOOR LEVELS



PL2

LINING - 2 INCH THICK

SYMBOL

DESCRIPTION

SYMBOL

W/W ENCL.

WWHP

WATER-TO-WATER HEAT PUMP

WALL TO WALL FIN TUBE ENCLOSURE

DESCRIPTION

HVAC SYMBOLS LIST

SYMBOL

DESCRIPTION

REVISION SCHEDULE	DESCRIPTION
	BY
	CONI.
	DATE
	Ö

05/14/21 | PLD | EIL SCALE NOT TO SCALE HVAC SYMBOLS LEGEND AND CONTRACTOR NOTES

> PROJECT NUMBER 13321.00

> > DRAWING NUMBER

HVAC CONTRACTOR GENERAL NOTES:

DESCRIPTION

CURRENT TRANSDUCER

OPEN/CLOSED

ENABLE/DISABLE

FLOW TRANSMITTER

PRESSURE TRANSMITTER

DUCT SMOKE DETECTOR

SPACE TEMPERATURE SENSOR

SPACE NATURAL GAS SENSOR

SPACE SENSOR WITH GUARD

SPACE HUMIDISTAT

WATER FLOW SENSOR

PNEUMATIC ACTUATOR

ELECTRIC ACTUATOR

COOLING COIL

HEATING COIL

GAS FURNACE

HUMIDIFIER

ALARM

STATUS

FLOW SWITCH

PRESSURE GAUGE

ELECTRICAL INTERFACE

TRAVERSE AVERAGING SENSOR

SPEED FEED BACK

PROBE SENSOR

FREEZE STAT SENSOR

FREEZE-STAT

DO

~~

SPACE CARBON DIOXIDE SENSOR

SPACE CARBON MONOXIDE SENSOR

VARIABLE SPEED / FREQUENCY DRIVE

DIFFERENTIAL STATIC PRESSURE SWITCH

DIGITAL INPUT (TO BUILDING MANAGEMENT SYSTEM)

DIGITAL OUTPUT (FROM BUILDING MANAGEMENT SYSTEM)

ANALOG OUTPUT (FROM BUILDING MANAGEMENT SYSTEM)

ANALOG INPUT (TO BUILDING MANAGEMENT SYSTEM)

SPACE THERMOSTAT

START/STOP

ELECTRIC/PNEUMATIC SWITCH OR RELAY

PNEUMATIC/ELECTRIC SWITCH OR RELAY

TEMPERATURE SENSOR (DUCT OR PIPE MOUNTED)

HUMIDITY SENSOR (DUCT MOUNTED)


DIFFERENTIAL PRESSURE TRANSMITTER


ELECTRIC/PNEUMATIC TRANSDUCER


ELECTRIC/ELECTRONIC TRANSDUCER

- A. IT IS THE RESPONSIBILITY OF THE CONTRACTOR TO FIELD VERIFY EXISTING CONDITIONS WITHIN THE BUILDING PRIOR TO COMMENCEMENT OF ALL DEMOLITION AND NEW WORK.
- B. IT IS THE RESPONSIBILITY OF THE CONTRACTOR TO REMOVE AND REPLACE EXISTING CEILINGS, UNLESS OTHERWISE NOTED ON THE ARCHITECTURAL DRAWINGS, FOR PERFORMING DEMOLITION OR NEW WORK WITHIN THE BUILDING. THE EXISTING CEILINGS SHALL BE REMOVED IN A MANNER TO AVOID DAMAGE TO THE CEILING SYSTEMS. STORAGE OF CEILING SYSTEM COMPONENTS FOR REINSTALLATION IS THE RESPONSIBILITY OF THE CONTRACTOR. THE STORAGE OF ALL MATERIAL SHALL BE IN AREAS OR LOCATIONS APPROVED BY THE OWNER. THE OWNER WILL NOT COMPENSATE FOR ANY DAMAGED OR LOST MATERIAL WHILE IN STORAGE. AFTER COMPLETION OF ALL DEMOLITION OR NEW WORK, THE CONTRACTOR SHALL REINSTALL THE CEILING SYSTEMS TO MATCH THE ORIGINAL INSTALLATION.
- C. DEMOLITION DRAWINGS SHOW MAJOR EQUIPMENT, PIPING, AND DUCTWORK REMOVALS. THE INTENT IS NOT TO IDENTIFY ALL MISCELLANEOUS PIPING, PIPING ACCESSORIES, DUCTWORK, DUCTWORK ACCESSORIES, SUPPORTS, CONTROLS, CONTROL ACCESSORIES, CONTROL WIRING, CONDUIT, AND PNEUMATIC CONTROL TUBING TO BE DISCONNECTED AND REMOVED, BUT IS THE REQUIREMENT UNDER THIS CONTRACT. NO EQUIPMENT, PIPING, OR DUCTWORK SHALL BE ABANDONED IN PLACE, UNLESS OTHERWISE NOTED ON THE DRAWINGS.
- D. ALL EQUIPMENT INDICATED TO BE TURNED OVER TO THE OWNER SHALL BE DISCONNECTED AND REMOVED FROM THE EXISTING SYSTEMS AND DELIVERED (INCLUDING LOADING AND UNLOADING) TO A STORAGE AREA WITHIN THE BUILDING AS SELECTED BY THE OWNER. IT WILL BE THE RESPONSIBILITY OF THE CONTRACTOR TO REPAIR ANY EQUIPMENT DAMAGED DURING REMOVAL AND DELIVERY. ANY DAMAGE TO EQUIPMENT PRIOR TO DISCONNECTING SHOULD BE REPORTED TO THE OWNER'S REPRESENTATIVE. IF NOT REPORTED, THE CONTRACTOR TAKES FULL RESPONSIBILITY FOR REPAIRS TO THE EQUIPMENT.
- E. BEFORE DISCONNECTING, REMOVING, OR SERVICING ANY AIR CONDITIONING EQUIPMENT OR SYSTEMS CONTAINING REFRIGERANTS, THE EQUIPMENT OR SYSTEMS SHALL BE EVACUATED OF ALL REFRIGERANT PER THE LATEST ADOPTED RULES AND REGULATIONS BY THE UNITED STATES ENVIRONMENTAL PROTECTION AGENCY (EPA). THE CONTRACTOR OR TECHNICIAN PERFORMING THE WORK SHALL BE CERTIFIED BY AN EPA APPROVED CERTIFYING AGENCY OR ORGANIZATION.
- F. ALL DUCTWORK, AND CONDUIT PENETRATIONS THROUGH RATED WALLS OR FLOORS SHALL BE PROVIDED WITH FIRE/SMOKE STOPPINGS PER SPECIFICATION. REFER TO CODE ANALYSIS DRAWING FOR ALL RATED WALL LOCATIONS. ALL FLOORS SHALL BE CONSIDERED RATED.
- G. UNLESS SHOWN ON THE ARCHITECTURAL DRAWINGS, IT IS THE RESPONSIBILITY OF THIS CONTRACT TO PATCH AND FINISH ALL EXISTING DUCTWORK OR PIPE PENETRATIONS THROUGH FLOORS, ROOFS, INTERIOR WALLS, AND EXTERIOR WALLS AFTER DEMOLITION WORK. IN ADDITION, ALL NEW PENETRATIONS SHALL BE PROVIDED FOR INSTALLATION OF MECHANICAL SYSTEMS INCLUDING, BUT NOT LIMITED TO, EQUIPMENT, CURBING, DUCTWORK, PIPING, CONTROLS, ETC. PATCHING AND FINISHING SHALL MATCH EXISTING CONSTRUCTION INCLUDING FIRE RATINGS. PROVIDE LINTELS PER LINTEL SCHEDULE.

ICATION MATER	RIAL PAINT	TYPE DESIG	GN EQUIPMENT	SIZE (INCH)	NOISE MAX NC (RAD)	DEVVVDK
				SILL (IIICII)	NOISE MAX NC (KAD)	REMARKS
UPPLY ALUM	whi	TE	PRICE, SCDA	8 DIA	20	1
UPPLY ALUM	whi	TE	PRICE, SCDA	10 DIA	20	1
ETURN STEEL	L WH	TE	PRICE, PDDR	24x24	20	1
	·					
	UPPLY ALU/	UPPLY ALUM WHI	UPPLY ALUM WHITE	UPPLY ALUM WHITE PRICE, SCDA	UPPLY ALUM WHITE PRICE, SCDA 10 DIA	UPPLY ALUM WHITE PRICE, SCDA 10 DIA 20

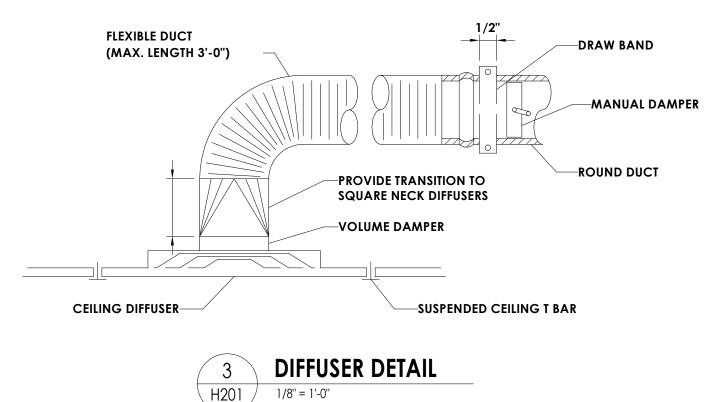

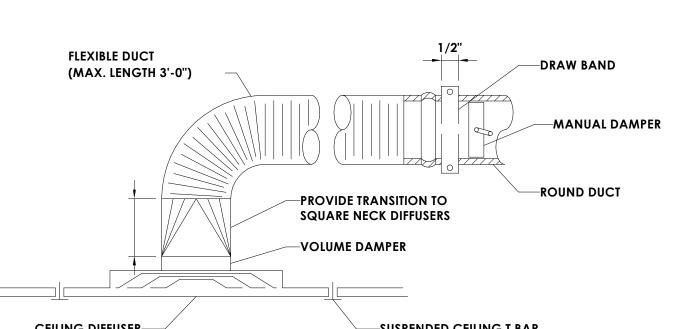

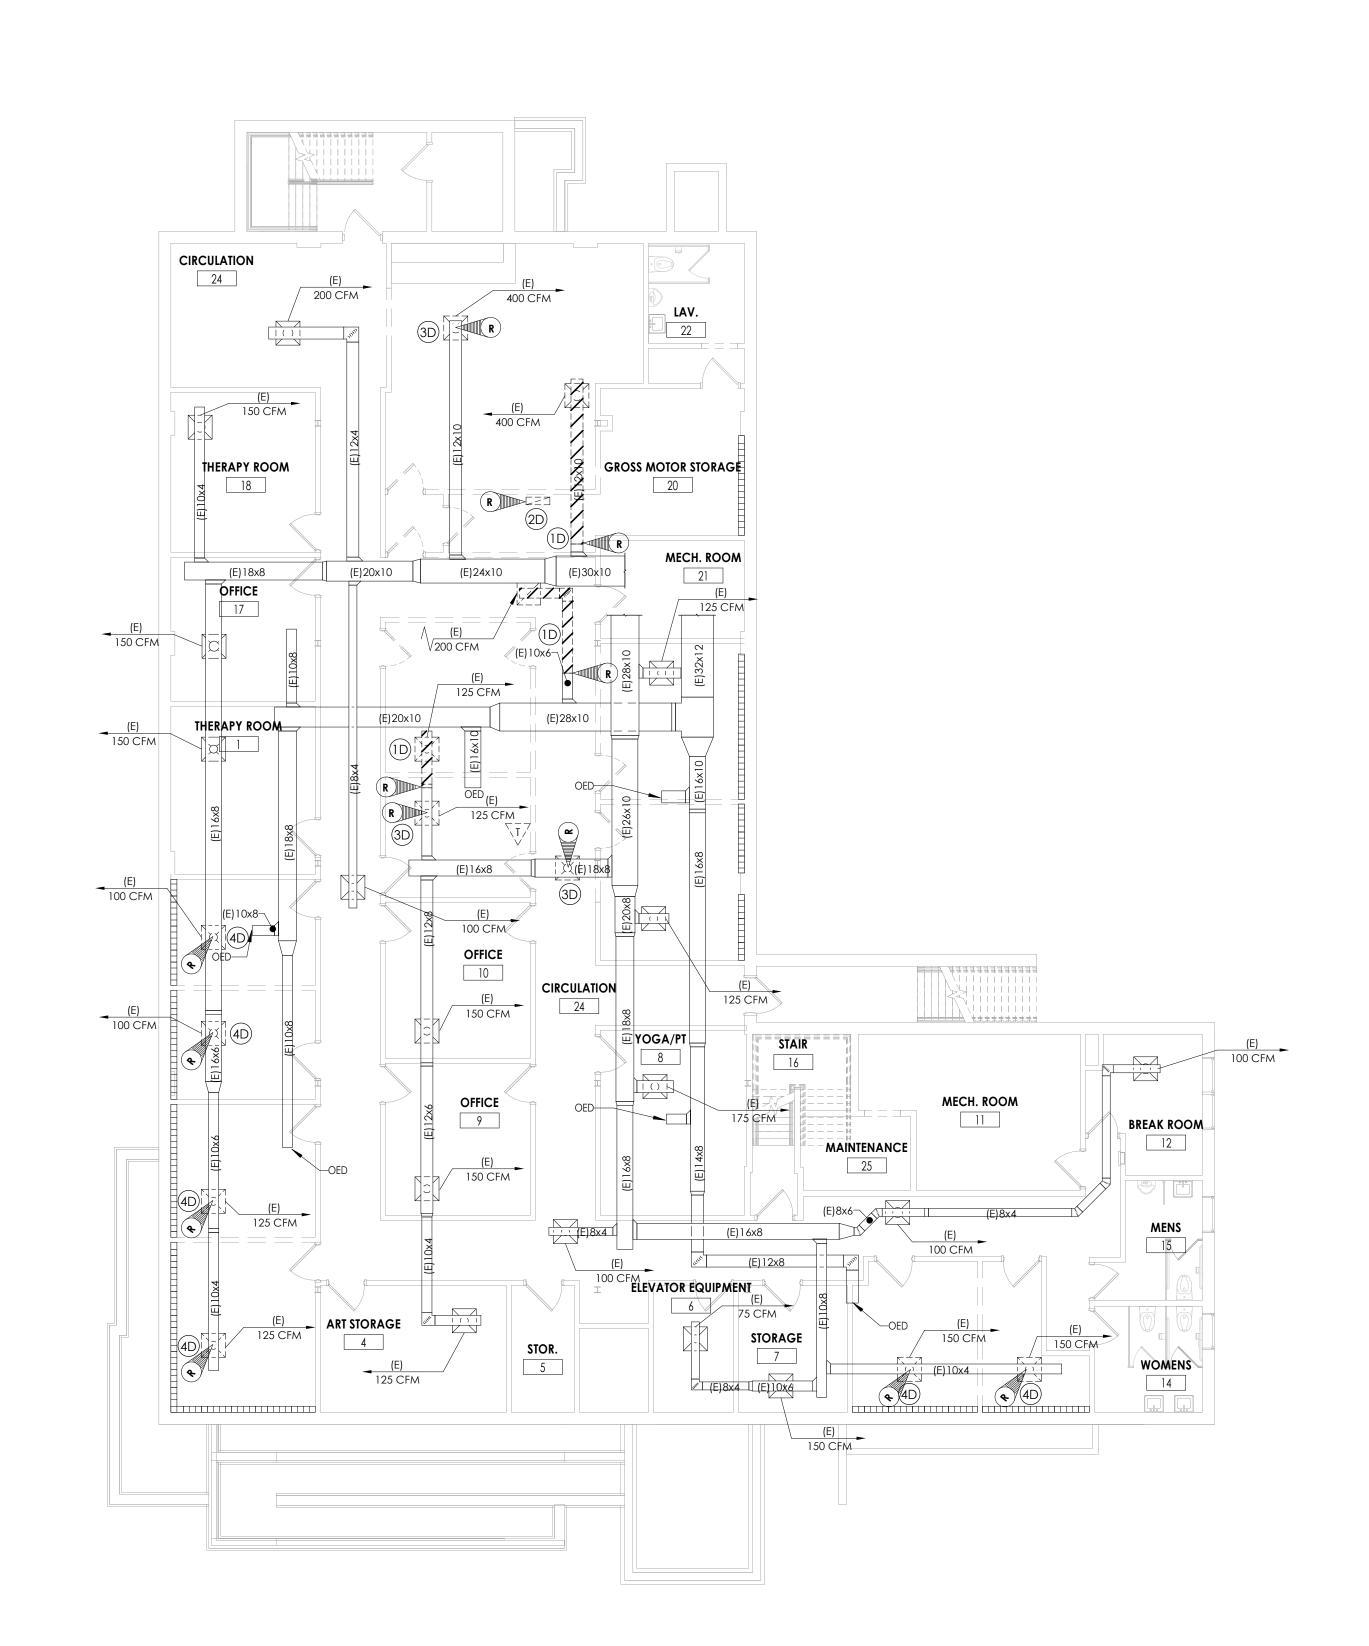

GENERAL NOTES - HVAC DEMOLITION

1. REFER TO DRAWING G/H000 FOR HVAC CONTRACTOR GENERAL CONDITIONS.

2. COORDINATE WITH BUILDING OWNER FOR ANY NECESSARY SHUT-DOWN OF

4. THE EXISTING BUILDING AUTOMATION CONTROL SYSTEM SHALL BE PROTECTED

COMPONENTS FOUND TO BE CONNECTED THAT MAY INTERFERE WITH THE WORK

REMOVE EXISTING SUPPLY/ RETURN DUCTWORK TO POINT SHOWN. PREPARE

REMOVE EXISTING SUPPLY DIFFUSER AND ASSOCIATED DUCTWORK BACK TO

POINT SHOWN. SEAL AND CAP THE EXISTING DUCTWORK BOTTOM

DISCONTECT EXISTING SUPPLY DIFFUSER AND PREPARE DUCTWORK FOR

OF THIS CONTRACT SHALL BE IDENTIFIED AND BROUGHT TO THE ARCHITECT'S

ATTENTION. NO CONTROL COMPONENTS SHALL BE REMOVED OR

DISCONNECTED WITHOUT THE CONSENT OF THE ARCHITECT.

DUCT WORK FOR RECONECTION IN NEW WORK.

KEY NOTES - HVAC DEMOLITION

REMOVE EXISTING TRANSFER GRILLE


RECONNECTION IN NEW WORK.

CONNECTION.

ON A CONTINUOUS BASIS. EXISTING CONTROL SYSTEM COMPONENTS I NCLUDING, BUT NOT LIMITED TO SENSORS, RELAYS, CONTROLLERS, ACTUATORS, AND CABLING SHALL REMAIN IN PLACE UNLESS OTHERWISE SPECIFIED. ANY

BUILDING SYSTEMS REQUIRED FOR DEMOLITION OR TIE-IN WORK.

3. COORDINATE DEMOLITION WORK WITH ALL OTHER TRADES.

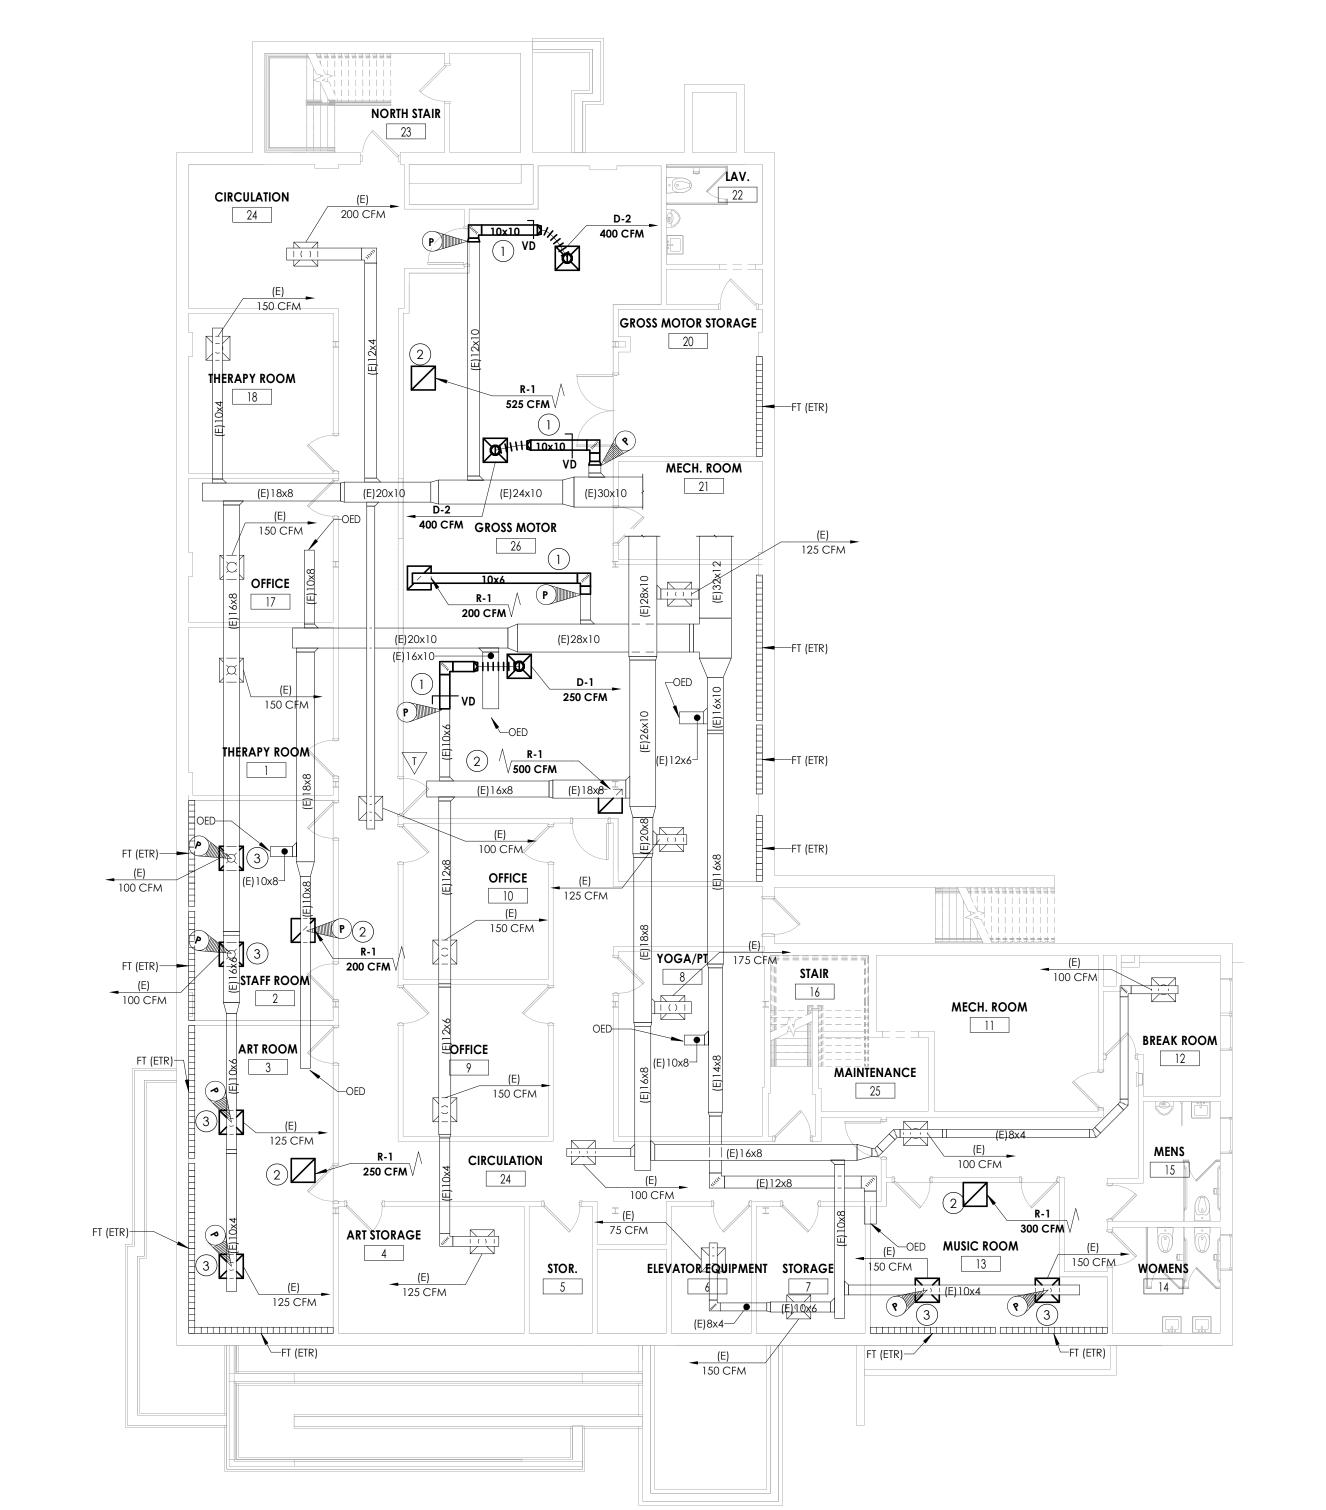





2. COORDINATE REGISTER, GRILLE, AND DIFFUSER LOCATIONS WITH CEILING GRID 3. ALL SUPPLY AIR, RETURN AIR, AND OUTSIDE AIR BRANCH DUCTS TO BE PROVIDED Clark Patterson Lee

26 Mississippi St., Suite 300 Buffalo, New York 14203 Tel: (800) 274-9000 Fax: (716) 852-2120 www.clarkpatterson.com

RECONNECT NEW SUPPLY AND RETURN DUCTWORK AS SHOWN, INCLUDING

GENERAL NOTES - HVAC NEW WORK

KEY NOTES - HVAC NEW WORK

COORDINATE WITH OTHER TRADES.

DIFFUSER IN NEW CEILING.

2) PROVIDE NEW RETURN GRILLE IN CEILING.

AND LIGHTS.

1. COORDINATE WITH BUILDING OWNER FOR ANY NECESSARY SHUT-DOWN OF

WITH VOLUME DAMPERS. RECTANGULAR VOLUME DAMPERS SHALL BE RUSKIN

5. UNLESS OTHERWISE DIRECTED, EXISTING BUILDING MANAGEMENT CONTROLS

DIFFUSERS, FITTINGS, HANGERS, AND OTHER NECESSARY ACCESSORIES.

RECONNECT EXISTING DIFFUSER TO THE EXISTING DUCTWORK. PLACE EXISTING

SHALL REMAIN AND BE PROTECTED DURING CONSTRUCTION

BUILDING SYSTEMS REQUIRED FOR DEMOLITION OR NEW WORK.

05/14/21 PLD EIL SCALE 1/8" = 1'-0"

BASEMENT FLOOR HVAC NEW WORK AND DEMOLITION PLAN

PROJECT NUMBER 13321.00

H201


WIRING LEGEND:

- - (NONE) SINGLE POLE TOGGLE SWITCH 2 TWO POLE TOGGLE SWITCH
 - 3 THREE WAY TOGGLE SWITCH 4 FOUR WAY TOGGLE SWITCH D DIMMER SWITCH
 - OCCUPANCY SENSOR SWITCH V VACANCY SENSOR SWITCH
 - DV COMBINATION DIMMER/VACANCY SENSOR SWITCH 3D THREE WAY DIMMER SWITCH
- LOWER CASE LETTER DESIGNATES SWITCH LEG
- SINGLE RECEPTACLE
- DUPLEX RECEPTACLE
- QUADRAPLEX RECEPTACLE
- SPECIAL RECEPTACLE
- GFI GROUND FAULT CIRCUIT INTERRUPTER
 - C COUNTER HEIGHT TR TAMPER RESISTANT, UL LISTED WP WEATHERPROOF
- BRANCH CIRCUIT HOME RUN WITH PANEL NAME AND CIRCUIT NUMBER, QUANTITY OF ARROWHEADS DENOTES QUANTITY OF BRANCH CIRCUITS
- GFI TYPE BREAKER A.F. BKR. ARC FAULT BREAKER
- BRANCH CIRCUIT WIRING, PROVIDE QUANTITIES OF CONDUCTORS REQUIRED FOR CIRCUITING AND SWITCHING AS INDICATED
- POWER LEG ONLY (NO SWITCH LEG BETWEEN ROOMS)

COMMUNICATIONS LEGEND:

- DATA DROP
 - (NONE) STANDARD MODULAR JACK FOR TELEPHONE W WALL MOUNTED TELEPHONE MODULAR JACK PUBLIC TELEPHONE MODULAR JACK C COUNTER HEIGHT MODULAR JACK
- CEILING MOUNTED WIRELESS ACCESS POINT
- DATA RACK
- SPEAKER (PUBLIC ADDRESS)
- (NONE) CEILING MOUNTED W WALL MOUNTED

LIGHT FIXTURE LEGEND:

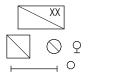

LIGHTING FIXTURE (SEE LUMINAIRE SCHEDULE FOR LETTER DESIGNATION AND DESCRIPTION OF FIXTURES)



EMERGENCY AND/OR NIGHT LIGHT LIGHTING FIXTURE

- EXIT LIGHTING FIXTURE UNIVERSAL MOUNT, SINGLE/DOUBLE FACE (WHERE USED, ARROW INDICATES CHEVRON DIRECTION)
- BATTERY POWERED EMERGENCY LIGHT
 - VACANCY SENSOR CEILING MOUNTED
 - OCCUPANCY SENSOR CEILING MOUNTED

- **FIRE/LIFE SAFETY LEGEND:**

 - FIRE ALARM PULL STATION
 - FIRE ALARM HORN AND STROBE COMBINATION FIRE ALARM SPEAKER AND STROBE COMBINATION
 - FIRE ALARM STROBE
 - FIRE ALARM BELL
 - SMOKE DETECTOR
 - CARBON MONOXIDE DETECTOR
 - HEAT DETECTOR FLOW SWITCH

PANEL LEGEND:

TAMPER SWITCH

- EXISTING ELECTRICAL PANEL
- ELECTRICAL SYSTEMS PANEL FACP FIRE ALARM CONTROL PANEL


17.0	TINE ALAMAT COMMOLITATE
PA	PUBLIC ADDRESS CONTROL PANEL
FAAP	FIRE ALARM ANNUNCIATOR PANEL

	LUMINAIRE SCHEDULE								
TYPE	DESCRIPTION	MANUFACTURER	MODEL	VOLTS	LOAD	TYPE/CCT	LUMENS	MOUNTING	COMMENTS
				120 V	0 VA		0		
EM	WALL MOUNT LED EMERGENCY LIGHT WITH BATTERY BACK-UP	COMPASS	CU2\$Q2D	120 V	3 VA	LED	1000	WALL - SURFACE	
L1	2X2' RECESSED LED TROFER W/ 0-10V DIMMING	COLUMBIA	LCAT22-3SHLG-EDU	120 V	32 VA	3500K LED	3707	GRID-RECESSED	
L1/E	2X2' RECESSED LED TROFER W/ 0-10V DIMMING WITH EMERGENCY BATTERY BACK-UP	COLUMBIA	LCA22-3SHLG-EDU-ELL14	120 V	32 VA	3500K LED	3707	GRID-RECESSED	
L2	1X4' LINEAR WRAPAROUND LED W/ EMERGENCY BATTERY BACK-UP	COLUMBIA	LAW4-35LW-EDU-ELL14	120 V	24 VA	3500K LED	2644	CEILING-SURFACE	1
X1	LED EXIT SIGN WITH RED LETTERS AND BATTERY BACK-UP	DUAL-LITE	EVE-U-R-W-E-1	120 V	3 VA	LED	200	CEILING	1
X2	DOUBLE SIDED LED EXIT SIGN WITH RED LETTERS AND BATTERY	DUAL-LITE	EVE-U-R-W-E-1	120 V	3 VA	LED	200	CEILING	1

1. FIXTURE SHALL BE CAPABLE OF PROVIDING A MINIMUM OF 90 MINUTES OF ILLUMINATION DURING POWER LOSS.



BASEMENT LIGHTING PLAN

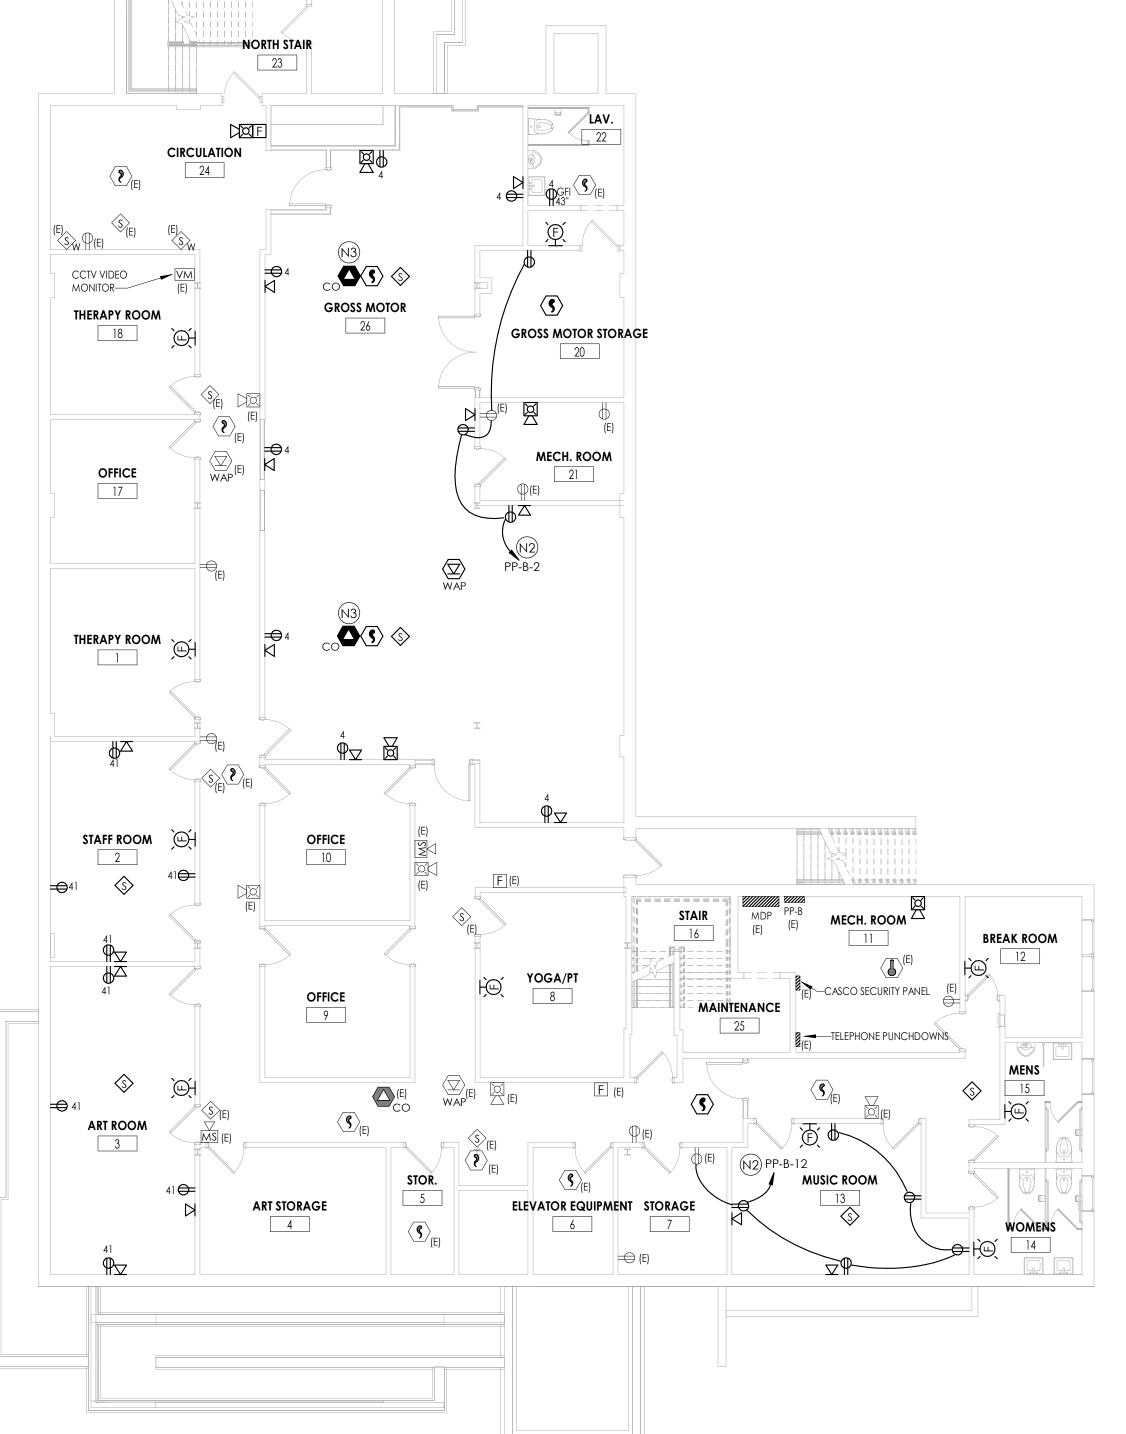

BASEMENT POWER AND SYSTEMS PLAN

DEMOLITION KEY NOTES NEW WORK GENERAL NOTES (D1) EXISTING LIGHT FIXTURE TO BE RELOCATED. DISCONNECT AND SALVAGE FIXTURE FOR RE-INSTALLATION. EXISTING CIRCUITING TO REMAIN AND BE

EXTENDED TO NEW LOCATION.

NEW WORK KEY NOTES

WITH (2)#12, #12G IN 3/4" CONDUIT.

WITH (2)#12, #12G IN 3/4" CONDUIT.

(D2) DISCONNECT AND REMOVE EXISTING LIGHT FIXTURES IN SPACE. EXISTING

(N1) RE-INSTALL SALVAGED FIXTURE AND CONNECT TO NEW SWITCH IN SPACE.

(N3) PROVIDE NEW 120V CARBON MONOXIDE DETECTOR AND CONNECT TO

(N4) CONNECT NEW LIGHT FIXTURES IN SPACE TO EXISTING LIGHTING CIRCUIT THAT

(N.5) CONNECT EXISTING LIGHT FIXTURES TO NEW LIGHTING CIRCUIT AS INDICATED

SERVED PREVIOUS FIXTURE LAYOUT. REWORK/EXTEND WIRING AND CONDUIT

REWORK/EXTEND EXISTING BRANCH CIRCUIT TO NEW FIXTURE LOCATION AS

LIGHTING CIRCUIT TO REMAIN TO SERVE NEW FIXTURE LAYOUT.

- A. (E)-EXISTING TO REMAIN. ANY DEVICE, AS WELL AS ITS' ASSOCIATED CIRCUITING AND CONDUIT, LABELED "(E)" SHALL REMAIN, UNLESS OTHERWISE NOTED.
- B. FOR ALL WALL MOUNT VOICE/DATA DROPS SHOWN, PROVIDE FLUSH MOUNT 2-GANG BOX WITH SINGLE GANG DEVICE RING. PROVIDE (2) CATEGORY 6 UTP CABLES IN 3/4" CONDUIT ABOVE FINISHED CEILING SPACE TO DATA RACK ON FIRST FLOOR. PROVIDE ASSOCIATED 2-PORT FACEPLATE, BRACKETS, (2) RJ45 JACKS, ETC. AT DROP LOCATION.
- NEW FIRE ALARM DEVICES SHOWN SHALL BE COMPATIBLE WITH AND CONNECTED TO FIRE ALARM CONTROL PANEL SYSTEM SERVING BUILDING. CONTRACTOR SHALL BE RESPONSIBLE FOR ALL ASSOCIATED TERMINATIONS, PROGRAMMING, TESTING, ADDITIONAL NOTIFICATION APPLIANCE CIRCUIT (NAC) PANELS, 120V
- POWER TO ALL NAC PANELS, ETC. FOR A COMPLETE OPERATIONAL SYSTEM. ALL NEW RECEPTACLES SHOWN SHALL BE TAMPER RESISTANT.
- E. ALL NEW CABLING ABOVE CEILING SHALL BE PLENUM RATED.
- . REFER TO LUMINAIRE SCHEDULE ON THIS SHEET FOR FIXTURE TYPE MARK DESCRITPIONS, NOTES, AND SPECIFICATIONS.
- (2)#10, #10G IN 3/4" CONDUIT TO EXISTING DEDICATED CIRCUIT #25 IN PANEL "PP-B". FIXTURES SHALL NOT BE CONNECTED TO ANY LOCAL LIGHTING SWITCHING/CONTROLS IN SPACE.
- . CONNECT NEW 120V DEVICES/FIXTURES TO A 20/1 CIRCUIT BREAKER IN PANEL "PP-B" WITH (2)#12, #12G IN 3/4" CONDUIT, UNLESS NOTED OTHERWISE. (N2) CONNECT NEW RECEPTACLES TO EXISTING RECEPTACLE CIRCUIT AS INDICATED

G. CONNECT NEW EXIT SIGNS AND WALL MOUNT TYPE "EM" FIXTURES TOGETHER WITH

NEW CEILING SPEAKERS SHALL BE 8" FLUSH MOUNT ROUND SPEAKERS THAT ARE COMPATIBLE WITH AND CONNECTED TO EXISTING BUILDING PUBLIC ADDRESS SYSTEM. EXISTING PUBLIC ADRESS SYSTEM AUDIO AMPLIFIER IS BOGEN CLASSIC EXISTING CO DETECTOR CIRCUIT #31 IN PANEL "PP-B" WITH (2)#12, #12G IN 3/4" SERIES MODEL C-35 AND IS LOCATED IN FIRST FLOOR MECH ROOM 32. PROVIDE ALL CABLING, TERMINATIONS AND FINAL TESTING IS REQUIRED.

GENERAL DEMOLITION NOTES


- A. ALL ITEMS SHOWN ARE TO BE REMOVED UNLESS LABELED AS (E) EXISTING. REMOVAL OF DEVICE INCLUDES ITS ASSOCIATED CABLING/BRANCH CIRCUIT
- WIRING, AND RACEWAY.


B. ANY EXISTING DEVICE TO REMAIN, LABELED AS (E) SHALL REMAIN IN PLACE AS

EXISTING MAY BE REQUIRED AT NEW OPENINGS IN EXISTING CONSTRUCTION OR

INTERFERENCE WITH OTHER NEW WORK AS NOTED IN THE FOLLOWING NOTES.

- WELL AS ITS' ASSOCIATED CIRCUITING AND CONDUIT, UNLESS OTHERWISE NOTED. C. THE CONTRACTOR SHALL REMOVE THE EXISTING ELECTRIC IN AREAS OF NEW RENOVATIONS TO ACCOMMODATE NEW CONSTRUCTION. REROUTING OF
- D. DRAWINGS INDICATE SPECIFIC ITEMS TO BE REMOVED AND/OR RELOCATED IN ORDER TO INDICATE GENERAL SCOPE. ADDITIONAL ITEMS NOT INDICATED, BUT
- NECESSARY FOR PROJECT RENOVATIONS, SHALL BE REMOVED, RELOCATED AND/OR REROUTED. . WHERE DEVICES, FIXTURES, ETC. ARE INDICATED TO BE REMOVED, THEY AND THEIR
- RELATED WIRING/CONDUIT SHALL BE REMOVED BACK TO THE SOURCE PANELBOARD UNLESS OTHERWISE NOTED. ON CIRCUITS WHERE OTHER DEVICES, FIXTURES, ETC. ARE FOUND THAT MUST REMAIN, MAINTAIN CIRCUIT CONTINUITY BY PROVIDING ADDITIONAL WIRING, TO FEED THROUGH TO THESE REMAINING ITEMS. RELOCATE ANY CIRCUITS THAT REMAIN, TO AVOID CONFLICT WITH NEW CONSTRUCTION AS REQUIRED. PROPERLY TERMINATE ALL WIRING.
- COORDINATE DEMOLITION OF EQUIPMENT, DEVICES, ETC. WITH OTHER DISCIPLINES AS APPLICABLE. REFER TO ARCHITECTURAL DEMOLITION DRAWINGS AND NOTES FOR COORDINATION.
- G. DRAWINGS ARE GRAPHICAL REPRESENTATIONS OF APPROXIMATE EQUIPMENT AND DEVICE LOCATIONS. CONTRACTOR SHALL VISIT THE SITE TO DETERMINE THE EXACT EXTENT OF ELECTRICAL WORK REQUIRED TO COMPLETE THE PROJECT. EXISTING CONDITIONS ARE TAKEN FROM FIELD OBSERVATION AND EXISTING BUILDING DOCUMENTS. OTHER ELECTRICAL ITEMS MAY EXIST FOR WHICH THE CONTRACTOR IS RESPONSIBLE.
- H. CONTRACTOR SHALL PROPERLY DISPOSE OF ALL ITEMS, EQUIPMENT, PANELS, LIGHT FIXTURES, ETC. BEING REMOVED AS PART OF THIS PROJECT. THE OWNER SHALL HAVE THE RIGHT OF RETAINING ANY ITEMS BEING REMOVED.
- CONTRACTOR SHALL PROVIDE NEW COVERPLATES ON ALL BOXES OF UNUSED
- FIREPROOFING AND/OR FIRE STOP MATERIALS REMOVED FROM FIRE RATED WALLS AND CEILINGS AS A RESULT OF DEMOLITION SHALL BE RE-INSTALLED USING AN

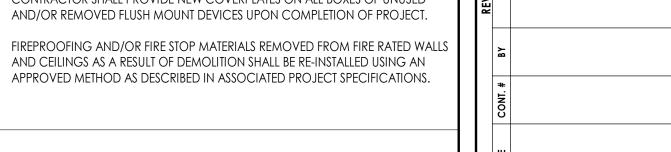

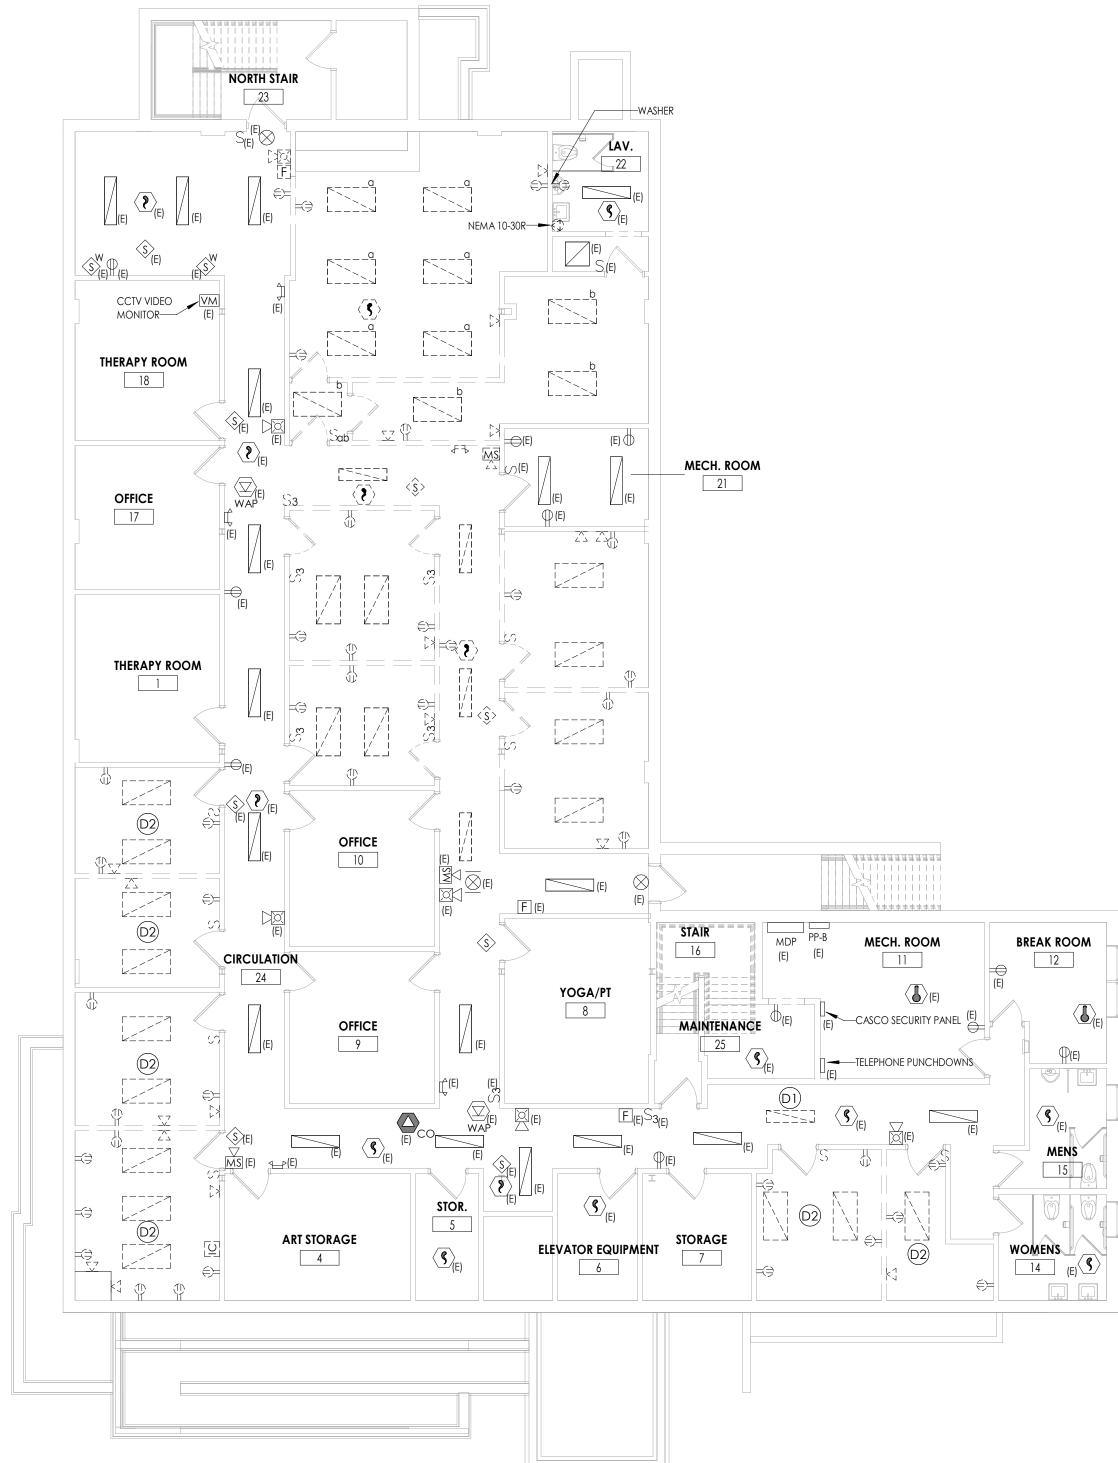

BASEMENT FLOOR - ELECTRICAL DEMOLITION PLAN

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MN ARM


SCALE As indicated

BASEMENT ELECTRICAL PLANS

13321.00

E200

DRAWING NUMBER

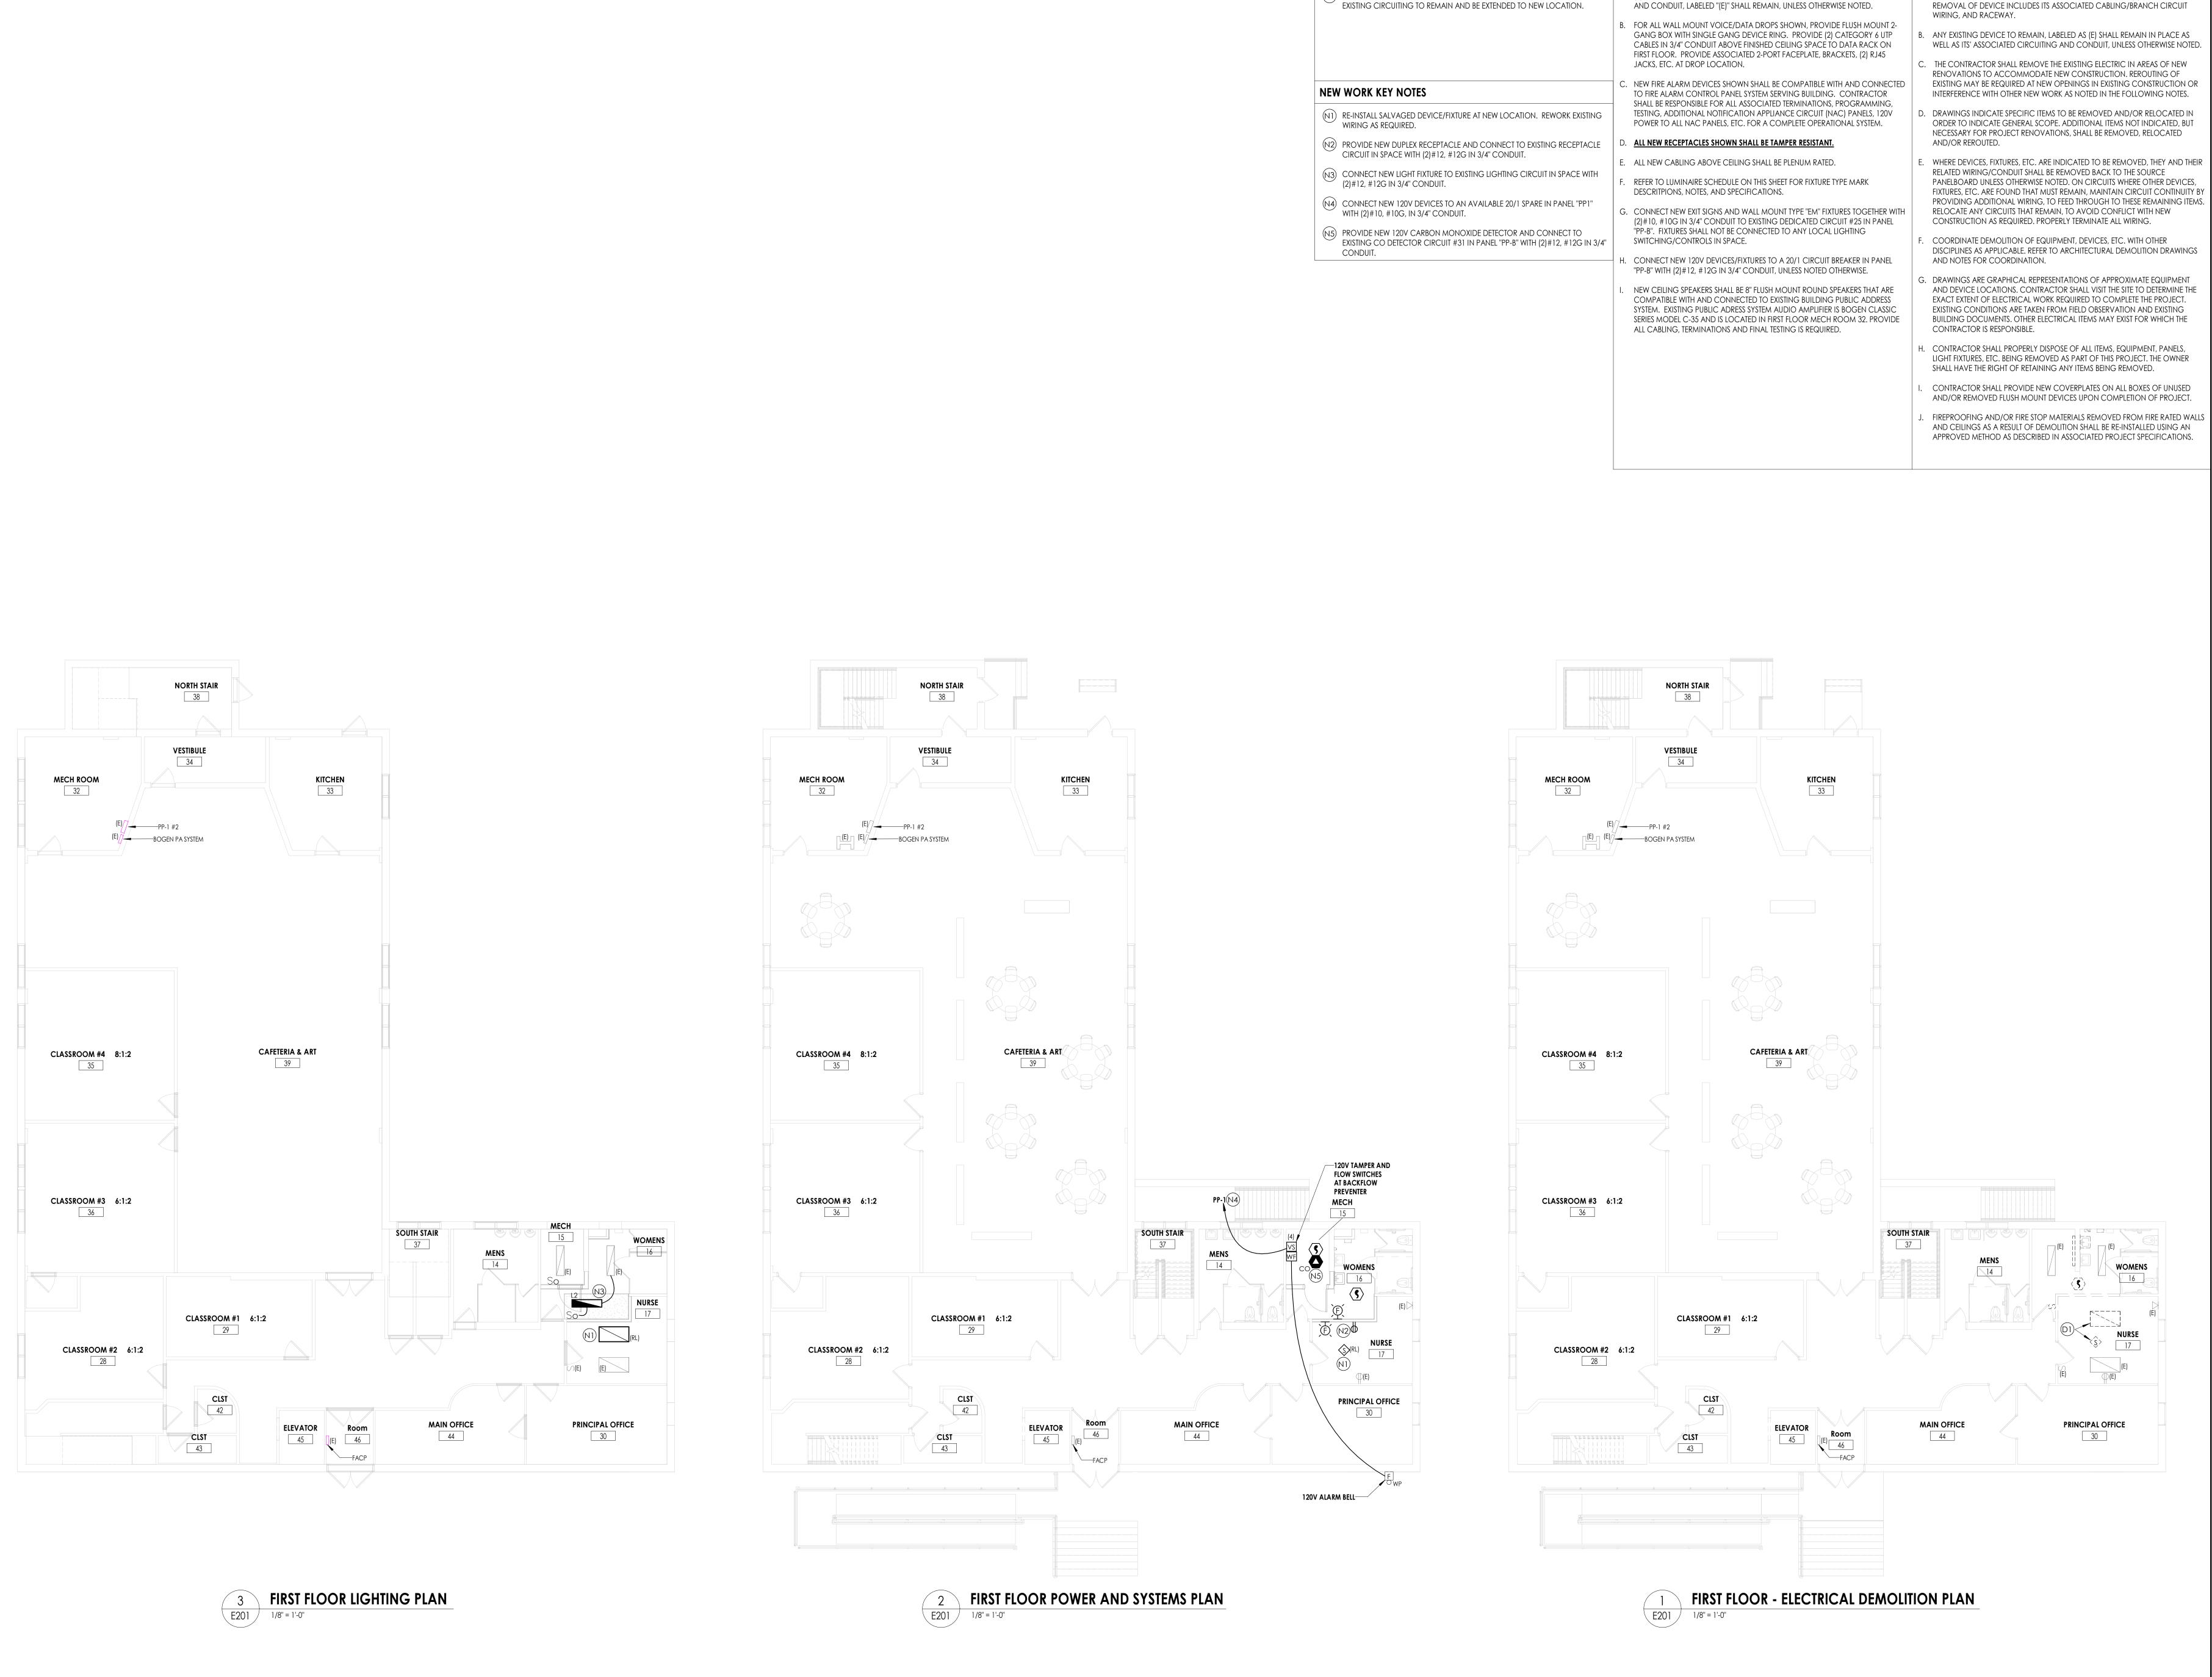

DEMOLITION KEY NOTES

(D1) DISCONNECT AND REMOVE EXISTING DEVICE/FIXTURE TO BE RELOCATED.

GENERAL DEMOLITION NOTES

NEW WORK GENERAL NOTES

A. ALL ITEMS SHOWN ARE TO BE REMOVED UNLESS LABELED AS (E) EXISTING. . (E)-EXISTING TO REMAIN. ANY DEVICE, AS WELL AS ITS' ASSOCIATED CIRCUITING REMOVAL OF DEVICE INCLUDES ITS ASSOCIATED CABLING/BRANCH CIRCUIT

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DATE DRAWN CHECKED 02/05/21 MN ARM scale AS NOTED FIRST FLOOR ELECTRICAL

13321.00 OLV E201