Office & Warehouse Buildings

9074 Main Street Clarence, New York SITE DEVELOPMENT DRAWINGS

AGENCIES

ENGINEERING DEPARTMENT

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COMPANY/DEPT: TOWN OF CLARENCE ENGINEERING DEPARTMENT

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NATURAL GAS
COMPANY/DEPT:.

NATIONAL FUEL GAS CORP. 6363 MAIN STREET WILLIAMSVILLE, NEW YORK 14221

TELEPHONE 716-857-7000

TELEPHONE COMPANY

COMPANY/DEPT:

VERIZON
65 FRANKLIN STREET
BUFFALO, NEW YORK 14203

TELEPHONE 716-840-8748

CABLE COMPANY COMPANY/DEPT:

COMPANY/DEPT: TIME WARNER
ADDRESS: 789 CHURCH ROAD
WEST SENECA, NEW YORK

TELEPHONE 716-558-8615

ELECTRIC COMPANY COMPANY/DEPT: ADDRESS:

NATIONAL GRID 144 KENSINGTON AVENUE BUFFALO, NEW YORK 14214

TELEPHONE 716-236-2738

WATER
COMPANY/DEPT:.
ADDRESS:

ERIE COUNTY WATER AUTHORITY 3030 UNION ROAD CHEEKTOWAGA, NEW YORK 14227

TELEPHONE 716-684-1510

DIG SAFELY NEW YORK

TELEPHONE 1-800-962-7962

OWNER/DEVELOPER

NAME: CORTESE CONSTRUCTION SERVICES CORP.

ADDRESS 2300 GEORGE URBAN BLVD DEPEW, NEW YORK 14043

CONTACT: DOMENIC CORTESE

TELEPHONE 716-683-2100

ENGINEER



Carmina • Wood • Morris DPC

487 Main Street Suite 600 Buffalo, New York 14203 P 716.842.3165 F 716.842.0263 LOCATION MAP

Monkey See, Monkey

Core Concepts

Pilates and Wellness

o...Children's Bookstore

ighes CPA

SITE

LOCATION

Clarence Community S


Clarence Hollow Jewelers Natale B


DWG NO.	DRAWING TITLE
- C-001 C-002 C-100 C-101 C-200 C-300 C-301 C-400 C-401 C-402 L-100 LP-100 M-100	COVER SHEET SURVEY & TOPOGRAPHIC MAP DEMOLITION & EROSION CONTROL PLAN DEMOLITION & EROSION CONTROL DETAILS SITE PLAN SITE DETAILS GRADING PLAN STORM DRAINAGE PLAN STORM DRAINAGE DETAILS UTILITY PLAN UTILITY DETAILS LANDSCAPING PLAN LIGHTING PLAN MAINTENANCE & PROTECTION OF TRAFFIC PLAN

AUGUST 2019

Office & Warehouse Buildings

9074 Main Street
Clarence, New York
SITE DEVELOPMENT DRAWINGS

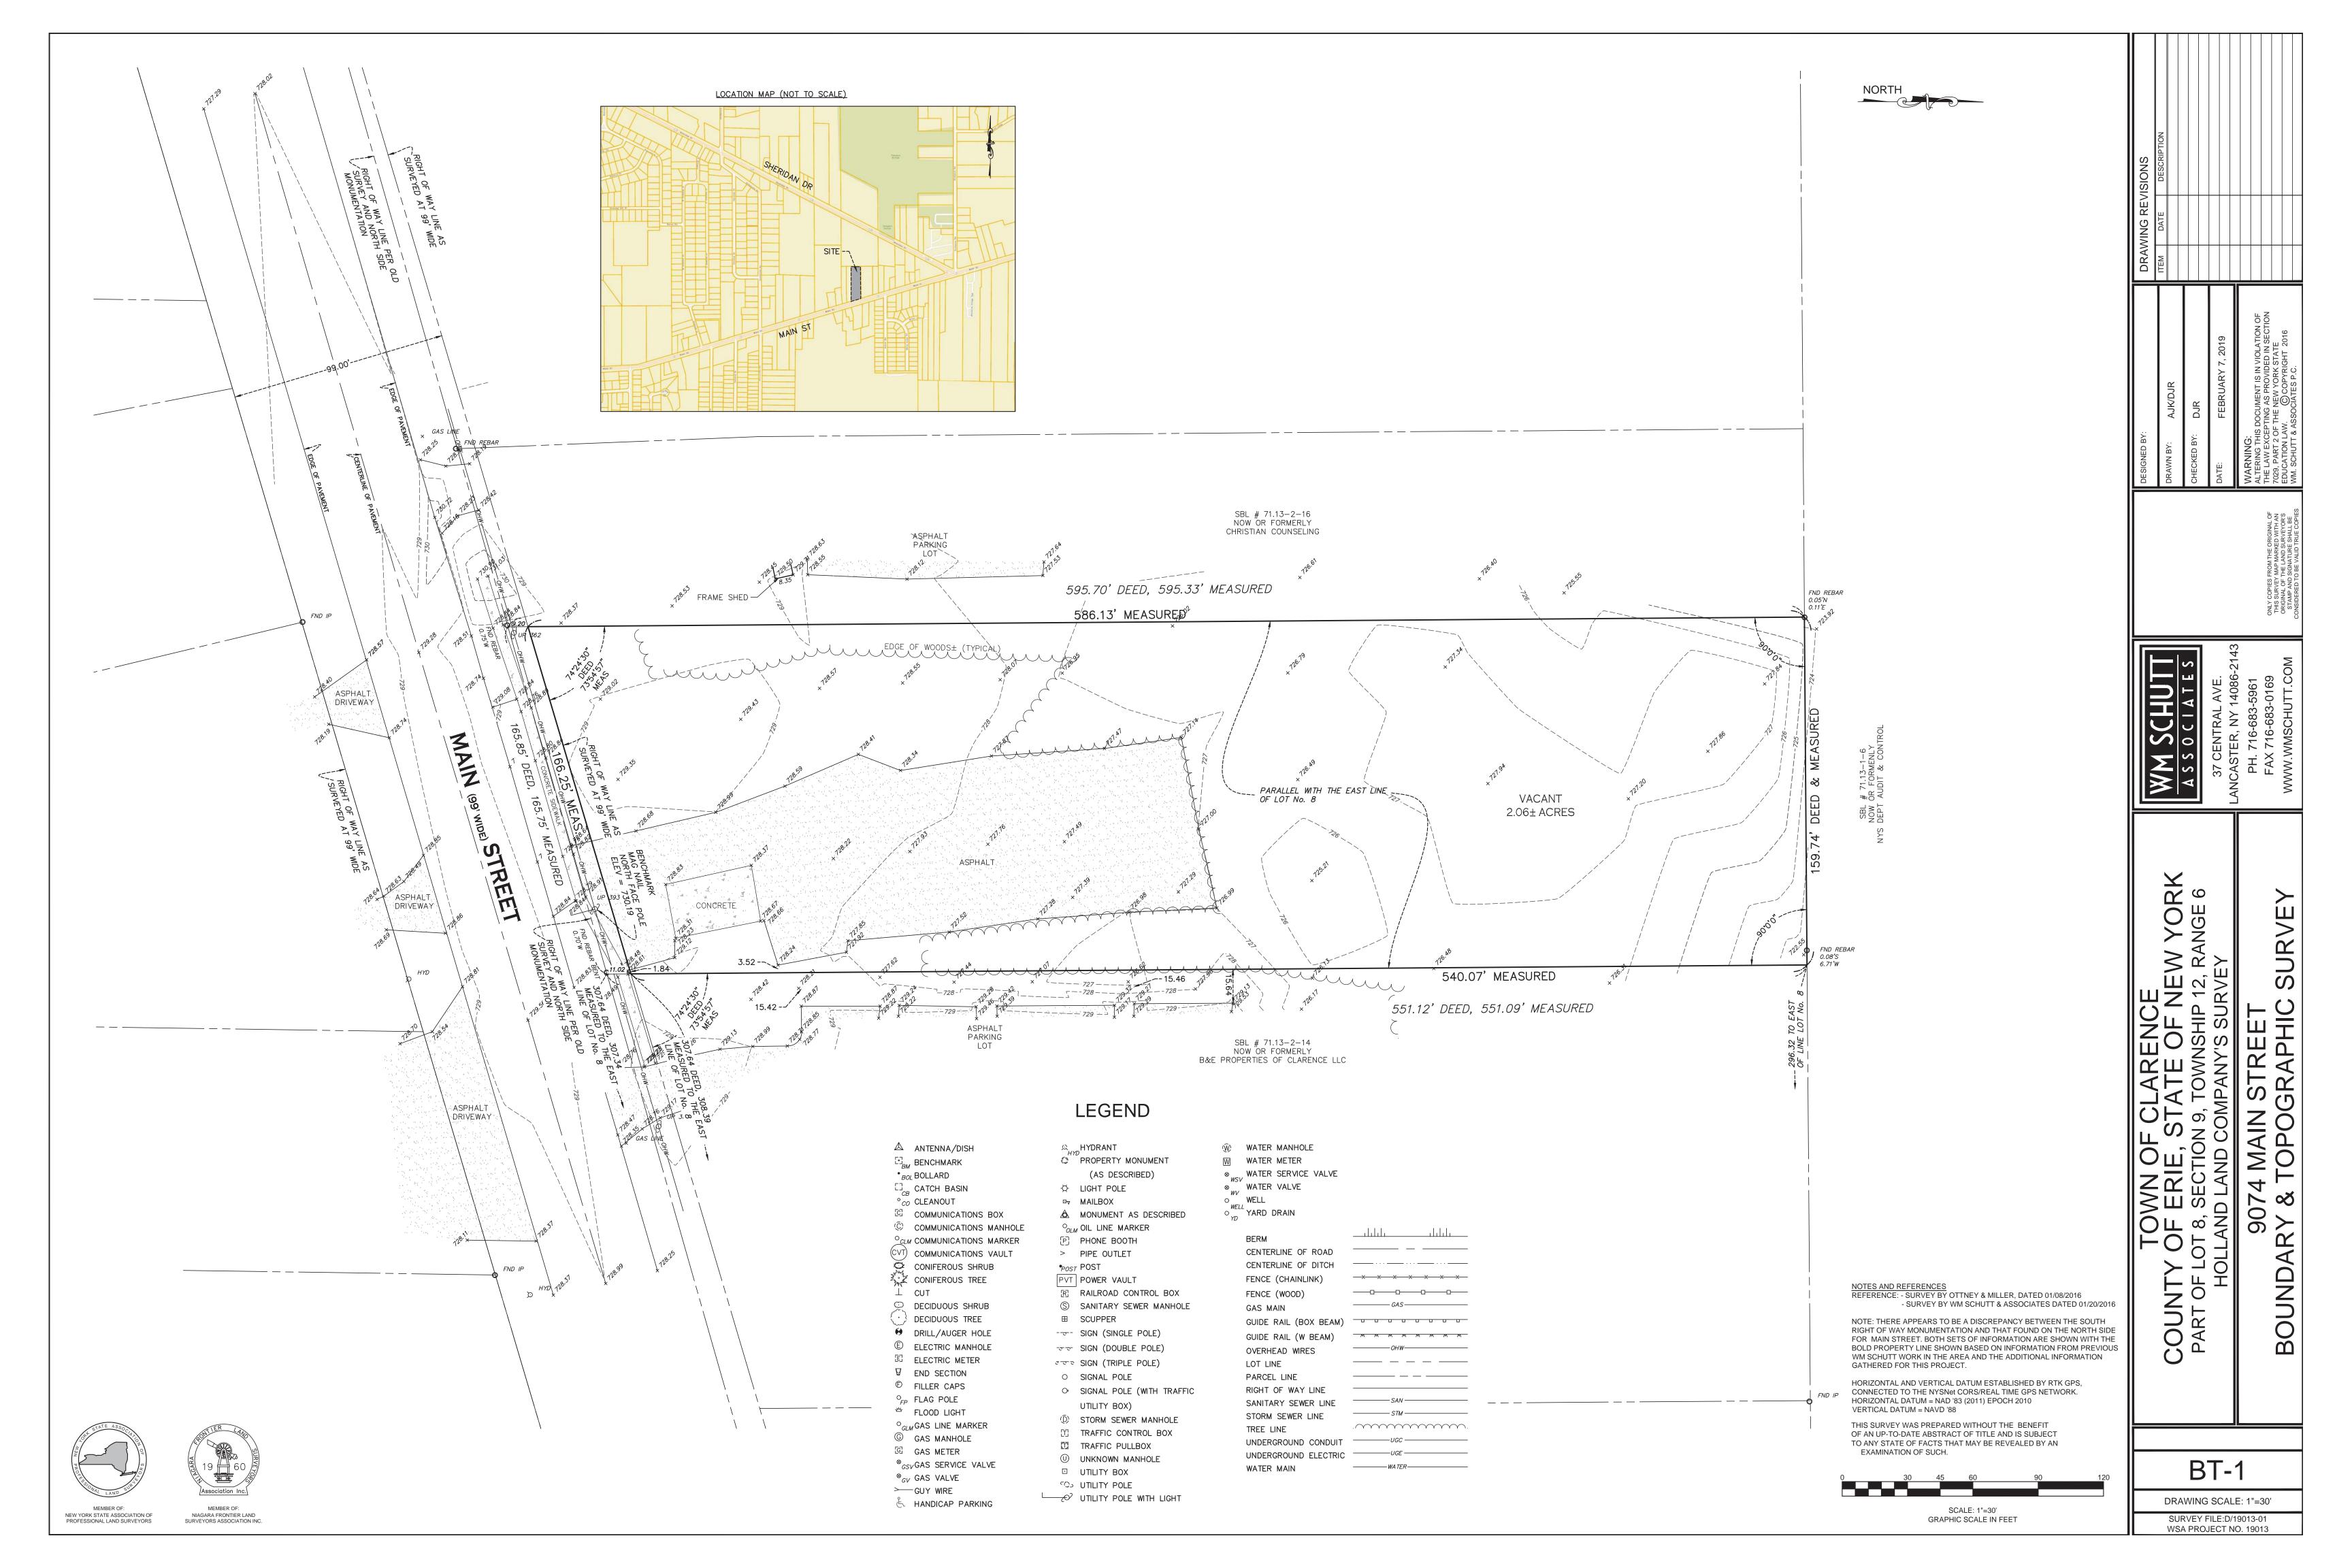

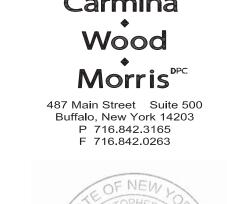



WHERE ACCESSING THE SITE FROM PAVED ROADWAYS. STORM DRAINAGE

PROTECTED WITH SILT SACK AND OTHER PROPER TEMPORARY INLET PROTECTION MEASURES. 4. AS NECESSARY, CONTRACTOR SHALL INSTALL TEMPORARY TRAFFIC

1. CONTRACTOR SHALL TAKE PRECAUTIONS TO PROTECT THOSE ITEMS TO

REMAIN, SUCH AS TREES, PROPERTY CORNER PINS, UTILITY POLES,

2. TEMPORARY SILT FENCE/SILT SOCK TO BE INSTALLED AS DIRECTED BY THE OWNERS FIELD REPRESENTATIVE. MAINTAIN UNTIL VEGETATION IS

3. CONTRACTOR SHALL INSTALL STABILIZED CONSTRUCTION ENTRANCE

INLETS THAT INTERFERE WITH CONSTRUCTION ENTRANCE TO BE

VALVES, HYDRANTS, CURBS, MANHOLES OR CATCH BASINS.

ESTABLISHED AND PAVEMENT IS INSTALLED.

CONTROL DEVICES IN ACCORDANCE WITH NYS M.U.T.C.D. STANDARDS PRIOR TO STARTING WORK.

5. AS NECESSARY, COVERED DUMPSTERS SHALL BE PROVIDED ONSITE AS REQUIRED FOR CONSTRUCTION WASTE.

EROSION CONTROL NOTES

THE FOLLOWING EROSION CONTROL PROCEDURES SHALL BE ADHERED TO BY THE CONTRACTOR:

DEMOLITION NOTES:

- 1. INSTALL TEMPORARY SILT FENCE/SILT SOCK BARRIERS AS DIRECTED BY THE OWNER AND AT ALL EXISTING STORMWATER CATCH BASINS WITHIN THE WORK AREA TO PREVENT SEDIMENT MIGRATION. ALL SILT FENCE/SILT SOCK BARRIERS SHALL BE INSTALLED IN ACCORDANCE WITH THE DETAILS SHOWN ON
- 2. TOPSOIL SHALL BE STRIPPED AND STOCKPILED ON SITE FOR RE-USE AS DIRECTED BY THE OWNER. ALL LOCAL ORDINANCES REGARDING THE SALE OF TOPSOIL MUST BE FOLLOWED. TOPSOIL MAY NOT BE REMOVED WITHOUT A PERMIT.
- 3. ALL SILT FENCE/SILT SOCK BARRIERS SHALL BE REPLACED WHEREVER THEY BECOME CLOGGED OR
- 4. THE CONTRACTOR SHALL BE RESPONSIBLE FOR MAINTENANCE AND REMOVAL OF TEMPORARY SEDIMENTATION CONTROLS.
- 5. THE CONTRACTOR MUST CONTROL DUST DURING CONSTRUCTION. DURING EARTHWORK OPERATIONS, WATER-SPREADING EQUIPMENT SHALL BE PROVIDED BY THE CONTRACTOR, AND SPREAD WATER AS NECESSARY AND AS DIRECTED BY THE OWNER IN ORDER TO CONTROL DUST.
- 6. DIRT OR DEBRIS LEFT ON LOCAL PUBLIC ROADS AS A RESULT OF THIS CONSTRUCTION PROJECT SHALL BE REMOVED AND ROAD SURFACES CLEANED BY THE CONTRACTOR ON A DAILY BASIS.
- 7. ALL DISTURBED AREAS (EXCEPT AREAS TO BE PAVED OR BUILT UPON) SHALL BE TOPSOILED TO A MINIMUM 4" DEPTH AND SEEDED IMMEDIATELY AFTER FINE GRADING TAKES PLACE AND AS SOON AS PHYSICALLY POSSIBLE.
- 8. THE CONTRACTOR IS RESPONSIBLE FOR THE MAINTENANCE OF DOWNSTREAM STORM SEWERS, DITCHES, AND CULVERTS. SILT BUILDUP FOUND TO BE A RESULT OF THIS SITE CONSTRUCTION WORK SHALL BE REMOVED FROM DOWNSTREAM CULVERTS BY THE CONTRACTOR AT NO ADDITIONAL EXPENSE TO THE OWNER OR THE TOWN/CITY.
- 9. ALL SOIL EROSION AND SEDIMENT CONTROL DEVICES AND MATERIALS SHALL BE IN PLACE PRIOR TO BEGINNING EARTHWORK OPERATIONS AND SHALL BE MAINTAINED UNTIL THE NEW SLOPES ARE STABILIZED WITH SEEDING AND/OR SLOPE PROTECTION, AS DIRECTED BY THE ENGINEER.
- 10. INSTALL TEMPORARY SILT FENCE AROUND THE BASE OF STOCKPILES.
- 11. THE ENGINEER OF RECORD FOR THIS PROJECT CERTIFIES THAT THESE DESIGN PLANS MEET THE REQUIREMENTS AND ARE IN COMPLIANCE WITH THE NEW YORK STORMWATER MANAGEMENT DESIGN MANUAL AND NYSDEC PHASE II STORMWATER REGULATION REQUIREMENTS.

DEMOLITION & EROSION CONTROL LEGEND

EXISTING PAVEMENT/SIDEWALK/CURBING TO BE SAWCUT & REMOVED EXISTING TREE TO BE REMOVED

TEMPORARY SILT SOCK

PROPOSED STORM INLET PROTECTION

NOTE: BOUNDARY AND TOPOGRAPHIC INFORMATION PROVIDED BY OTHERS, CARMINA WOOD MORRIS, D.P.C.

DRAWING NO.

Drawn by:

DRAWING NAME:

Demolition &

Erosion Control

Scale:


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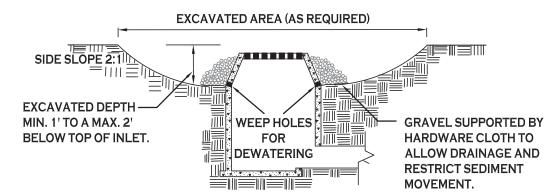
P. Sheedy

DEMOLITION & EROSION CONTROL PLAN

SCALE: 1"=30"

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CONSTRUCTION SPECIFICATIONS

- 2. GRADE APPROACH TO THE INLET UNIFORMLY AROUND THE BASIN.
- 4. UPON STABILIZATION OF CONTRIBUTING DRAINAGE AREA, SEAL WEEP HOLES, FILL BASIN WITH STABLE SOIL TO FINAL GRADE, COMPACT IT PROPERLY AND STABILIZE WITH

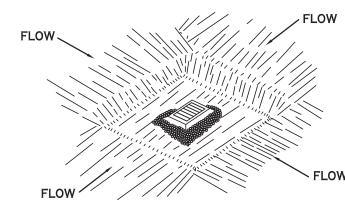
MAXIMUM DRAINAGE AREA 1 ACRE

INLET PROTECTION DETAIL 1

FOR OVER FLOW STABILITY.

INLET PROTECTION DETAIL 2

NOTE: INSTALL ONE OF THE INLET PROTECTION OPTIONS SHOWN PRIOR TO CONSTRUCTION

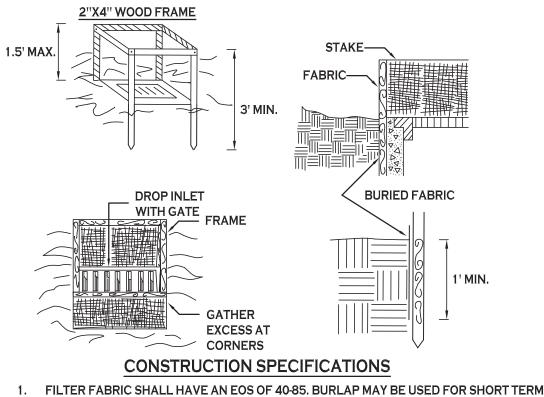

- APPLICATIONS.
- 2. CUT FABRIC FROM A CONTINUOUS ROLL TO ELIMINATE JOINTS. IF JOINTS ARE NEEDED THEY WILL BE OVERLAPPED TO THE NEXT STAKE.
- 3. STAKE MATERIALS WILL BE STANDARD 2" x 4" WOOD OR EQUIVALENT. METAL WITH A MINIMUM LENGTH OF 3 FEET.
- 4. SPACE STAKES EVENLY AROUND INLET 3 FEET APART AND DRIVE A MINIMUM 18 INCHES DEEP. SPANS GREATER THAN 3 FEET MAY BE BRIDGED WITH THE USE OF WIRE MESH BEHIND THE FILTER FABRIC FOR SUPPORT.
- 5. FABRIC SHALL BE EMBEDDED 1 FOOT MINIMUM BELOW GROUND AND BACKFILLED. IT SHALL BE SECURELY FASTENED TO THE STAKES AND FRAME.
- 6. A 2" x 4" WOOD FRAME SHALL BE COMPLETED AROUND THE CREST OF THE FABRIC

MAXIMUN DRAINAGE AREA 1 ACRE

INLET PROTECTION DETAIL 3 NOT TO SCALE

STONE & BLOCK PLAN VIEW

FINE GRAVEL FACE

(1'MIN. THICKNESS)

SUPPORT.

STONE.

BLOCK ON A 2:1 SLOPE OR FLATTER.

MAXIMUM DRAINAGE AREA 1 ACRE

TEMPORARY

SEDIMENT POOL—

— SEDIMENT POOL

"DOUGHNUT" DETAIL

AGAINST THE 3 INCH STONE AS SHOWN ON THE DRAWINGS.

CONSTRUCTION SPECIFICATIONS


1. LAY ONE BLOCK ON EACH SIDE OF THE STRUCTURE ON ITS SIDE FOR DEWATERING. FOUNDATION SHALL

BE 2 INCHES MINIMUM BELOW REST OF INLET AND BLOCKS SHALL BE PLACED AGAINST INLET FOR

2. HARDWARE CLOTH OR 1/2" WIRE MESH SHALL BE PLACED OVER BLOCK OPENINGS TO SUPPORT

3. USE CLEAN STONE OR GRAVEL 1/2-3/4 INCH IN DIAMETER PLACED 2 INCHES BELOW TOP OF THE

4. FOR STONE STRUCTURES ONLY, A 1 FOOT THICK LAYER OF THE FILTER STONE WILL BE PLACED

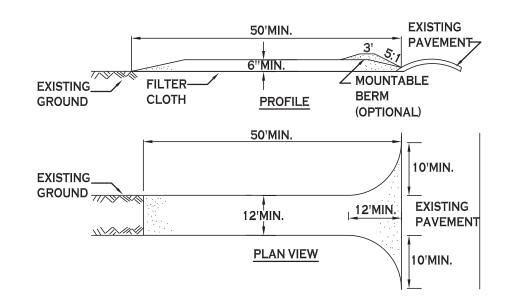


1. STONE SIZE - USE 2" STONE, OR RECLAIMED OR RECYCLED CONCRETE EQUIVALENT.

CONSTRUCTION SPECIFICATIONS

- 2. LENGTH NOT LESS THAN 50 FEET (EXCEPT ON A SINGLE RESIDENCE LOT WHERE A 30 FOOT MINIMUM LENGTH WOULD APPLY).
- 3. THICKNESS NOT LESS THAN SIX (6) INCHES.
- 4. WIDTH TWELVE (12) FOOT MINIMUM, BUT NOT LESS THAN THE FULL WIDTH AT POINTS WHERE INGRESS OR EGRESS OCCURS. TWENTY-FOUR (24) FOOT IF SINGLE ENTRANCE
- 5. FILTER CLOTH WILL BE PLACED OVER THE ENTIRE AREA PRIOR TO PLACING OF
- 6. SURFACE WATER ALL SURFACE WATER FLOWING OR DIVERTED TOWARD CONSTRUCTION ENTRANCES SHALL BE PIPED ACROSS THE ENTRANCE. IF PIPING IS IMPRACTICAL, A MOUNTABLE BERM WITH 5:1 SLOPES WILL BE PERMITTED.
- MAINTENANCE THE ENTRANCE SHALL BE MAINTAINED IN A CONDITION WHICH WILL PREVENT TRACKING OR FLOWING OF SEDIMENT ONTO PUBLIC RIGHTS-OF-WAY, ALL SEDIMENT SPILLED, DROPPED, WASHED OR TRACTED ONTO PUBLIC RIGHTS-OF-WAY MUST BE REMOVED IMMEDIATELY.
- 8. WHEN WASHING IS REQUIRED, IT SHALL BE DONE ON A AREA STABILIZED WITH STONE AND WHICH DRAINS INTO AN APPROVED SEDIMENT TRAPPING DEVICE.
- 9. PERIODIC INSPECTION AND NEEDED MAINTENANCE SHALL BE PROVIDED AFTER EACH

STABILIZED CONSTRUCTION ENTRANCE DETAIL

NOT TO SCALE

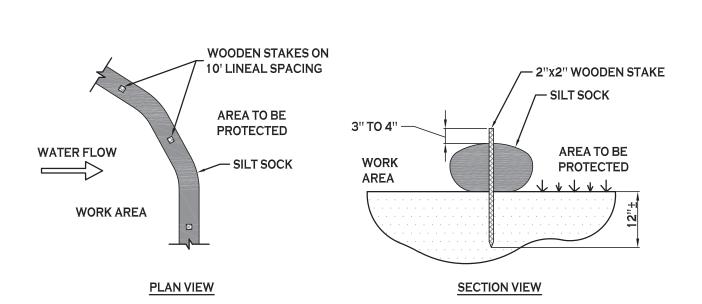

- WIRE SCREEN

STONE & BLOCK DETAIL

WIRE MESH (OPTIONAL)


DEWATERING

DROP INLET

CONTRACTOR SHALL INSPECT AND MAINTAIN SILT SOCK AS NEEDED DURING THE DURATION OF CONSTRUCTION PROJECT.

CONTRACTOR SHALL REMOVE SEDIMENT COLLECTED AT THE BASE OF THE SILT SOCK WHEN IT HAS REACHED 1 OF THE EXPOSED HEIGHT OF THE SILT SOCK. ALTERNATIVELY, RATHER THAN CREATE A SOIL DISTURBING ACTIVITY, THE ENGINEER MAY CALL FOR ADDITIONAL SILT SOCK TO BE ADDED AT AREAS OF HIGH SEDIMENTATION, PLACED IMMEDIATELY ON TOP OF THE EXISTING SEDIMENT LADEN SILT SOCK.

> SILT SOCK DETAIL NOT TO SCALE

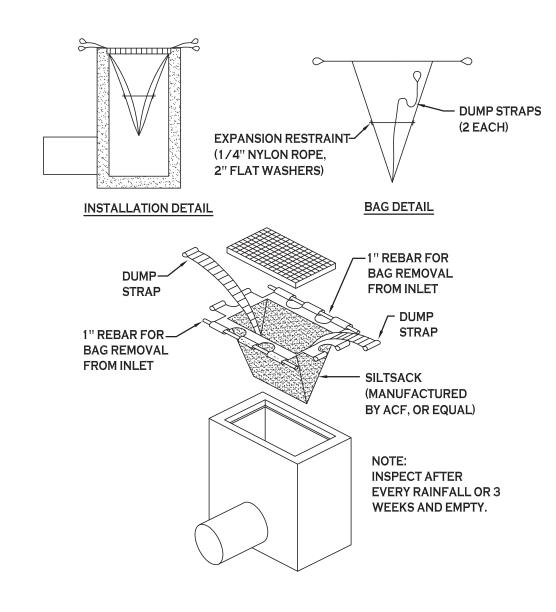

SILT SACK DETAIL

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Wood

Morris[®]

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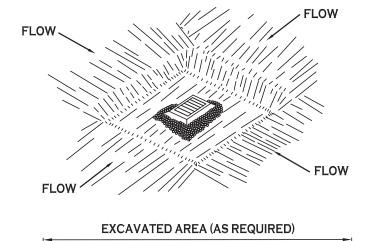
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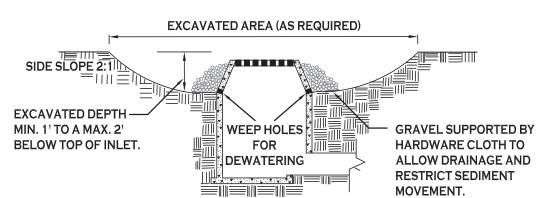
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Demolition & **Erosion Control**

DRAWING NO.

Details







- 1. CLEAR THE AREA OF ALL DEBRIS THAT WILL HINDER EXCAVATION.
- 3. WEEP HOLES SHALL BE PROTECTED BY GRAVEL.
- PERMANENT SEEDING.

NOT TO SCALE



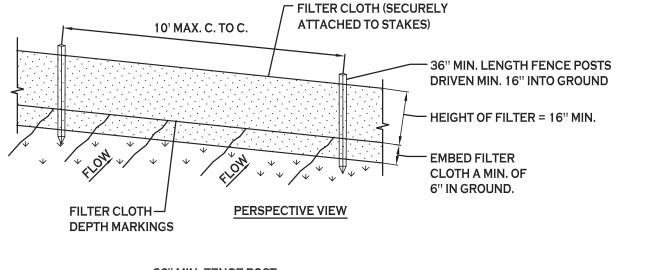

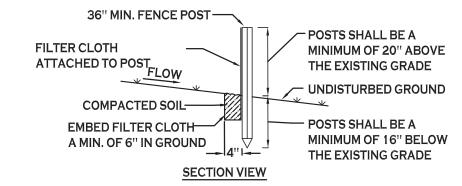

CONSTRUCTION SPECIFICATIONS

- 1. WOVEN FENCE TO BE FASTENED SECURELY TO FENCE POSTS WITH WIRE TIES OR STAPLES. POSTS SHALL BE STEEL EITHER "T" OR "U" TYPE OR HARDWOOD.
- 2. WHEN TWO SECTIONS OF FILTER CLOTH ADJOIN EACH OTHER THEY SHALL BE OVER-LAPPED BY SIX INCHES AND FOLDED. FILTER CLOTH SHALL BE EITHER FILTER X, MIRAFI 100X, STABILINKA T140N, OR APPROVED EQUIVALENT.
- 3. MAINTENANCE SHALL BE PERFORMED AS NEEDED AND MATERIAL REMOVED WHEN "BULGES" DEVELOP IN THE SILT FENCE.

SILT FENCE DETAIL NOT TO SCALE

SITE DATA SITE AREA = 2.10 AC **ZONED: COMMERCIAL** USE: PROPOSED 6,448 SF OFFICE & 4,500 SF WAREHOUSE BUILDING SETBACKS - BUILDING REQUIRED FRONT 45 FT * 45.0 FT SIDE (ABUTTING COM. / RES.) 25 FT / 45 FT 25.0 FT REAR (ABUTTING COM. / RES.) 25 FT / 45 FT 341.91 FT SETBACKS - PARKING 33.70 FT N/A N/A 2.74 FT REAR N/A 221.91 FT PARKING STALLS STALL SIZE 9'x19' 9'x19' REQUIRED SPACES GREENSPACE OVERALL SITE GREENSPACE 25% (0.53 AC) 58% (1.21 AC) 8% (0.02 AC) 8% (0.02 AC) INTERIOR GREENSPACE MAX. BUILDING HEIGHT 45 FT <= 45 FT MAX. BUILDING COVERAGE 13.66% 70% MAX.

* WHERE THERE IS AN ESTABLISHED FRONT SETBACK LINE BETWEEN ADJOINING PROPERTIES, THAT SETBACK LINE WOULD APPLY TO THE PROPERTY TO A MINIMUM OF 45 FEET.

PARKING CALCULATION:

1 SPACE PER 200 GSF OF FLOOR AREA

6,448 GSF / 200 = <u>32 SPACES</u>

1 PER 200 GSF OF OFFICE AREA, OR 1 PER EMPLOYEE OF MAXIMUM SHIFT 2 EMPLOYEES ≈ 2 SPACES

TOTAL SPACES REQUIRED = 34 SPACES

SITE NOTES:

- 1. ALL RADII SHALL BE 3'-0" UNLESS OTHERWISE NOTED.
- 2. ALL DISTURBED AREAS SHALL HAVE 4" MIN. OF TOPSOIL AND SEED. FOR DISTURBED AREAS WITHIN NYSDOT R.O.W. DISTURBED AREAS SHALL BE RESTORED USING ITEM 610.1402 - TOPSOIL ROADSIDE AND ITEM 610.1602 - TURF ESTABLISHMENT.
- 3. ALL DIMENSIONS FROM PROPERTY LINES SHALL BE MEASURED PERPENDICULAR TO THE PROPERTY LINE.
- 4. CENTER ENTRANCE SIDEWALKS ON DOOR OPENINGS.
- 5. BUILDING DIMENSIONS ARE APPROXIMATE, REFER TO ARCHITECTURAL DRAWINGS FOR LAYOUT DIMENSIONS.
- 6. ALL HANDICAP RAMPS AND/OR SIDEWALKS FLUSH TO PAVEMENT SHALL HAVE ADA COMPLIANT TACTILE WARNING STRIPS WHERE ENTERING PARKING AREAS/DRIVEWAYS.
- 7. KNOX KEY BOX TO BE INSTALLED TO ALLOW FIRE DEPARTMENT ACCESS TO BUILDING KEYS, LOCATION TO BE COORDINATED WITH OWNER AND TOWN.
- 8. ALL EDGES OF PAVEMENT SHALL BE CURVED.
- 9. ALL SIDEWALKS ARE 5' WIDE UNLESS OTHERWISE NOTED.

GENERAL NOTS:

- 1. INSTALL ALL MATERIALS TO MANUFACTURER'S RECOMMENDATIONS AND BEST STANDARDS OF TRADE
- 2. SUBSTITUTIONS SHALL BE MADE ONLY WITH OWNER'S APPROVAL AND BE OF EQUIVALENT QUALITY TO WHAT
- 3. WORK SHALL BE COMPLETED IN STRICT ACCORDANCE WITH ALL LOCAL CODES AND OSHA SAFETY RULES AND REGULATIONS.
- 4. VERIFY ALL EXISTING CONDITIONS AND DIMENSIONS AT THE SITE. NOTIFY OWNER & ENGINEER OF DISCREPANCIES IN CONDITIONS SHOWN ON DRAWINGS PRIOR TO PROCEEDING WITH THE WORK.
- 5. CONTRACTOR SHALL BE RESPONSIBLE FOR PROTECTION OF ANY EXISTING STRUCTURES TO REMAIN AND ANY FINISH MATERIAL INSTALLED WHILE WORKING ON OTHER COMPONENTS.
- 6. CONTRACTOR SHALL KEEP JOB FREE OF DEBRIS AND MAKE FINAL CLEANUP TO SATISFACTION OF OWNER.
- 7. CONTRACTOR SHALL ASCERTAIN THE LOCATION OF ALL UTILITIES PRIOR TO CONSTRUCTION SO THAT THIS WORK WILL NOT DISTURB EXISTING LINES AND/OR INSTALLATIONS. COORDINATE ALL WORK WITH THE APPLICABLE UTILITY COMPANIES.
- 8. ALL OTHER PERMITS REQUIRED BY STATE OF NEW YORK, COUNTY OF ERIE, AND TOWN OF CLARENCE ARE THE RESPONSIBILITY OF THE CONTRACTOR/DEVELOPER/OWNER.
- 9. REFER TO NYSDOT STANDARD SHEET 608-03 FOR DRIVEWAY ENTRANCE AND LAYOUT INFORMATION ALONG MAIN STREET.

DETAIL LEGEND SEE SITE DETAIL SHEET 1 STANDARD DUTY ASPHALT

1 EDGE OF PAVEMENT

2 90° PARKING STALL CONCRETE SIDEWALK

HANDICAPPED PAVEMENT MARKINGS

HANDICAPPED PARKING SIGN (WALL MOUNTED) 6 6' HIGH BOARD ON BOARD FENCE

GRAVEL PARKING AREA HANDICAP PAVEMENT RAMP

9 CONCRETE CURB

DUMPSTER ENCLOSURE

NOTE LEGEND

INSTALL "NO PARKING" SIGN, M.U.T.C.D. SIGN NO. R7-1C (WALL MOUNTED) LANDSCAPED AREA - SEE LANDSCAPE PLAN, IF NO PLANTINGS, INSTALL TOPSOIL & SEED

2.5' HIGH STONE DECORATIVE WALL, FACE ALONG R.O.W. LINE

RUNOUT CURB IN 2'

6 WALLPACK LIGHTING

(11) CONCRETE SLAB ON GRADE

SITE PLAN

SCALE: 1"=30'

SITE LEGEND PROPERTY LINE ____ PROPOSED SIDEWALK PROPOSED ASPHALT PAVEMENT NUMBER OF PARKING SPACES PROPOSED SIGN PROPOSED BLDG. MOUNTED LIGHT

NOTE: BOUNDARY AND TOPOGRAPHIC INFORMATION PROVIDED BY OTHERS, CARMINA WOOD MORRIS, D.P.C. ASSUMES NO RESPONSIBILITY FOR ITS ACCURACY.

Wood

Buffalo, New York 14203 P 716.842.3165 F 716.842.0263

Morris


487 Main Street Suite 500

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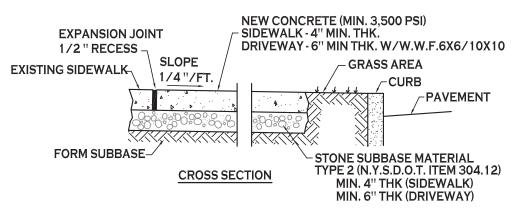
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8/20/19

Site Plan



HANDICAPPED PAVEMENT RAMP - 8 NOT TO SCALE

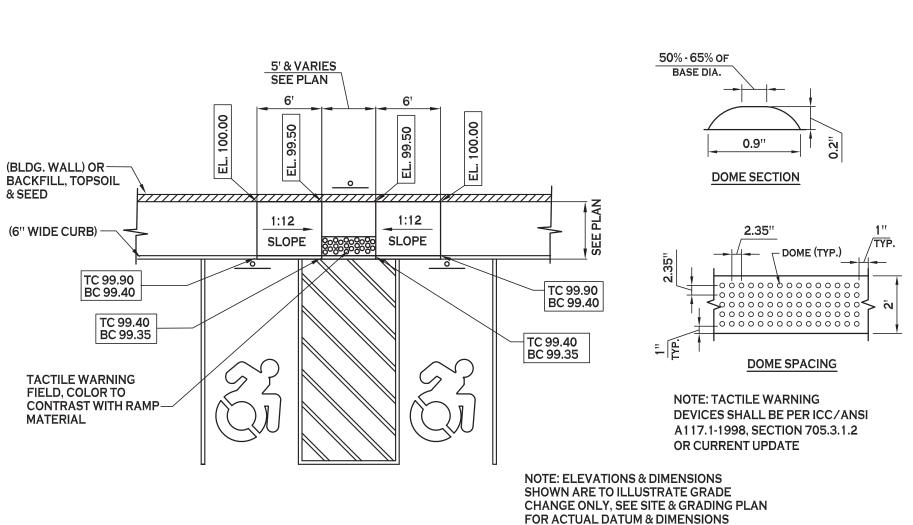


8" SUBBASE COURSE

MATERIAL, TYPE 2

- I. CONTROL JOINTS TO BE AT 5'-0" O.C., BOTH WAYS WHERE APPLICABLE. SEE SPECIFICATIONS FOR FURTHER JOINT REQUIREMENTS NYSDOT 702-0700.
- 2. CONCRETE SIDEWALK AND DRIVEWAY MATERIAL SHALL CONFORM TO NYSDOT STANDARD SPECIFICATION 501 AND CONSTRUCTION METHODS SHALL CONFORM TO NYSDOT STANDARD SPECIFICATION 608-3.
- 3. SUBBASE GRADE SHALL FOLLOW THE PROPOSED GRADE OF THE SIDEWALK AND SLOPE AWAY FROM BUILDING WHERE APPLICABLE, PROVIDE CONTINUOUS STONE PATH TO CURB UNDERDRAIN WHERE PROVIDED.
- 4. FULL DEPTH EXPANSION JOINTS SHALL BE INSTALLED EVERY 20' O.C., BOTHWAYS WHERE APPLICABLE. SEE SPECIFICATIONS FOR FURTHER JOINT REQUIREMENTS NYSDOT 702-0700.
- 5. SEE CURB DETAIL FOR DOWLING REQUIREMENTS WHERE ABUTTING CURB.
- 6. INSTALL 6" LONG #3 DOWELS @ 12" O.C. WHERE SIDEWALK ABUTS A BUILDING WALL AT AN ENTRANCE, THICKEN SIDEWALK TO 6" AT BUILDING WALL AND INSTALL DOWEL CENTERED IN THE 6" DEPTH. DOWELS AND THICKENING OF SIDEWALK SHALL EXTEND 18" EITHER SIDE OF ENTRANCE.
- 7. INSTALL 1/2" PREMOLDED EXPANSION JOINT WITH BACKER ROD & SEALANT WHERE SIDEWALK ABUTS BUILDING OR OTHER STRUCTURE.

CONCRETE SIDEWALK-3 NOT TO SCALE

HANDICAPPED PARKING SIGN M.U.T.C.D. SIGN NO. P4-6C-RESERVED **PARKING**

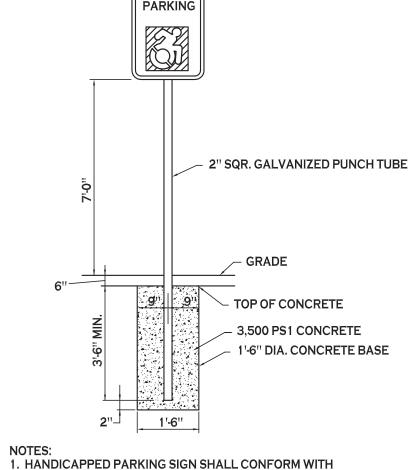


CURRENT STATE AND LOCAL CODES AND REGULATIONS. GRASS/LAWN AREA

HANDICAPPED PARKING SIGN - 5 NOT TO SCALE

PAVEMENT WIDTH VARIES SEE SITE PLAN TRAFFIC YELLOW 4" WIDE **CONCRETE CURB OR** PAINTED LINE (TYP) -- EDGE OF PVMT., SEE PLAN **√8" SUBBASE COURSE MATERIAL, TYPE 2** (N.Y.S.D.O.T. ITEM 304.12) LANDSCAPED AREA NONWOVEN GEOTEXTILE FABRIC MIRAFI 600X OR 9'-0'' 9'-0" **CONCRETE CURB OR** APPROVED EQUAL - EDGE OF PVMT., SEE PLAN GRADED AND COMPACTED PAVEMENT SUBGRADE **GRAVEL PARKING SECTION - 7**

90° PARKING STALL LAYOUT - 2 NOT TO SCALE

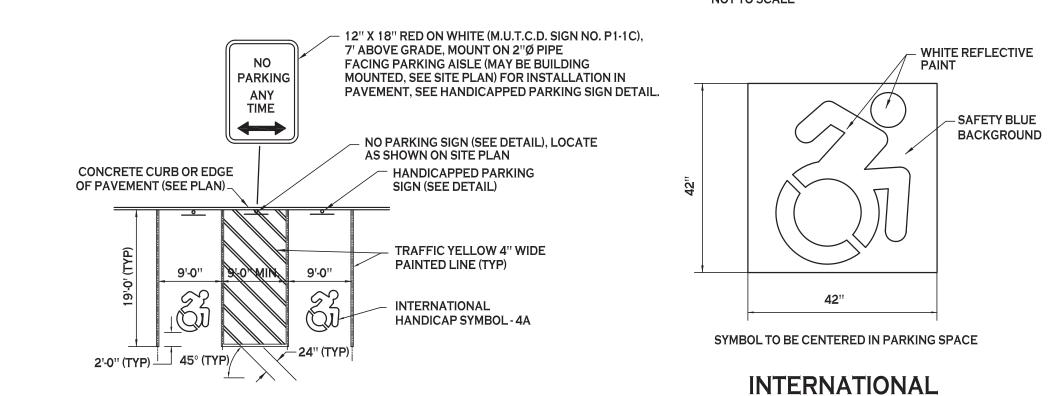

HANDICAPPED PAVEMENT MARKINGS & SIGNAGE - 4 NOT TO SCALE

NOT TO SCALE

1" X 6" BOARD

__ 2" X 6" TOP RAILS - 3-20# NAILS ATTACHED

TO RAIL POST (EACH SIDE)

2" X 6" CENTER RAILS

_ 2" X 6" BOTTOM RAILS

3,000 PSI CONC.

3" Ø GALVANIZED STEEL POST.

12" DIA. HOLE, FILL WITH

2'-0" GRAVEL FILL

TREATED PINE.

2. CENTER, BOTTOM AND TOP RAILS TO BE FASTENED

TO 3" Ø GALVANIZED STEEL FENCE POSTS USING


3. ATTACH EACH 1" X 6" BOARD TO RAILS USING (3)

GALVANIZED NAILS AT EACH RAIL LOCATION.

SIMPSON PIPE GRIP TIES OR EQUAL. ALL

HARDWARE TO BE GALVANIZED.


8'-0" O.C. 12' LONG (8' HIGH FENCE) 8'-0" O.C. 10' LONG (6' HIGH FENCE)

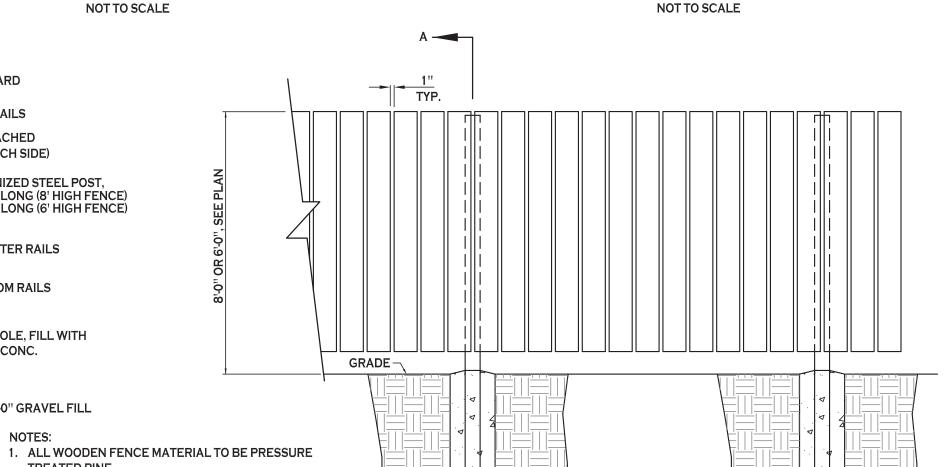

HANDICAP SYMBOL - 4A

4. WOOD POSTS CAN BE SUBSTITUTED FOR STEEL 6' BOARD ON BOARD FENCE - 6

NOT TO SCALE

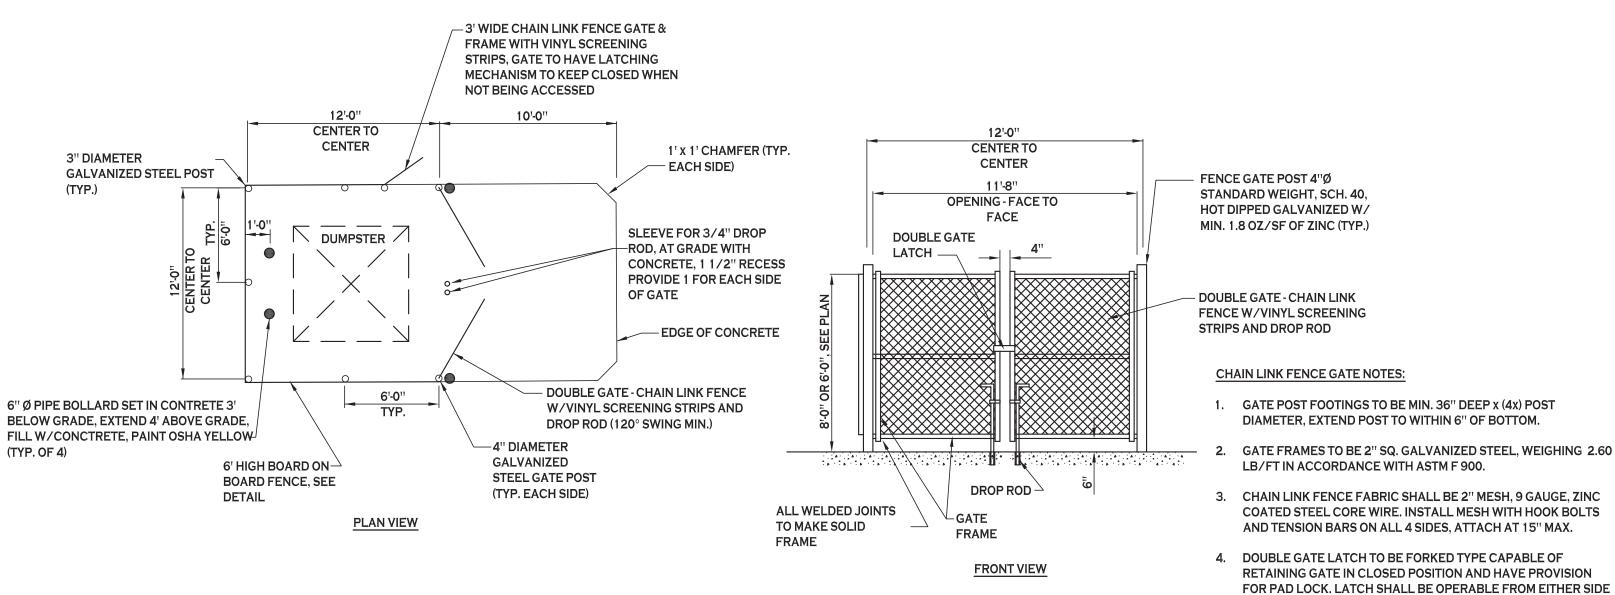

SECTION A-A

DUMPSTER ENCLOSURE - 10 NOT TO SCALE

DOUBLE GATE - CHAIN LINK

CHAIN LINK FENCE GATE NOTES:

OF GATE.

- 1. GATE POST FOOTINGS TO BE MIN. 36" DEEP x (4x) POST DIAMETER, EXTEND POST TO WITHIN 6" OF BOTTOM.
- GATE FRAMES TO BE 2" SQ. GALVANIZED STEEL, WEIGHING 2.60
- LB/FT IN ACCORDANCE WITH ASTM F 900. 3. CHAIN LINK FENCE FABRIC SHALL BE 2" MESH, 9 GAUGE, ZINC
- COATED STEEL CORE WIRE. INSTALL MESH WITH HOOK BOLTS AND TENSION BARS ON ALL 4 SIDES, ATTACH AT 15" MAX. 4. DOUBLE GATE LATCH TO BE FORKED TYPE CAPABLE OF RETAINING GATE IN CLOSED POSITION AND HAVE PROVISION
- 5. ALL HARDWARE TO BE HOT DIPPED GALVANIZED STEEL TO SUIT GATE SIZE.

Wood Morris[®] 487 Main Street Suite 500 Buffalo, New York 14203



P 716.842.3165

uilding

Date: Drawn by: Scale:

P. Sheedy As Noted

8/20/19

DRAWING NAME Site Details

DRAWING NO.

_ CB 2 _ RIM 728.25

TC 729.40 BC 728.90

TC 729.10 BC 728.60

MAIN (99' WIDE) STREET MATCHEX.

TC 729.45 BC 728.95

729.50 × 729.50 / 729.50 / 729.50 | TC 729.40 | BC 728.90

PROPOSED

OFFICE/ SHOWROOM

TC 729.40 BC 728.90


RIM 728.50 🔪

6,448 SF

729.50 BUILDING F.F.E. F.F.E. 729.50

EX. BUILDING

GRADING PLAN SCALE: 1"=30'

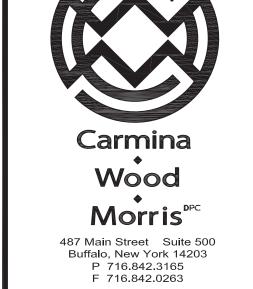



Buildings

PROPOSED GRADING LEGEND

100.80

■ CB

⊕ YD

NOTE: BOUNDARY AND TOPOGRAPHIC INFORMATION

PROVIDED BY OTHERS, CARMINA WOOD MORRIS, D.P.C. ASSUMES NO RESPONSIBILITY FOR ITS ACCURACY.

TC 101.30

BC 100.80

PROPOSED CONTOUR

PROPOSED SPOT ELEVATION

PROPOSED TOP OF CURB/

PROPOSED CATCH BASIN

PAVEMENT/GROUND SLOPE

PROPOSED YARD DRAIN

CB: CATCH BASIN DW: DRAINAGE WELL YD: YARD DRAIN

BOTTOM OF CURB ELEVATION


Date: Drawn by: Scale:

DRAWING NAME:

8/20/19 P. Sheedy As Noted

Grading Plan

DRAWING NO.

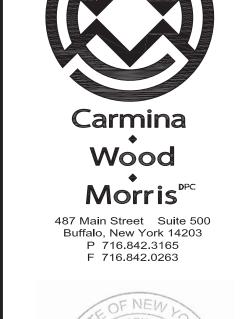



Buildings

Date: Drawn by: Scale:

PROPOSED STORM DRAINAGE LEGEND

NOTE: BOUNDARY AND TOPOGRAPHIC INFORMATION

ASSUMES NO RESPONSIBILITY FOR ITS ACCURACY.

PROVIDED BY OTHERS, CARMINA WOOD MORRIS, D.P.C.

PROPOSED STORM PIPE

PROPOSED PERFORATED

PROPOSED CATCH BASIN

PROPOSED YARD DRAIN

CB: CATCH BASIN DW: DRAINAGE WELL YD: YARD DRAIN

(INCHES)

0.65

0.89

1.27

1.63

2.23 2.80

3.48

ELEVATION STORAGE

725.54

725.78

726.13

726.46

726.96

727.40 727.90

(CUBIC-FEET)

2,181

3,322

4,453

6,316

8,091

3,747

5,096

7,257

9,361

12,794 16,051

19,968

POST DEVELOPMENT STORMWATER EVENT SUMMARIES

0.56 0.56 0.56 0.56

2-YEAR

5-YEAR

10-Year

25-YEAR

50-YEAR

2-YEAR

5-YEAR

10-YEAR

25-YEAR 6.88 50-YEAR 8.30 100-YEAR 9.95

100-YEAR 5.59

2.03

2.63

3.60 4.51

5.33

8/20/19 P. Sheedy As Noted

DRAWING NAME:

Storm Drainage

Plan

DRAWING NO.

Project no.: 19.004

SCALE: 1"=30"

A. PIPE INSTALLATION SHALL BE IN ACCORDANCE WITH MANUFACTURERS RECOMMENDATIONS.

B. TRENCHING OPERATIONS SHALL INCLUDE ALL NECESSARY DEWATERING.

C. TRENCH DETAILS ARE ONLY SHOWN FOR PURPOSES OF MATERIAL PLACEMENT AND MAXIMUM PAY LIMITS.

D. AN OSHA APPROVED MOVABLE PROTECTIVE TRENCH SHIELD SHALL BE USED IN ALL UNSHEETED TRENCH AREAS.

PIPE BEDDING MATERIAL (NYSDOT 1985 EDITION)

NO. 1 CRUSHED STONE OR CRUSHED GRAVEL WITH A GRADATION CONFORMING WITH NYSDOT SECTION 703-02. THE MATERIAL SHALL BE WELL GRADED WITH NO PARTICLES LARGER THAN ONE INCH AND HAVING A MAXIMUM GRADATION MEETING THE LIMITS DESCRIBED IN THE SPECIFICATIONS. THE BEDDING SHALL BE COMPACTED IN 6" LIFTS WITH EQUIPMENT ACCEPTABLE TO THE PIPE MANUFACTURER.


NO SLAG SHALL BE ALLOWED FOR MATERIAL (1)

(2) TYPE 2 CRUSHED STONE OR CRUSHED GRAVEL WITH A GRADATION CONFORMING WITH NYSDOT SECTION 304·2.02 TYPE 2. THE MATERIAL SHALL BE WELL GRADED WITH NO PARTICLES LARGER THAN TWO INCHES AND HAVING A MAXIMUM GRADATION MEETING THE LIMITS DESCRIBED IN THE SPECIFICATIONS. THE BEDDING SHALL BE COMPACTED IN 6" LIFTS WITH EQUIPMENT ACCEPTABLE TO THE PIPE MANUFACTURER.


NO SLAG SHALL BE ALLOWED FOR MATERIAL (2)

STORM SEWER TRENCH SECTION **IN PAVED AREAS**

NOT TO SCALE

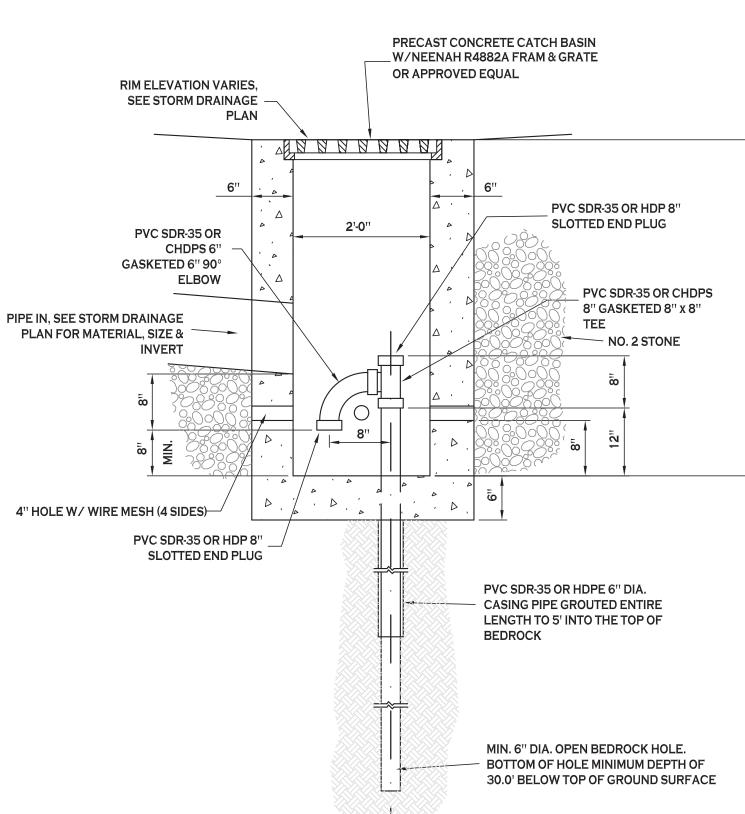

TYPICAL DRAINAGE WELL NOT TO SCALE

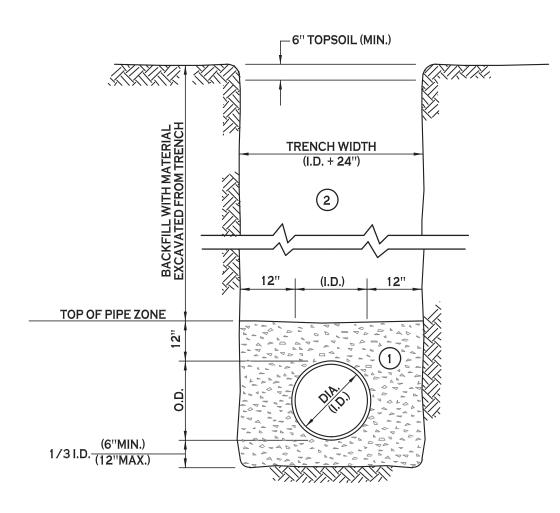

A. PIPE INSTALLATION SHALL BE IN ACCORDANCE WITH MANUFACTURERS

B. TRENCHING OPERATIONS SHALL INCLUDE ALL NECESSARY DEWATERING.

C. TRENCH DETAILS ARE ONLY SHOWN FOR PURPOSES OF MATERIAL PLACEMENT AND MAXIMUM PAY LIMITS.

D. AN OSHA APPROVED MOVABLE PROTECTIVE TRENCH SHIELD SHALL BE USED IN ALL UNSHEETED TRENCH AREAS.

MATERIALS

PIPE BEDDING MATERIAL (NYSDOT 1985 EDITION)

NO. 1 CRUSHED STONE OR CRUSHED GRAVEL WITH A GRADATION CONFORMING WITH NYSDOT SECTION 703-02. THE MATERIAL SHALL BE WELL GRADED WITH NO PARTICLES LARGER THAN ONE INCH AND HAVING A MAXIMUM GRADATION MEETING THE LIMITS DESCRIBED IN THE SPECIFICATIONS. THE BEDDING SHALL BE COMPACTED IN 6" LIFTS WITH EQUIPMENT ACCEPTABLE TO THE PIPE MANUFACTURER.

NO SLAG SHALL BE ALLOWED FOR MATERIAL (1)

BACKFILL MATERIAL SHALL BE NATIVE SOIL CONTAINING NO UNSUITABLE MATERIAL COMPACTED IN 6" LIFTS.

STORM SEWER TRENCH SECTION **IN UNPAVED AREAS** NOT TO SCALE


1. CONSTRUCTION OF STORM DRAINAGE WELLS TO BE IN ACCORDANCE WITH RECOMMENDATIONS OF BUFFALO DRILLING COMPANY, INC.

2. STORM DRAINAGE WELLS TO BE CONSTRUCTED AS MINIMUM 6" DIAMETER OPEN BEDROCK WELLS EXTENDING MINIMUM OF 30 FEET BELOW EXISTING GROUND SURFACE.

3. EACH STORM DRAINAGE WELL TO BE FIELD TESTED TO DETERMINE INTAKE VALUE, THIS VALUE TO BE APPROVED BY OWNER.

4. CONTRACTOR SHALL COMPLY WITH ALL APPLICABLE FEDERAL. STATE AND LOCAL STATUTES REGARDING THE PREVENTION AND ABATEMENT OF SOIL EROSION, SEDIMENTATION, WATER POLLUTION AND PRESERVATION OF EXISTING AQUIFERS.

5. REGULAR PERIODIC INSPECTION AND MAINTENANCE OF STORM DRAINAGE WELLS IS RECOMMENDED. MAINTENANCE TO INCLUDE REMOVAL OF ACCUMULATED OILS AND SEDIMENT FROM SUMPS IN CURB INLETS AND STORM DRAINAGE WELLS AS WELL AS PERIODIC FLUSHING OF STORM DRAINAGE WELLS WITH WATER AND AIR.

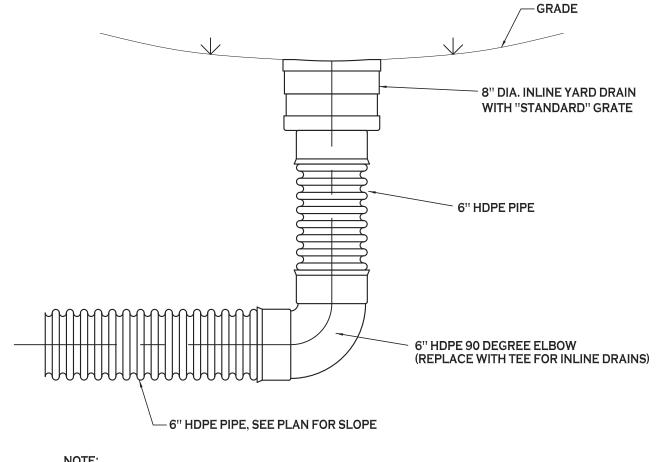

SEE TYPICAL TRENCH SECTION FOR BEDDING REQUIREMENTS

EXTERIOR CLEANOUT @ GRADE — J.R. SMITH #4251-U W/ VANDAL-

TOP COURSE

STONE BASE

SELECT FILL

FLOW

BINDER

PROOF SCREWS OR APPROVED EQUAL

TYPICAL YARD DRAIN DETAIL NOT TO SCALE

-HYDROSEED MAX. PONDING/ (3" MAX. PONDING HEIGHT) + EL. 725.00 RIM OF DW OVERFLOW ELEV. 1.5" AVG. PONDING HEIGHT EL. 724.50 2. MULCH TO BE SHREDDED HARDWOOD, AGED 12 3. DRAINAGE GRAVEL TO MEET AASHTO M-43. 4. CONTRACTOR TO PROVIDE PLANTING SOIL 18" MIN. PLANTING -PLANTING SOIL BED SOIL DEPTH 4" PERFORATED HDPE UNDERDRAIN IN 6" EL. 723.00 DRAINAGE GRAVEL **JACKET** EL. 722.33-(VARIES, SEE STORM SUBGRADE OR EX. SOIL 4" PERF. **HDPE @ 0.0%**

BIO-RETENTION AREA SEEDING SPEC (NORTHEAST WETLAND GRASS SEED MIX):						
SEED MIXTURE	VARIETY	PERCENT BY No. OF SEEDS				
CREEPING BENTGRASS	AGROSTIS STOLONIFERA	63.0				
ROUGH BLUEGRASS	Poa trivialis	17.0				
MEADOW FOXTAIL	ALOPECURUS ARUNDINACEUS	11.0				
ANNUAL RYEGRASS	LOLIUM MULTIFLORUM	4.5				
DEERTONGUE	PANICUM CLANDESTINUM	4.5				

PVC END CAP

(END OF LINE CLEANOUTS ONLY)

BIORETENTION AREA - TYPICAL SECTION

NOT TO SCALE

EXTERIOR CLEANOUT @ GRADE -J.R. SMITH #4251-U W/ VANDAL-NOTE: COVER TO BE PROOF SCREWS OR APPROVED EQUAL INSCRIBED "SANITARY" PVC CAP END 2"x4" MARKER TO BE CUT 1'-0" BELOW GRADE AFTER FINAL FIELD WALK (END OF LINE CLEANOUTS ONLY) FRAME OD+2' 4000 PSI CONCRETE ENCASEMENT **4000 PSI CONCRETE ENCASE** 24" MIN. TO FULL DEPTH OF FRAME √ 6"x6"x6" WYE (VARIES W/SIZE OF PIPE) **WATER TIGHT**

LAMPHOLE/CLEANOUT IN PAVEMENT/SIDEWALK

FRAME OD + 2'

LAMPHOLE/CLEANOUT IN LAWN/FIELD AREAS NOT TO SCALE

FILTER FABRIC TO BE NON-WOVEN CLASS 'C'.

SUBMITTAL SPECIFICATION FOR REVIEW AND

NOTE: PLANTING SOIL SHALL BE LOAM/SAND MIX CONTAINING A MINIMUM

OF 35 TO 60% SAND BY VOLUME AND LESS THAN 25% CLAY. SOIL SHOULD

FALL WITHIN USCS TYPES SM OR ML WITH PERMEABILITY OF AT LEAST 0.5

FEET PER DAY. SOIL SHOULD BE FREE FROM STONES, STUMPS, ROOTS OR

PLANTING SOIL SHOULD BE IN LIFTS OF 12" TO 18", LOOSELY COMPACTED.

OTHER WOODY MATERIAL OVER 1" IN DIAMETER. PLACEMENT OF THE

APPROVAL PRIOR TO CONSTRUCTION.

MIRAFI 180-N OR APPROVED EQUIVALENT

MONTHS MIN.

NO.67, SIZE 0.25" TO 0.75"

CHARACTERISTICS SHALL BE:

MAGNESIUM: 35 LBS PER ACRE MIN.

POTASSIUM: 85 LBS PER ACRE MIN.

PHOSPHORUS: 75 LBS PER ACRE MIN.

ORGANIC MATTER: 1.5 - 4.0%


SOLUBLE SALTS: 500 PPM

PH RANGE: 5.2 - 7.00

CLAY: 10 TO 25%

SILT: 30 TO 55%

SAND: 35 TO 60%

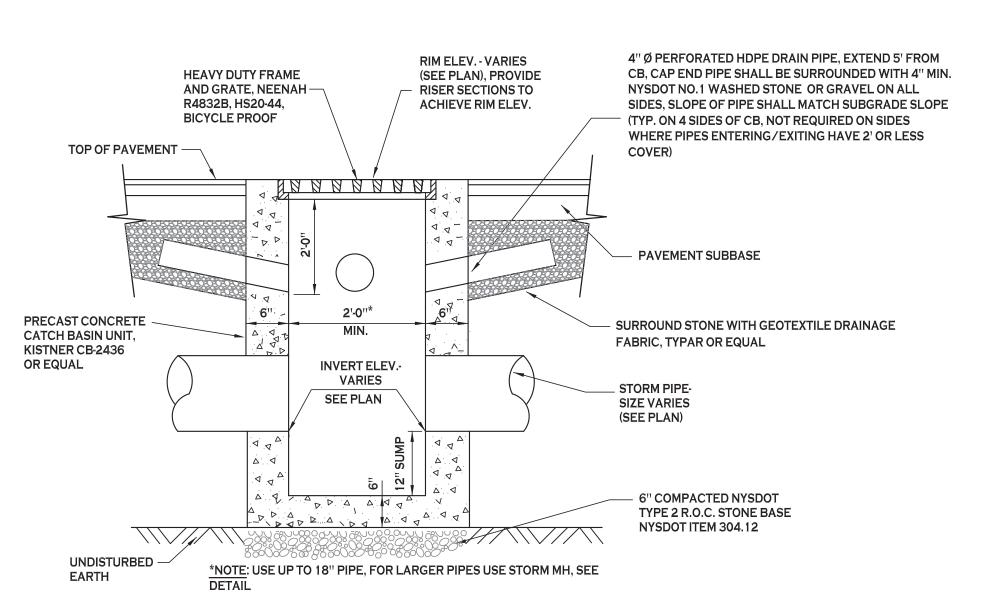

-EXPANSION JOINT

WITH FIBERBOARD

SEE PLANS FOR

SEWER SIZES

- 6" FOR IN-LINE CLEAN-OUT

8" FOR END OF LINE LAMPHOLE

TYPICAL PRECAST CATCH BASIN NOT TO SCALE

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6" Ø PVC OR A SPECIFIED ON PLANS


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Date: Drawn by:

P. Sheedy Scale: As Noted DRAWING NAME:

6/3/19

Storm Drainage Details

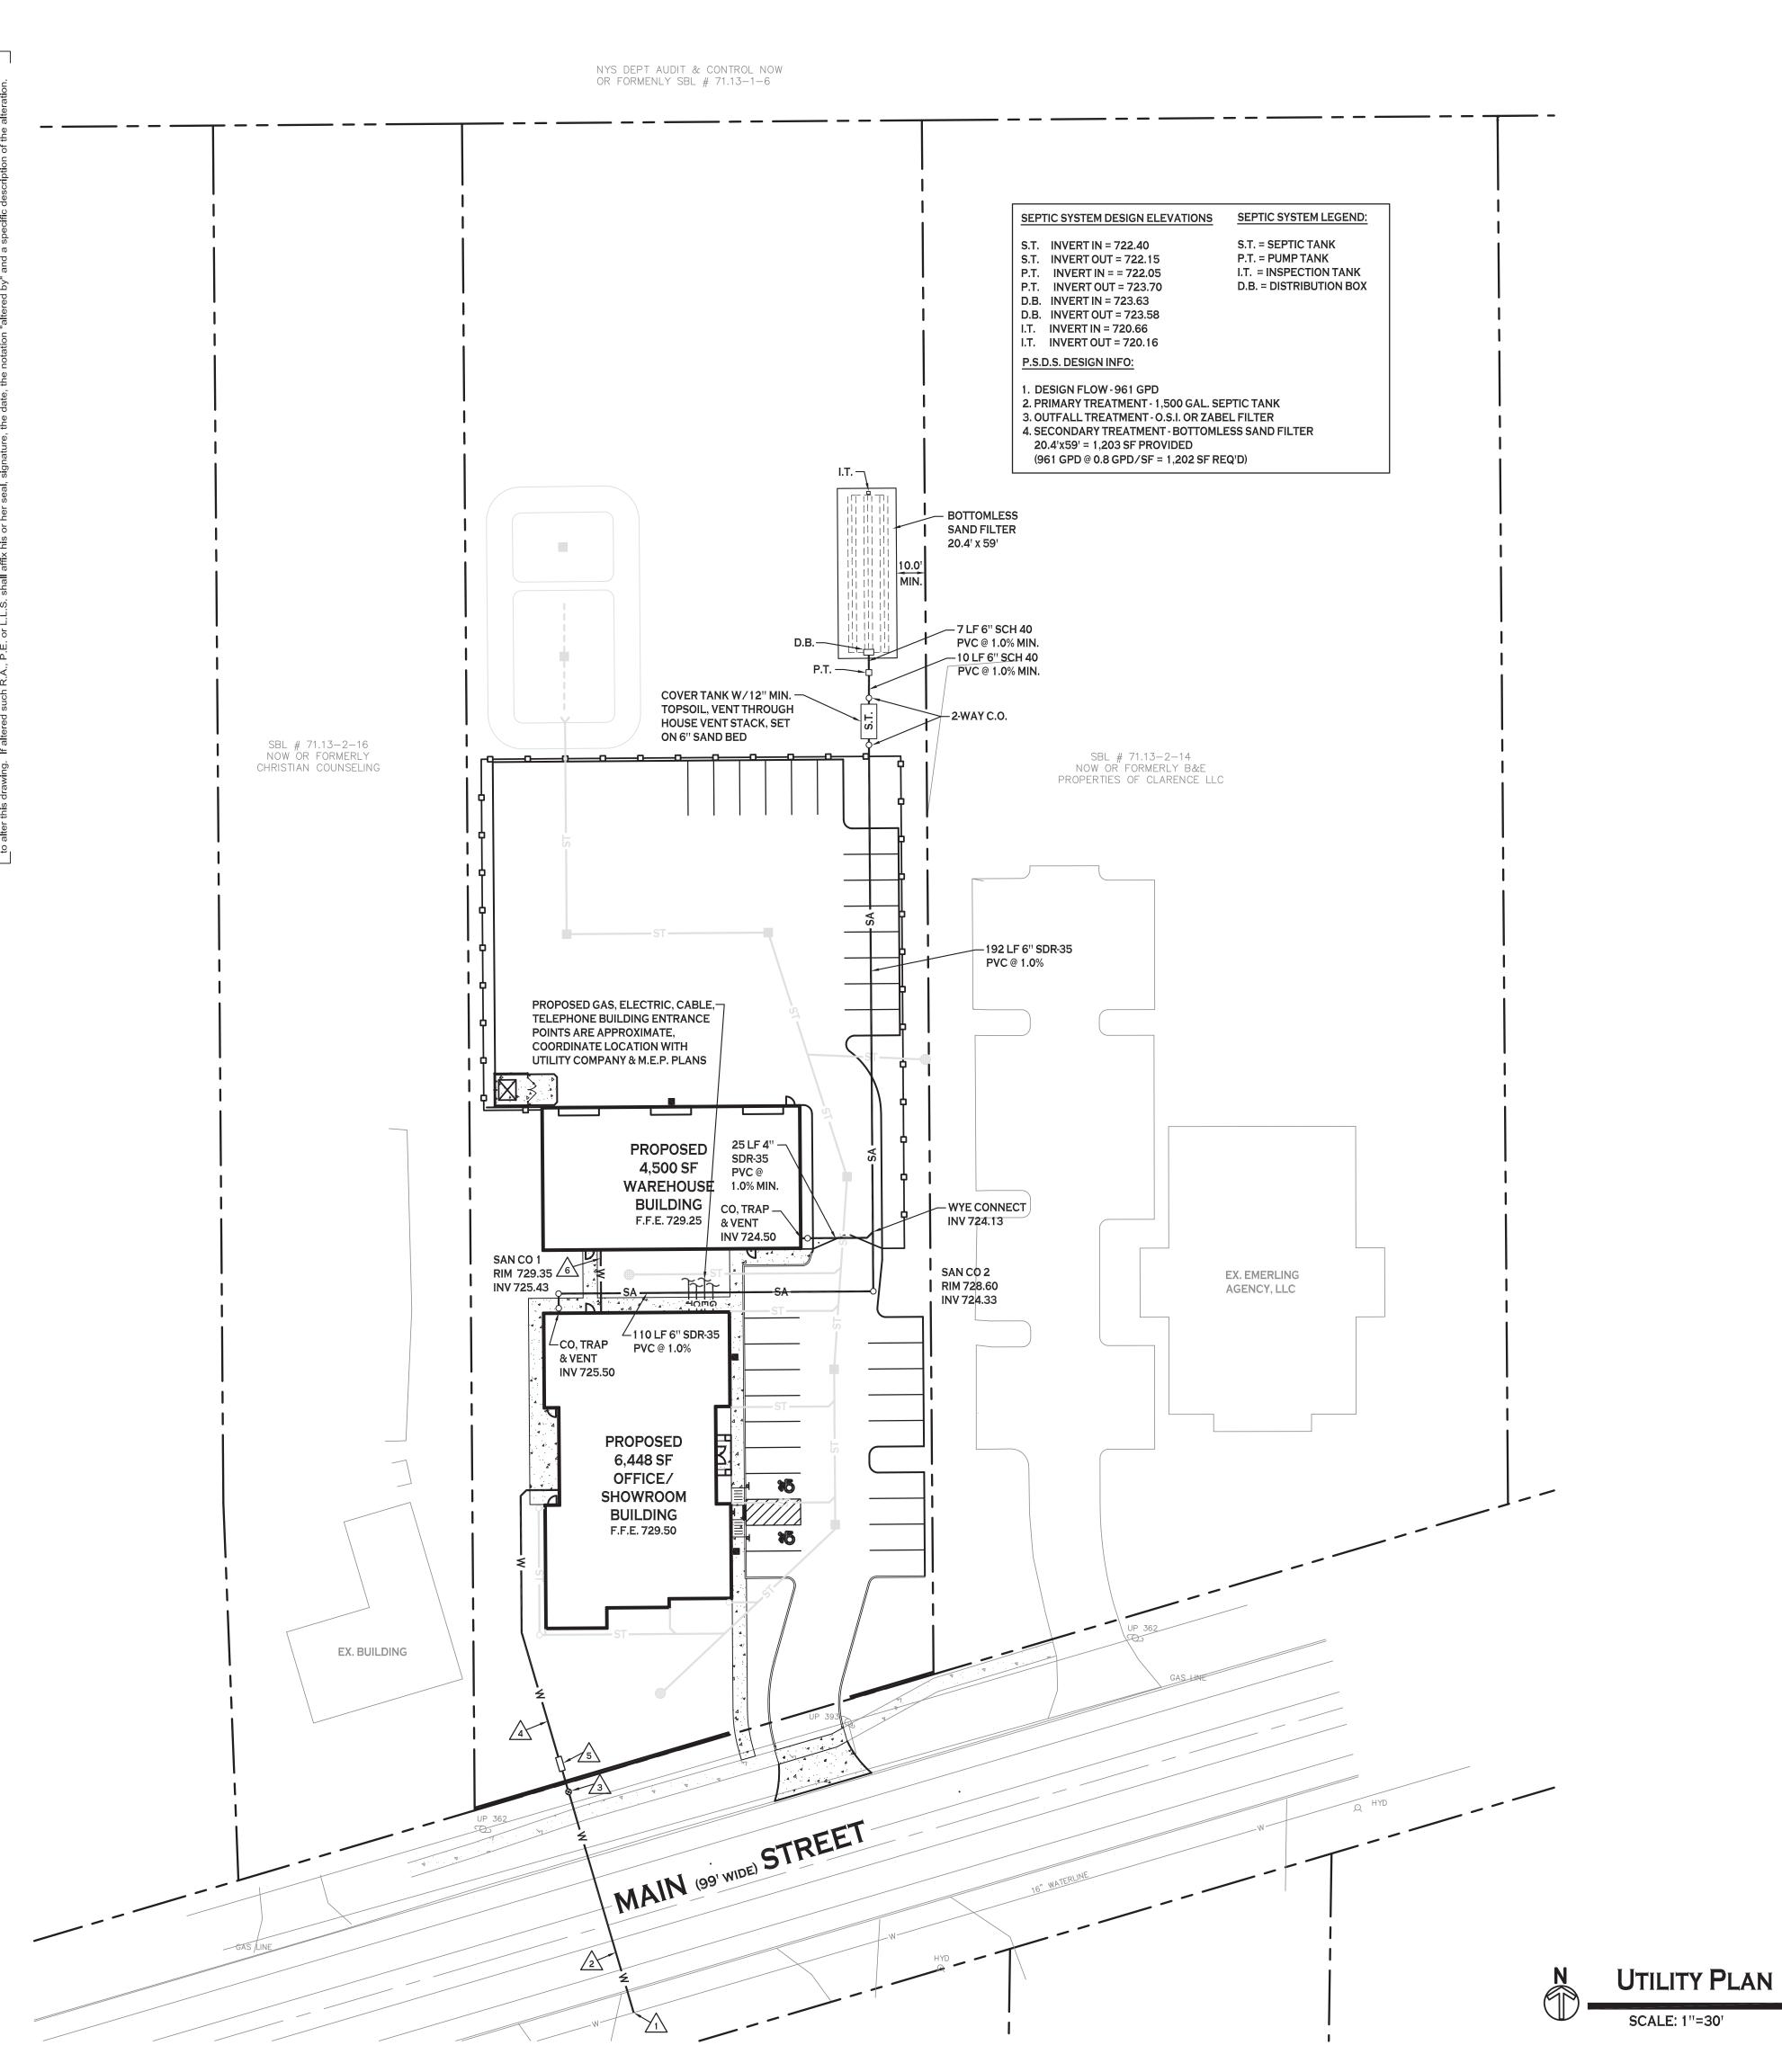

WATER NOTE LEGEND

2" CORP. STOP (BY ECWA)

2" CURB STOP, VALVE & BOX

2" POLYETHYLENE DOMESTIC SERVICE


METER AND RPZ HOT BOX ENCLSOURE SEE DETAIL ON DWG C-401

1" TYPE 'K' COPPER DOMESTIC SERVICE

2" TYPE 'K' COPPER DOMESTIC SERVICE (BY ECWA)


UTILITY NOTES:

- 1. EXISTING WATER, GAS, AND ELECTRIC SHOWN ARE APPROXIMATE. CONTRACTOR TO FIELD VERIFY LOCATION/SIZE/CONDITION BEFORE CONSTRUCTION.
- 2. SELECT BACKFILL IS REQUIRED FOR ALL UTILITIES (GAS, WATER, STORM, SANITARY) THAT CROSS THROUGH PAVEMENT AREAS.
- 3. IF NECESSARY, PROVIDE FITTINGS AND BLOCKING AS NECESSARY AT ALL BENDS IN WATER LINES.
- 4. A MINIMUM OF 10 FEET HORIZONTAL AND 18 INCHES OF VERTICAL SEPARATION MUST BE MAINTAINED BETWEEN ALL SANITARY SEWER AND WATER SERVICES.
- 5. ERIE COUNTY WATER AUTHORITY IS TO BE NOTIFIED A MINIMUM OF 48-HOURS PRIOR TO STARTING THE CONNECTION FOR THE NEW WATER
- 6. ALL SANITARY SEWER CONSTRUCTION SHALL ADHERE TO ERIE COUNTY DIVISION OF SEWERAGE MANAGEMENT SPECIFICATIONS AND DETAILS, AND ERIE COUNTY DEPARTMENT OF HEALTH RULES AND REGULATIONS.
- 7. ALL OTHER REQUIRED PERMITS BY THE STATE OF NEW YORK, ERIE COUNTY, OR TOWN OF CLARENCE ARE THE RESPONSIBILITY OF THE CONTRACTOR.

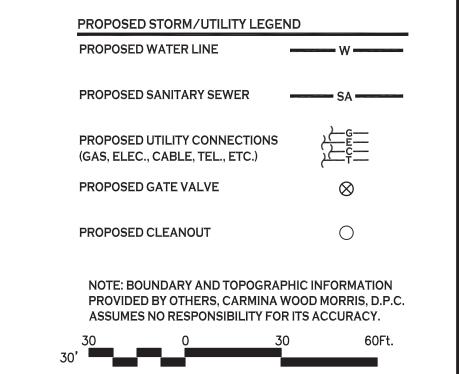

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487 Main Street Suite 500

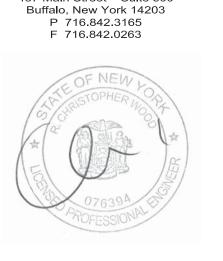

uilding

Drawn by:

P. Sheedy As Noted Scale:

8/20/19

DRAWING NAME: **Utility Plan**

NOTES:

A. PIPE INSTALLATION SHALL BE IN ACCORDANCE WITH MANUFACTURERS RECOMMENDATIONS.

B. TRENCHING OPERATIONS SHALL INCLUDE ALL NECESSARY DEWATERING.

DETECTABLE TAPE

1'-6" BELOW FINISHED GRADE

- C. TRENCH DETAILS ARE ONLY SHOWN FOR PURPOSES OF MATERIAL PLACEMENT AND MAXIMUM PAY LIMITS.
- D. AN OSHA APPROVED MOVABLE PROTECTIVE TRENCH SHIELD SHALL BE USED IN ALL UNSHEETED TRENCH AREAS.

MATERIALS

PIPE BEDDING MATERIAL (NYSDOT 1985 EDITION)

1 NO. 1 CRUSHED STONE OR CRUSHED GRAVEL WITH A GRADATION CONFORMING WITH NYSDOT SECTION 703-02. THE MATERIAL SHALL BE WELL GRADED WITH NO PARTICLES LARGER THAN ONE INCH AND HAVING A MAXIMUM GRADATION MEETING THE LIMITS DESCRIBED IN THE SPECIFICATIONS. THE BEDDING SHALL BE COMPACTED IN 6" LIFTS WITH EQUIPMENT ACCEPTABLE TO THE PIPE MANUFACTURER.


NO SLAG SHALL BE ALLOWED FOR MATERIAL (1)

TYPE 2 CRUSHED STONE OR CRUSHED GRAVEL WITH A GRADATION CONFORMING WITH NYSDOT SECTION 304-2.02 TYPE 2. THE MATERIAL SHALL BE WELL GRADED WITH NO PARTICLES LARGER THAN TWO INCHES AND HAVING A MAXIMUM GRADATION MEETING THE LIMITS DESCRIBED IN THE SPECIFICATIONS. THE BEDDING SHALL BE COMPACTED IN 6" LIFTS WITH EQUIPMENT ACCEPTABLE TO THE PIPE MANUFACTURER.

NO SLAG SHALL BE ALLOWED FOR MATERIAL (2)

SEWER/WATERLINE TRENCH SECTION IN PAVED AREAS

NOT TO SCALE

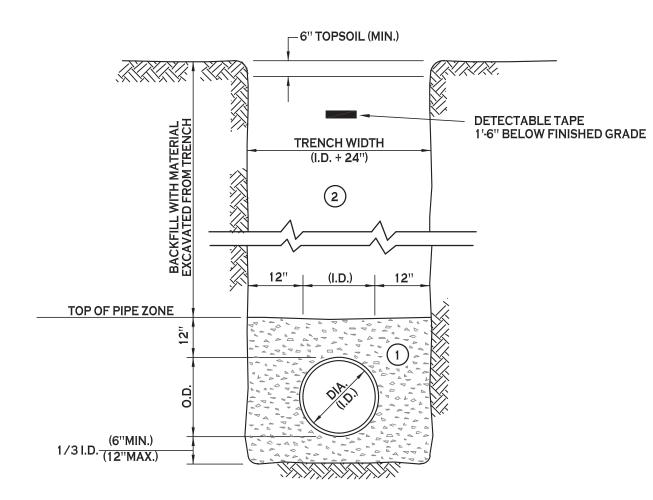

NOTES:

- A. PIPE INSTALLATION SHALL BE IN ACCORDANCE WITH MANUFACTURERS RECOMMENDATIONS.
- B. TRENCHING OPERATIONS SHALL INCLUDE ALL NECESSARY DEWATERING.
- C. TRENCH DETAILS ARE ONLY SHOWN FOR PURPOSES OF MATERIAL PLACEMENT AND MAXIMUM PAY LIMITS.
- D. AN OSHA APPROVED MOVABLE PROTECTIVE TRENCH SHIELD SHALL BE USED IN ALL UNSHEETED TRENCH AREAS.

MATERIALS

PIPE BEDDING MATERIAL (NYSDOT 1985 EDITION)


1 NO. 1 CRUSHED STONE OR CRUSHED GRAVEL WITH A GRADATION CONFORMING WITH NYSDOT SECTION 703-02. THE MATERIAL SHALL BE WELL GRADED WITH NO PARTICLES LARGER THAN ONE INCH AND HAVING A MAXIMUM GRADATION MEETING THE LIMITS DESCRIBED IN THE SPECIFICATIONS. THE BEDDING SHALL BE COMPACTED IN 6" LIFTS WITH EQUIPMENT ACCEPTABLE TO THE PIPE MANUFACTURER.


NO SLAG SHALL BE ALLOWED FOR MATERIAL (1)

BACKFILL MATERIAL SHALL BE NATIVE SOIL CONTAINING NO UNSUITABLE MATERIAL COMPACTED IN 6" LIFTS.

SEWER/WATERLINE TRENCH SECTION IN UNPAVED AREAS

NOT TO SCALE

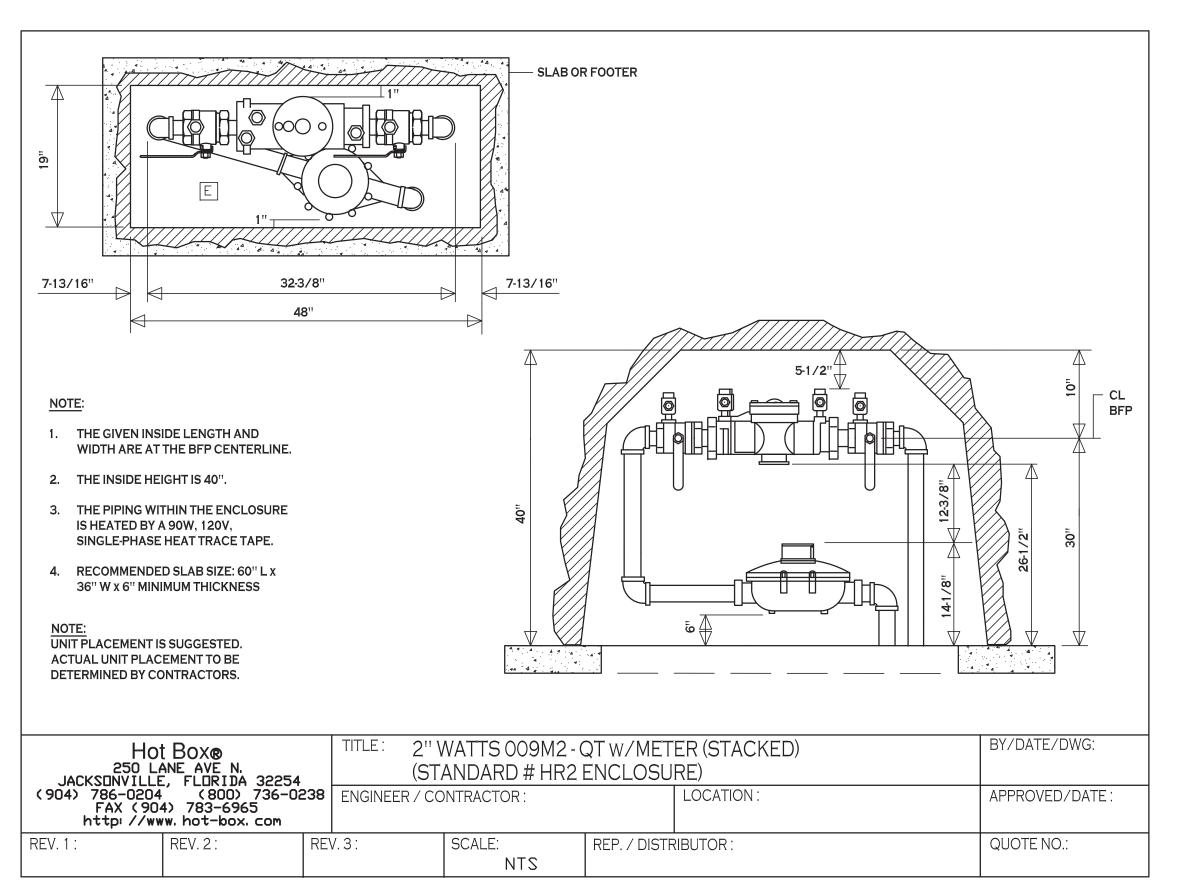

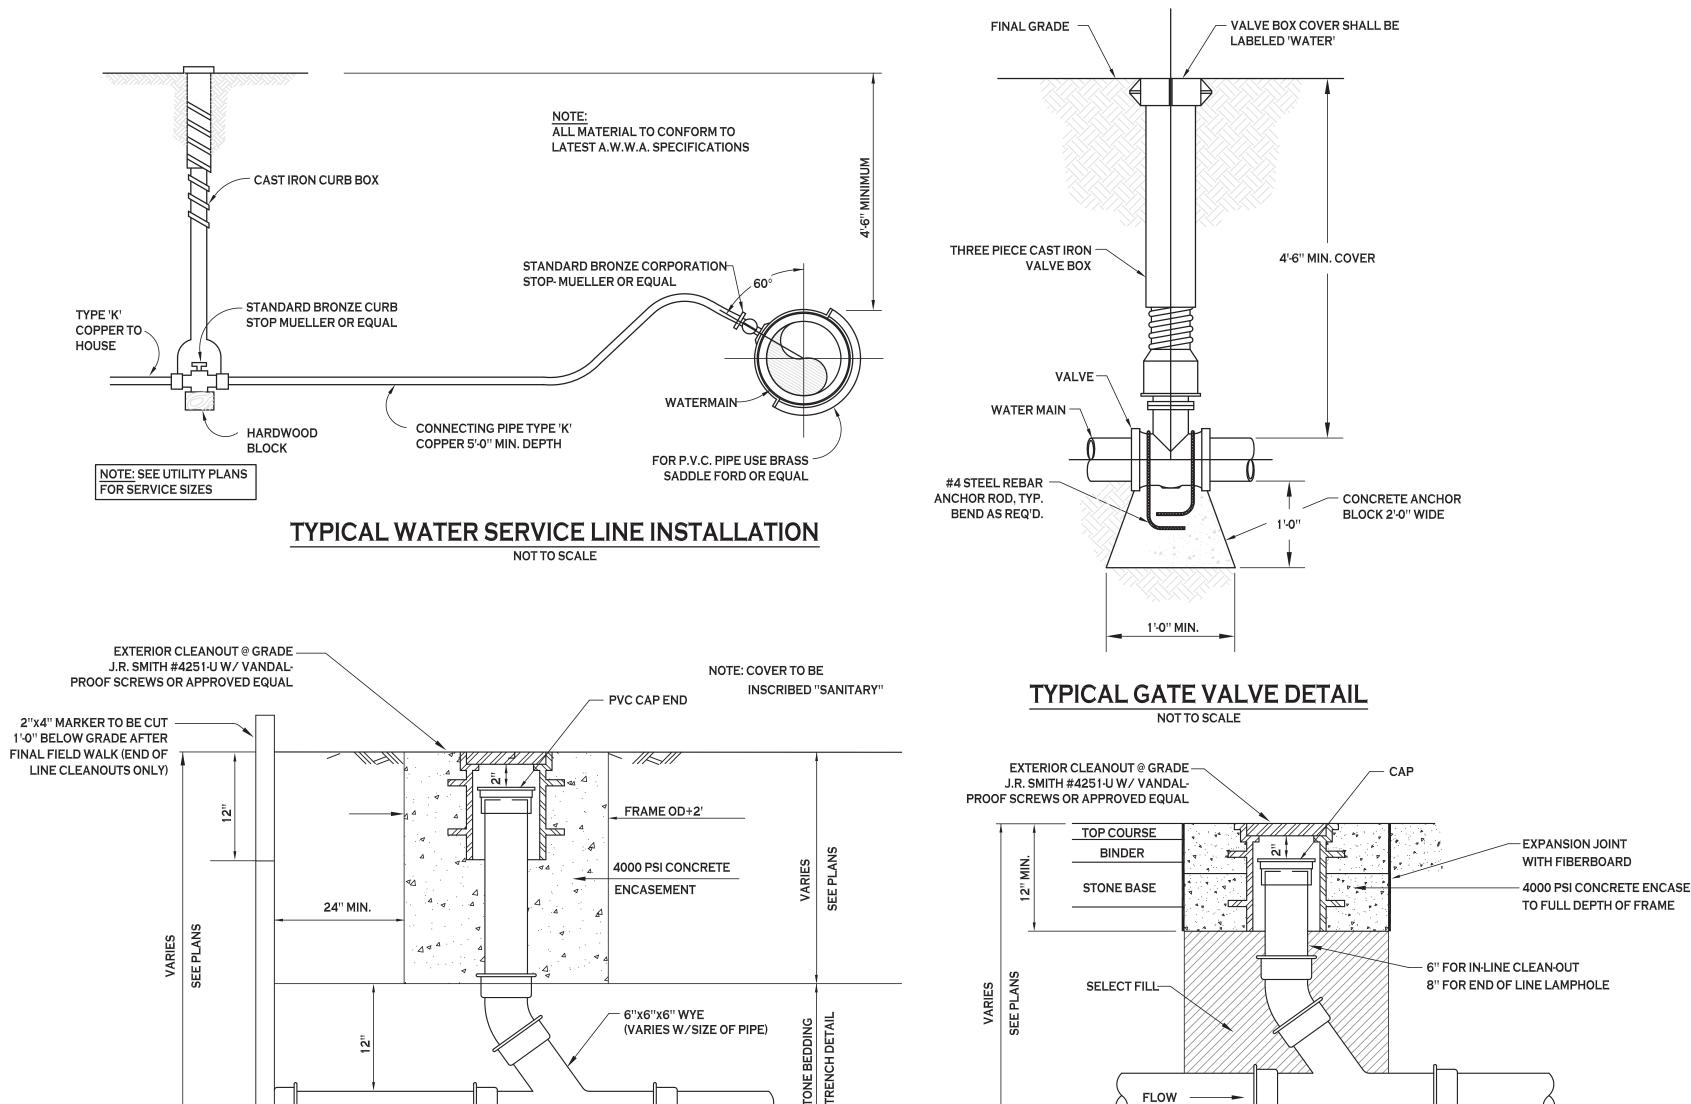

6" Ø PVC OR A SPECIFIED ON PLANS

LAMPHOLE/CLEANOUT IN LAWN/FIELD AREAS
NOT TO SCALE

WATER TIGHT

(END OF LINE CLEANOUTS ONLY)

PVC END CAP

FLOW ----

LAMPHOLE/CLEANOUT IN PAVEMENT/SIDEWALK
NOT TO SCALE

FRAME OD + 2'

SEE PLANS FOR SEWER SIZES





Morris

487 Main Street Suite 500

Buffalo, New York 14203

/ISIONS:
Description
Date

& Warehouse Buildings

New Construction

Date:
Drawn by:


Drawn by: P. Sheedy As Noted

DRAWING NAME:


8/20/19

Utility Details

DRAWING NO.

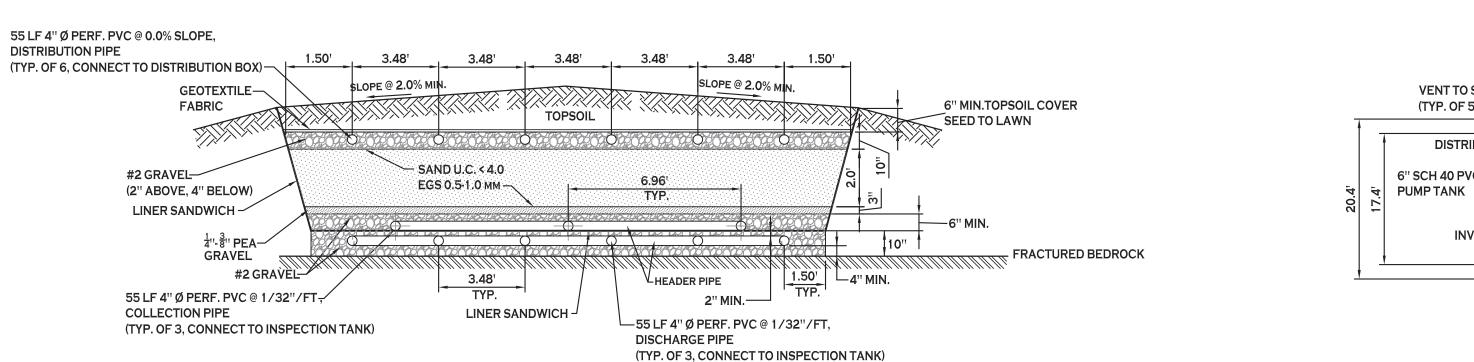

SAND FILTER CROSS SECTION A-A

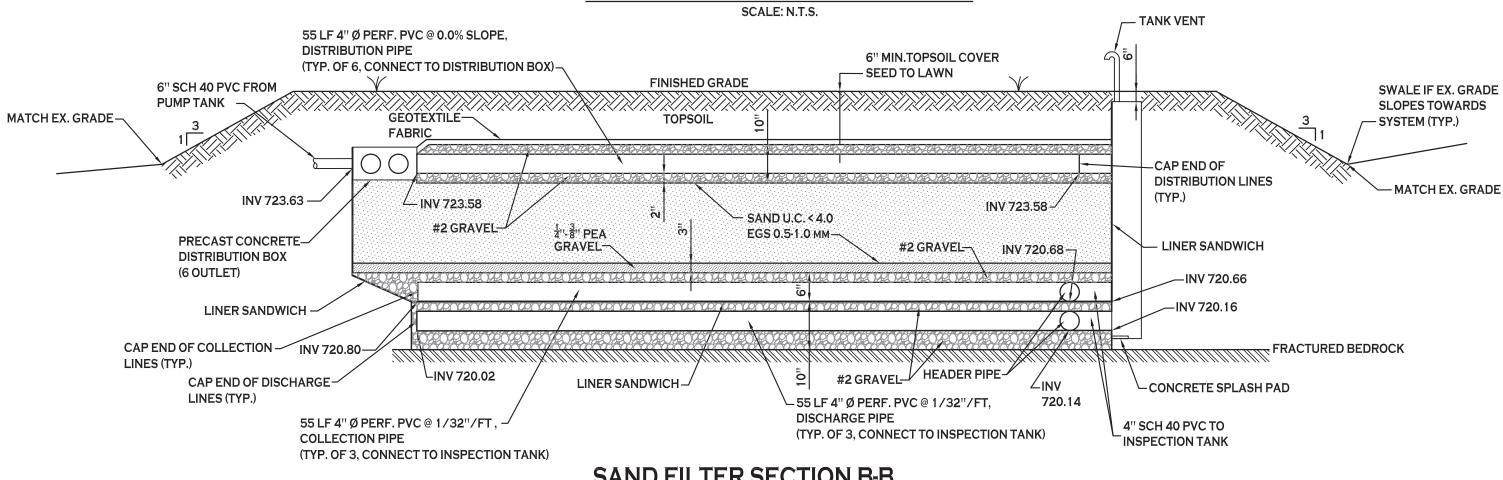

SAND FILTER PLAN

SCALE: 1"=10"

4" Ø PERF. PVC @ 1/32"/FT UNDERDRAINS

(TYP. OF 3, CONNECT TO INSPECTION TANK)

4" Ø PERF. PVC →

UNDERDRAINS

4" Ø PERF. PVC DIST. LINES -

SAND FILTER NOTES:

VENT TO SURFACE -

DISTRIBUTION BOX-

INV IN 723.63 -

(TYP. OF 5)

6" SCH 40 PVC FROM -

1. ALL SAND SHALL BE UNIFORM COARSE TO MEDIUM SAND (< 4% PASSINF #200 SIEVE), ALL PASSING 1/4 INCH SIEVE, HAVE A EFFECTIVE GRAIN SIZE (EGS) BETWEEN 0.25 - 1.00 mm, AN UNIFORMITY COEFFICIENT (UC) <= 4.

4" Ø PERF. PVC DISTRIBUTION LINES @ 0.0% SLOPE

(TYP. OF 6, CONNECT TO

DISTRIBUTION BOX)

_CAP END OF DISTRIBUTION

►ENDS OF UNDERDRAIN TO

BE CONNECTED

LINES (TYP.)

-INSPECTION

- INV 720.66

- 2. SEAL PENETRATIONS AND SEAMS OF LINER SANDWICH WATER TIGHT.
- 3. TOP OF SAND FILTER SHALL BE SLOPED TO DRAIN, AREAS AROUND THE FILTER SHALL BE GRADED TO DIVERT WATER AWAY.
- 4. ALL HEAVY EQUIPMENT SHALL BE KEPT OFF THE SAND FILTER AREA FOLLOWING CONSTRUCTION.
- 5. DEPENDING ON DEPTH OF HIGH WATER MARK OR BEDROCK OR THE EXISTING TOPOGRAPHY, THE ENTIRE FILTER MAY BE ADJUSTED UP OR DOWN. ALL REQUIRED CLEARANCES AND MINIMUM SLOPES MUST BE MAINTAINED. IF ADJUSTMENTS ARE MADE TO THE FILTER, THE


SAND FILTER SECTION B-B SCALE: N.T.S.

ERIE COUNTY HEALTH DEPARTMENT NOTES

- 1. THE EXCAVATED ROCK AREA MUST BE TESTED FOR ROCK INFILTRATION CAPACITY BY DISCHARGING A GARDEN HOSE RUNNING AS FULL AS POSSIBLE FOR A MINIMUM OF 30 MINUTES. WATER SHALL NOT ACCUMULATE. OR, IF THE ABOVE IS NOT POSSIBLE, FILL THE EXCAVATION WITH 2" OF HAULED WATER AND RECORD THE DRAINAGE RATE, WHICH MUST BE 30 MINUTES OR LESS TO DROP 1 INCH. AN EFFORT MUST BE MADE TO CLEAR SUFFICIENT DEBRIS TO OBSERVE BEDROCK SURFACE OVER THE EXTENT OF THE EXCAVATION.
- 2. SAND FILTER TO BE SIZED AS NORMAL EXCEPT THAT 0.8 GPD/SF APPLICATION RATE
- 3. THE DOWNSTREAM ABSORPTION SYSTEM (DISCHARGE LINES) WILL BE CONSTRUCTED BENEATH THE SAND FILTER AS SHOWN IN THE SECTION.
- 4. MINIMUM OF 4" OF #2 GRAVEL SHALL BE PLACED BETWEEN THE EXCAVATED BEDROCK AND DISCHARGE LINES. A MINIMUM OF 2" OF #2 GRAVEL SHALL BE PLACED ON TOP OF THE DISCHARGE LINES PER THE SECTION.
- 5. THE SAND FILTER MUST BE LINED WITH THE "LINER SANDWICH" CONSTRUCTED BETWEEN THE DOWNSTREAM ABSORPTION SYSTEM AND THE SAND FILTER AS FOLLOWS:
- TOP LAYER: NON-WOVEN GEOTEXTILE TERRATEX 4.5 OR APPROVED EQUAL - 6 MIL. POLYETHYLENE - 6 MIL. POLYETHYLENE
- BOTTOM LAYER: NON-WOVEN GEOTEXTILE TERRATEX 4.5 OR APPROVED EQUAL


7. PIPE INTRUSIONS - USE FERNCO COUPLINGS OR APPROVED EQUAL.

- 6. SLOPE LINER AT OUTSIDE EDGES TOWARDS THE COLLECTION LINES TO CHANNEL WATER TO COLLECTORS.
- 8. INSPECTION TANK VENT PIPE SHALL BE OPEN GRATED AND EXPOSED TO THE ATMOSPHERE AT ALL TIMES. CAPPING OR BURYING THE VENT COULD RESULT IN A FINE. OPEN GRATE VENT PIPE MUST BE A MINIMUM OF $\frac{1}{2}$ " ABOVE THE GROUND SURFACE.
- 9. THE TOP ON THE INSPECTION TANK MUST BE LOCATED A MAXIMUM OF 3" BELOW GRADE. IF AT OR ABOVE GRADE, A LOCKABLE COVER SHALL BE PROVIDED.

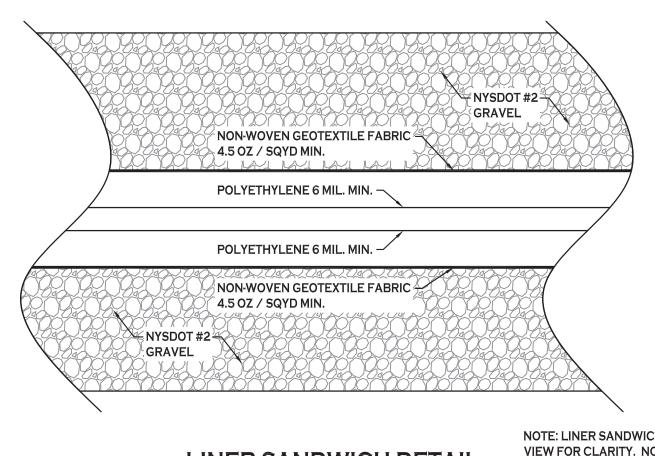


LINER SANDWICH DETAIL


NOTE: LINER SANDWICH EXPLODED VIEW FOR CLARITY. NO VOID SPACE SHALL BE PERMITTED BETWEEN

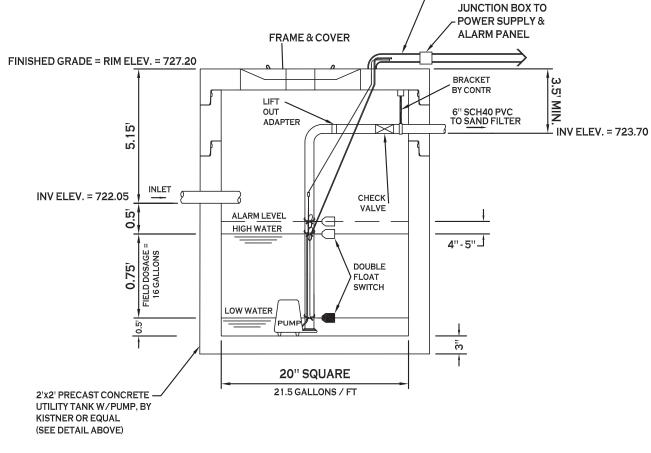

PUMP TANK NOT TO SCALE

- 1. ALL PUMP SYSTEMS SHALL BE SUPPLIED & INSTALLED COMPLETE WITH ALL NECESSARY ELECTRICAL DEVICES, CONTROLS AND AUDIO/VISUAL
- 2. 2. TANKS SHALL HAVE EXTERIOR BITUMASTIC COATING.
- 3. INSTALL OSHA APPROVED STAIRS IN TANK IN LOCATION THAT DOES NOT INTERFERE WITH PUMP OPERATION.
- 4. PUMP CONTROL PANEL TO BE INSTALLED ON PRESSURE TREATED POST OR
- IN OTHER LOCATION WHERE VISIBLE, COORDINATE WITH OWNER.
- 5. THE PUMP SHALL BE INSTALLED IN A 2' x 2' INSPECTION TANK WITH THE FLOATS SET PER THE DETAIL SHOWN. THE ACCESS HATCH SHALL BE EXTENDED TO BE FLUSH WITH FINISHED GRADE.

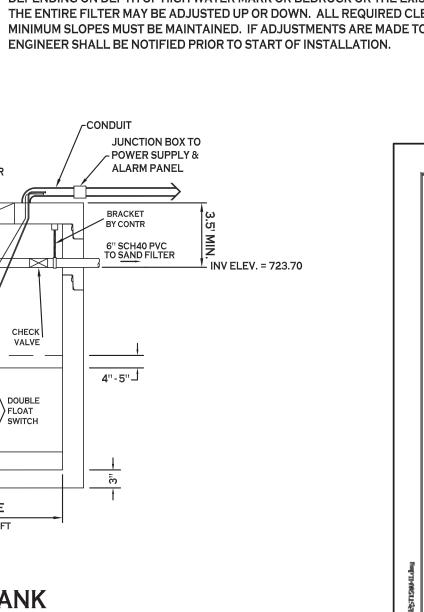

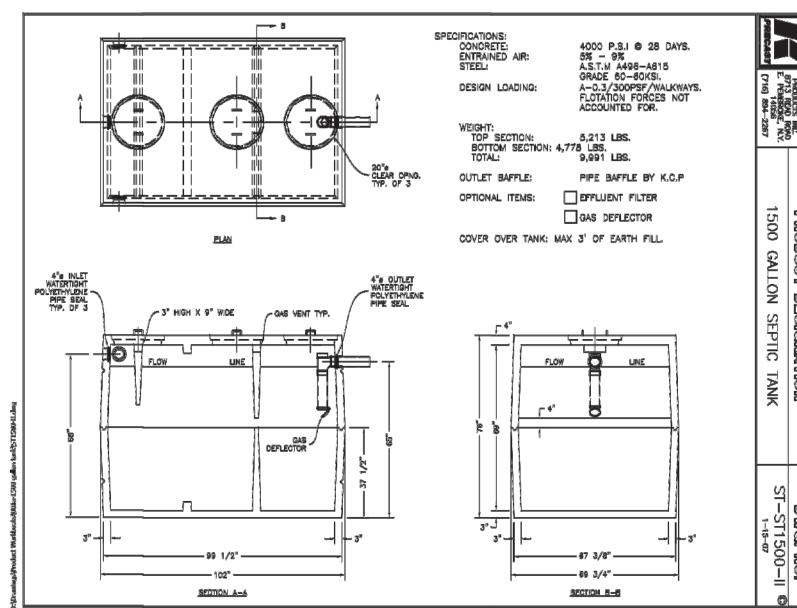

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Buffalo, New York 14203


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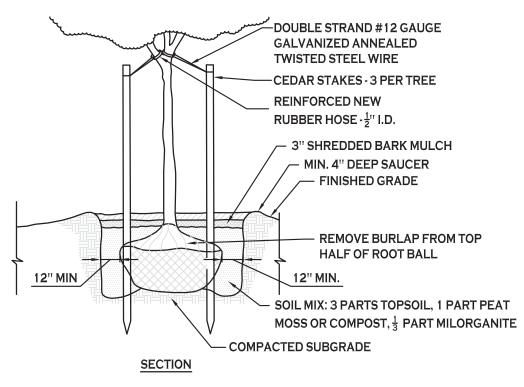


P. Sheedy Scale: As Noted


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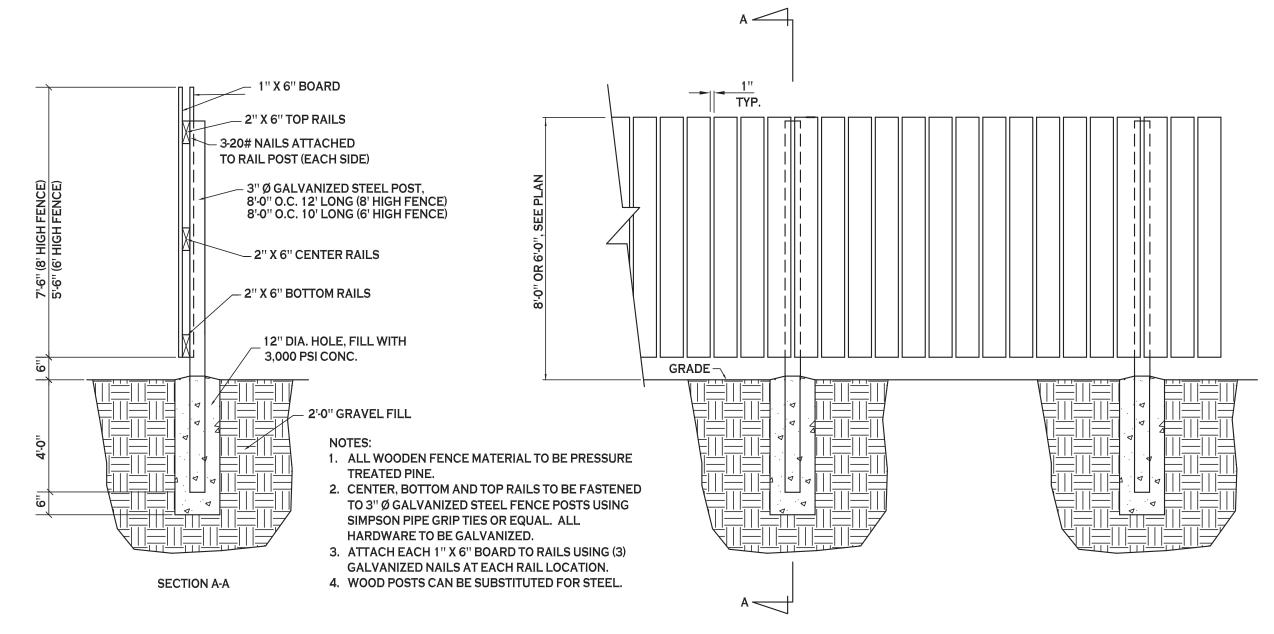
SHRUB PLANTING DETAIL



TREE PLANTING DETAIL

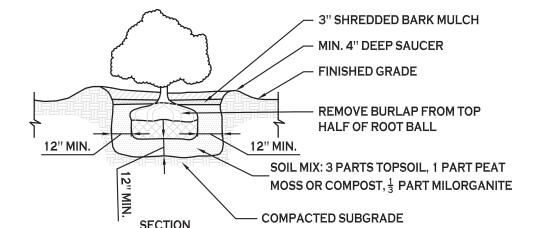

STONE WALL DETAIL NOT TO SCALE

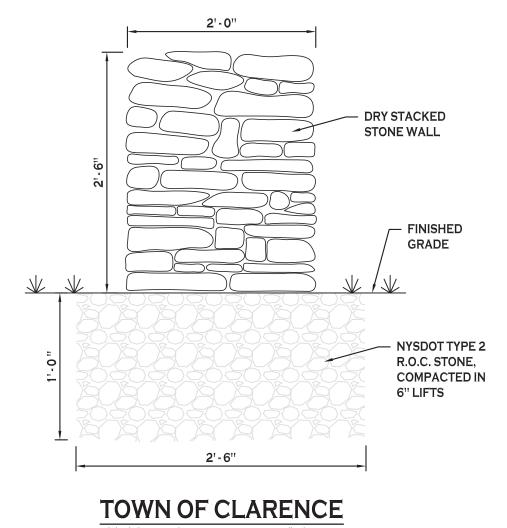

BOARD ON BOARD FENCE

NOT TO SCALE


PLANTING SCHEDULE - PROPOSED OFFICE & WAREHOUSE BLDG / 9074 MAIN STREET, CLARENCE

KEY	QTY.	BOTANICAL NAME	COMMON NAME	MIN. SIZE	REMARKS
		DECIDUOUS TREES			
AF	9	ACER x FREEMANII "JEFFERSRED"	AUTUMN BLAZE MAPLE	2.5" - 3" CAL.	B&B
BN	3	BETULA NIGRA 'CULLY'	HERITAGE BIRCH	10'-12' HIGH	B&B, MULTI-STEM
NS	3	NYSSA SYLVATICA 'WILDFIRE'	WILDFIRE BLACK GUM	2 1/2" - 3" CAL	B&B
		SMALL/ORNAMENTAL TREES			
AC	3	AMELANCHIER CANADENSIS	SERVICEBERRY	8' - 10' HIGH	B&B MULTI-STEM
AG	3	AMELANCHIER GRANDIFLORA "AUTUMN BRILLIANCE"	AUTUMN BRILLIANCE SERVICEBERRY	1-3/4" - 2" CAL.	B&B
MP	3	MALUS X 'PRAIRIFIRE'	PRAIRFIRE CRABAPPLE	1 3/4" - 2" CAL.	B&B
		EVERGREEN TREES			
PG	10	PICEA GLAUCA	WHITE SPRUCE	5' – 6' HT.	B&BFULL TO GROUND
PP	3	PICEA PUNGENS 'GLAUCA'	COLORADO BLUE SPRUCE	5' – 6' HT.	B&BFULL TO GROUND
		SHRUBS			
DS	16	DIERVILLA SPLENDENS 'G2X885411'	KODIAK RED DIERVILLA	18" HIGH MIN.	5 GAL. CONT.
JP	27	JUNIPERUS X PFITZERIANA 'SAYBROOK GOLD'	SAYBROOK GOLD JUNIPER	18" HIGH MIN.	5 GAL. CONT.
		PERENNIALS			
SN	10	SALVIA × NEMEROSA 'BALYRICLU'	LYRICAL BLUE MEADOW SAGE	NO.2 CONT.	

PLANTING NOTES:

- 1. ALL PLANTING BEDS AND TREES SHALL RECEIVE A MINIMUM 3-INCH DEPTH OF SHREDDED HARDWOOD BARK
- 2. ALL SHRUBS SHOULD BE ALLOWED TO GROW FOR AT LEAST TWO YEARS PRIOR TO PRUNING; AFTER TWO YEARS PRUNE ONLY AS NECESSARY AND SELECTIVELY PRUNE TO MAINTAIN SHAPE - DO NOT SHEAR INTO UNNATURAL SHAPES.



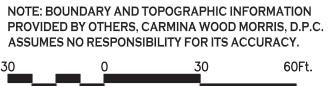



Wood Morris^b 487 Main Street Suite 500



ROBERT C. WALTER, RLA REGISTERED LANDSCAPE ARCHITECT MEMBER AMERICAN SOCIETY OF LANDSCAPE ARCHITECTS 2765 DODGE ROAD, EAST AMHERST, NY 14051-2113 PHONE: 716-364-5564

RCWLANDSCAPEARCHITECT@GMAIL.COM

Scale:

Drawn by:

8/20/19


P. Sheedy As Noted DRAWING NAME:


Landscape Plan


DRAWING NO.

Luminaire Schedule Description
WH4-120NACT4S_P_ 15' MOUNT HEIGHT Label Symbol Qty

LIGHTING PLAN SCALE: 1"=30"

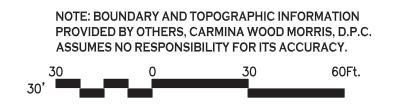

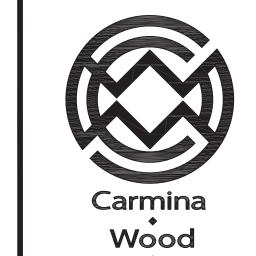

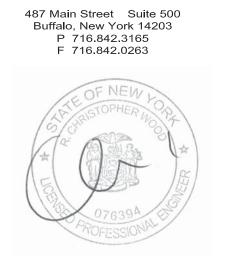

Morris

Buildings

Date: Drawn by: Scale:

8/20/19 P. Sheedy As Noted

DRAWING NAME:

Lighting Plan

DRAWING NO.

TYPE 3 BARRICADE — W/LIGHTS, TYP. CONSTRUCTION -

SIDEWALK

- SIDEWALK DETOUR TO BE USED WHEN CONSTRUCTION ACTIVATES IMPACT EXISTING PEDESTRIAN FACILITIES ALONG THE STATE HIGHWAY.
- 2. TEMPORARY SIDEWALK SHALL BE SMOOTH, CONTINUOUS HARD SURFACE WITH NO ABRUPT CHANGES IN GRADE OR TERRAIN THAT COULD CAUSE TRIPPING OR BE A BARRIER TO WHEELCHAIR USE. THE GEOMETRY AND ALIGNMENT OF THE FACILITY SHALL MEET THE APPLICABLE REQUIREMENTS OF THE "AMERICANS WITH DISABILITIES ACT ACCESSIBILITY GUIDELINES FOR BUILDINGS AND FACILITIES (ADAAG)."

TEMPORARY SIDEWALK DETOUR

NOT TO SCALE

ALLOW ACCESS TO PRIVATE

DRIVEWAYS AT ALL TIMES

DURING CONSTRUCTION

SBL # 71.13-2-16 NOW OR FORMERLY CHRISTIAN COUNSELING

4,500 SF WAREHOUSE

BUILDING

OFFICE/

BUILDING

SHOWROOM

NOTE: WORK PERFORMED WITHIN THE NYSDOT R.O.W. MUST BE DONE FROM THE PROPERTY. IF WORK PROTRUDES INTO THE R.O.W. BEYOND THE LIMITS OF THE SHOULDER LANE, A RIGHT LANE CLOSURE MUST BE IMPLEMENTED BASED ON NYSDOT STANDARD SHEET 619-30.

DESIGN IS BASED ON NYSDOT STANDARD SHEET 619-22 FOR SHOULDER HIGHWAY CLOSURE

SCALE: 1"=50"

MAINTENANCE & PROTECTION OF TRAFFIC PLAN

(36"x36")

(36" x 18")

STATUS ENVI.

LICENSE.
SUSTRICED
AFTER TWO
WORK ZONE
STEEDING
TICKETS

G20-2

6. THE DIMENSIONS OF WORK ZONE TRAFFIC CONTROL SIGNS ARE DESCRIBED IN THE MUTCD. ANY CHANGES TO THE DIMENSIONS SHALL BE APPROVED BY THE REGIONAL DIRECTOR OR BY HIS/HER DESIGNEE.

7. NYR9-12 MAY BE USED IN PLACE OF THE NYR9-11.

GENERAL NOTES:

ACTIVITY AREA:

MANUAL OF UNIFORM TRAFFIC CONTROL DEVICES (MUTCD), THE

CURRENT STATE OF NEW YORK SUPPLEMENT, NYSDOT STANDARD

SPECIFICATIONS, NYSDOT STANDARD SHEETS AND NYSDOT WORK

PROPOSED REVISIONS TO THE TRAFFIC CONTROL PLAN FOR REVIEW

AND APPROVAL BY THE REGIONAL DIRECTOR OR HIS/HER DESIGNEE

SUCH PROPOSED REVISIONS, EXCEPT FOR CHANGES THE ALTER THE

FIVE (5) WORK DAYS PRIOR TO THE PLANNED IMPLEMENTATION OF

SCOPE OF THE TRAFFIC CONTROL PLAN. SUCH CHANGES IN SCOPE

REGIONAL DIRECTOR OR HIS/HER DESIGNEE THIRTY (30) WORKING

WITH THE NAMES, ADDRESSES, AND TELEPHONE NUMBERS OF HIS

STAFF WHO ARE AUTHORIZED TO SECURE LABOR, MATERIALS, AND

EQUIPMENT FOR EMERGENCY REPAIRS OUTSIDE NORMAL WORKING

INFORMATION TO REGIONAL MANAGEMENT, THE NEW YORK STATE

BETWEEN THE HOURS OF 6AM TO 9AM AND 3PM TO 6PM. THESE TIME

RESTRICTIONS INCLUDE THE SET UP AND TAKE DOWN OF WORK

MUST BE SUBMITTED TO THE ENGINEER FOR APPROVAL BY THE

DAYS PRIOR TO THE IMPLEMENTATION OF SUCH REVISIONS.

4. THE CONTRACTOR SHALL PROVIDE THE ENGINEER, IN WRITING,

POLICE, THE RESIDENT ENGINEER, AND THE LOCAL POLICE.

5. NO WORK SHALL TAKE PLACE WITHIN ON THE STATE HIGHWAY

500'LONGITUDINAL DISTANCE BETWEEN CONSTRUCTION

2. WHEN TWO OR MORE AREAS ARE ADJACENT, OVERLAP, OR ARE IN CLOSE PROXIMITY, THE CONTRACTOR SHALL ENSURE THERE

ARE NO CONFLICTING SIGNS AND THAT LANE CONTINUITY IS

1. THE LOCATIONS OF THE SIGNS SHOWN ON THE WORK ZONE TRAFFIC

2. ANY EXISTING SIGNS, INCLUDING OVERHEAD SIGNS, WHICH CONFLICT WITH THE TEMPORARY TRAFFIC CONTROL SIGN LAYOUT SHALL BE

COVERED, REMOVED, STORED OR RESET, AS APPROVED BY THE

3. SINGS AT OR NEAR INTERSECTIONS SHALL BE PLACED SO THAT THEY

4. ALL WARNING AND REGULATORY SIGNS SHALL BE POSTED ON BOTH

5. SIGNS MOUNTED ON THE MEDIAN OF DIVIDED HIGHWAYS WHERE

SIDES OF MULTI-LANE DIVIDED HIGHWAYS, MULTI-LANE RAMPS, AND

SIDE OF THE ACTIVE TRAVEL LANE, UNLESS OTHERWISE AUTHORIZED

MEDIAN BARRIER IS IN PLACE MAY BE MOUNTED ON THE BARRIER WITH

A SADDLE TYPE BRACKET. LAYING THE SIGN DOWN IN A HORIZONTAL

ONE-WAY STREETS. IN CASES WHERE LANE RESTRICTIONS REDUCE THE TRAVEL LANE TO ONE LANE, SIGNS SHALL BE POSTED ON THE RIGHT

DO NOT OBSTRUCT A MOTORIST'S LINE OF SIGHT.

ENGINEER. ALL APPROPRIATE EXISTING SIGNS SHALL BE RESTORED TO

THEIR ORIGINAL CONDITION AND/OR LOCATION UNLESS OTHERWISE

SIGNS ARE SUBJECT TO THE APPROVAL BY THE ENGINEER.

CONTROL PLANS AND THE DETAILS MAY BE ADJUSTED BASED ON SIGHT DISTANCE AND OTHER CONSIDERATIONS. THE FINAL LOCATIONS OF

OPERATIONS ON ALTERNATE SIDE OF THE ROADWAY, UNLESS

1. THE CONTRACTOR SHALL MAINTAIN A MINIMUM

OTHERWISE APPROVED BY THE ENGINEER.

MAINTAINED THROUGHOUT ALL WORK AREAS.

REPLACED IN THIS CONTRACT.

BY THE ENGINEER.

POSITION IS NOT PERMITTED.

HOURS. THE ENGINEER WILL PROVIDE THE SUBMITTED

2. THE TYPICAL DETAILS DEPICTED ON THE STANDARD SHEETS AND IN

ZONE TRAFFIC CONTROL MANUAL DATED JANUARY 2012.

3. THE CONTRACTOR MUST SUBMIT TO THE ENGINEER, IN WRITING,

THE MUTCD, REFLECT THE MINIMUM REQUIREMENTS.

WORK ZONE TRAFFIC CONTROL GENERAL NOTES (WZTC-P10 - 10 DEC 2008)

- LANE CLOSURES: 1. ALL WORK ZONE TRAFFIC CONTROLS SHALL CONFORM TO THE 2009 THE CONTRACTOR SHALL LOCATE LANE CLOSURES TO PROVIDE OPTIMUM VISIBILITY, I.E. BEFORE CURVES AND
 - 2. THE ENGINEER MAY REQUIRE THAT ALL LANES BE RE-OPENED AT ANY TIME IF THE ROUTE IS NEEDED FOR EMERGENCY PURPOSES. THIS COULD INCLUDE INCIDENTS AT THE LOCATIONS OUTSIDE THE CONTRACT

CRESTS, TO THE EXTENT CONDITIONS PERMIT.

- 1. UNLESS AUTHORIZED BY THE ENGINEER, THE MINIMUM LANE WIDTHS FOR WORK ZONE TRAVEL SHALL BE AS FOLLOWS: FREEWAYS ABND/OR EXPRESSWAYS IS 11'. THE MINIMUM LANE WIDTH FOR ALL OTHERS TYPES OF ROADWAYS IS 10'.
- 2. THE CONTRACTOR SHALL PROVIDE A WRITTEN NOTICE TO THE ENGINEER, A MINIMUM OF 21 CALENDAR DAYS IN ADVANCE OF PERFORMING ANY WORK THAT RESULTS IN THE REDUCED WIDTH OF AN EXISTING ROADWAY, SO THAT THE ENGINEER MAY NOTIFY THE REGIONAL PERMIT ENGINEER IN A TIMELY MANNER.
- 3. WHEN THE MINIMUM LANE WIDTH OF 10' CANNOT BE MAINTAINED DUE TO A SHOULDER CLOSURE, A SINGLE LANE CLOSURE SHOULD BE USED (NYSDOT 619-30 STANDARD SHEET).

BARRIER/SHADOW VEHICLES:

- 1. BARRIER AND SHADOW VEHICLES SHALL BE REQUIRED AS PER STANDARD SHEET TITLED "WORK ZONE TRAFFIC CONTROL LEGEND AND TABLES".
- 2. NO WORK ACTIVITY, EQUIPMENT, VEHICLES AND/OR MATERIALS SHALL BE LOCATED BETWEEN THE BARRIER OR SHADOW VEHICLE AND THE ACTIVE WORK AREA (ROLL AHEAD DISTANCES).
- 3. THE CONTRACTOR MAY BE REQUIRED TO PROVIDE A BARRIER VEHICLE IN CONJUNCTION WITH POLICE PRESENCE IN THE WORK ZONE, TO BE INCLUDED IN THE UNIT BID PRICE FOR BASIC WORK ZONE TRAFFIC
- 4. LANE CLOSURE DETAILS AND TIMES SHALL BE APPROVED BY THE NYSDOT ENGINEER IN CHARGE.

CHANNELIZING DEVICES:

- WHERE POSSIBLE ALL CHANNELIZING AND GUIDING DEVICES ARE TO BE PLACED SO AS TO PROVIDE A MINIMUM 2' LATERAL CLEARANCE TO THE TRAVELED
- 2. DRUMS SHALL BE USED FOR ANY LANE CLOSURES OR SHOULDER CLOSURES WHICH ARE TO REMAIN OVERNIGHT.

PUBLIC ACCESS:

- 1. PROPERTY OWNERS WHOSE DRIVEWAYS WILL BE MADE INACCESSIBLE SHALL BE NOTIFIED BY THE CONTRACTOR AT LEAVE 24 HOURS PRIOR TO THE RESTRICTING USE OF THE DRIVEWAY. FOR MULTIPLE ACCESS PROPERTIES, AT LEAST ONE DRIVEWAY SHALL BE OPEN AT ALL TIMES. ACCESS SHALL BE RESTORED TO ALL DRIVEWAYS AS SOON AS POSSIBLE.
- 2. SUITABLE RAMPS SHALL BE INSTALLED TO MAINTAIN SMOOTH TRANSITIONS FROM RESIDENTIAL AND COMMERCIAL DRIVEWAYS TO AND FROM THE WORK AREA.


MTP LEGEND

(20' SPACING)

WORK SPACE

HMBTYPE III BARRIACDE

NOTE: BOUNDARY AND TOPOGRAPHIC INFORMATION PROVIDED BY OTHERS, CARMINA WOOD MORRIS, D.P.C. ASSUMES NO RESPONSIBILITY FOR ITS ACCURACY.

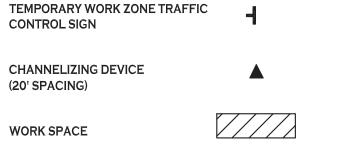

Wood

Buffalo, New York 14203 P 716.842.3165 F 716.842.0263

487 Main Street Suite 500

8/20/19 Drawn by: P. Sheedy

DRAWING NAME:

Maintenance & Protection of

DRAWING NO.

Traffic Plan