

BID ADDENDUM NO.1

2181539 Bank on Buffalo, Niagara Falls, NY

There was an error during the printing process that caused the structural & HVAC items to not appear in the Architectural drawings. Some of the drawings being replaced are only to show the missing items for clarification. No actual changes are occurring on these sheets. Any changes to the drawings are clouded & tagged.

Revised drawings will be sent via a WeTransfer link. If you do not receive a link, please notify me immediately. Included in the link is a copy of the civil drawings <u>for reference only.</u> No civil work is included in the bid package.

The Contract Documents are herein amended by this Addendum, as follows:

PART 1- DRAWINGS

1.1. ARCHITECTURAL

A. Drawing A101

- 1. <u>DELETE</u> Drawing in its entirety
- 2. ADD replacement Drawing A101
- 3. Changes to the curved Customer feature (DIY) wall
- 4. Structural items are now shown on drawings.

B. Drawing A102

- 1. DELETE Drawing in its entirety
- 2. ADD replacement Drawing A102
- 3. Changes to the curved Customer feature (DIY) wall
- 4. Structural items are now shown on drawings.

C. Drawing A111

- 1. <u>DELETE</u> Drawing in its entirety
- 2. ADD replacement Drawing A111
- 3. HVAC shown on drawings.

D. Drawing A112

- 1. DELETE Drawing in its entirety
- 2. ADD replacement Drawing A112
- 3. HVAC shown on drawings.

E. Drawing A201

- 1. DELETE Drawing in its entirety
- 2. ADD replacement Drawing A201
- 3. HVAC shown on drawings.



F. Drawing A202

- 1. **DELETE** Drawing in its entirety
- 2. ADD replacement Drawing A202
- 3. HVAC shown on drawings.

G. Drawing A211

- 1. **DELETE** Drawing in its entirety
- 2. ADD replacement Drawing A211
- 3. Changes to the curved Customer feature (DIY) wall & Break Room counter

H. Drawing A301

- 1. **DELETE** Drawing in its entirety
- 2. ADD replacement Drawing A301
- 3. HVAC & structural shown on drawings.

I. Drawing A302

- 1. **DELETE** Drawing in its entirety
- 2. ADD replacement Drawing A302
- 3. HVAC & structural shown on drawings.

J. Drawing A311

- 1. <u>DELETE</u> Drawing in its entirety
- 2. ADD replacement Drawing A311
- 3. HVAC & structural shown on drawings.

K. Drawing A312

- 1. **DELETE** Drawing in its entirety
- 2. ADD replacement Drawing A312
- 3. HVAC & structural shown on drawings.

L. Drawing A401

- 1. **DELETE** Drawing in its entirety
- 2. ADD replacement Drawing A401
- 3. HVAC & structural shown on drawings.

M. Drawing A501

- 1. **DELETE** Drawing in its entirety
- 2. ADD replacement Drawing A501
- 3. Structural items are now shown on drawings.

N. Drawing A502

- 1. DELETE Drawing in its entirety
- 2. ADD replacement Drawing A502
- 3. Structural items are now shown on drawings.

O. Drawing A503

- 1. **DELETE** Drawing in its entirety
- 2. ADD replacement Drawing A503
- 3. Added Customer feature section & deleted vertical cove light detail. Vertical cove lighting is to be removed from the project. It is <u>not</u> otherwise noted on the Electrical drawings.
- 4. Structural items are now shown on drawings.



P. Drawing I101

- 1. <u>DELETE</u> Drawing in its entirety
- 2. ADD replacement Drawing I101
- 3. Finish changes
- 4. Structural items are now shown on drawings.

Q. Drawing I102

- 1. <u>DELETE</u> Drawing in its entirety
- 2. ADD replacement Drawing I102
- 3. Finish changes
- 4. Structural items are now shown on drawings.

1.2. ELECTRICAL

A. DRAWING E101

- 1. <u>DELETE</u>: This drawing in its entirety.
- 2. ADD replacement Drawing E101
- 3. Addition of (5) powered signs, ceiling hung TV, & camera


B. DRAWING E502

- 1. <u>DELETE</u>: This drawing in its entirety.
- 2. ADD replacement Drawing E502
- 3. Timer control changes

C. DRAWING E601

- 1. <u>DELETE</u>: This drawing in its entirety.
- 2. ADD replacement Drawing E601
- 3. Panel schedule changes

Please acknowledge receipt of this notic Email: <u>sparrish@labellapc.com</u>	e by your signature below and return by email to LaBella.
Acknowledged by	Representing

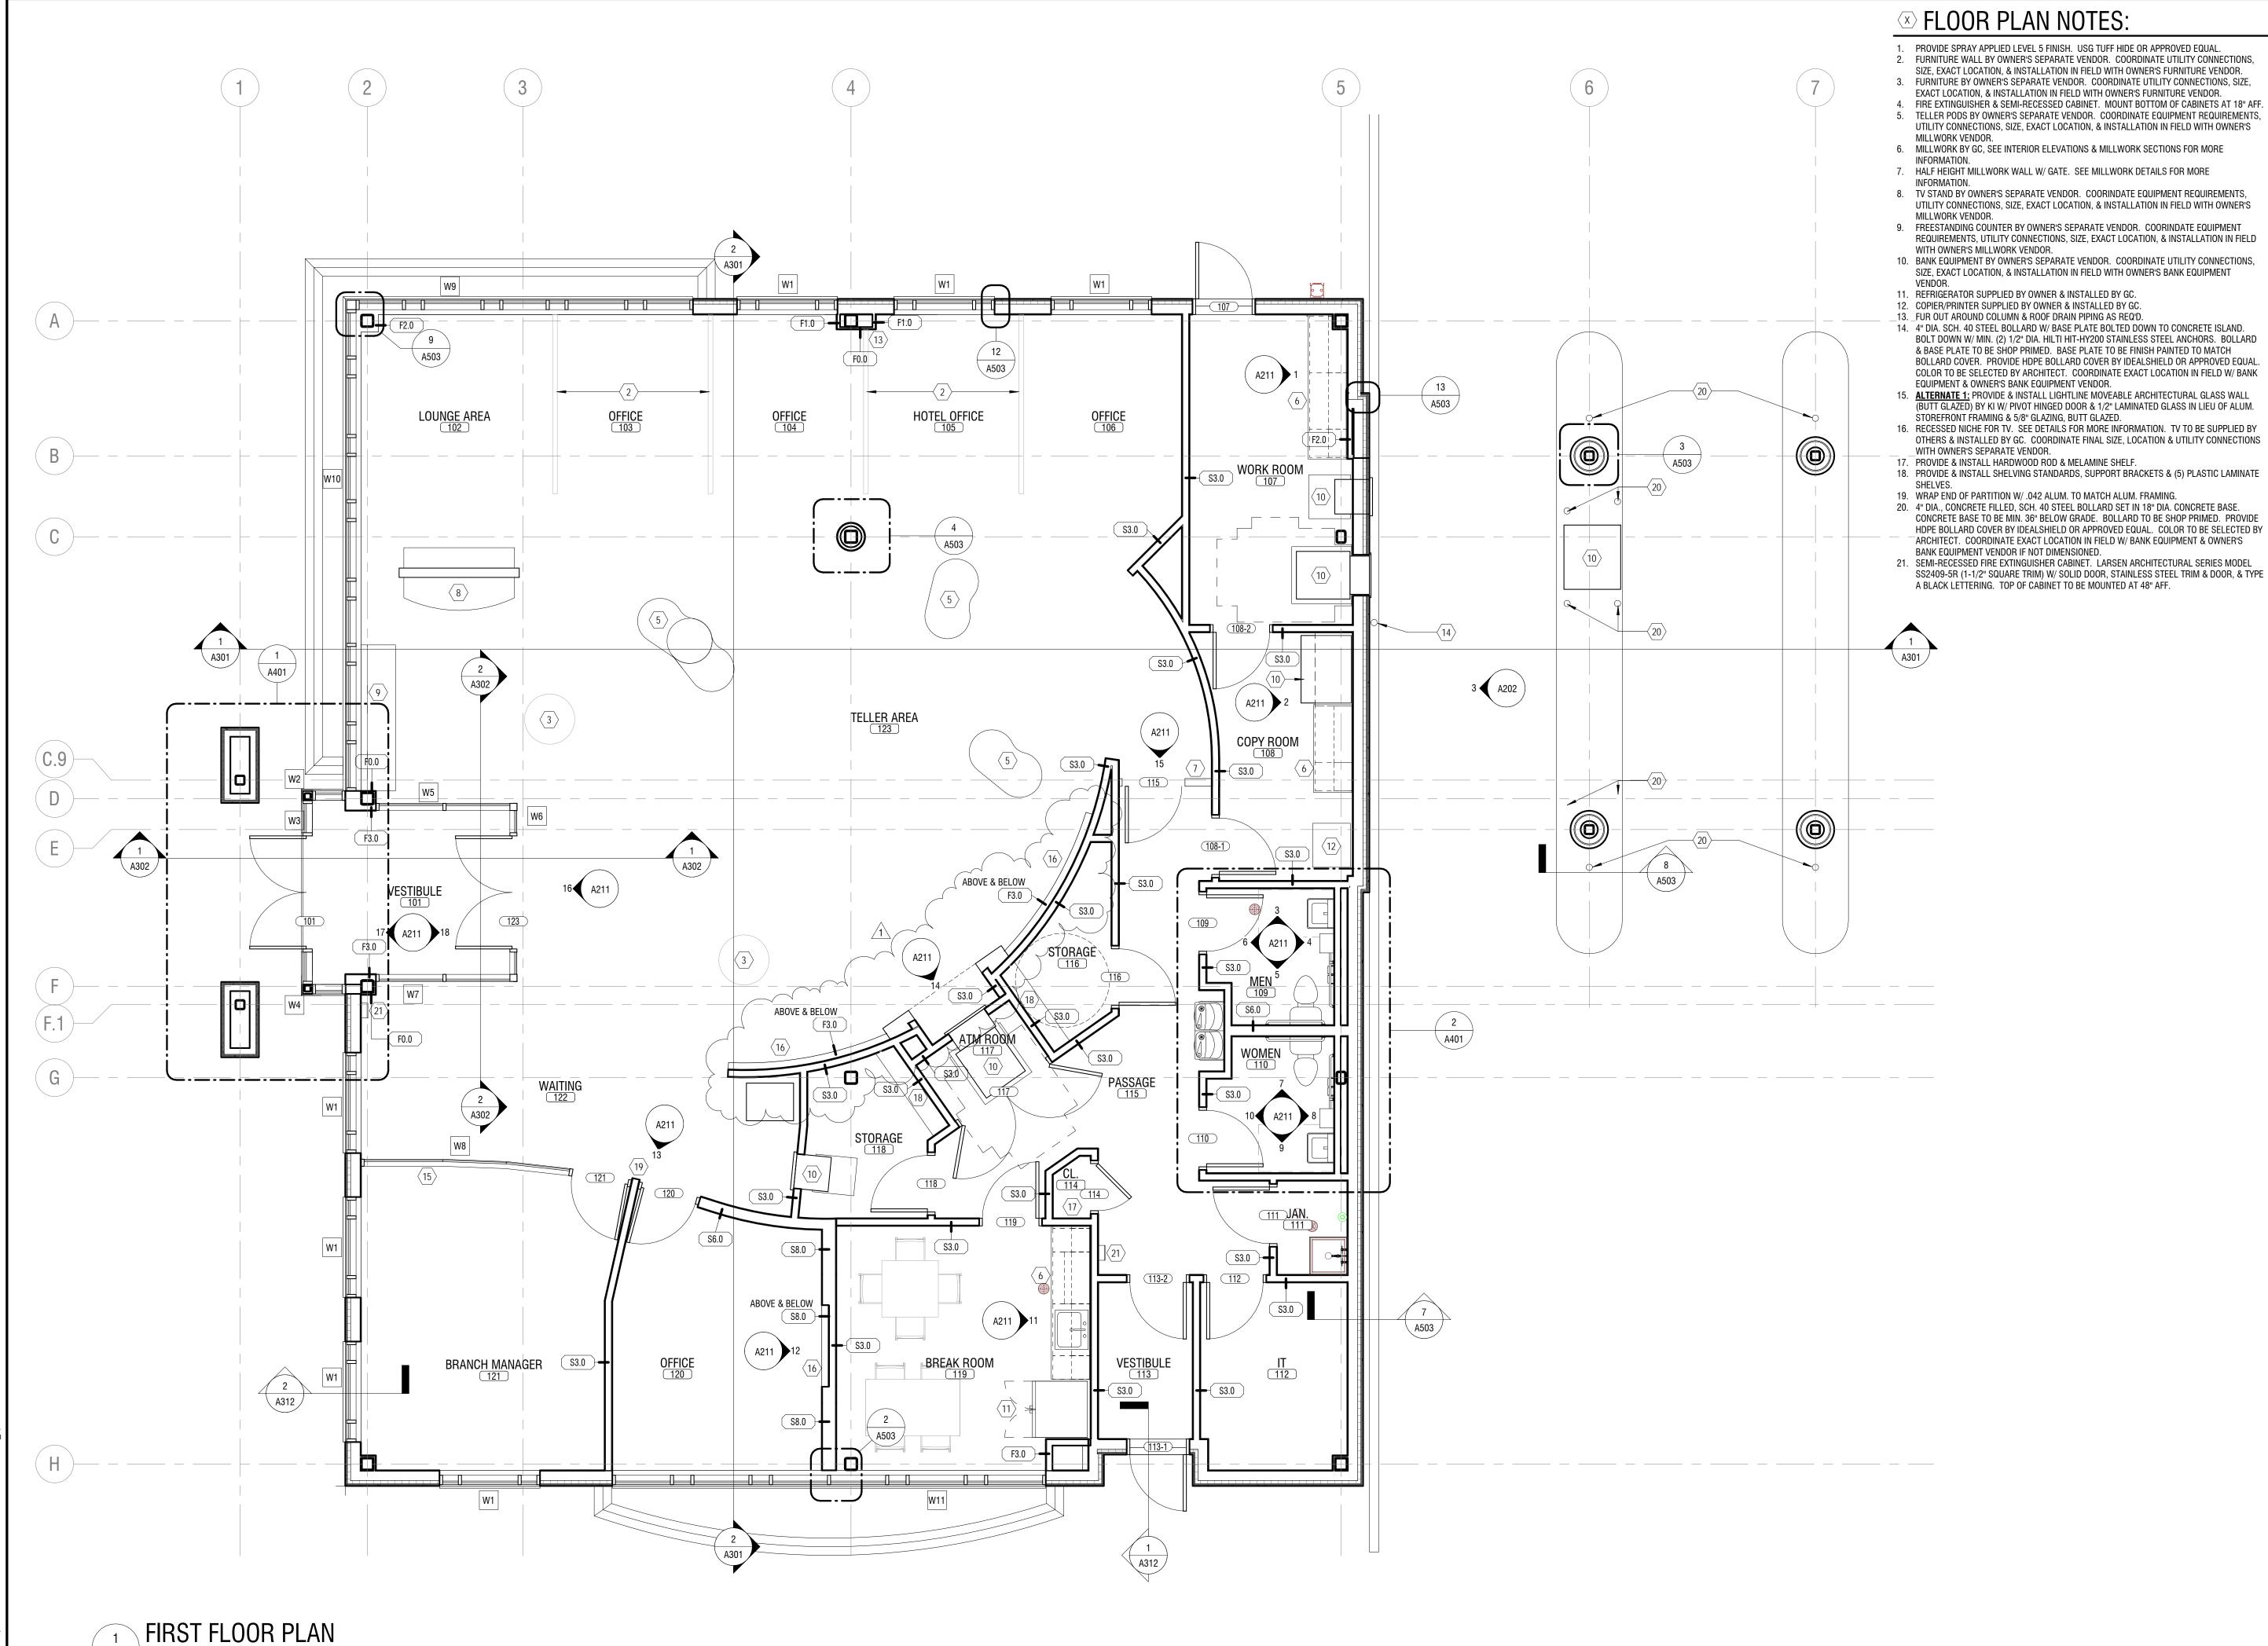

A101 SCALE: 1/4" = 1'-0"



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acting under the direction of a licensed architect, professional engineer, or land surveyor, to alter an item in any way. If an item bearing the seal of an architect, engineer, or land surveyor is altered; the altering architect, engineer, or land surveyor shall affix to the item their seal and notation "altered by"

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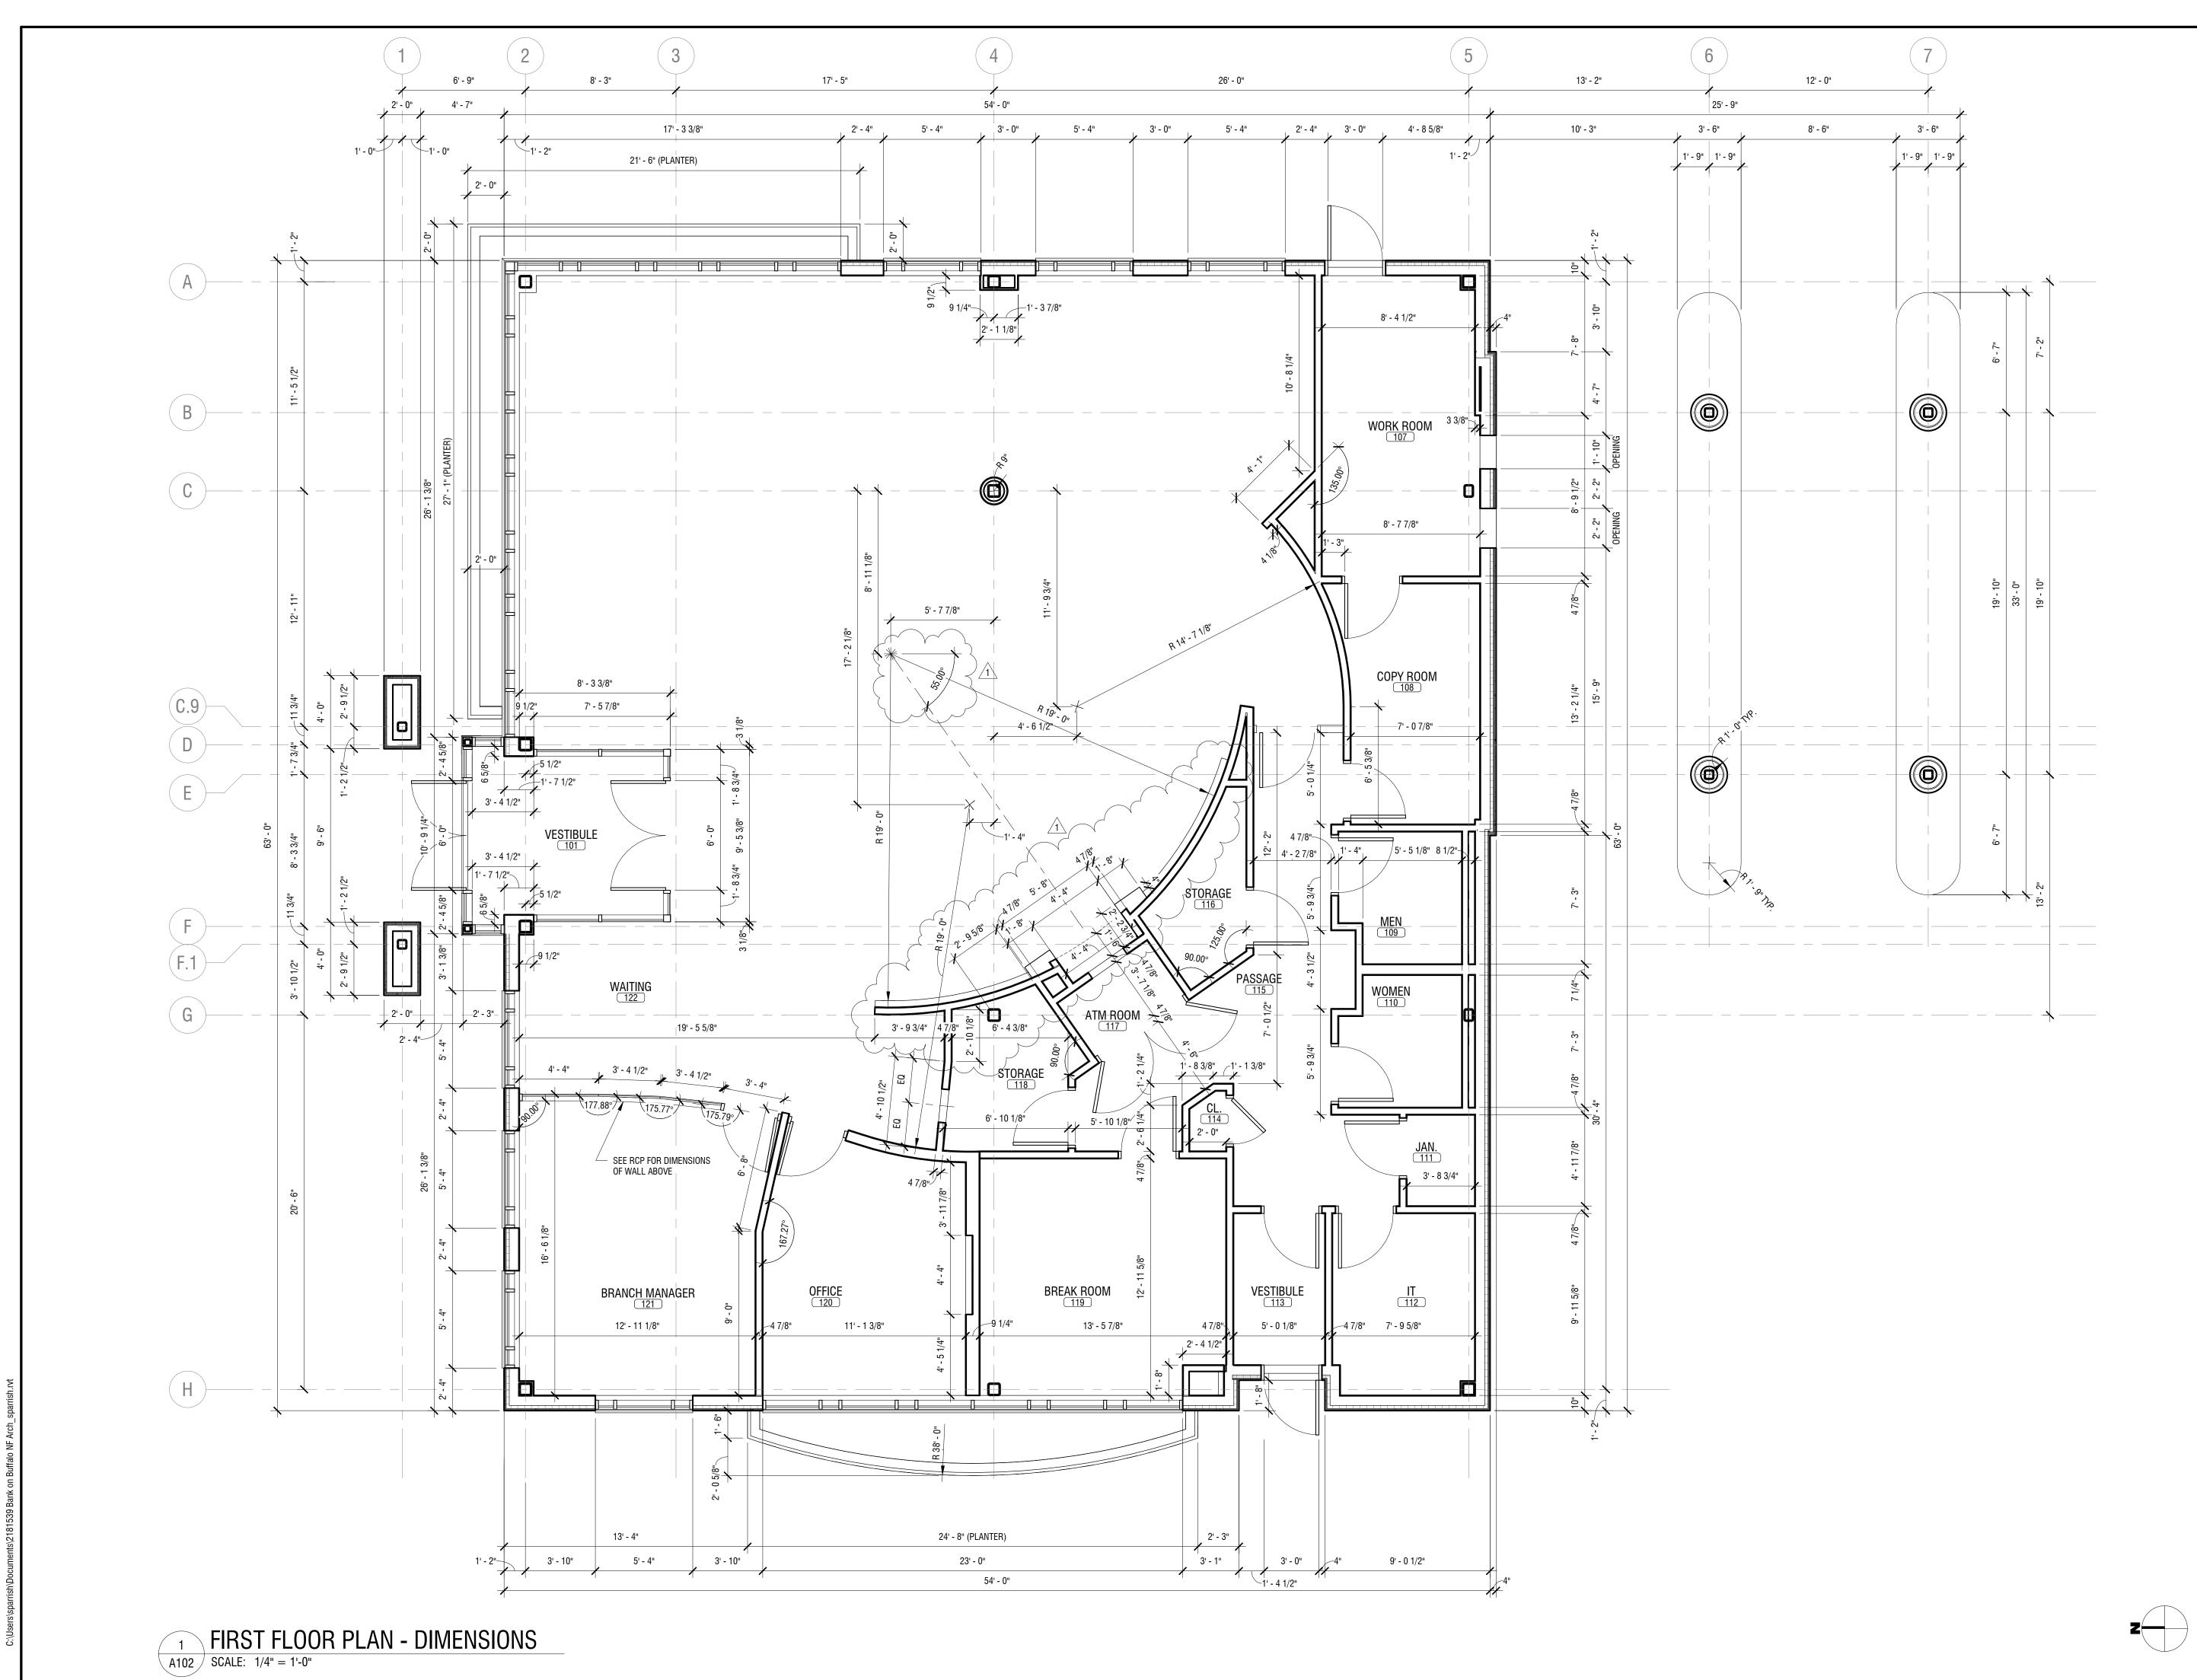
NEW COMMUNITY BRANCH -NIAGARA FALLS

7121 Niagara Falls Blvd. Niagara Falls, NY 14304

1	02-15-19	ADDENDUM 1	
NO:	DATE:	DESCRIPTION:	
Revisions			
PROJECT N	IUMBER:	2181539	
DRAWN BY	:	SP	
REVIEWED	BY:	RJN	
ISSUED FO		PERMIT SET	
DATE:		8 FEB 2019	
DRAWING I	NAME:		

FIRST FLOOR PLAN

DRAWING NUMBER:





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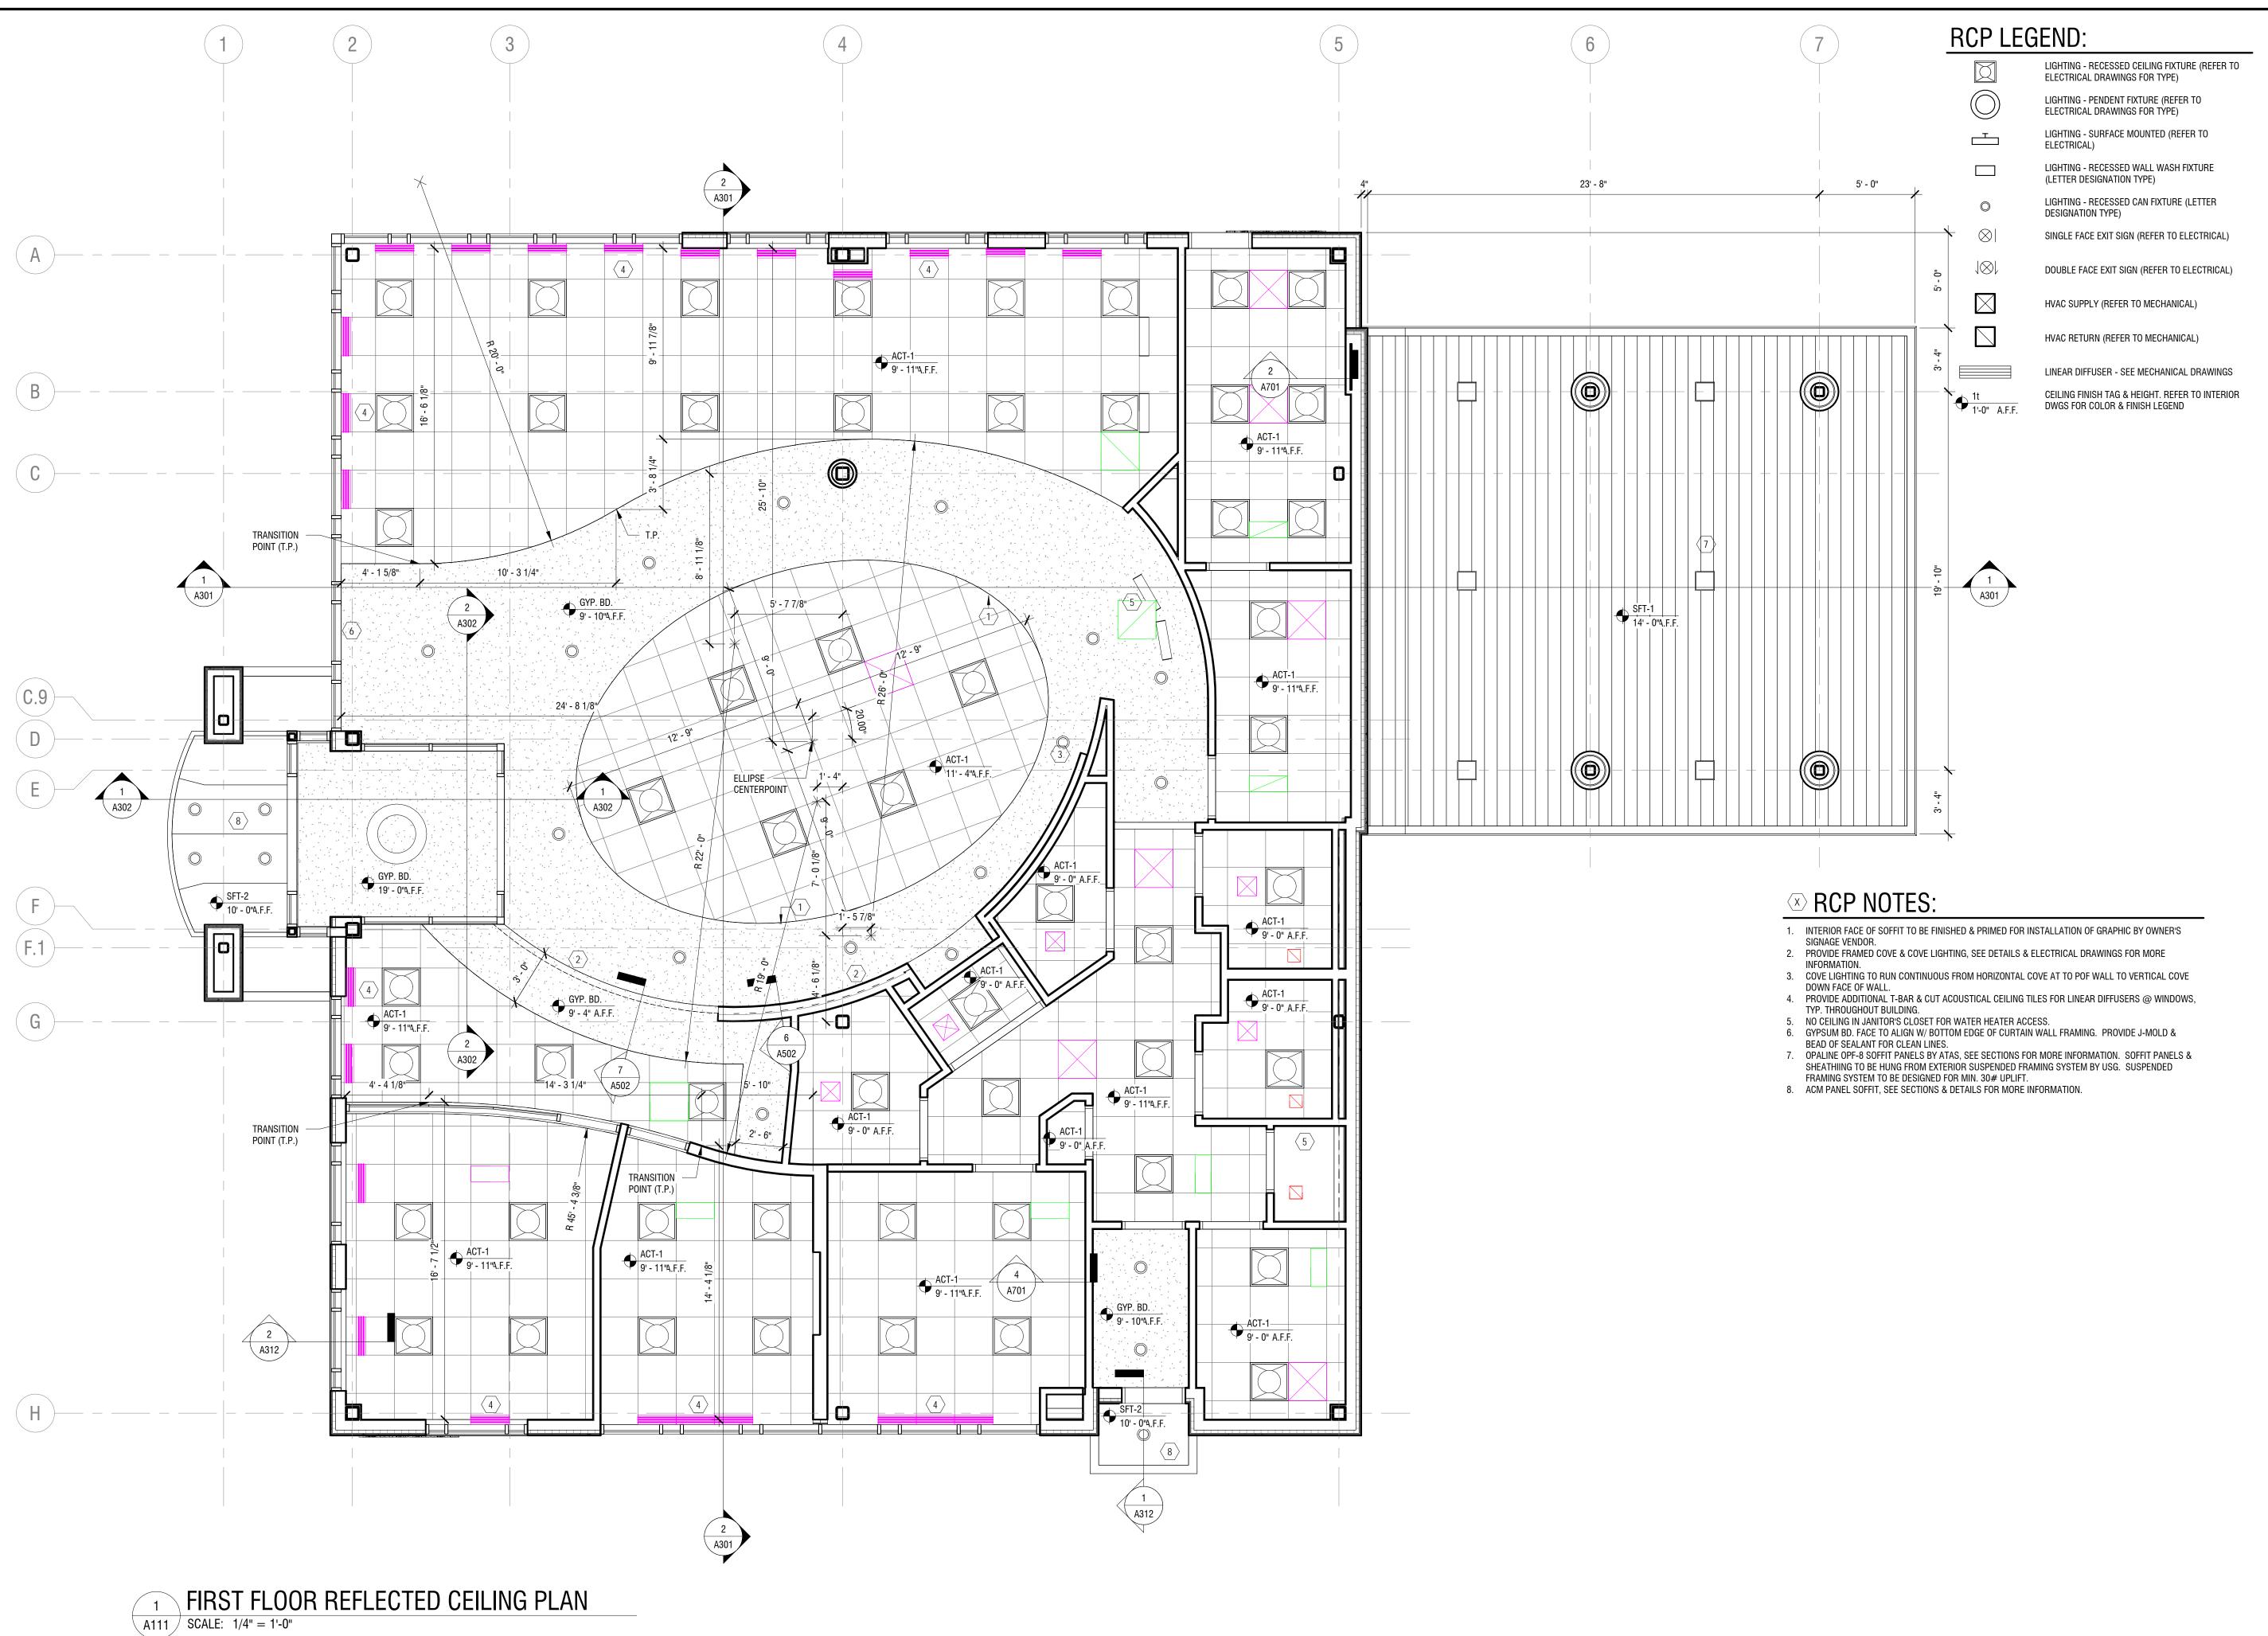
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1	02-15-19	ADDENDUM 1
NO:	DATE:	DESCRIPTION:
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PROJECT N	IUMBER:	2181539
DRAWN BY	··	JMR
REVIEWED BY:		RJN
ISSUED FO		PERMIT SET
DATE:		8 FEB 2019
DRAWING 1	NAME:	

FIRST FLOOR PLAN -DIMENSIONS

DRAWING NUMBER:





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Revisions

PROJECT NUMBER:

2181539

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REVIEWED BY: RJN

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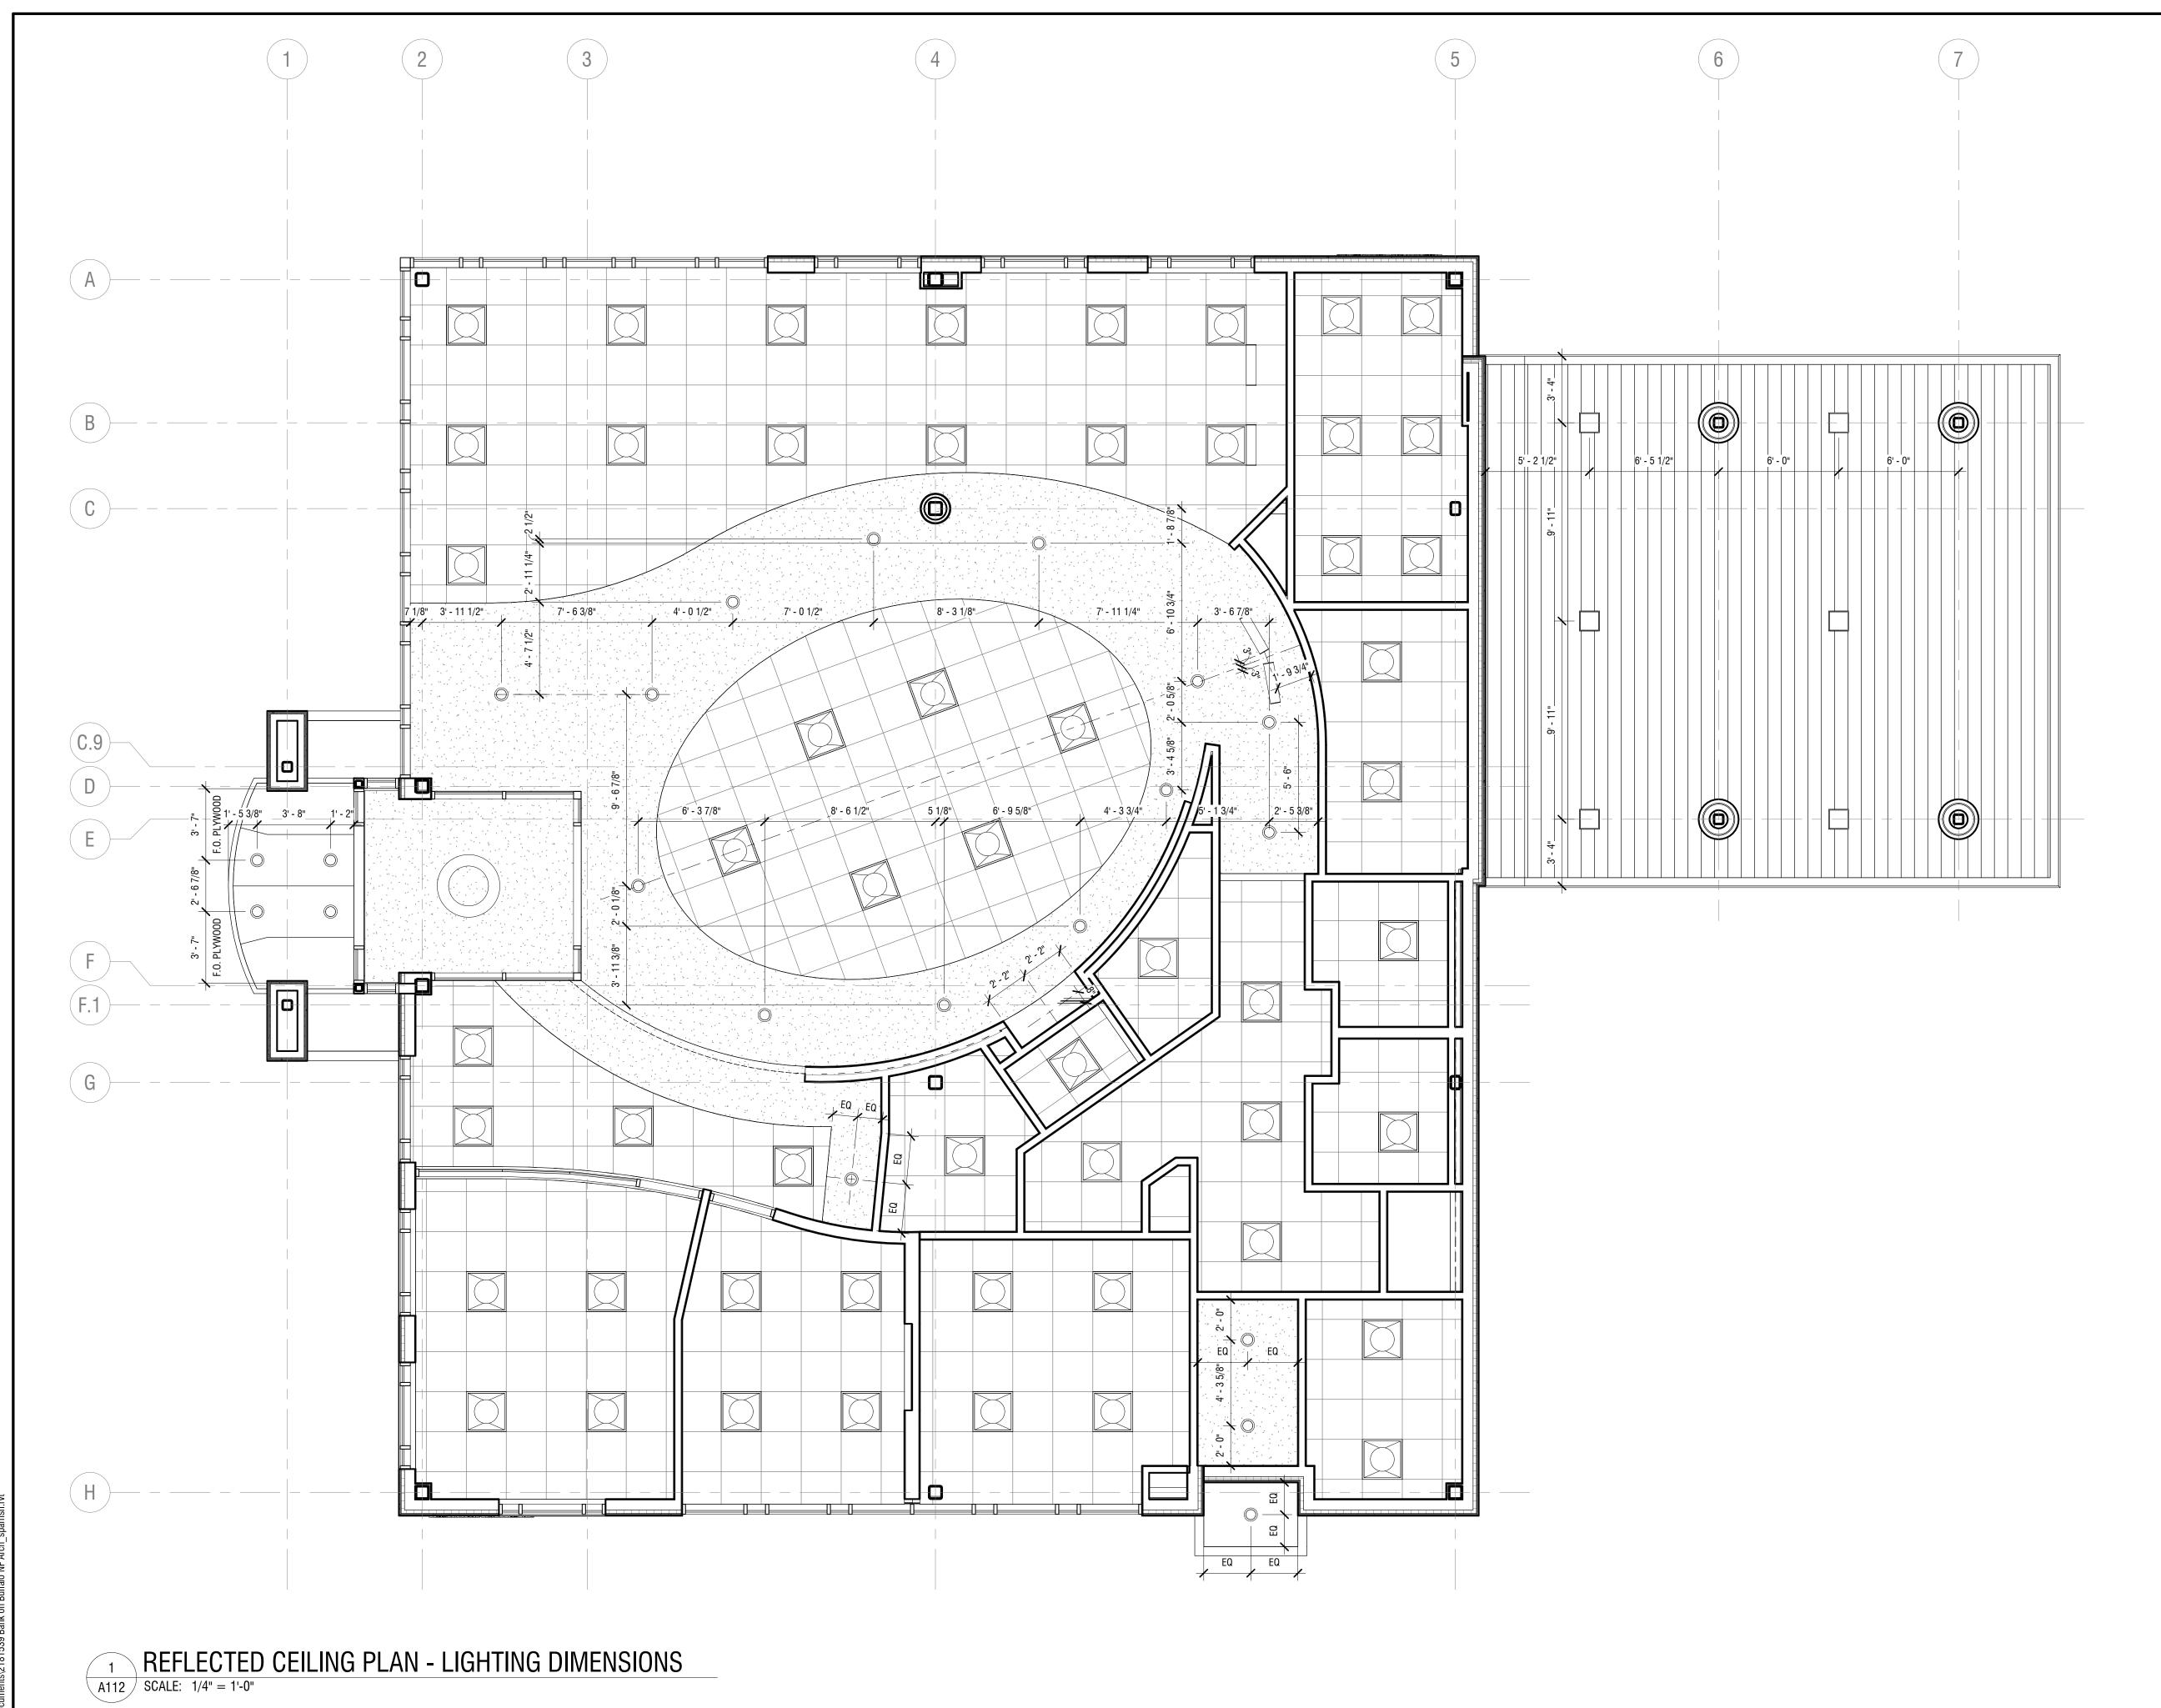
PERMIT SET

DATE: 8 FEB 2019

DRAWING NAME:

FIRST FLOOR REFLECTED CEILING PLAN

DRAWING NUMBER:





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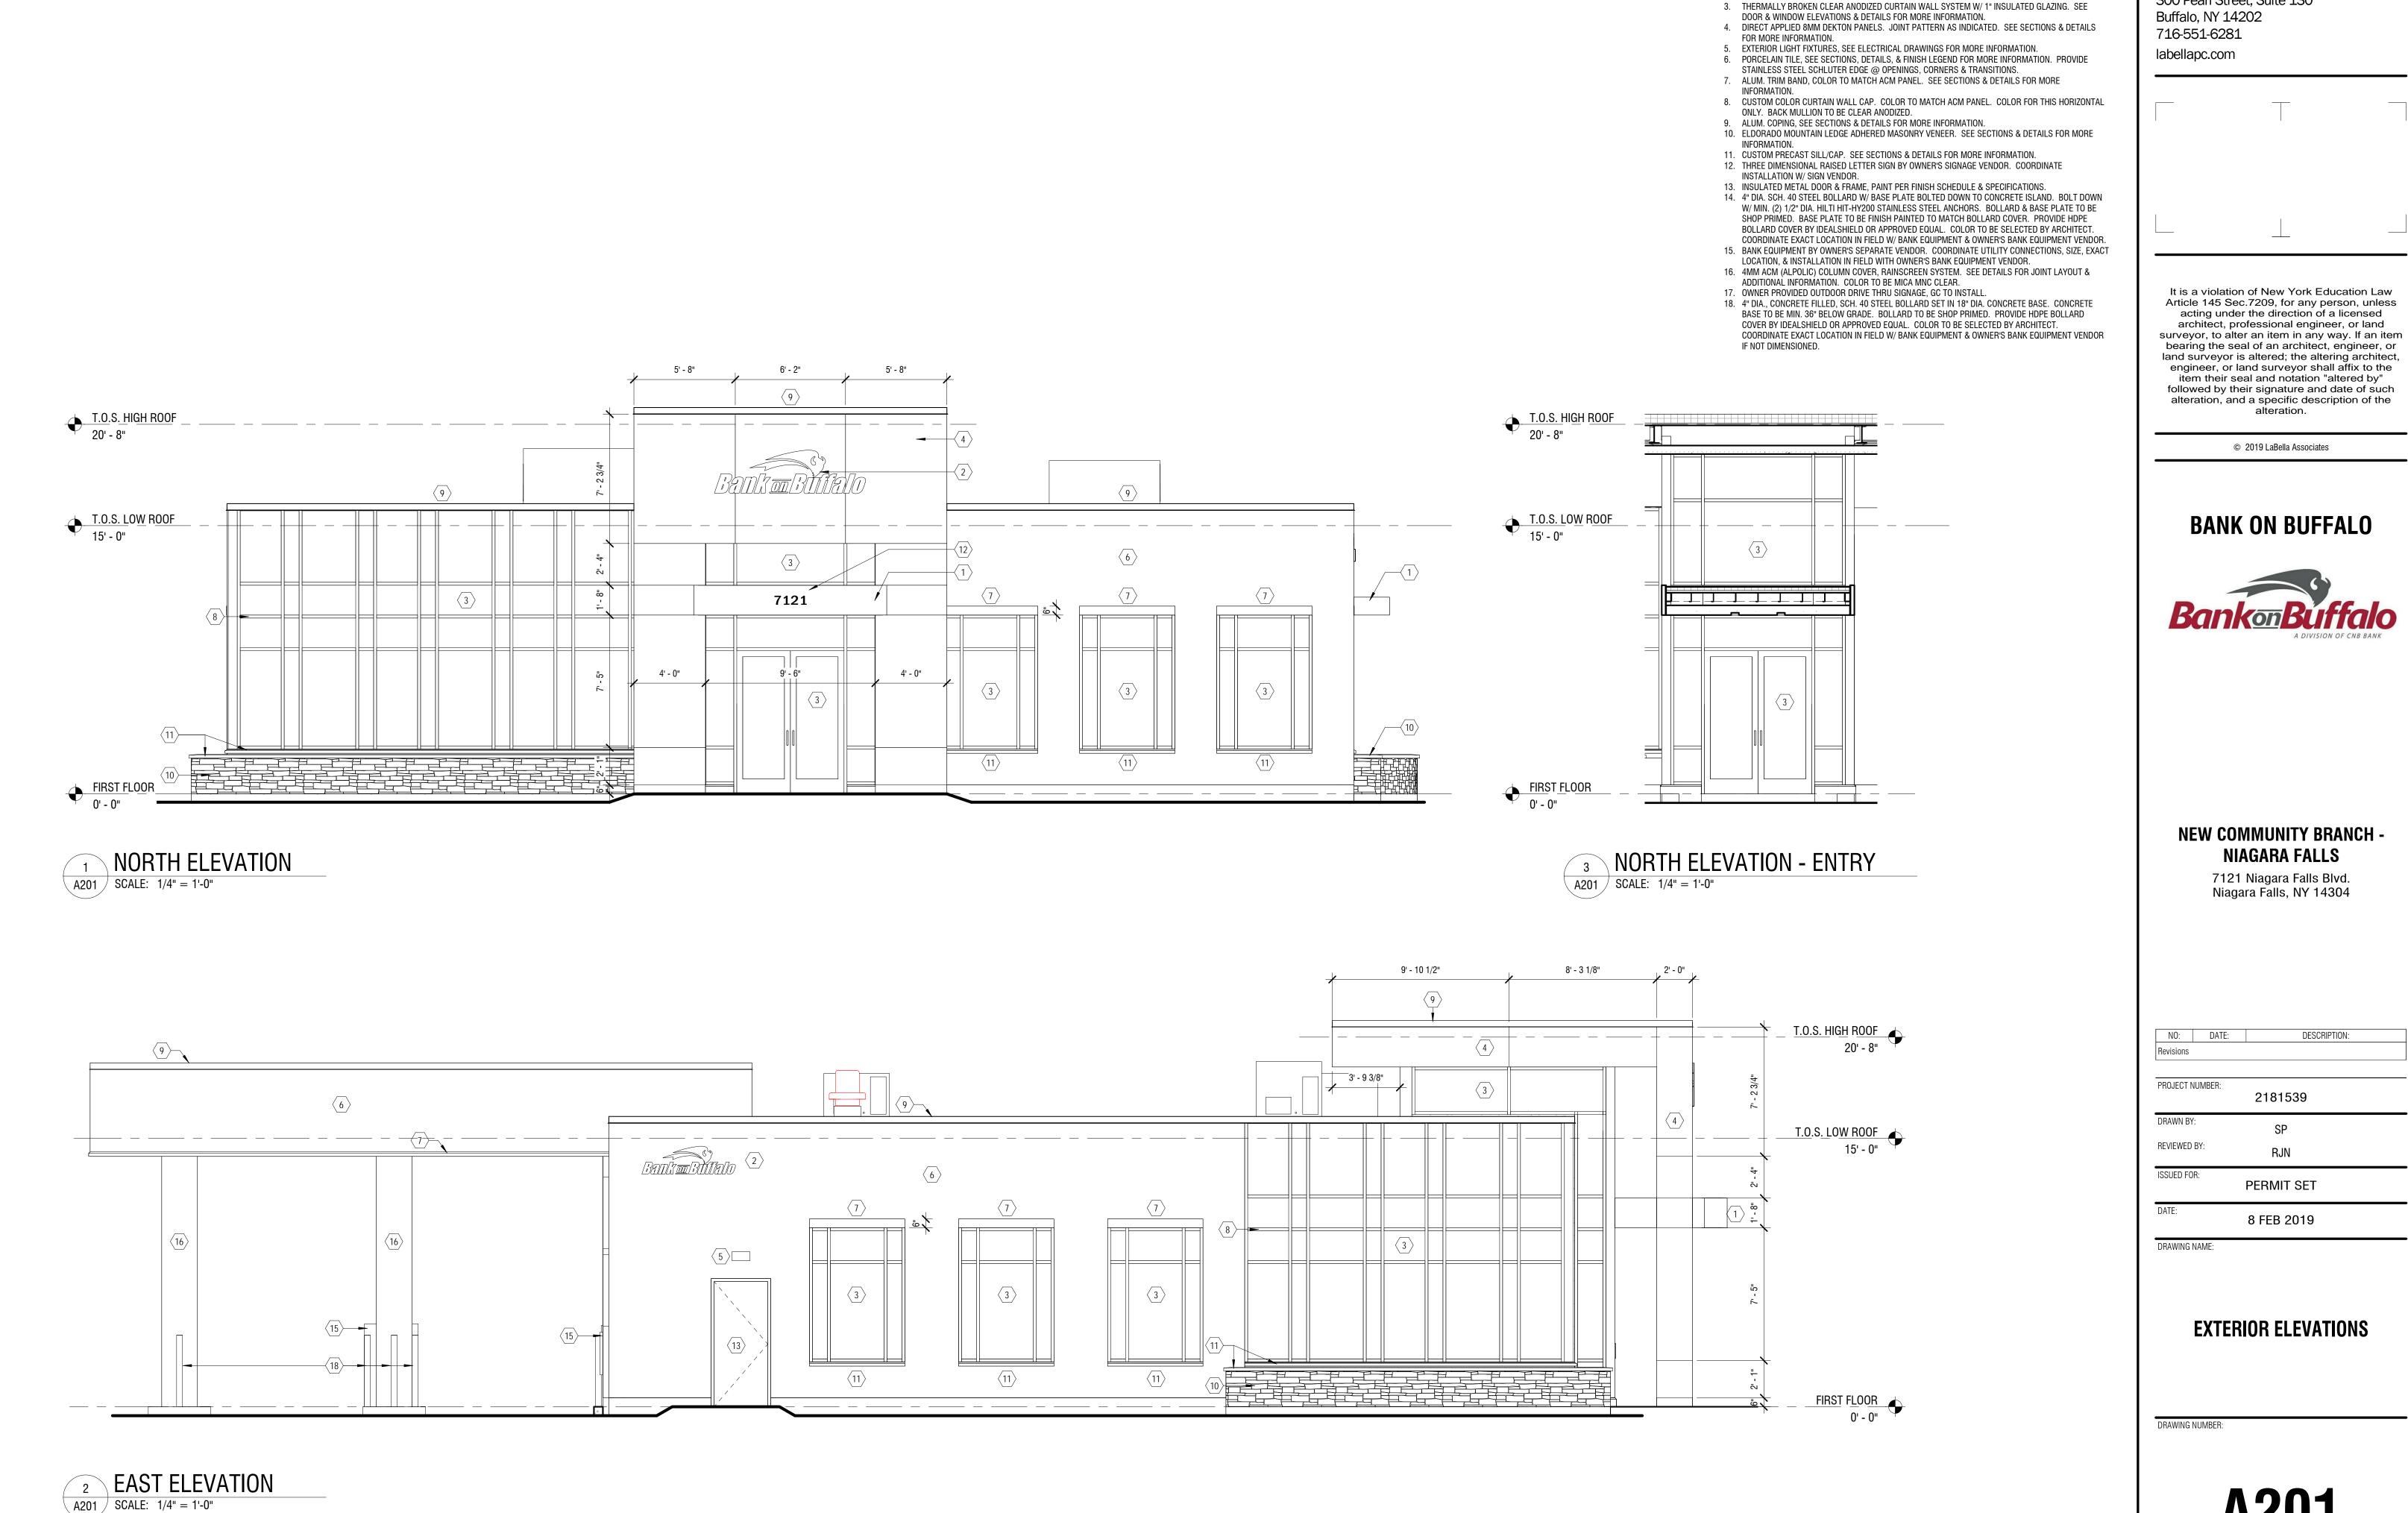
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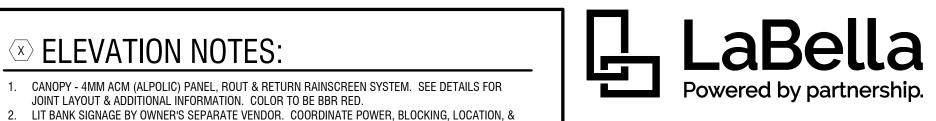
FIRST FLOOR REFLECTED CEILING PLAN - LIGHTING DIMENSIONS

DRAWING NUMBER:

A112

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ELEVATION NOTES:

JOINT LAYOUT & ADDITIONAL INFORMATION. COLOR TO BE BBR RED.

INSTALLATION REQUIREMENTS W/ OWNER'S BANK SIGNAGE VENDOR.

1. CANOPY - 4MM ACM (ALPOLIC) PANEL, ROUT & RETURN RAINSCREEN SYSTEM. SEE DETAILS FOR

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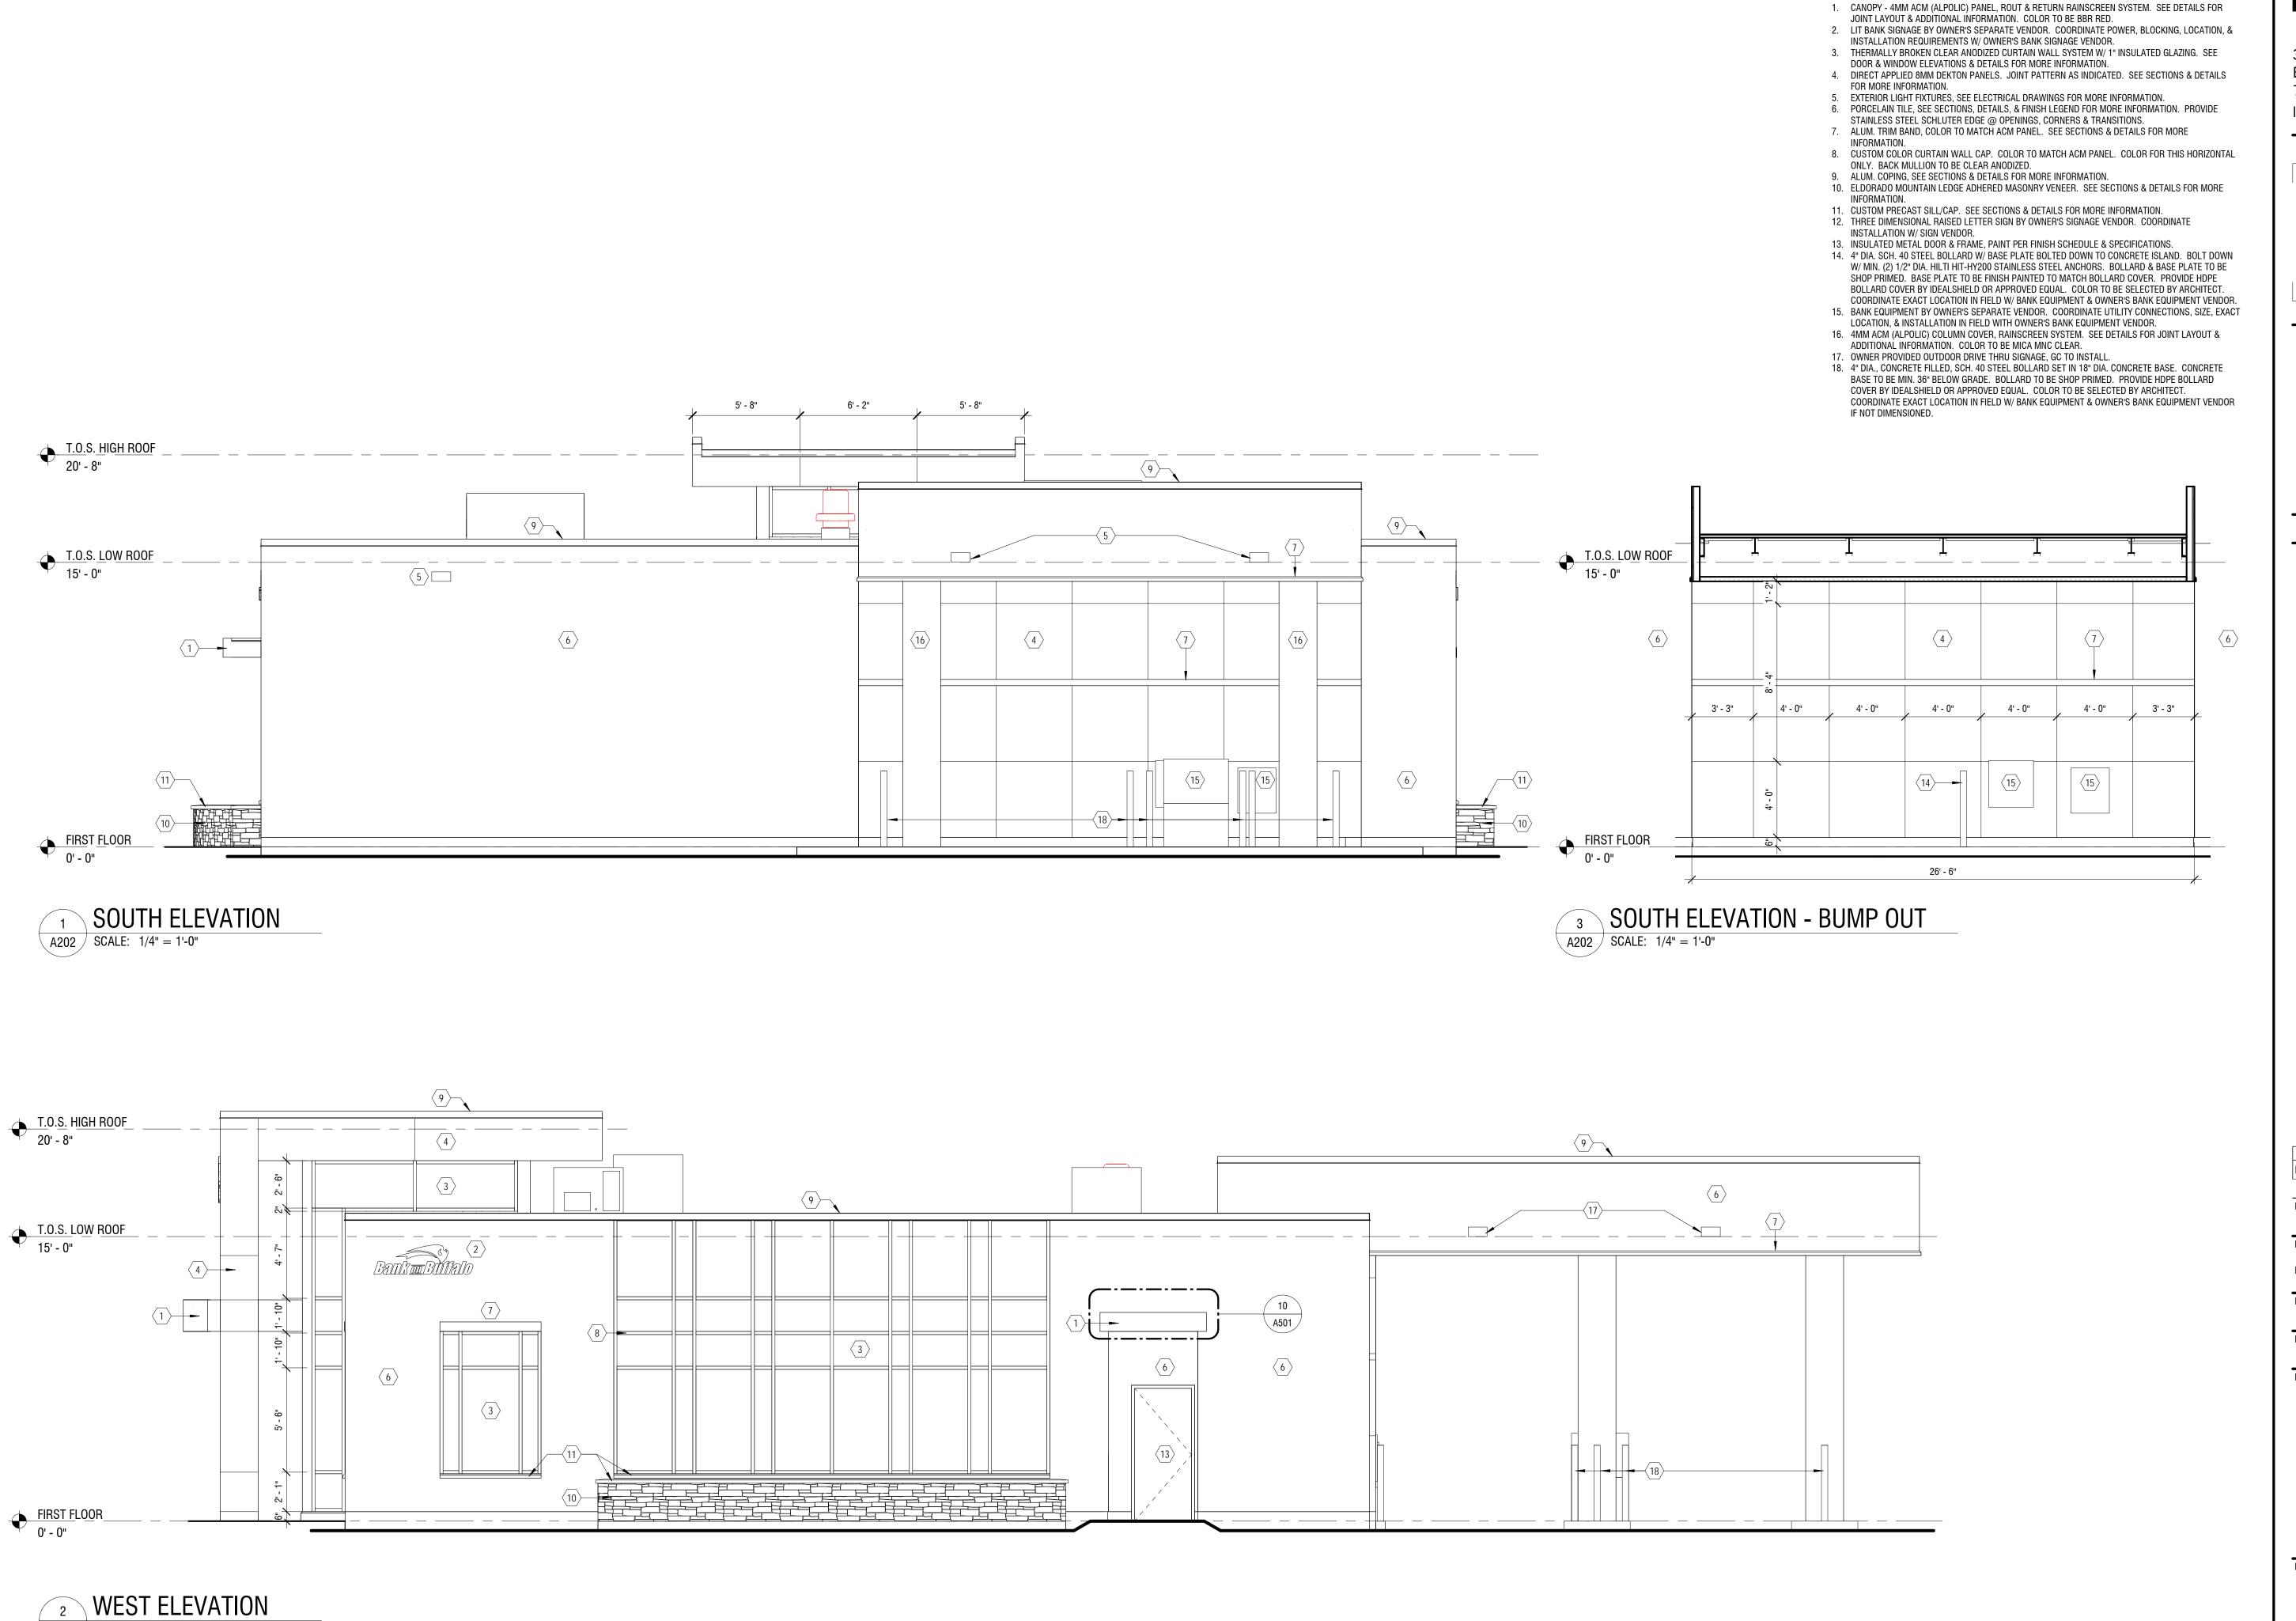
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EXTERIOR ELEVATIONS

DRAWING NUMBER:



A202 SCALE: 1/4" = 1'-0"



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ELEVATION NOTES:

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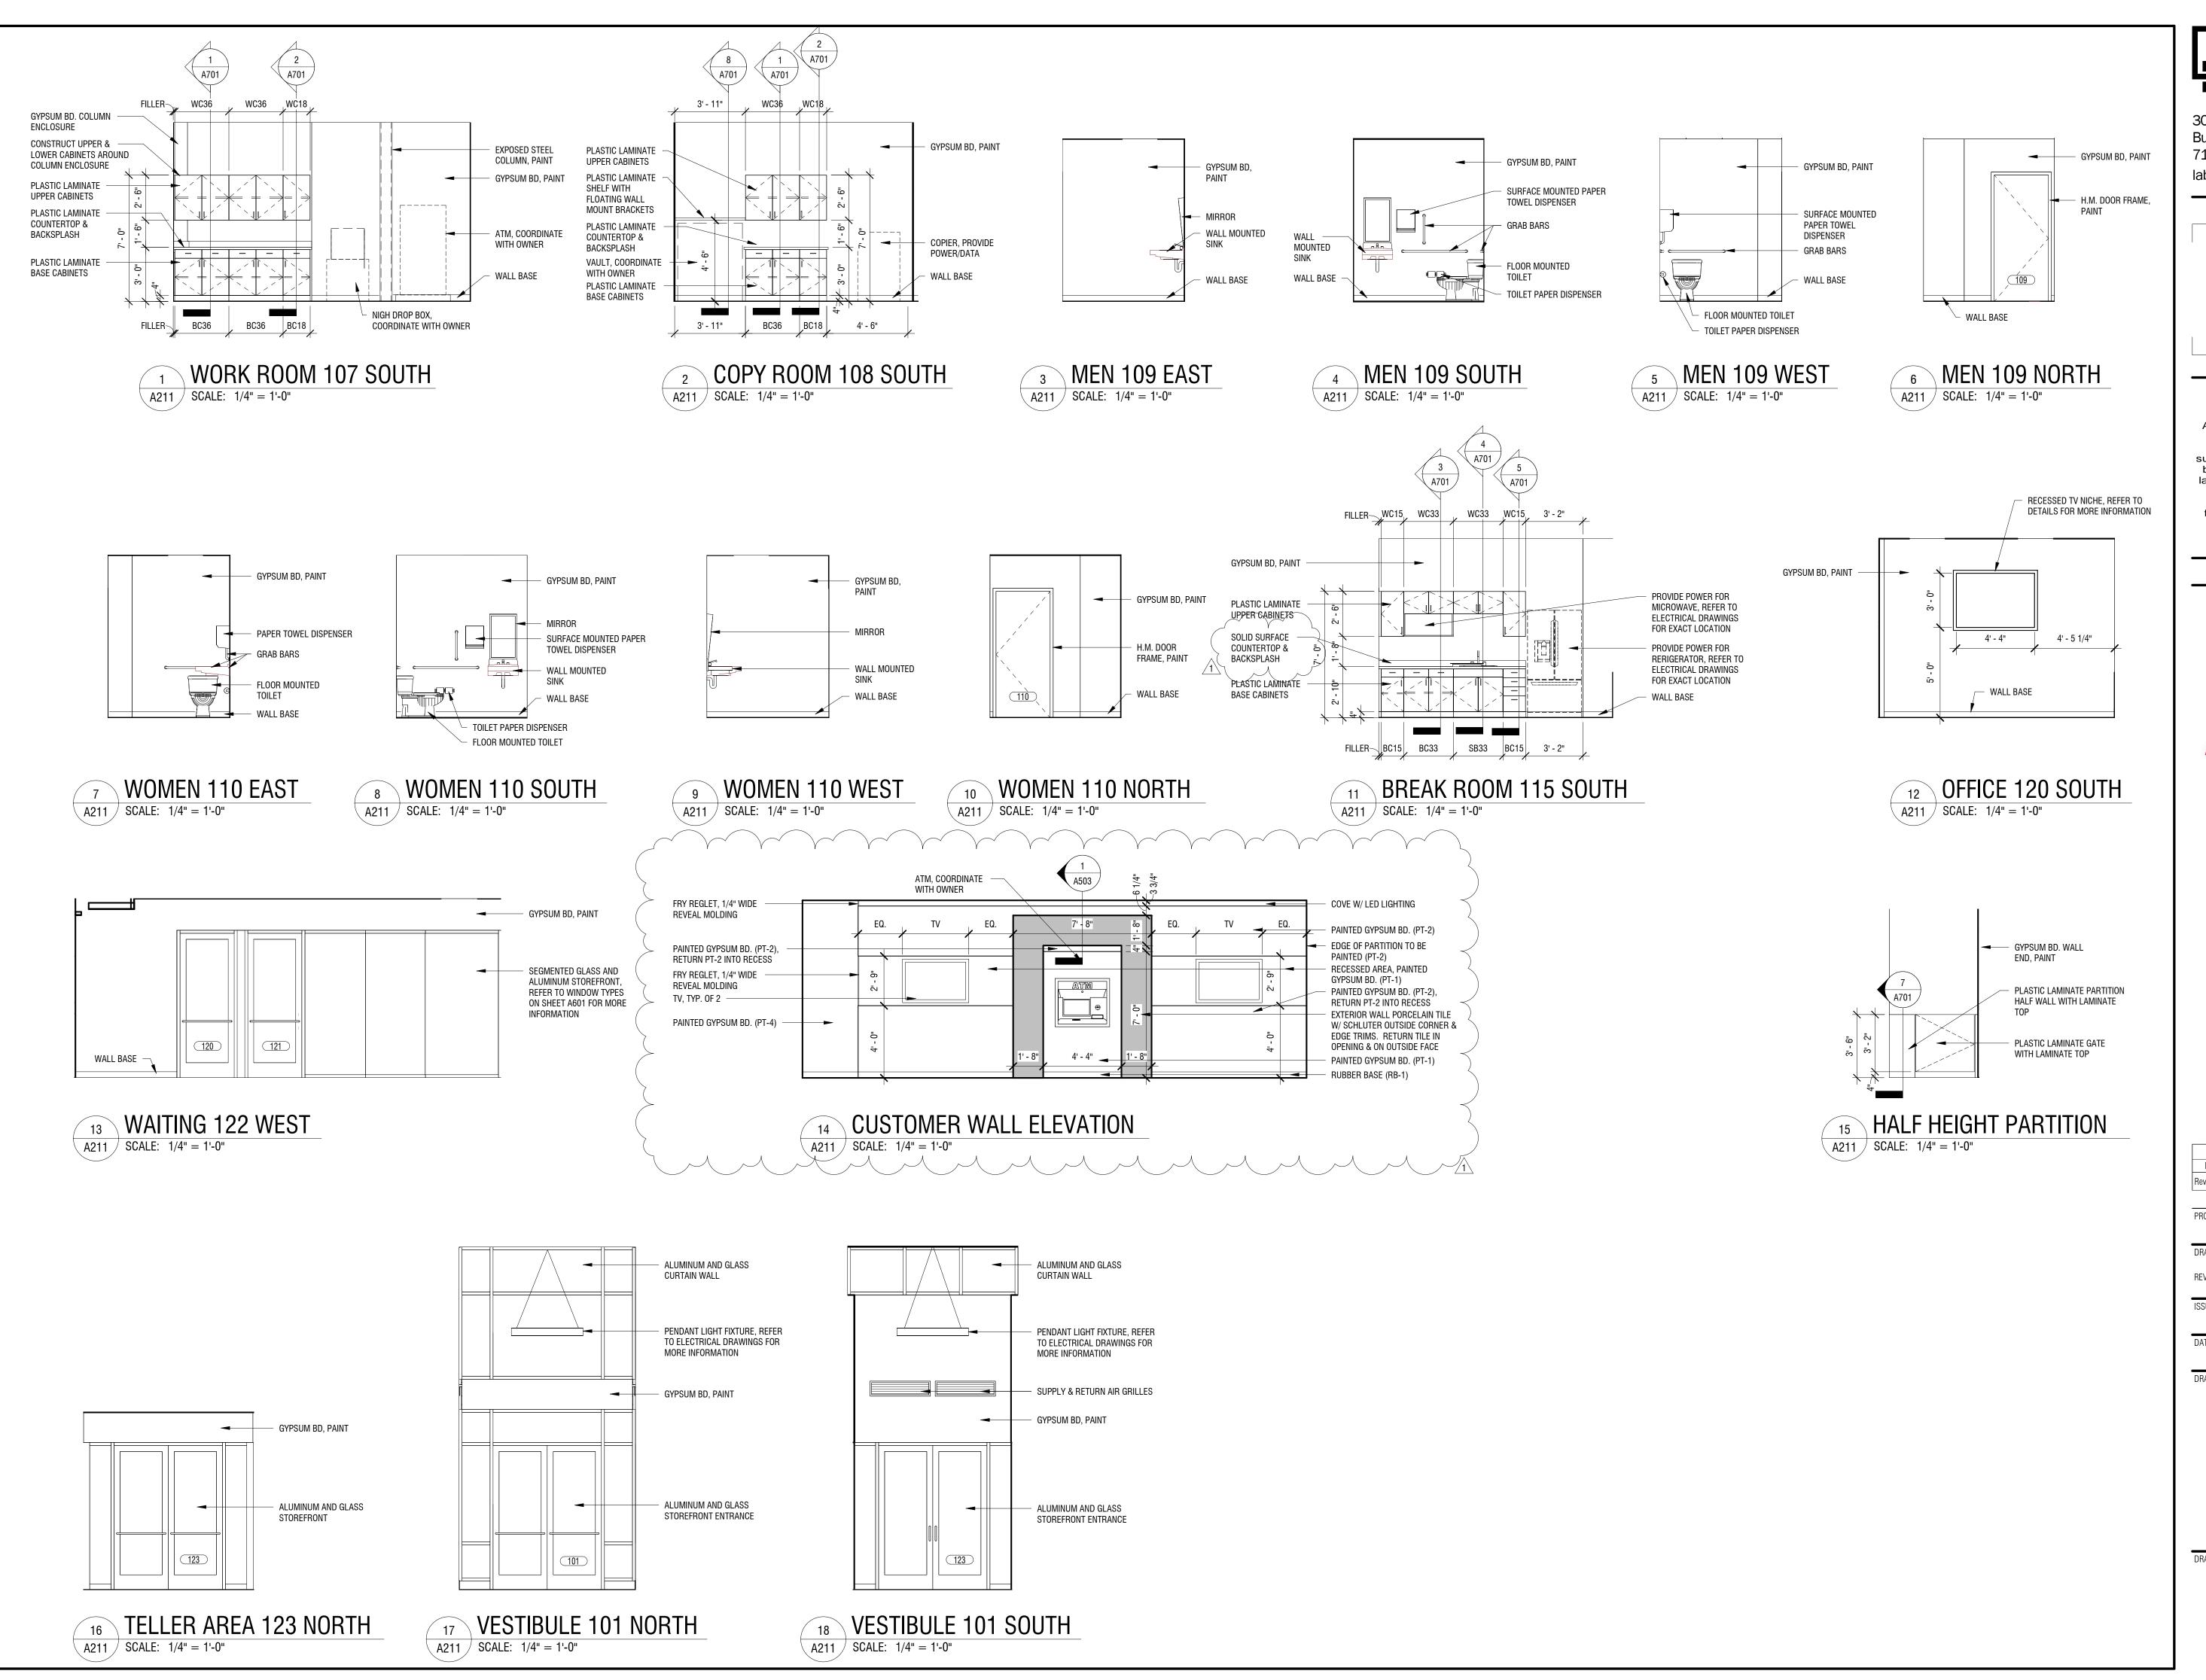
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EXTERIOR ELEVATIONS

DRAWING NUMBER:



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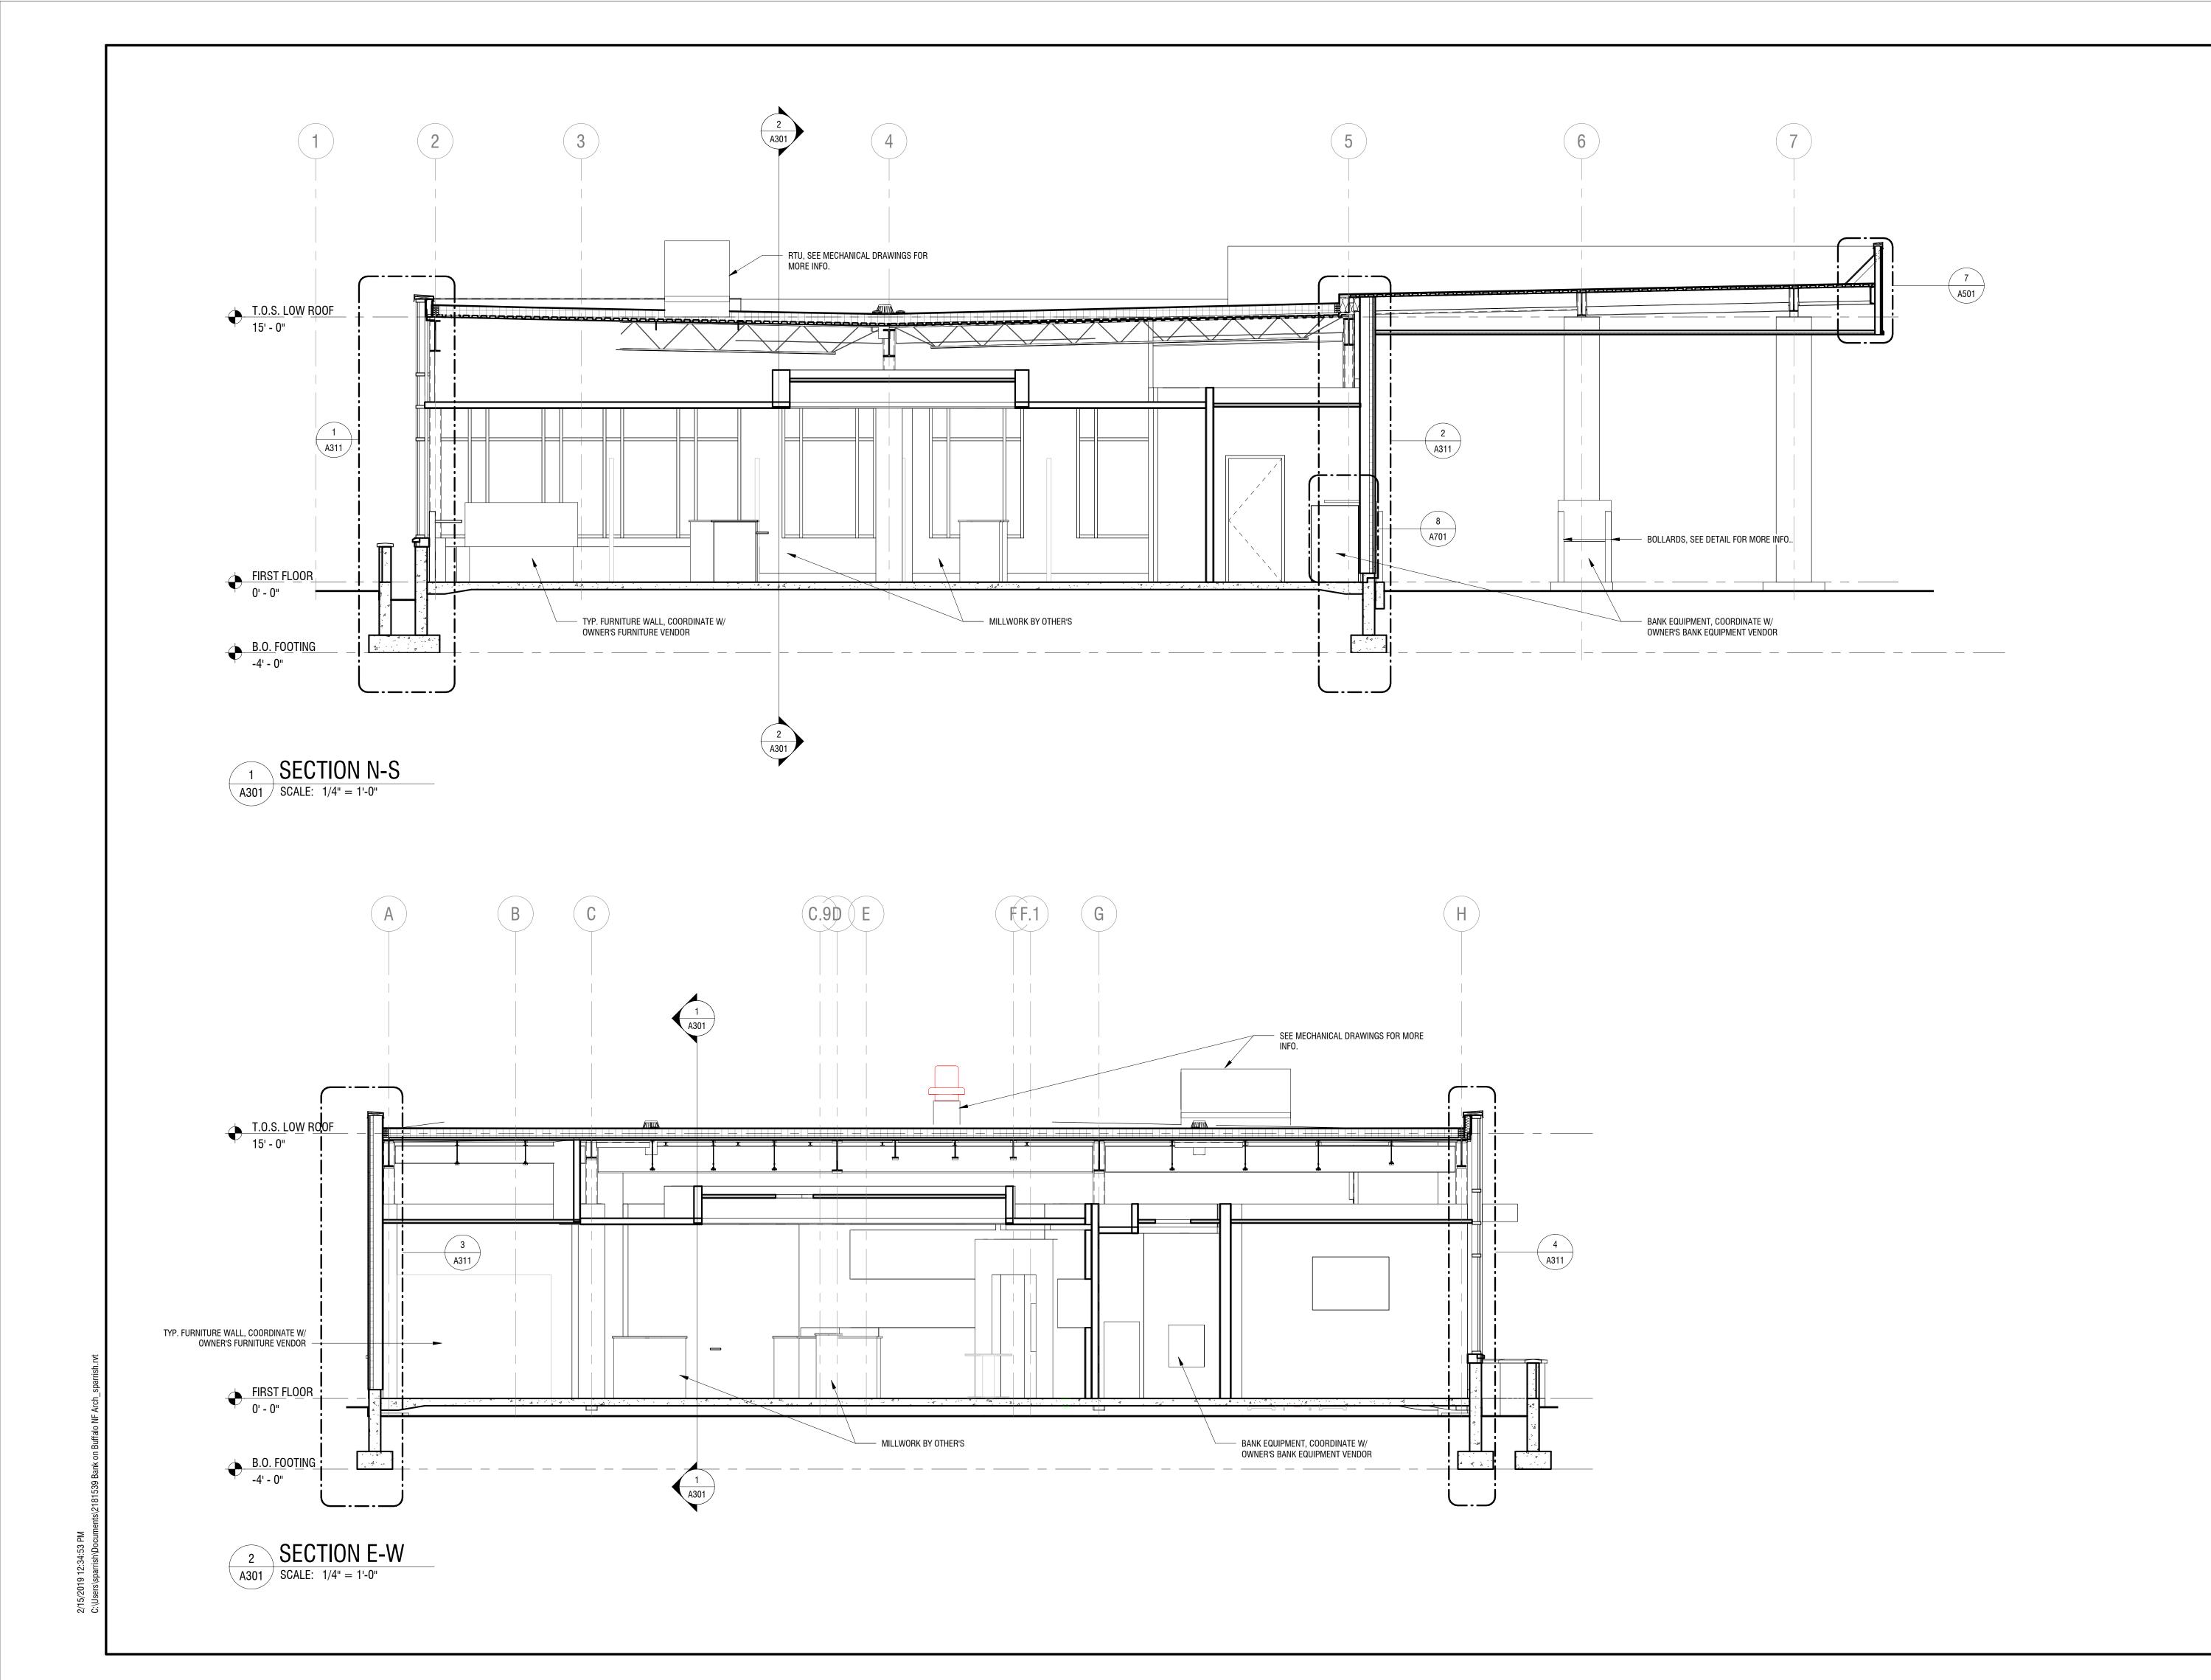
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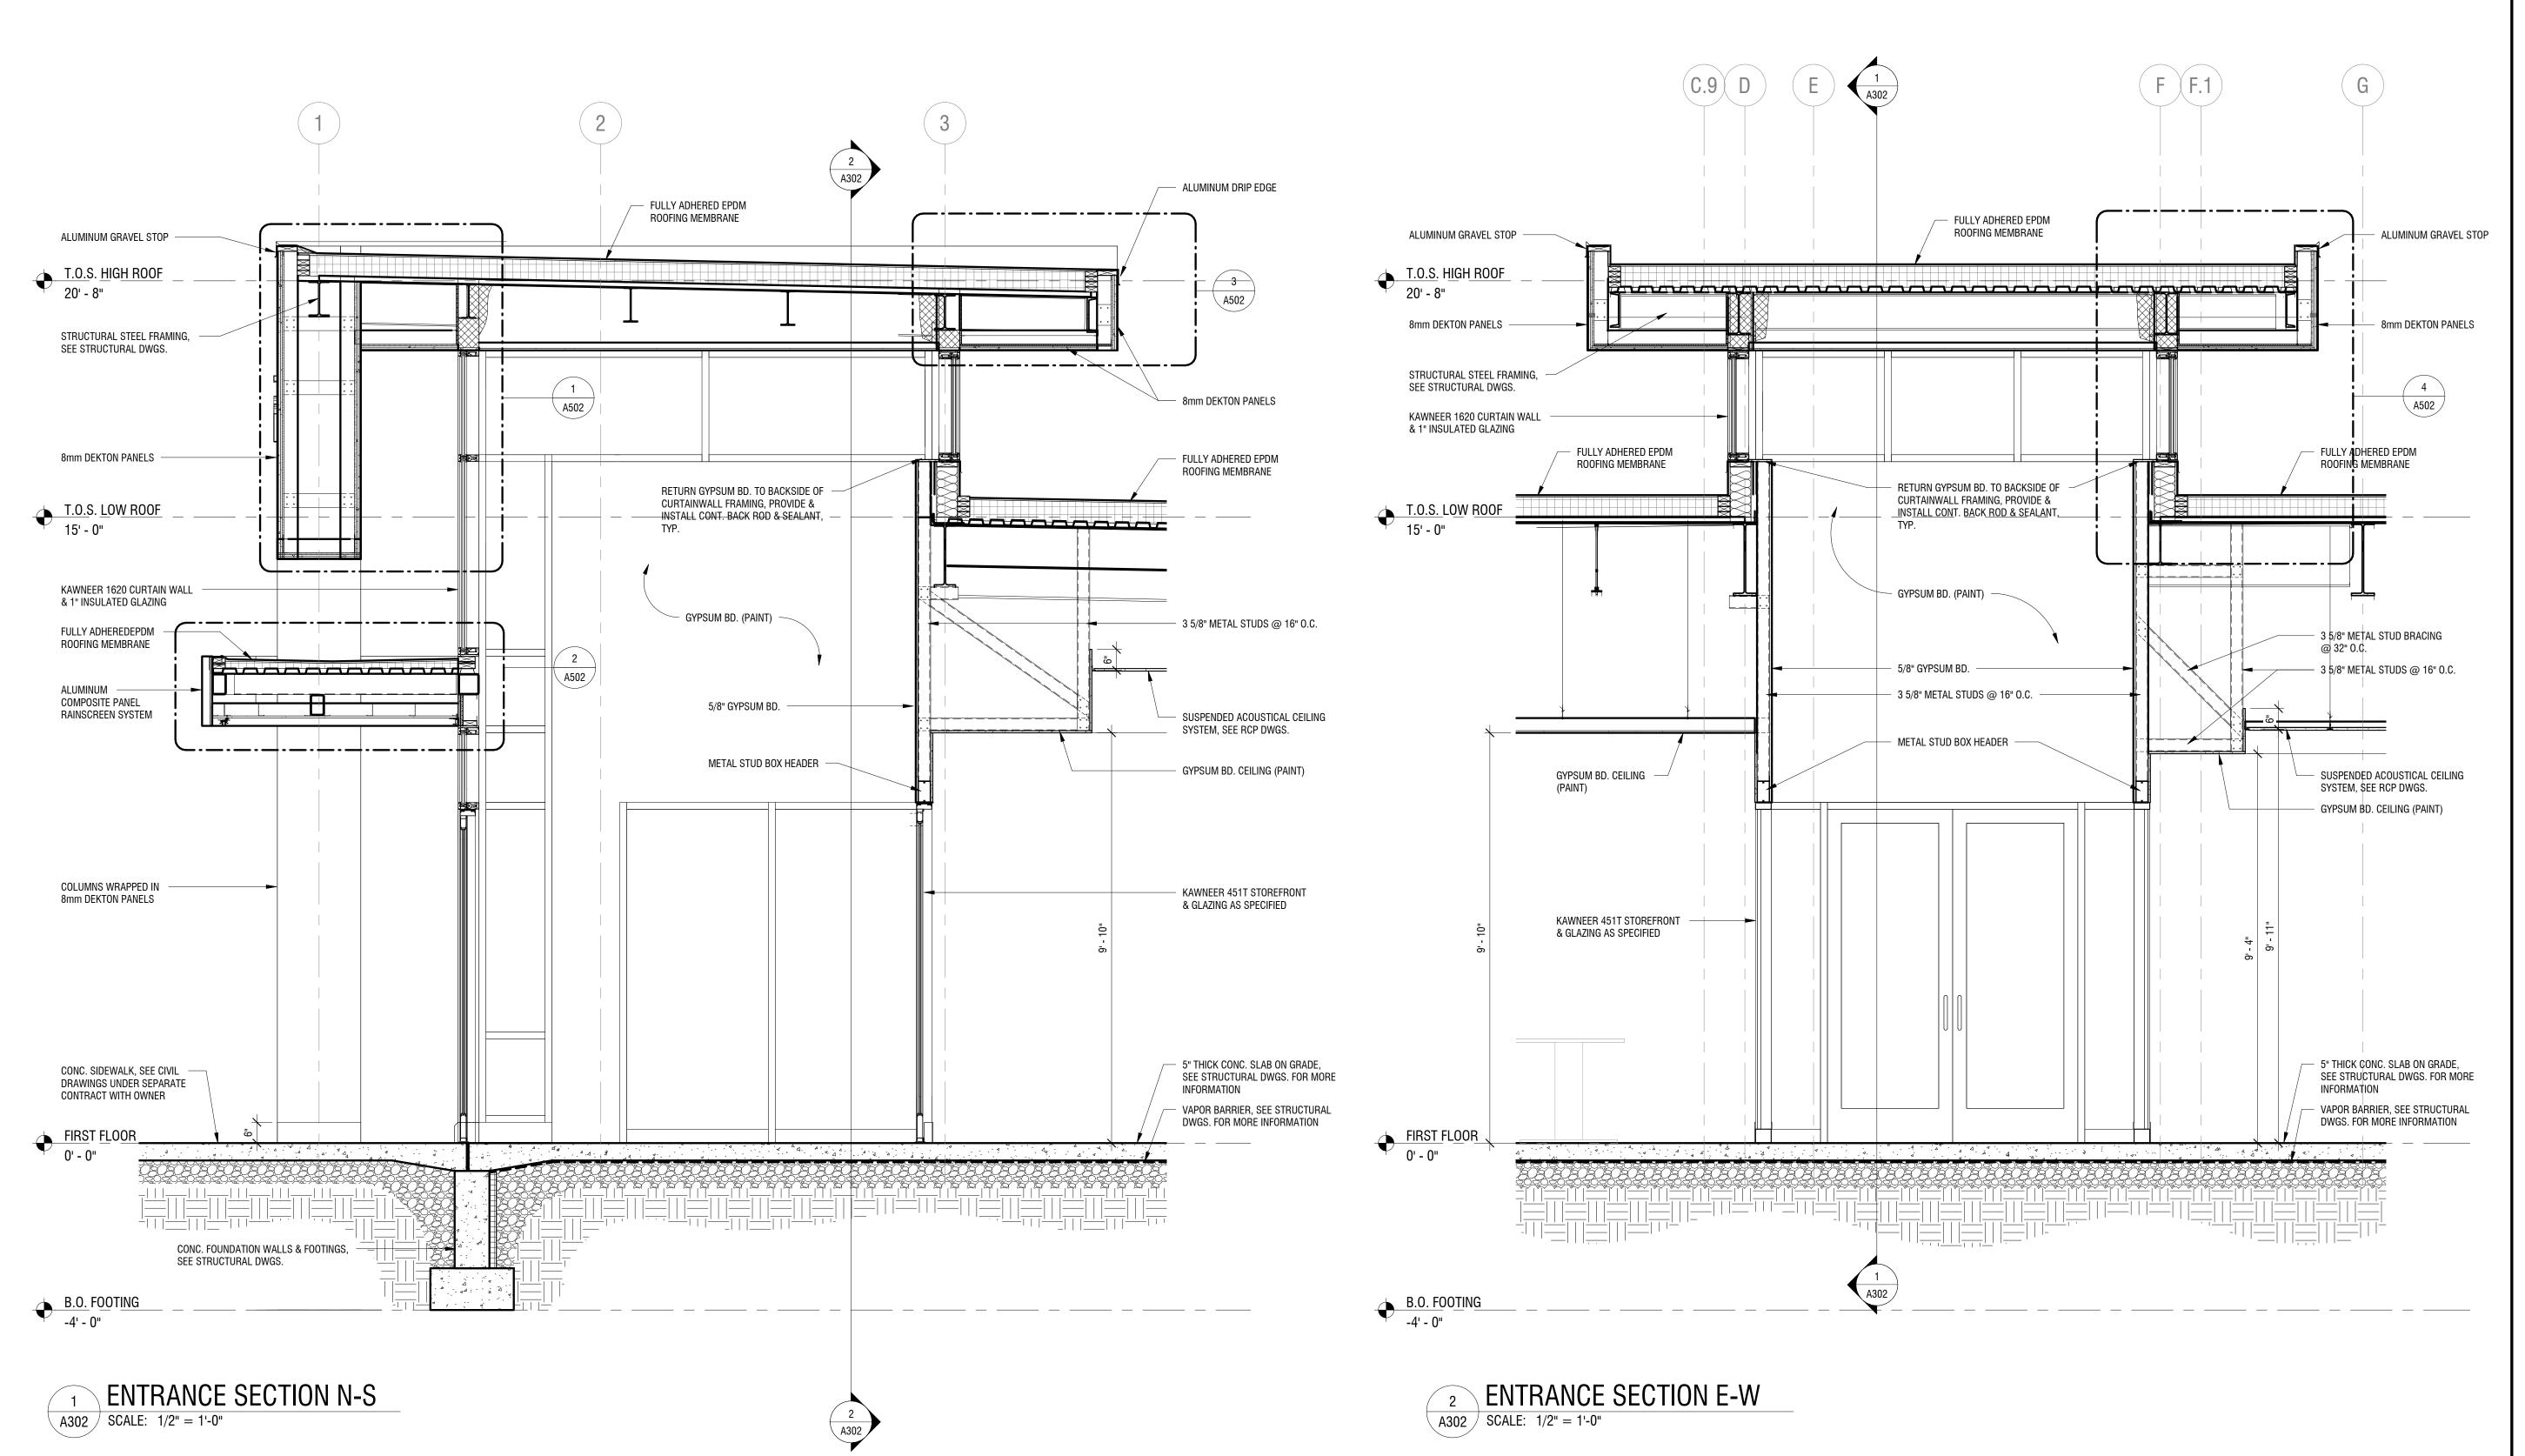
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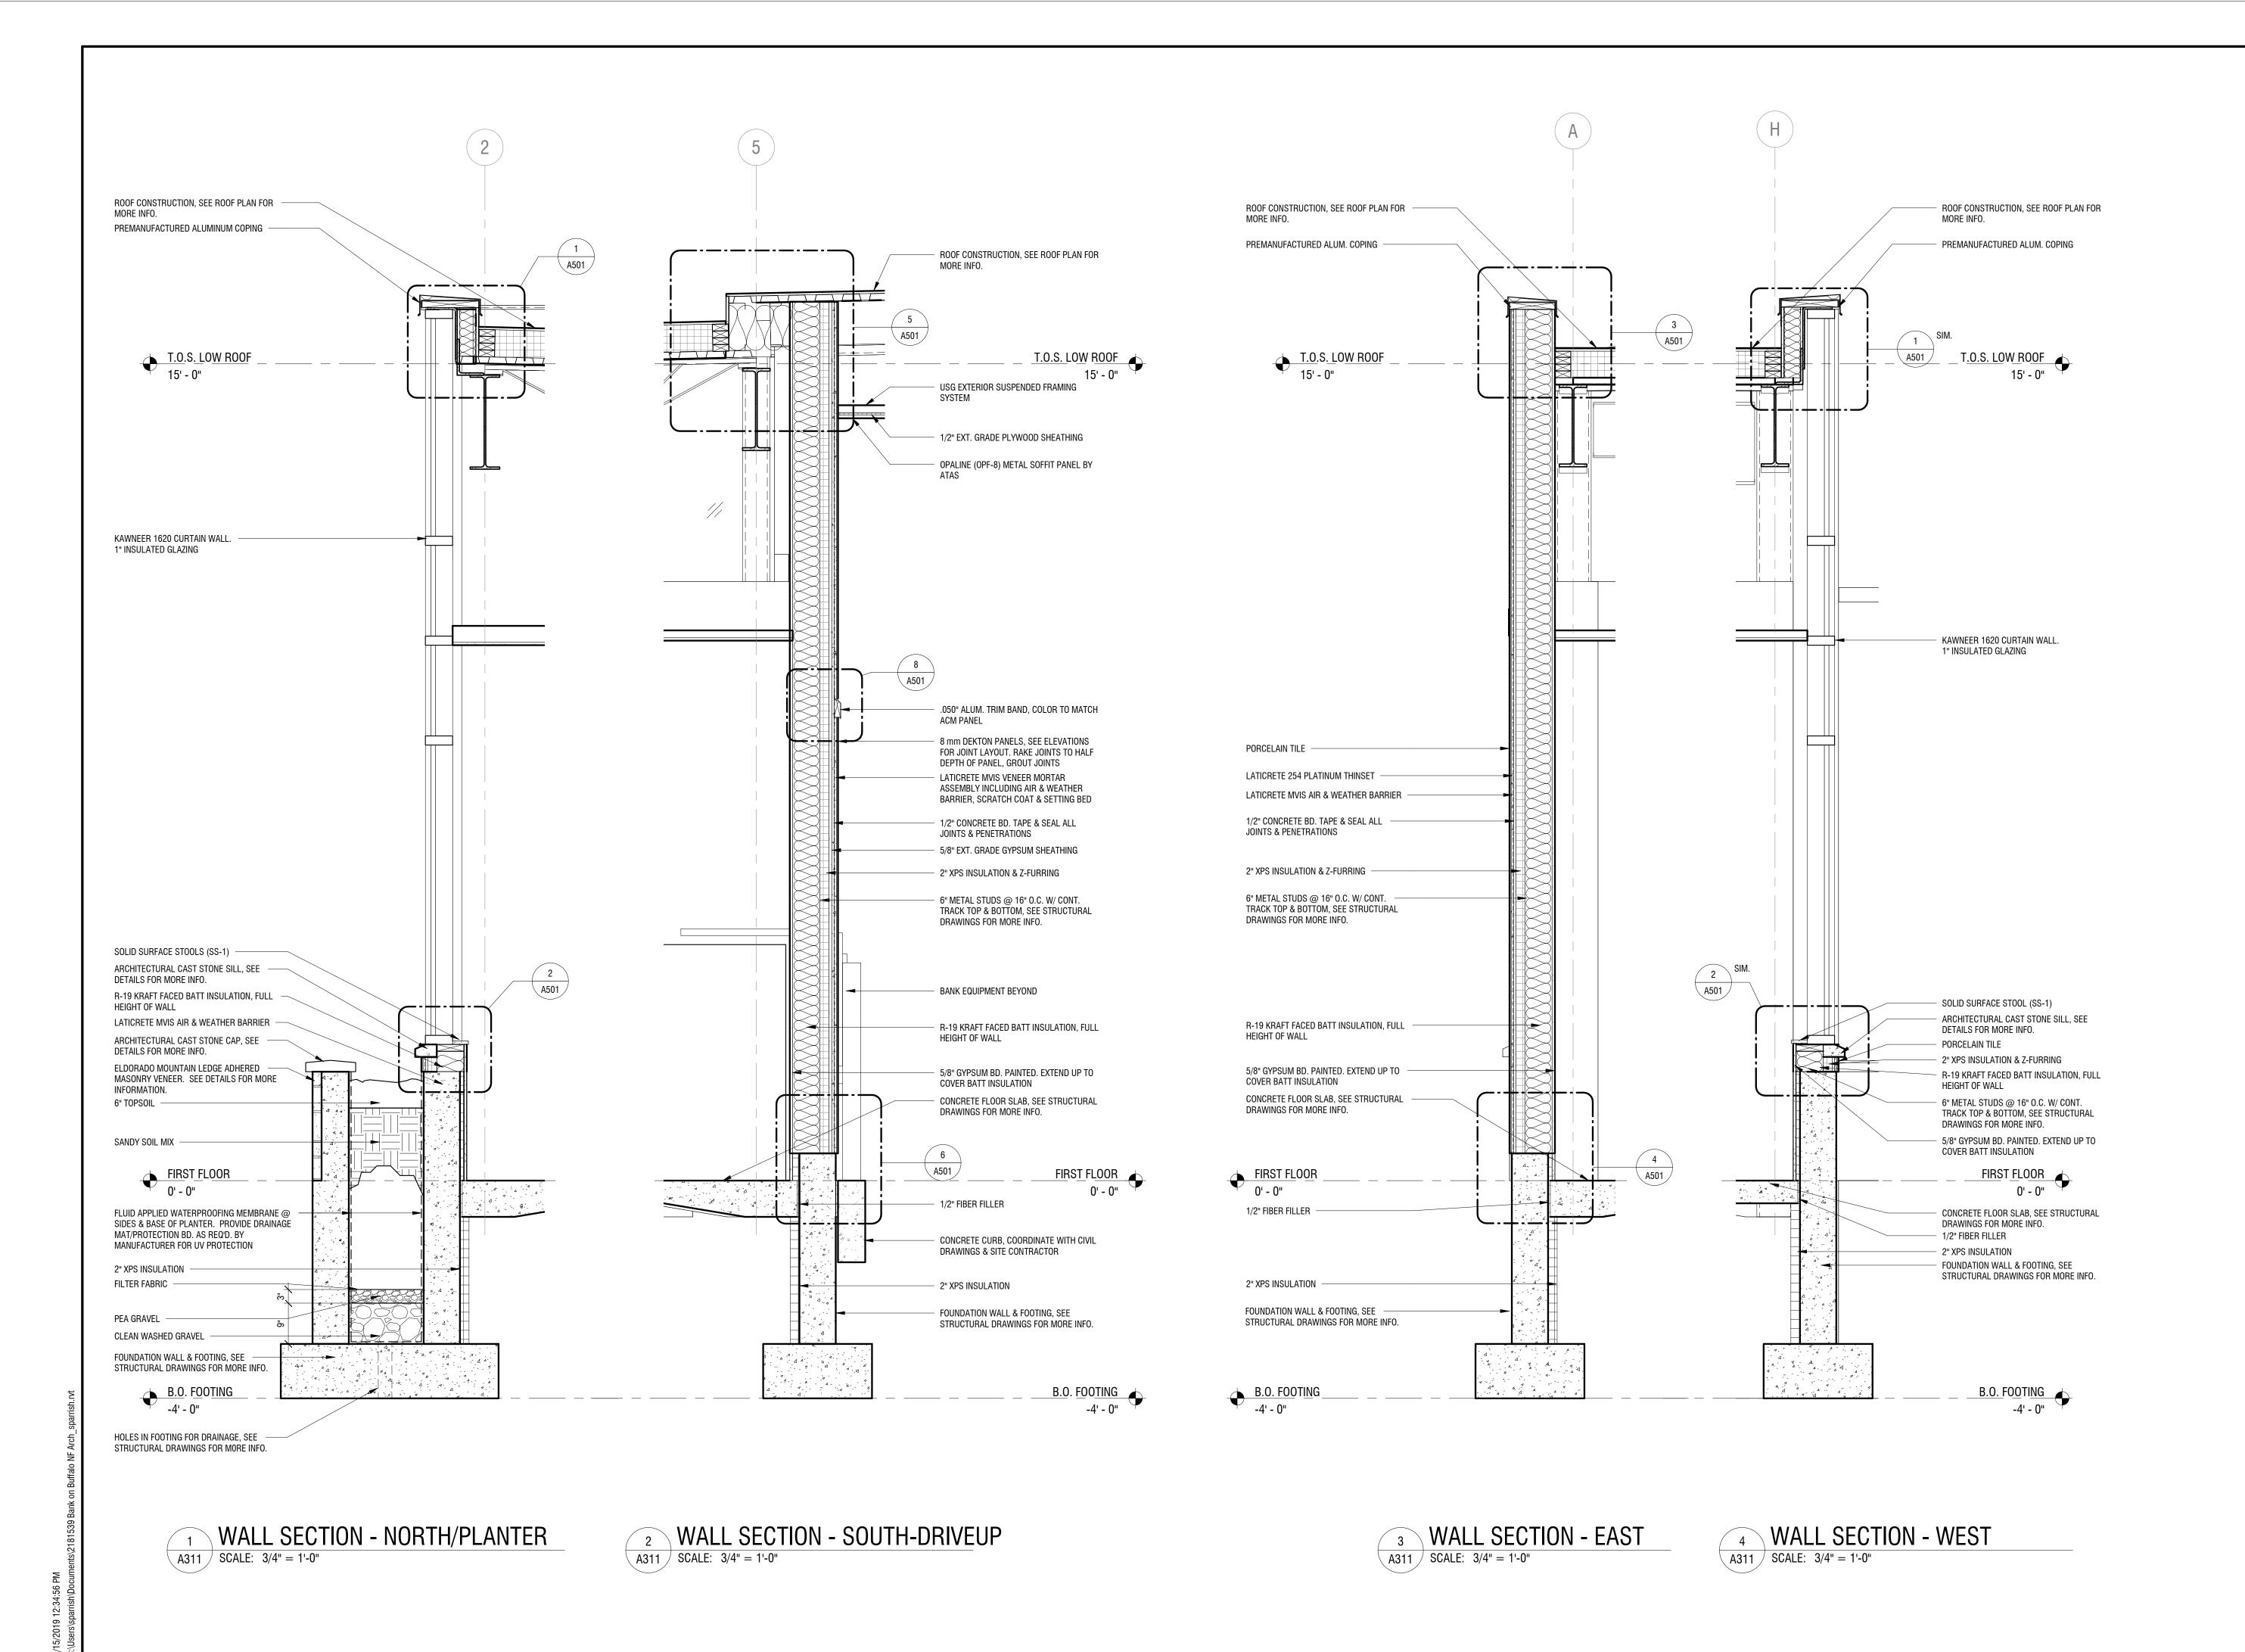
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PROJECT NUMBER:

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REVIEWED BY: RJN

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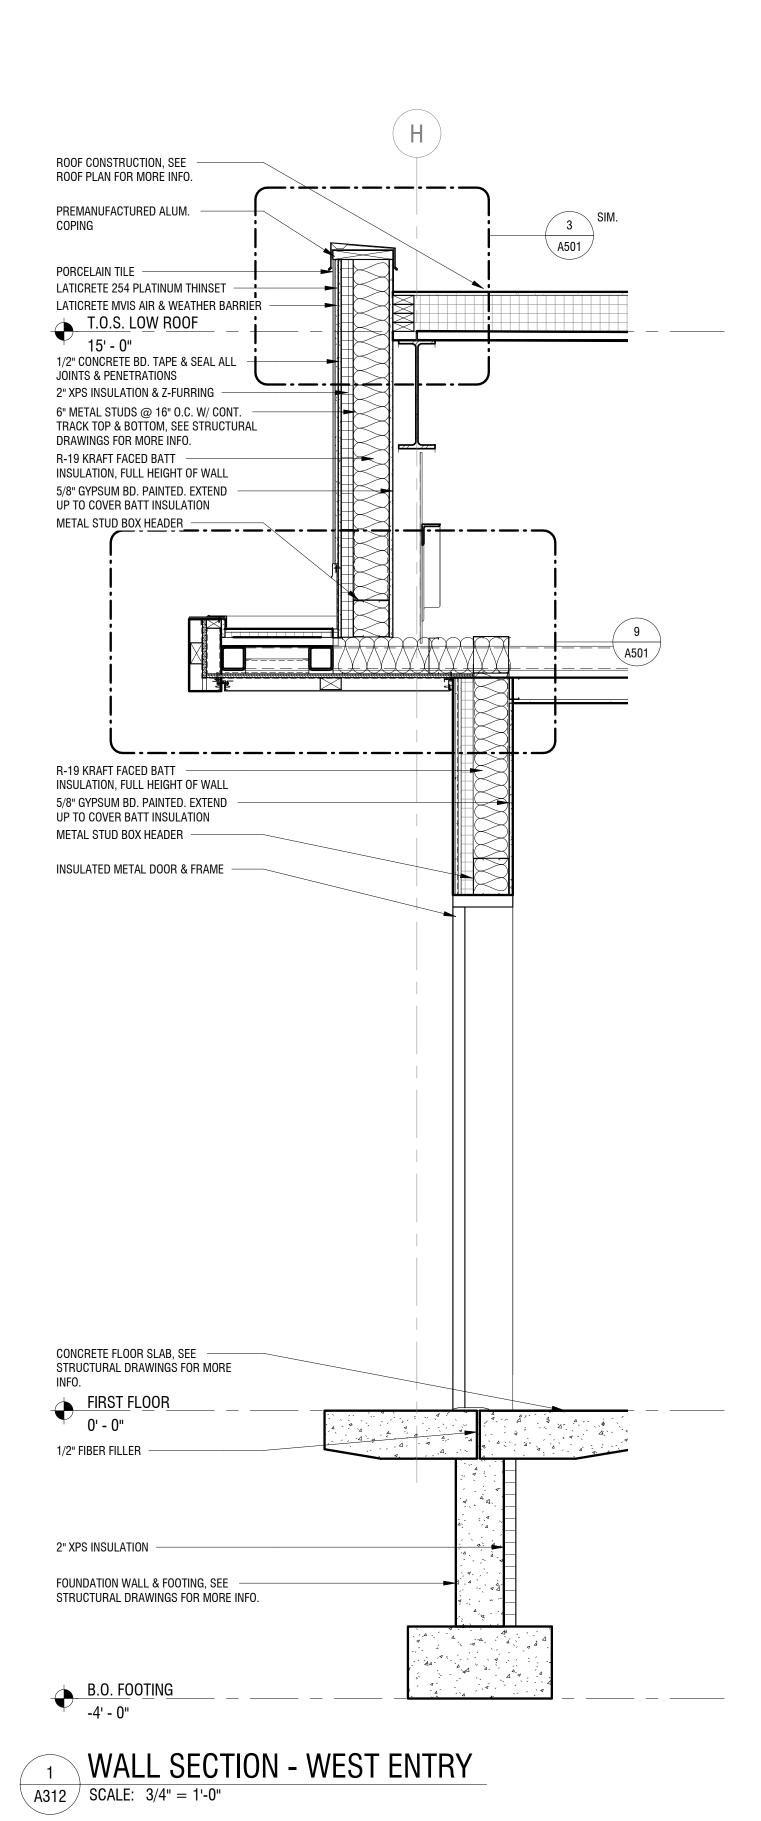
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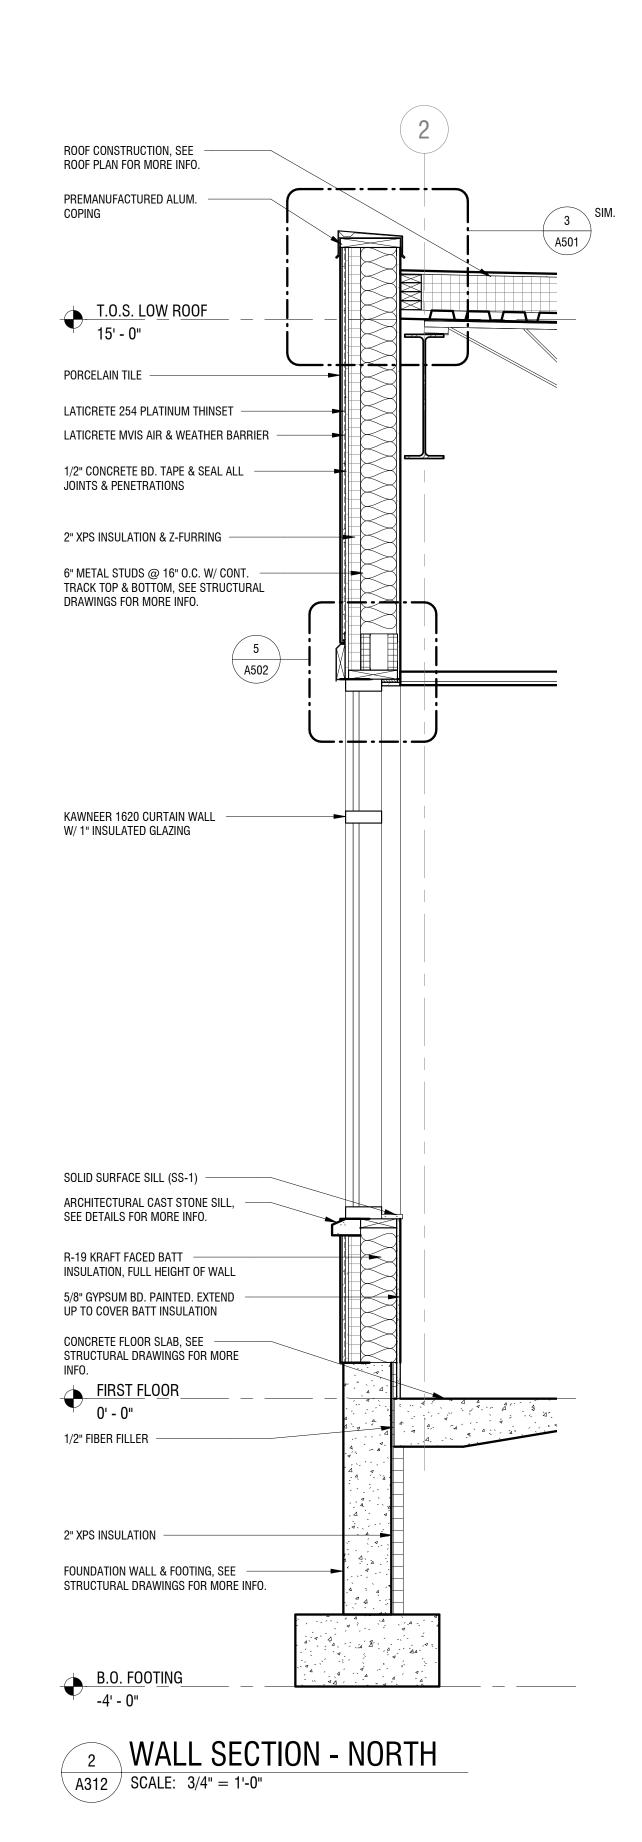
DATE: 8 FEB 2019

DRAWING NAME:

WALL SECTIONS

DRAWING NUMBER:







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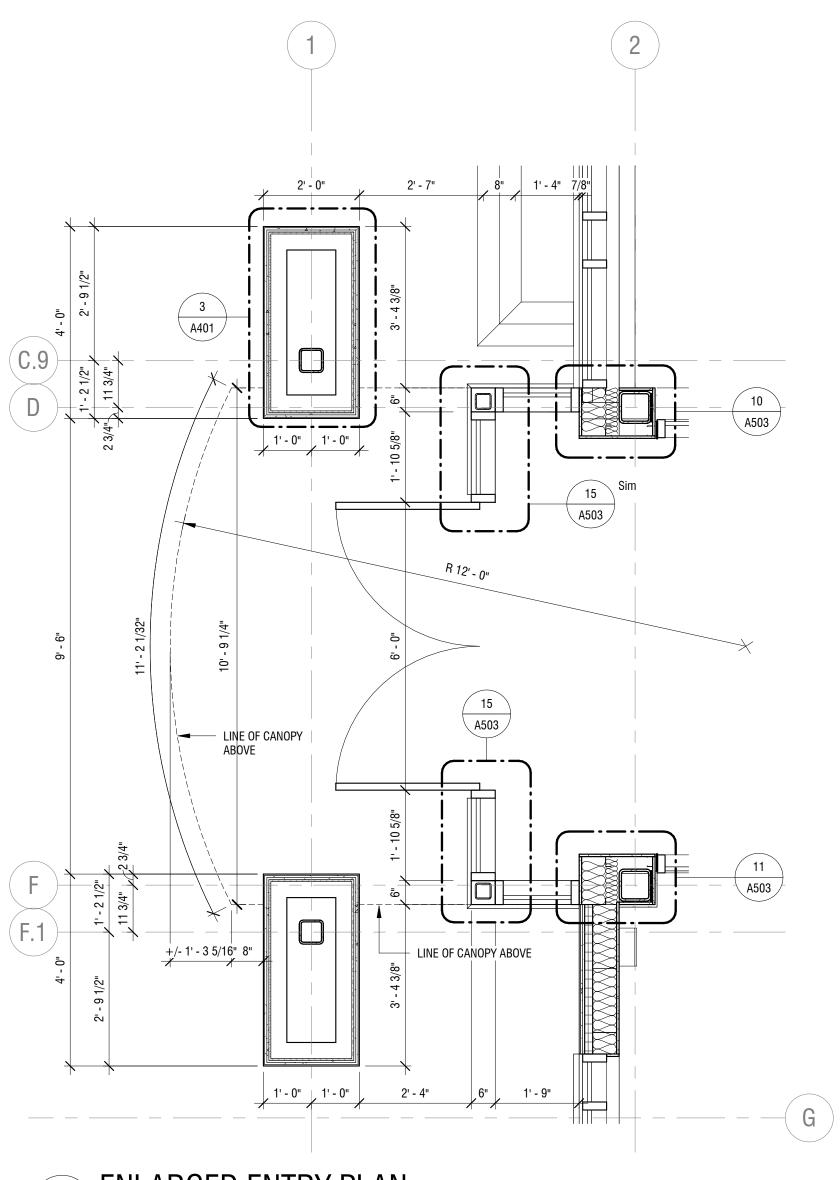
NEW COMMUNITY BRANCH -NIAGARA FALLS

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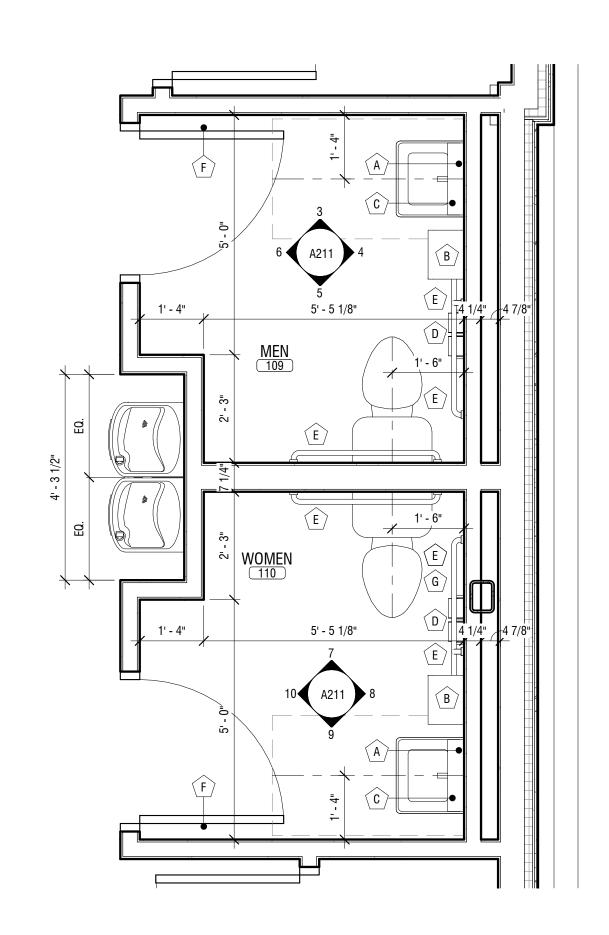
WALL SECTIONS

DRAWING NUMBER:



1 ENLARGED ENTRY PLAN

A401 SCALE: 1/2" = 1'-0"




² ENLARGED BATHROOM PLAN

☼ TOILET ACCESSORIES:

- A. MIRROR: BOBRICK MODEL NO. B-165 2436, 24"W x 36"H, STAINLESS STEEL CHANNEL FRAME MIRROR, MOUNTED W/ REFLECTIVE SURFACE @ 40" AFF (MAX.)
- B. PAPER TOWEL DISPENSER: GEORGIA PACIFIC "ENMOTION" SERIES ELECTRONIC TOWEL SYSTEM,
- MODEL NO. 59462A "BLACK", MOUNT BOTTOM @ 46" AFF.
 C. SOAP DISPENSER: TECHNICAL CONCEPTS/RUBBERMAID "ONESHOT" COUNTERMOUNT AUTOMATIC
- SOAP DISPENSER. MODEL NO FG401310 POLISHED CHROME/BLACK
 D. TOILET PAPER DISPENSER: GEORGIA PACIFIC "COMPACT" DOUBLE ROLL, COVERED HIGH CAPACITY SIDE BY SIDE TISSUE DISPENSER, MODEL NO 56784A "BLACK", MOUNTED PER DETAILS, SHEET G002.
- E. GRAB BARS: BOBRICK MODEL NOS. 5806-18, 5806-36 & 5806-42, 1-1/4" O.D., SNAP-FLANGE STAINLESS STEEL TUBING W/ PEENED, NON-SLIP GRIPPING SURFACE, MOUNTED PER DETAILS, SHEET
- G002.
 F. HOOKS: BOBRICK MODEL NO. B-76717, SATIN STAINLESS STEEL, SINGLE ROBE HOOK @ BACK SIDE
- OF DOOR. COORDINATE MOUNTING HEIGHT & LOCATION W/ OWNER.

 G. SANITARY NAPKIN DISPOSAL: BOBRICK MODEL B-270, STAINLESS STEEL, SURFACE MOUNTED, MOUNTED PER DETAILS, SHEET GO02.

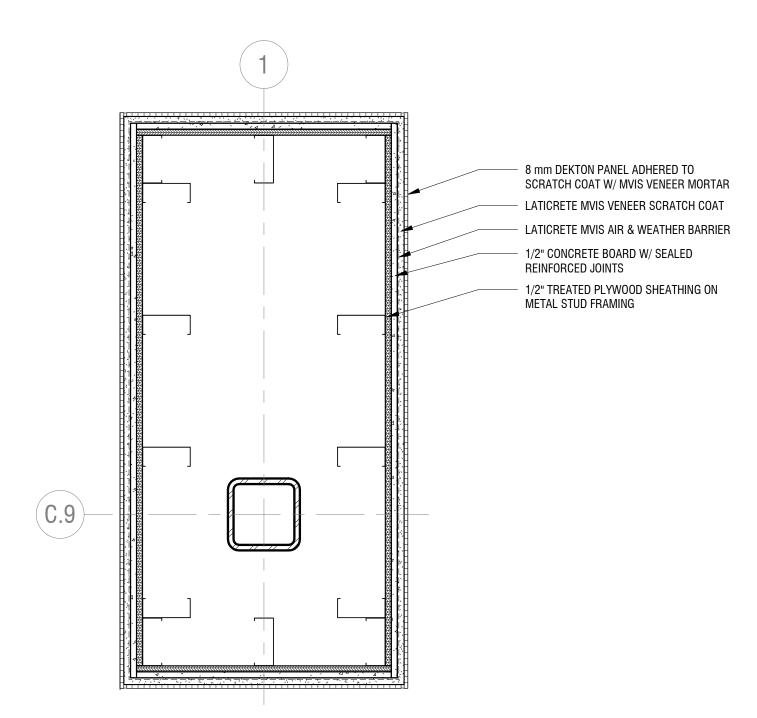

3 ENLARGED ENTRY PIER DETAIL

A401 SCALE: 1 1/2" = 1'-



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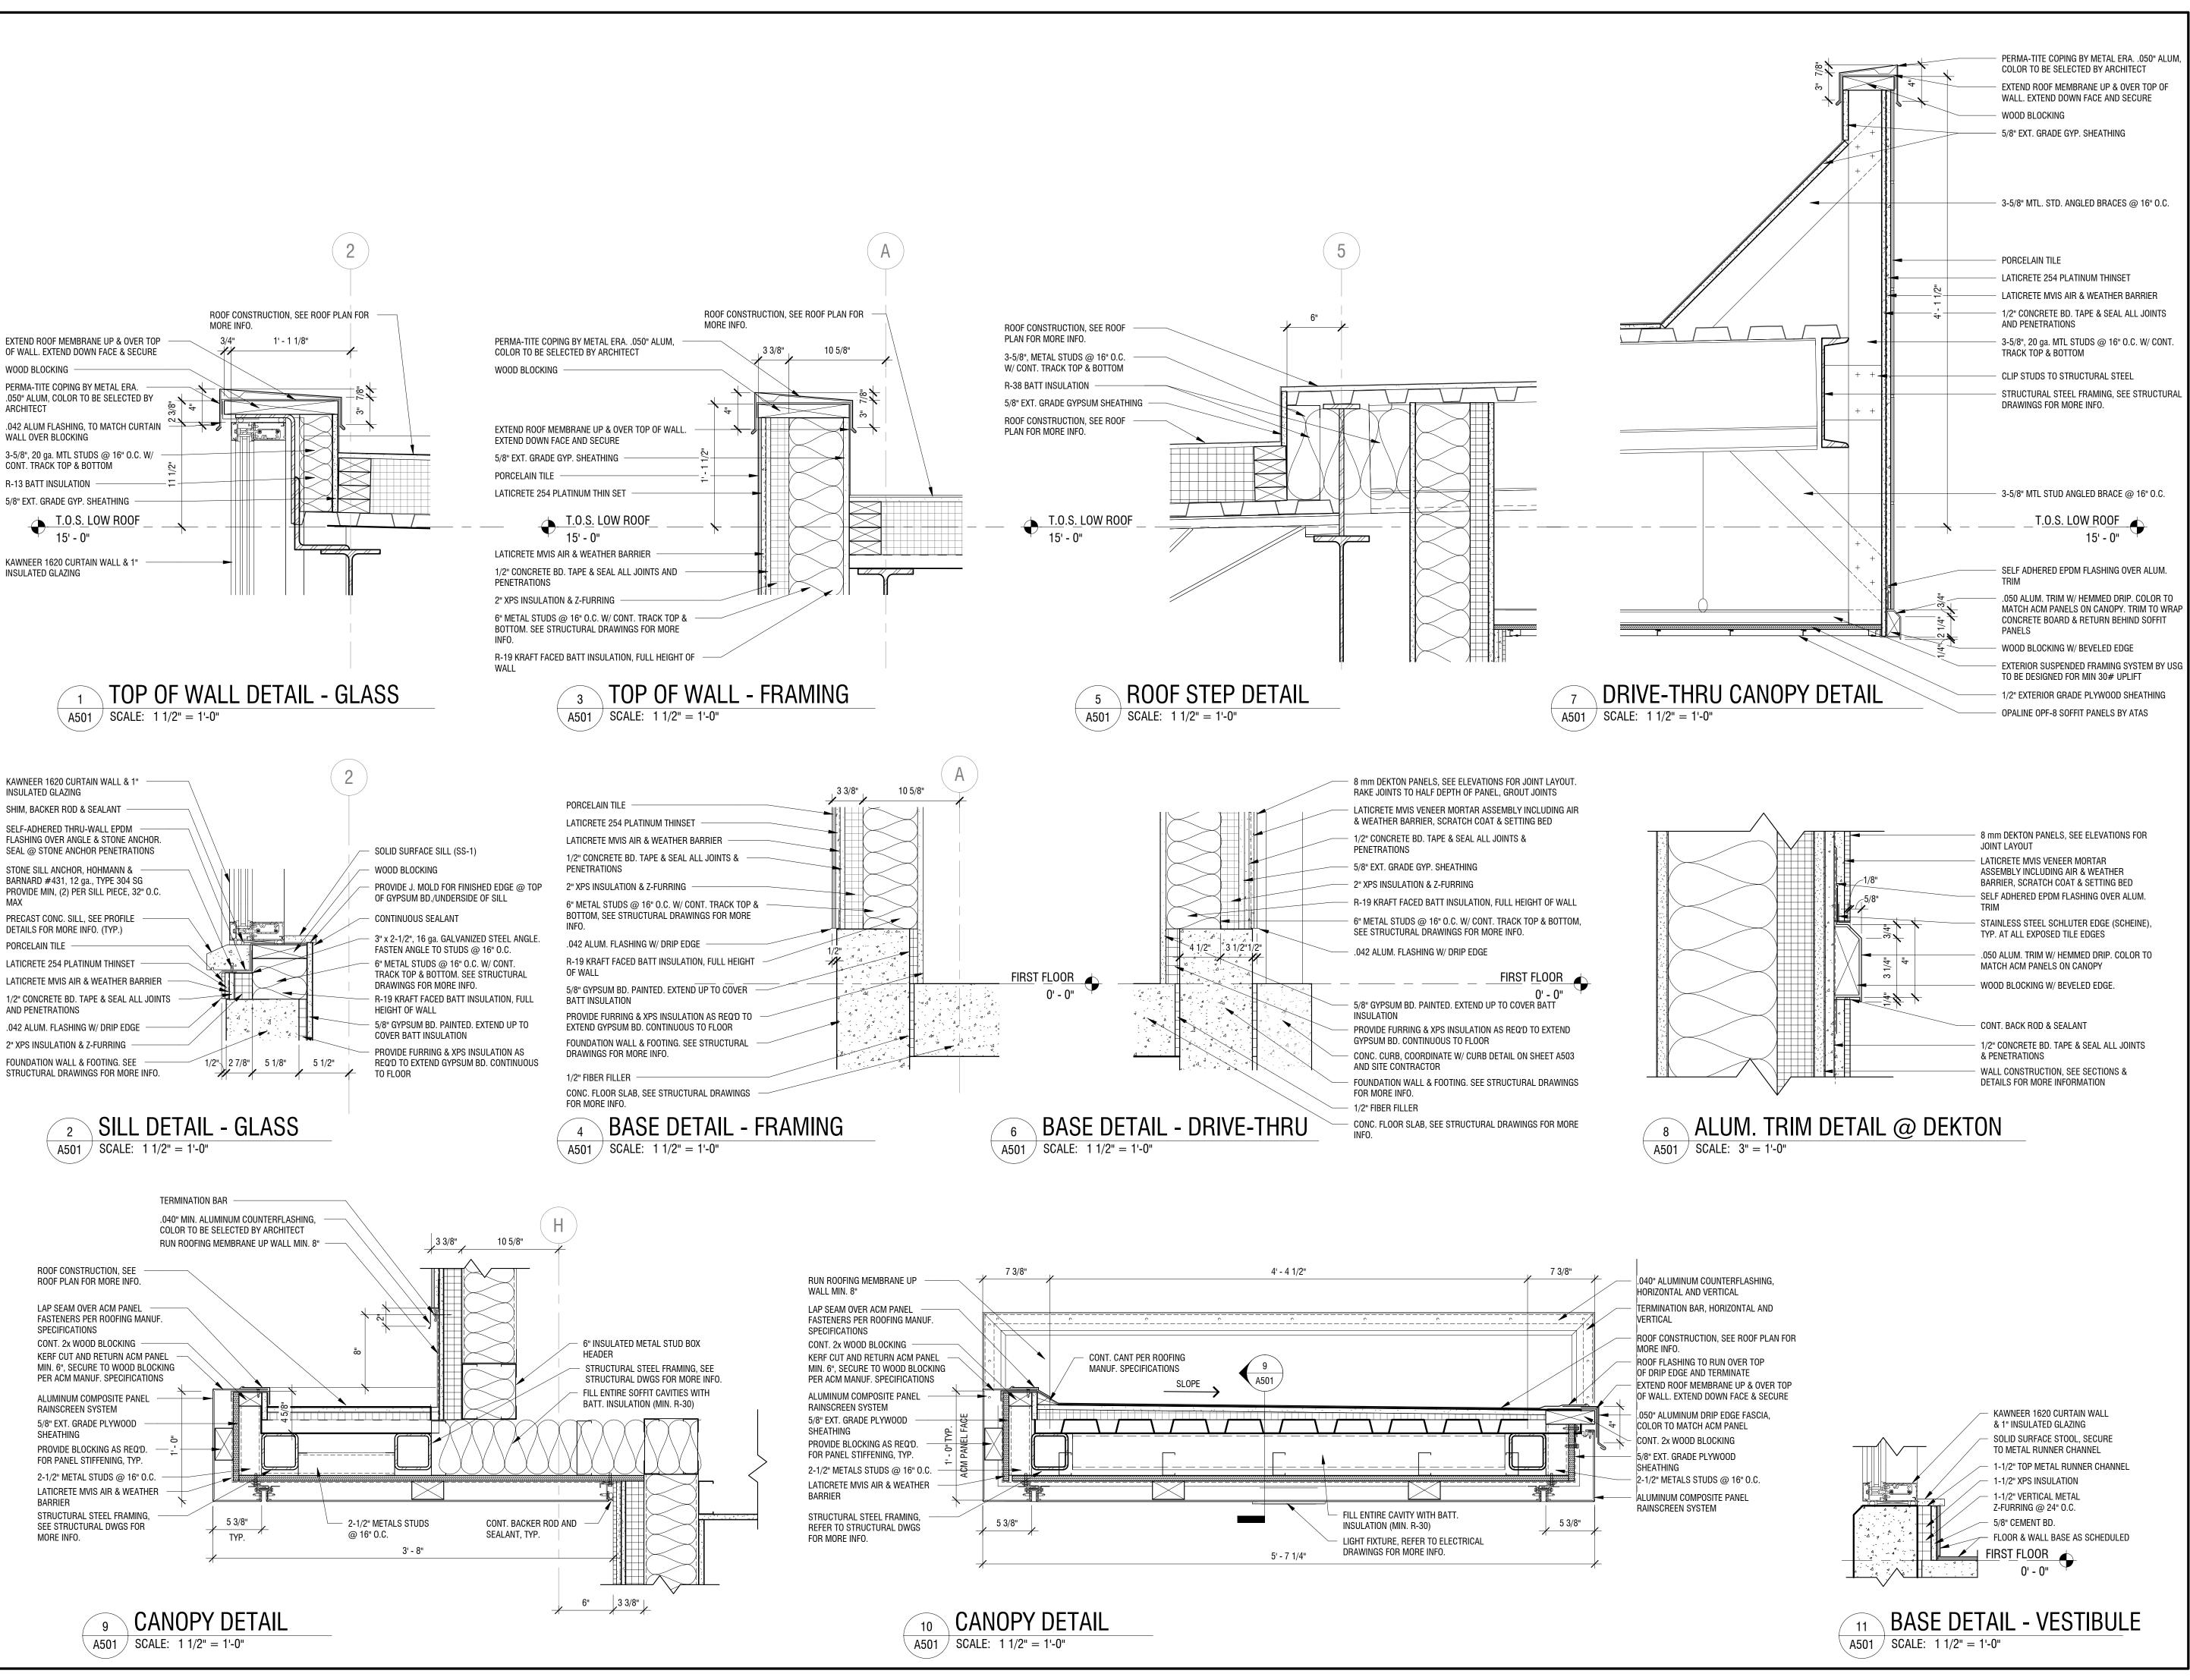
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DATE:		8 FEB 2019	

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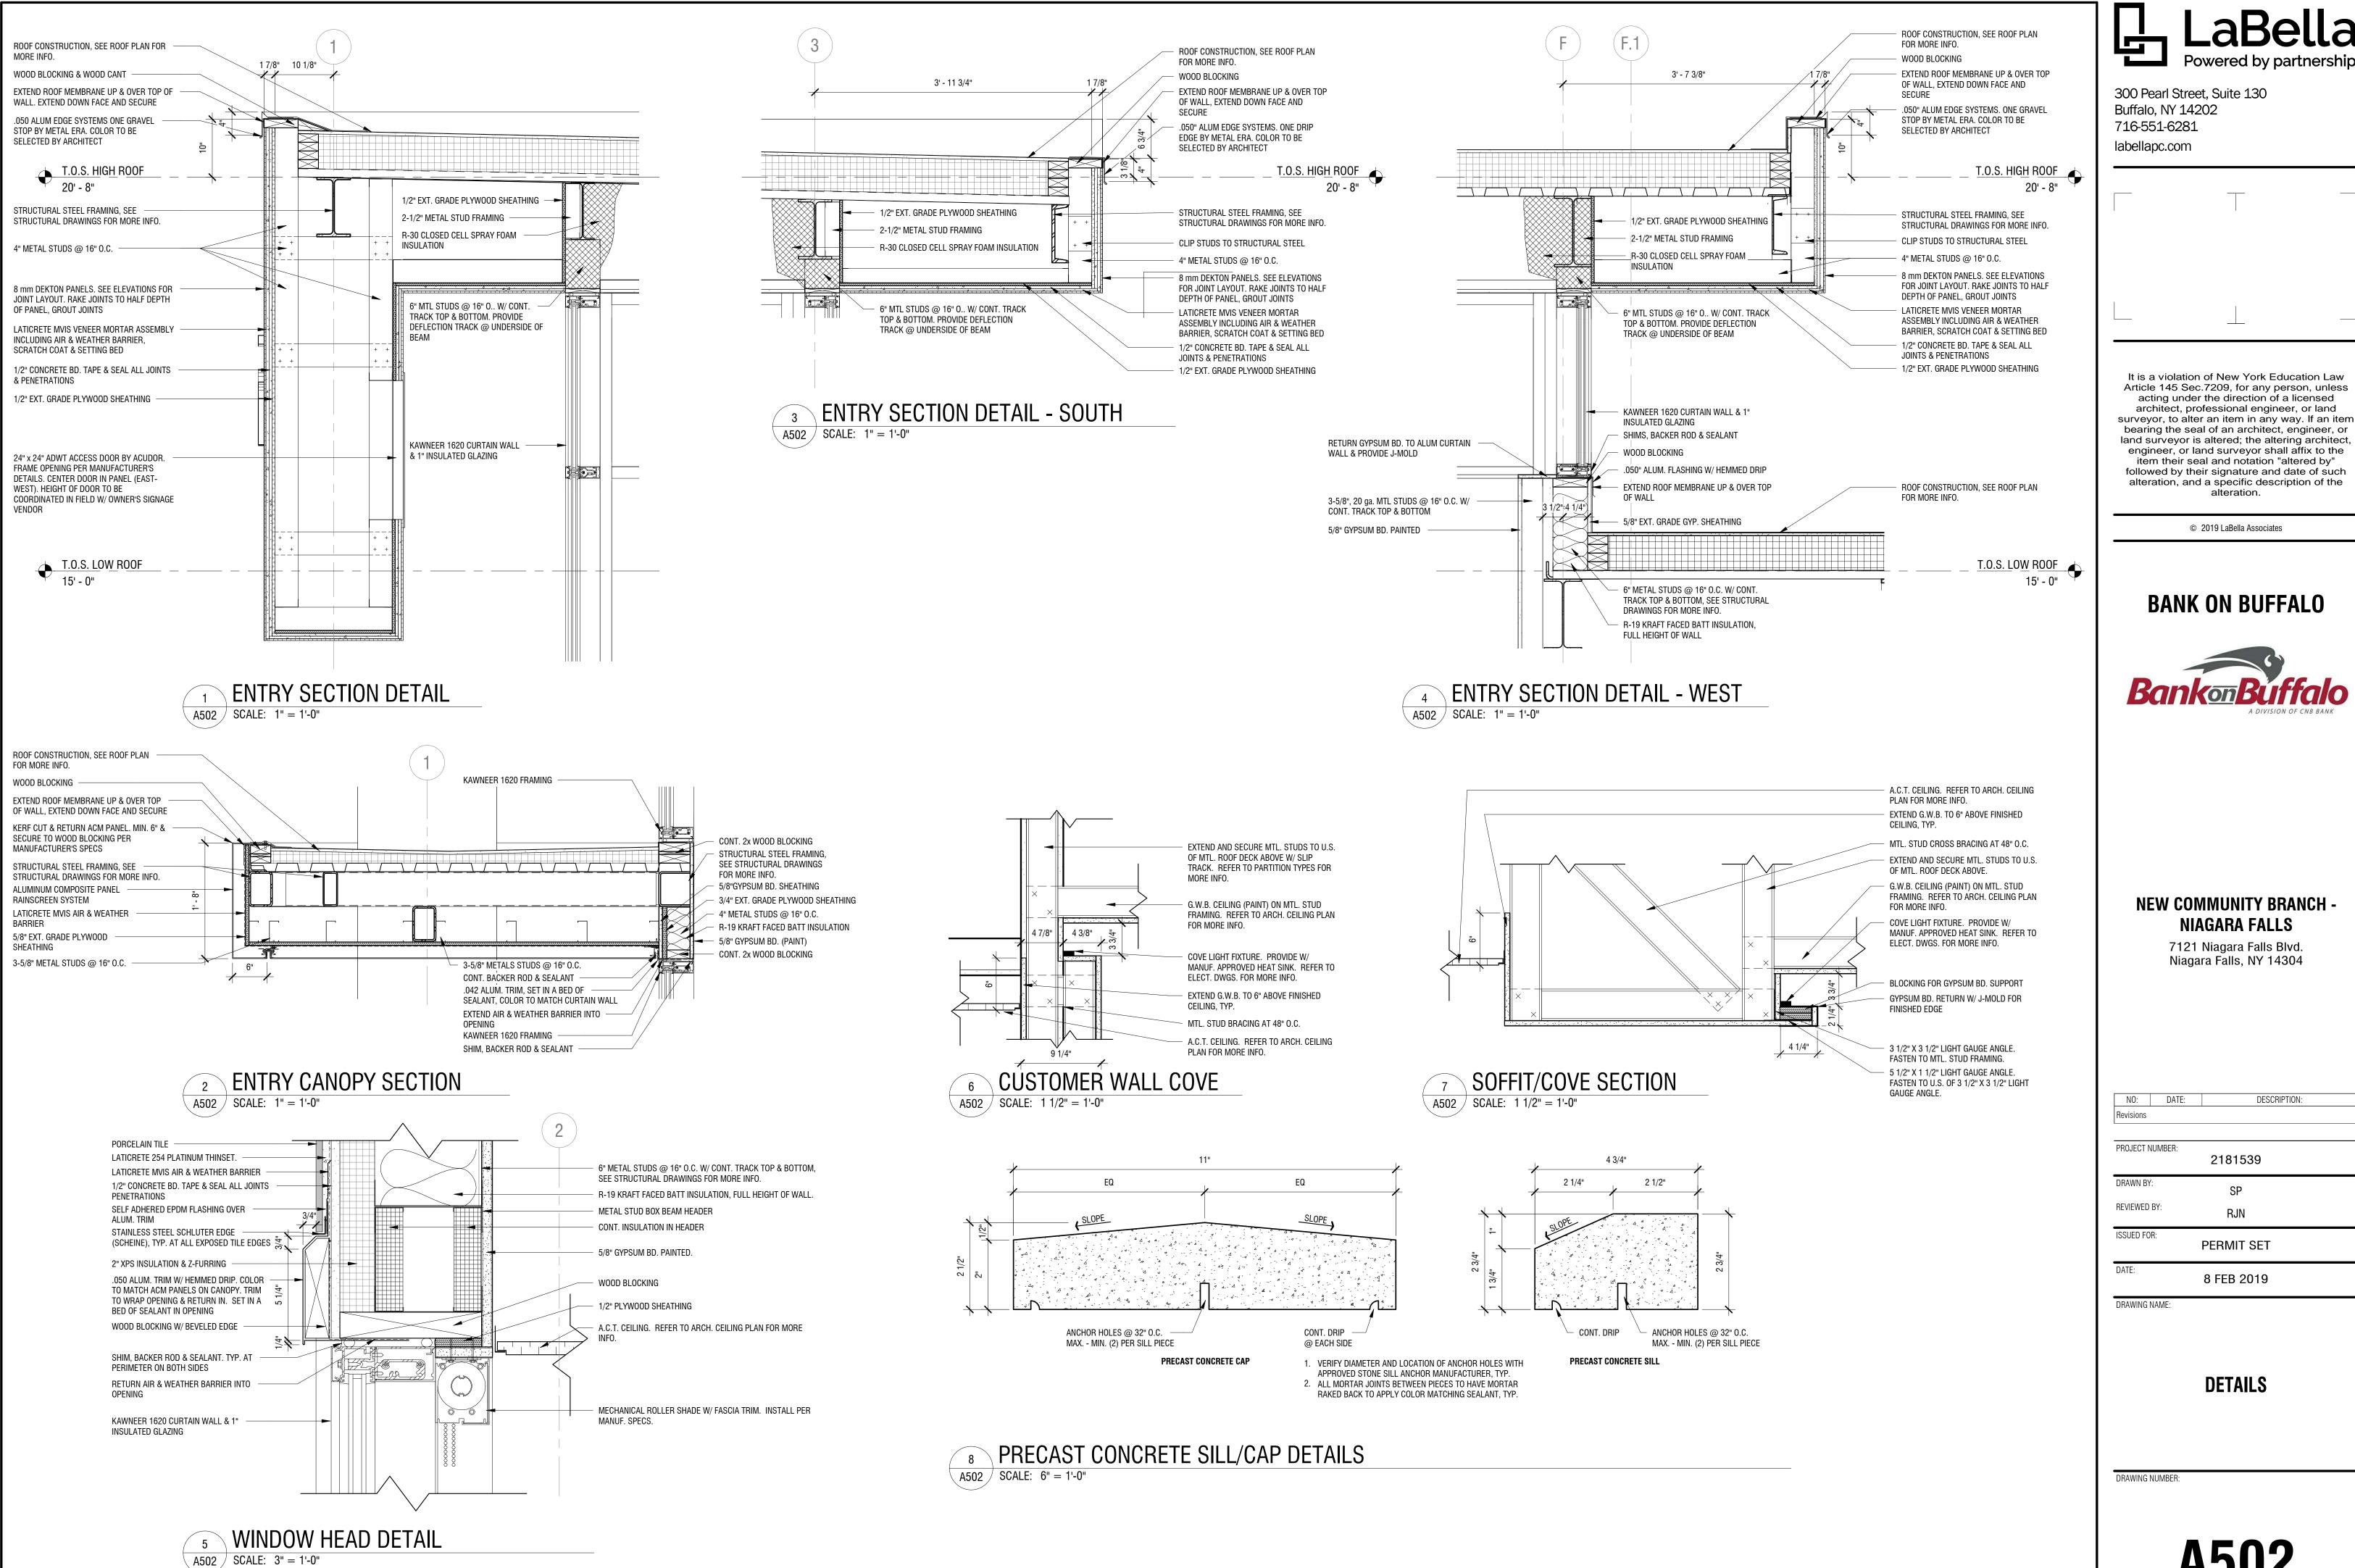
NEW COMMUNITY BRANCH - NIAGARA FALLS

7121 Niagara Falls Blvd. Niagara Falls, NY 14304

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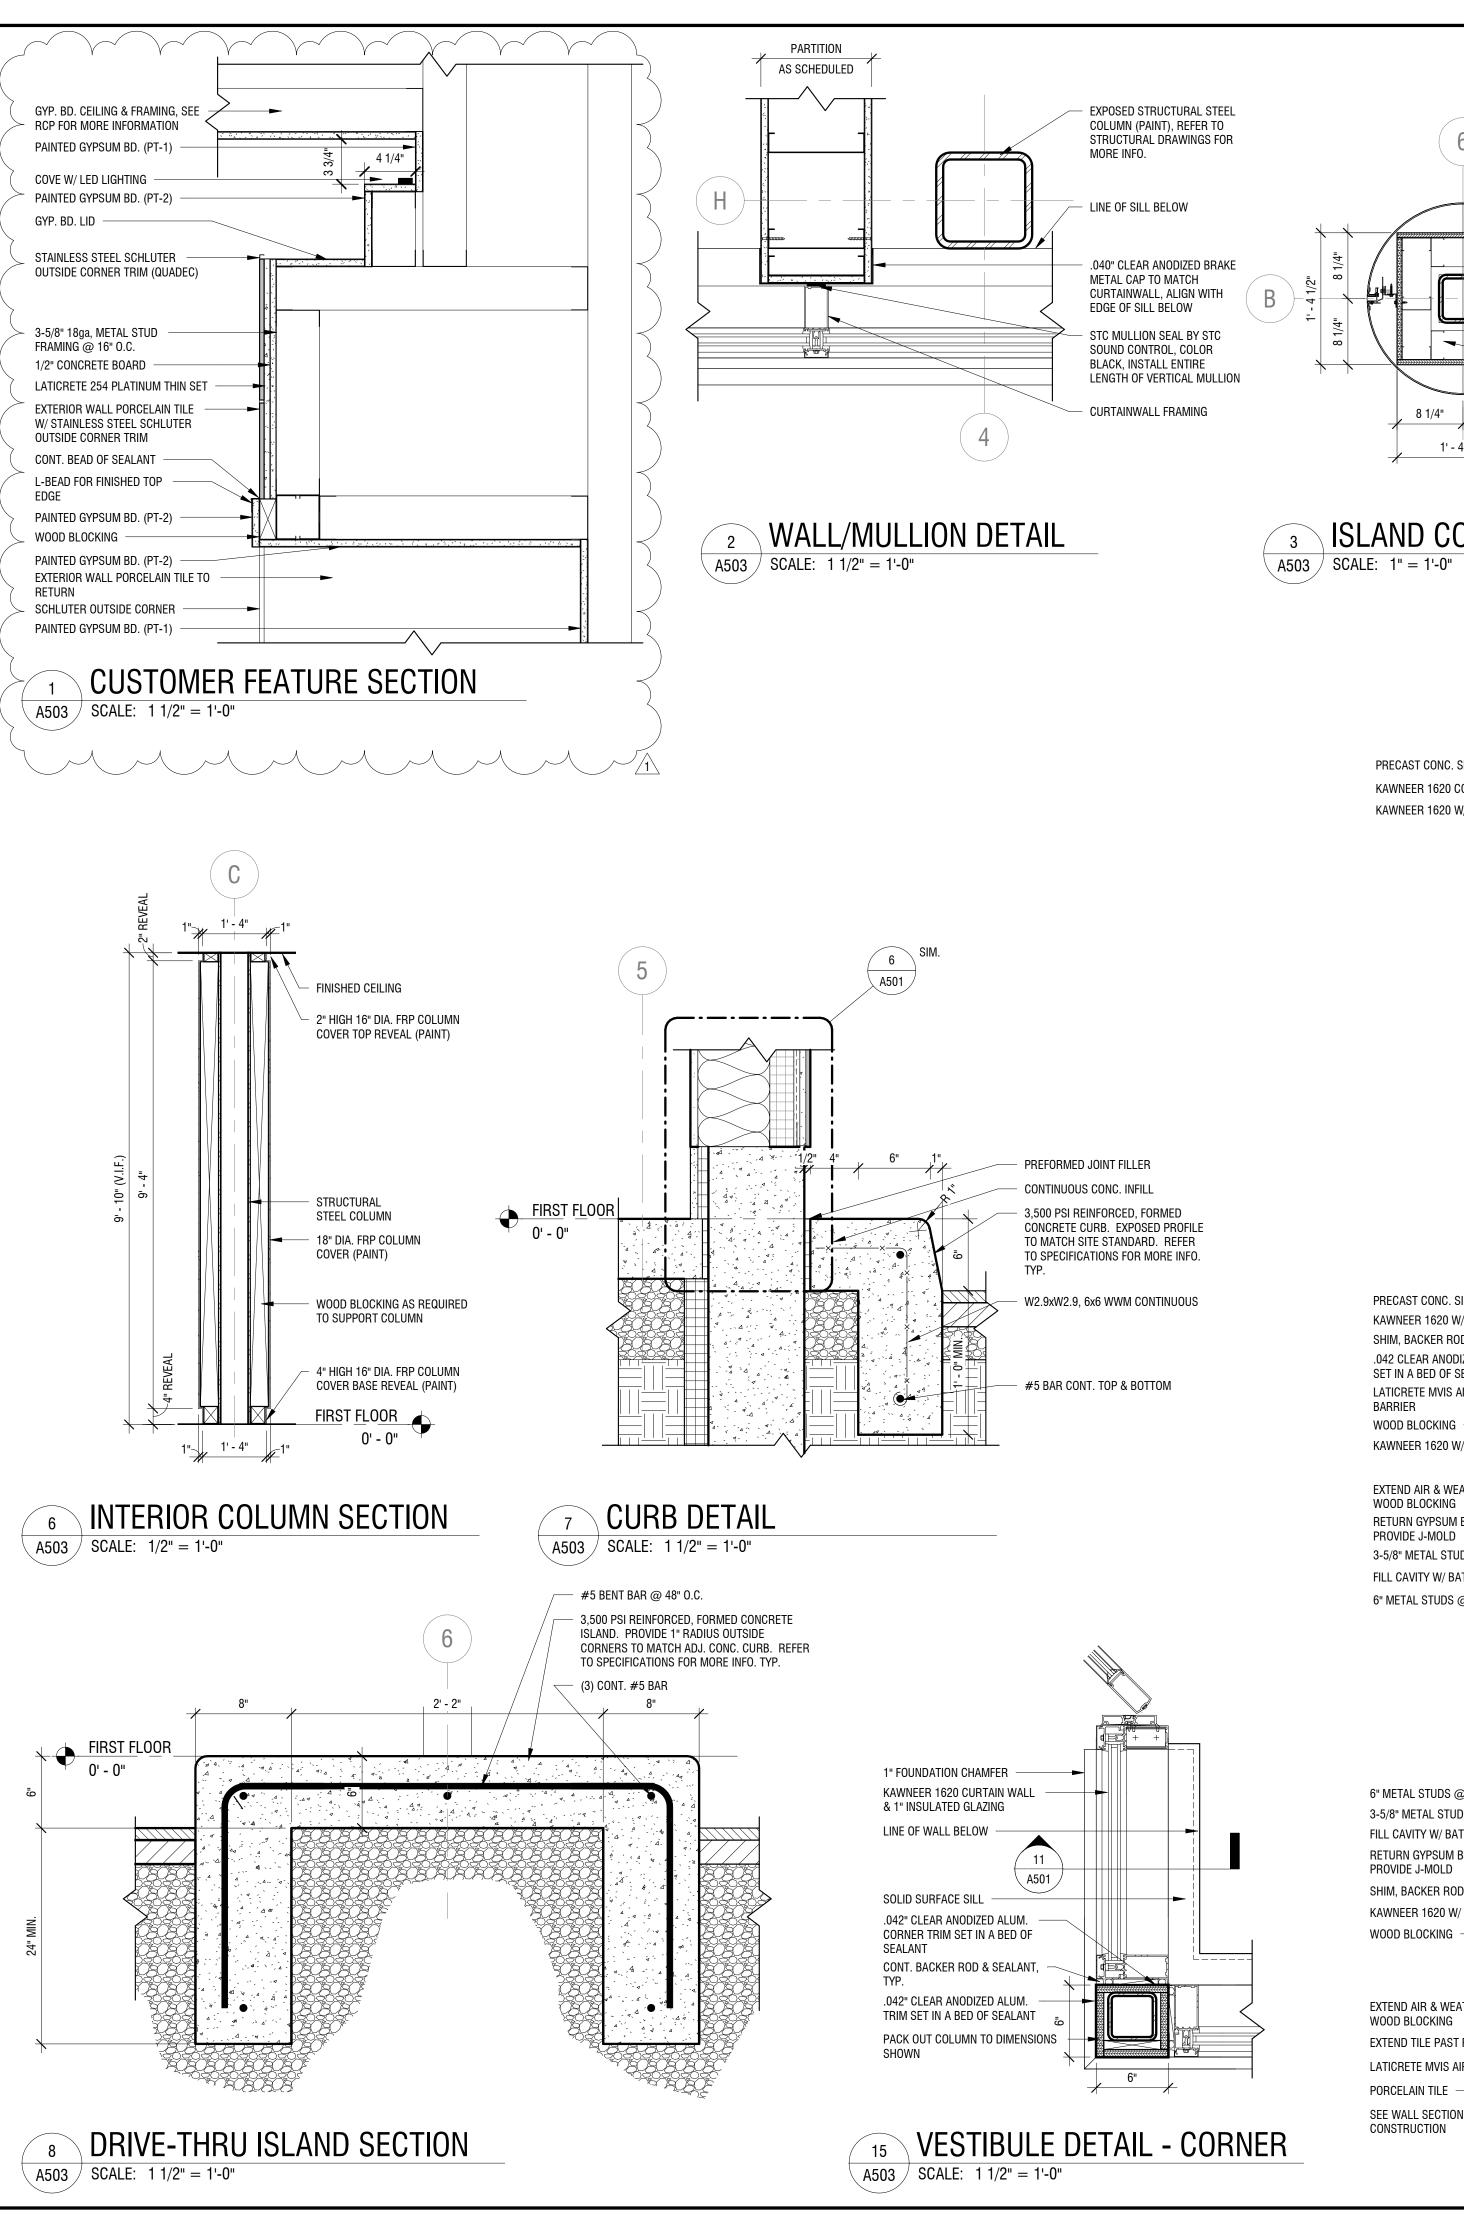
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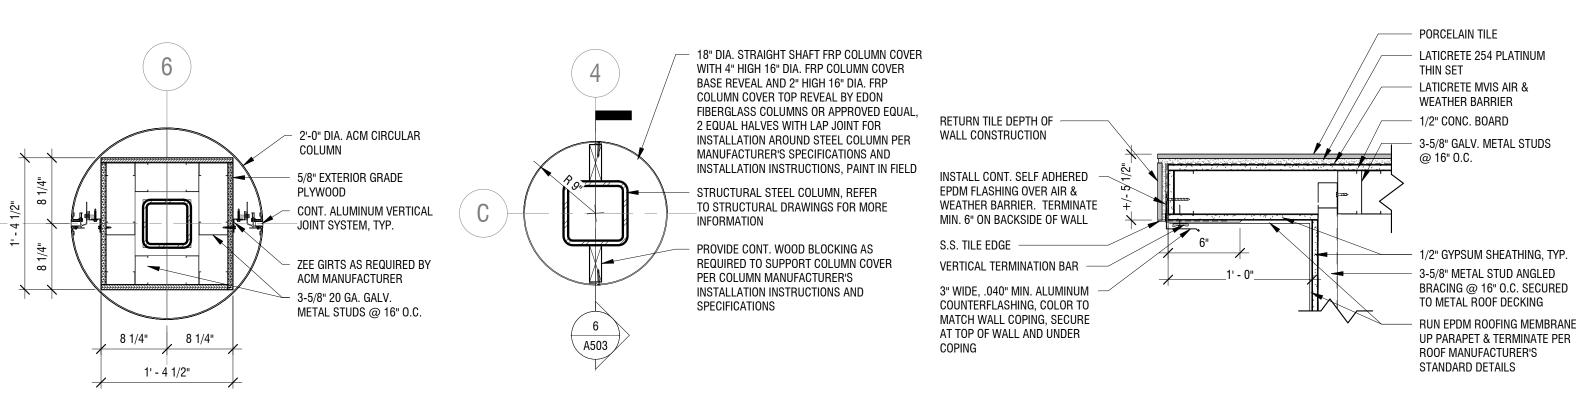
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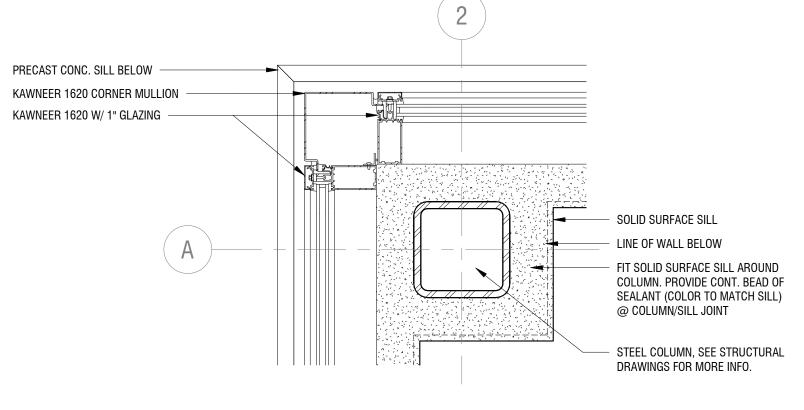
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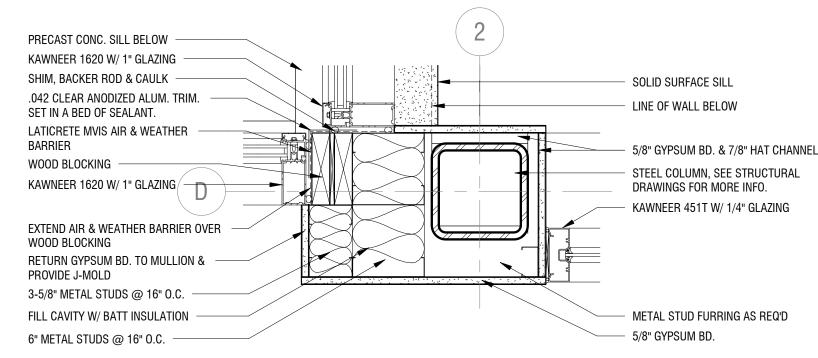


3 ISLAND COLUMN DETAIL


4 INTERIOR COLUMN DETAIL A503 SCALE: 1" = 1'-0"



COLUMN DETAIL A503 \int SCALE: 1 1/2" = 1'-0"



VESTIBULE DETAIL - EAST A503 SCALE: 1 1/2" = 1'-0"

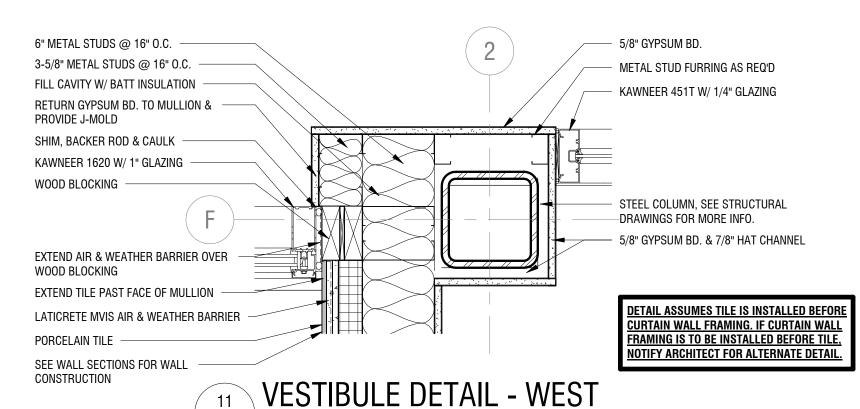

A503 | SCALE: 1 1/2" = 1'-0"


SCALE: 1 1/2" = 1'-0"

KAWNEER 1620 CURTAIN WALL & 1" INSULATED GLAZING STAINLESS STEEL SCHLUTER EDGE (SCHIENE) TYP. AT ALL EXPOSED TILE EDGES SHIM, BACKER ROD & SEALANT. TYP. AT PERIMETER ON BOTH SIDES WOOD BLOCKING PORCELAIN TILE LATICRETE 254 PLATINUM THINSET LATICRETE MVIS AIR & WEATHER BARRIER 1/2" CONCRETE BD. TAPE & SEAL ALL JOINTS AND PENETRATIONS 2" XPS INSULATION & Z-FURRING 6" METAL STUDS @ 16" O.C. W/ CONT. TRACK TOP & BOTTOM. SEE STRUCTURAL DRAWINGS FOR MORE INFO. R-19 KRAFT FACED BATT INSULATION, FULL HEIGHT OF WALL 5/8" GYPSUM BD. PAINTED

CONC. SILL BELOW


SOLID SURFACE SILL BELOW (SS-1)

12 WINDOW JAMB DETAIL A503 / SCALE: 3" = 1'-0"

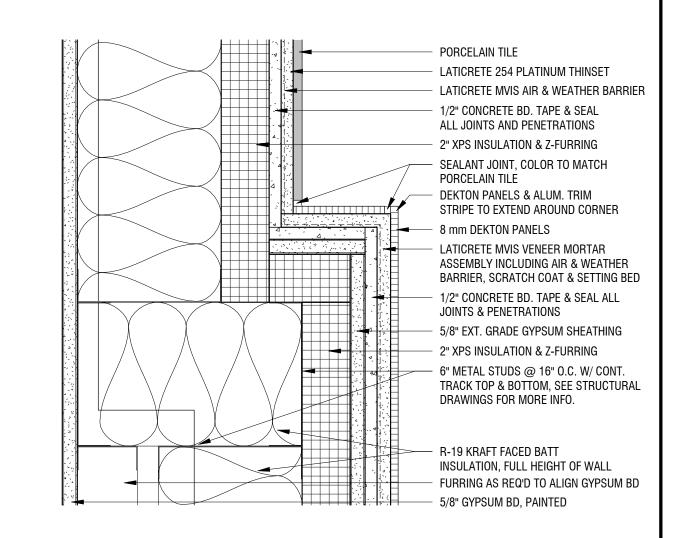

13 BUMP OUT CORNER DETAIL

A503 SCALE: 3" = 1'-0"

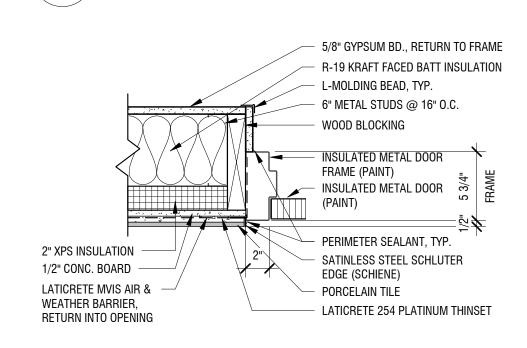

14 H.M. DOOR JAMB DETAIL (HEAD SIM.)

A503 | SCALE: 1 1/2" = 1'-0"

300 Pearl Street, Suite 130 Buffalo, NY 14202 716-551-6281 labellapc.com

It is a violation of New York Education Law Article 145 Sec.7209, for any person, unless acting under the direction of a licensed

bearing the seal of an architect, engineer, or land surveyor is altered; the altering architect, engineer, or land surveyor shall affix to the item their seal and notation "altered by" followed by their signature and date of such alteration, and a specific description of the alteration.

architect, professional engineer, or land surveyor, to alter an item in any way. If an item

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BANK ON BUFFALO




NEW COMMUNITY BRANCH NIAGARA FALLS

7121 Niagara Falls Blvd. Niagara Falls, NY 14304

1	02-15-19	ADDENDUM 1
NO:	DATE:	DESCRIPTION:
Revisions		
PROJECT N	NUMBER:	
		2181539
DRAWN BY	/ :	
		JMR
REVIEWED	BY:	RJN
		1.0.1
ISSUED FO		PERMIT SET
		FERIVITI SET
DATE:		8 FEB 2019
		O FED ZUIS
DRAWING	NAME:	

DETAILS

DRAWING NUMBER:

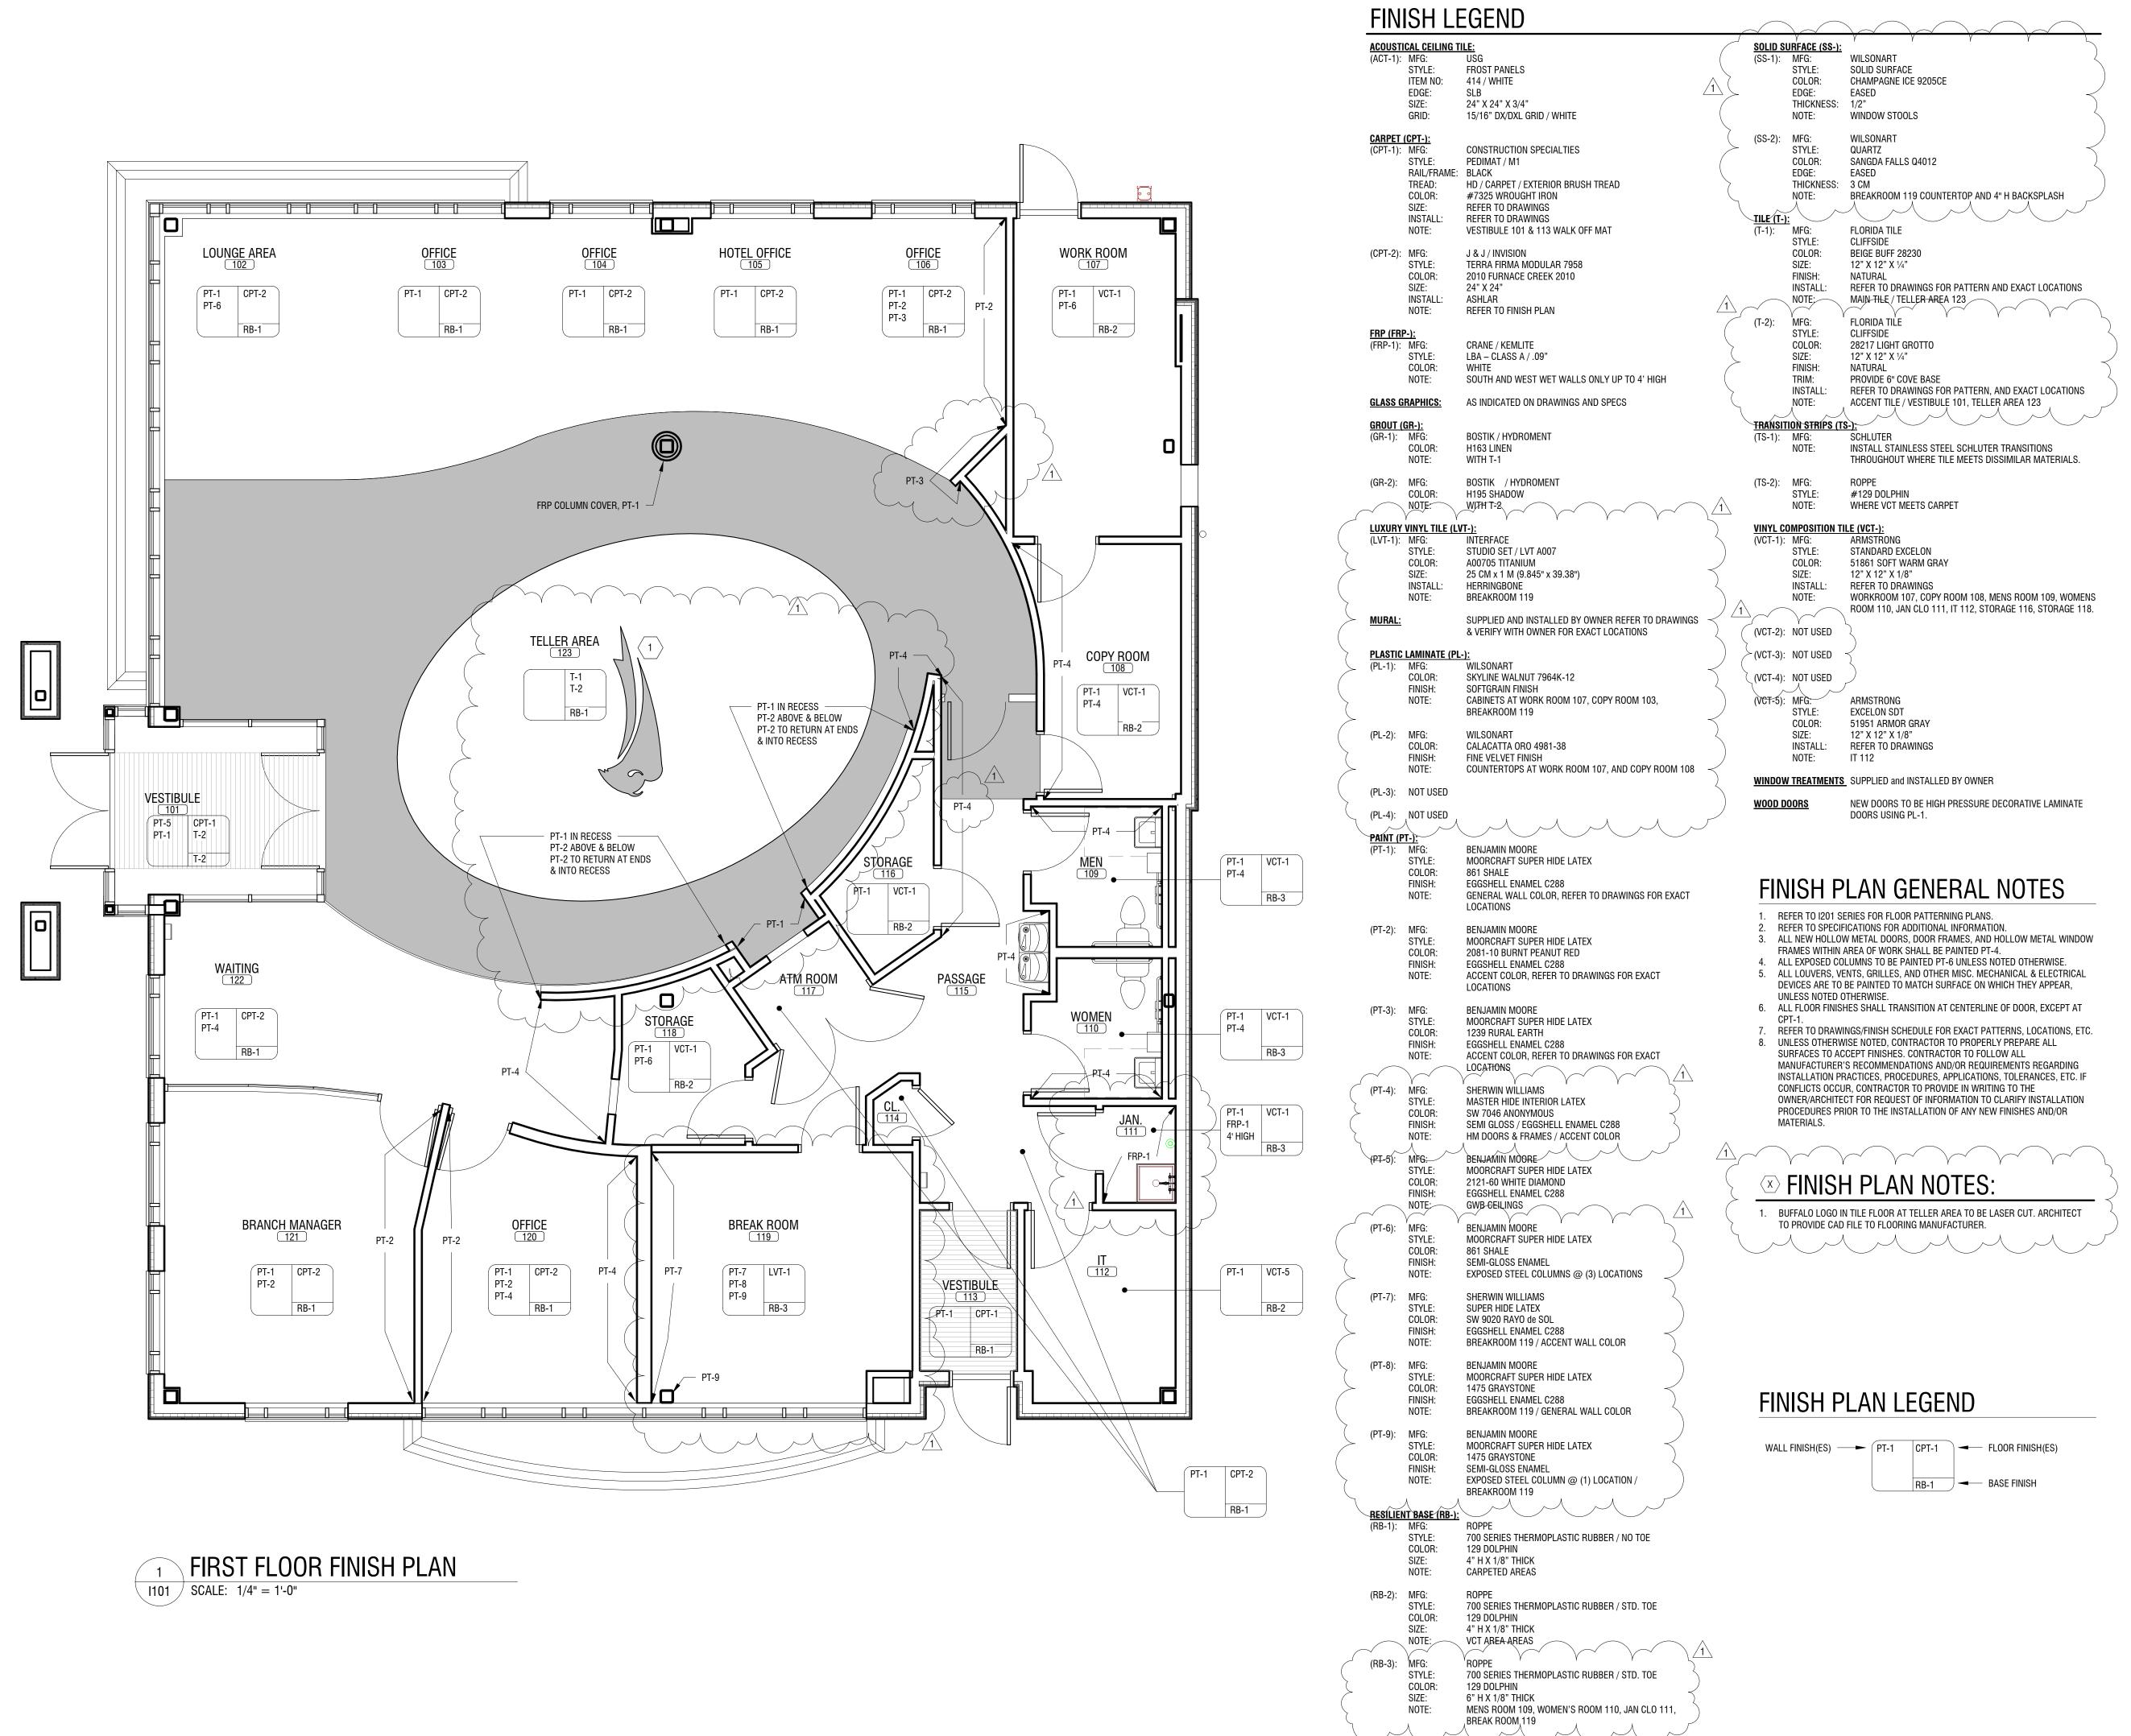



It is a violation of New York Education Law
Article 145 Sec.7209, for any person, unless
acting under the direction of a licensed
architect, professional engineer, or land
surveyor, to alter an item in any way. If an item
bearing the seal of an architect, engineer, or
land surveyor is altered; the altering architect,
engineer, or land surveyor shall affix to the
item their seal and notation "altered by"

followed by their signature and date of such

alteration, and a specific description of the

alteration.

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NEW COMMUNITY BRANCH - NIAGARA FALLS


7121 Niagara Falls Blvd. Niagara Falls, NY 14304

1	02-15-19	ADDENDUM 1
NO:	DATE:	DESCRIPTION:
Revisions		
PROJECT N	IUMBER:	2181539
DRAWN BY:		JMR
REVIEWED	BY:	D IN
		RJN
ISSUED FO		PERMIT SET
DATE:		8 FEB 2019
DRAWING I	NAME:	

FIRST FLOOR FINISH PLAN

DRAWING NUMBER:

I101

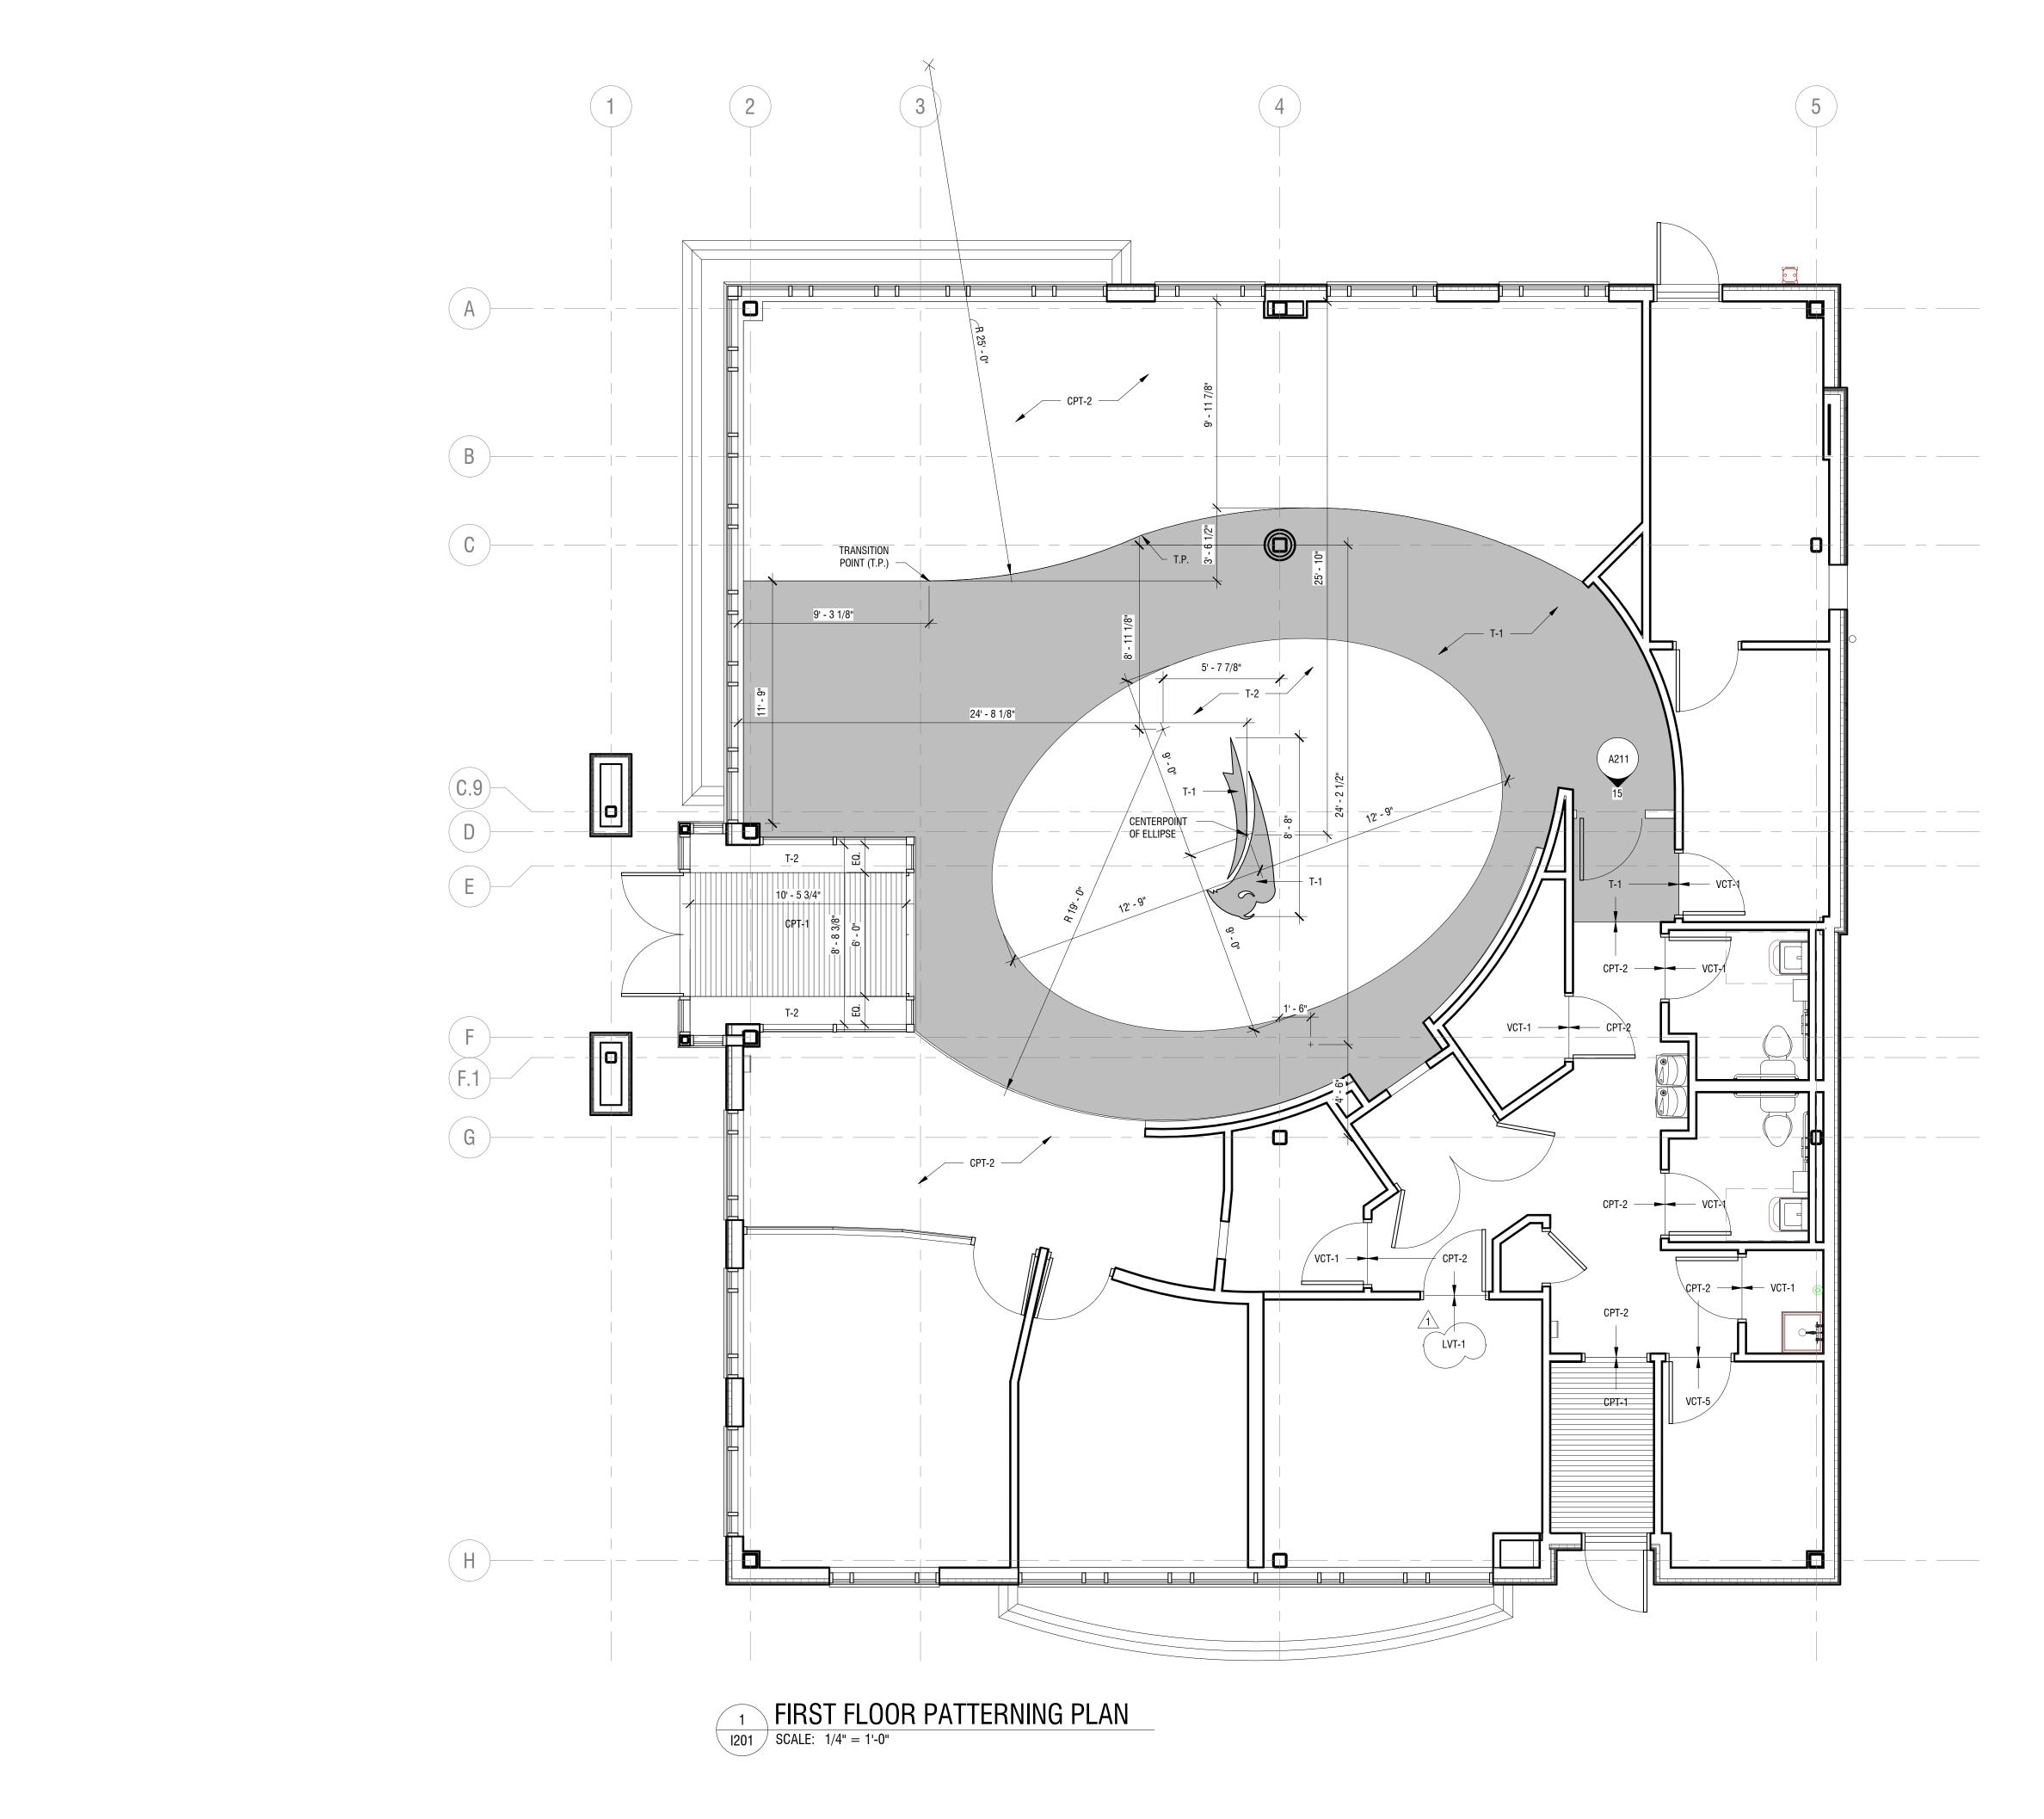



It is a violation of New York Education Law Article 145 Sec.7209, for any person, unless acting under the direction of a licensed architect, professional engineer, or land surveyor, to alter an item in any way. If an item bearing the seal of an architect, engineer, or land surveyor is altered; the altering architect, engineer, or land surveyor shall affix to the item their seal and notation "altered by" followed by their signature and date of such alteration, and a specific description of the alteration.

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NEW COMMUNITY BRANCH -NIAGARA FALLS

7121 Niagara Falls Blvd. Niagara Falls, NY 14304

1	02-15-19	ADDENDUM 1
NO:	DATE:	DESCRIPTION:
Revisions		
PROJECT N	IUMBER:	2181539
DRAWN BY:		JMR
REVIEWED	BY:	RJN
ISSUED FO	R:	PERMIT SET
DATE:		8 FEB 2019
DRAWING N	NAME:	

FIRST FLOOR PATTERNING PLAN

DRAWING NUMBER:

1201

Wood Buffalo, New York 14203

P 716.842.3165 F 716.842.0263

Drawn by: Scale:


P. Sheedy


DRAWING NAME:

Demolition &

Erosion Control

DRAWING NO.

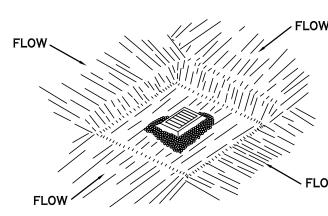

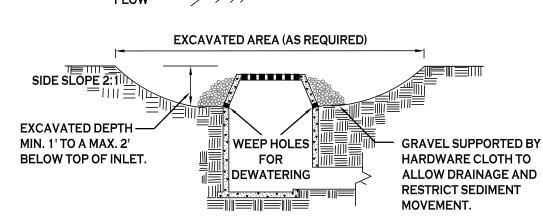

CONSTRUCTION SPECIFICATIONS

- 1. CLEAR THE AREA OF ALL DEBRIS THAT WILL HINDER EXCAVATION.
- 2. GRADE APPROACH TO THE INLET UNIFORMLY AROUND THE BASIN.
- 3. WEEP HOLES SHALL BE PROTECTED BY GRAVEL.
- 4. UPON STABILIZATION OF CONTRIBUTING DRAINAGE AREA, SEAL WEEP HOLES, FILL BASIN WITH STABLE SOIL TO FINAL GRADE, COMPACT IT PROPERLY AND STABILIZE WITH PERMANENT SEEDING.

MAXIMUM DRAINAGE AREA 1 ACRE


INLET PROTECTION DETAIL


NOT TO SCALE

INLET PROTECTION DETAIL 2

NOTE: INSTALL ONE OF THE INLET PROTECTION OPTIONS SHOWN PRIOR TO CONSTRUCTION

— CONCRETE BLOCK 2:1 SLOPE GRAVEL FILTER STONE & BLOCK PLAN VIEW

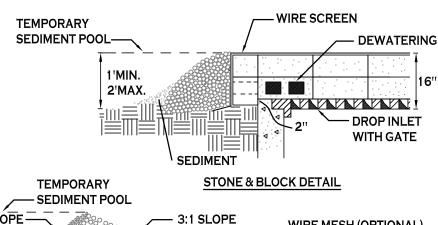

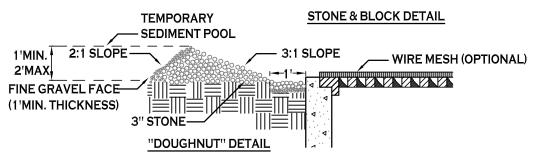

CONSTRUCTION SPECIFICATIONS

- 1. LAY ONE BLOCK ON EACH SIDE OF THE STRUCTURE ON ITS SIDE FOR DEWATERING. FOUNDATION SHALL BE 2 INCHES MINIMUM BELOW REST OF INLET AND BLOCKS SHALL BE PLACED AGAINST INLET FOR SUPPORT.
- 2. HARDWARE CLOTH OR 1/2" WIRE MESH SHALL BE PLACED OVER BLOCK OPENINGS TO SUPPORT STONE.
- 3. USE CLEAN STONE OR GRAVEL 1/2-3/4 INCH IN DIAMETER PLACED 2 INCHES BELOW TOP OF THE BLOCK ON A 2:1 SLOPE OR FLATTER.
- 4. FOR STONE STRUCTURES ONLY, A 1 FOOT THICK LAYER OF THE FILTER STONE WILL BE PLACED AGAINST THE 3 INCH STONE AS SHOWN ON THE DRAWINGS.

MAXIMUM DRAINAGE AREA 1 ACRE

INLET PROTECTION DETAIL 3

NOT TO SCALE

NOT TO SCALE

2"X4" WOOD FRAME

DROP INLET

THEY WILL BE OVERLAPPED TO THE NEXT STAKE.

MESH BEHIND THE FILTER FABRIC FOR SUPPORT.

SHALL BE SECURELY FASTENED TO THE STAKES AND FRAME.

APPLICATIONS.

MINIMUM LENGTH OF 3 FEET.

FOR OVER FLOW STABILITY.

MAXIMUN DRAINAGE AREA 1 ACRE

EXCESS AT CORNERS

CONSTRUCTION SPECIFICATIONS

1. FILTER FABRIC SHALL HAVE AN EOS OF 40-85. BURLAP MAY BE USED FOR SHORT TERM

2. CUT FABRIC FROM A CONTINUOUS ROLL TO ELIMINATE JOINTS. IF JOINTS ARE NEEDED


3. STAKE MATERIALS WILL BE STANDARD 2" x 4" WOOD OR EQUIVALENT. METAL WITH A


5. FABRIC SHALL BE EMBEDDED 1 FOOT MINIMUM BELOW GROUND AND BACKFILLED. IT

6. A 2" x 4" WOOD FRAME SHALL BE COMPLETED AROUND THE CREST OF THE FABRIC

INCHES DEEP. SPANS GREATER THAN 3 FEET MAY BE BRIDGED WITH THE USE OF WIRE

4. SPACE STAKES EVENLY AROUND INLET 3 FEET APART AND DRIVE A MINIMUM 18

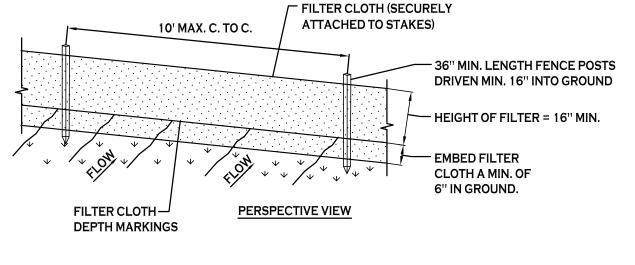


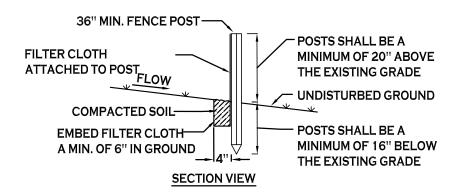

CONSTRUCTION SPECIFICATIONS

- WOVEN FENCE TO BE FASTENED SECURELY TO FENCE POSTS WITH WIRE TIES OR STAPLES. POSTS SHALL BE STEEL EITHER "T" OR "U" TYPE OR HARDWOOD.
- WHEN TWO SECTIONS OF FILTER CLOTH ADJOIN EACH OTHER THEY SHALL BE OVER-LAPPED BY SIX INCHES AND FOLDED. FILTER CLOTH SHALL BE EITHER FILTER X, MIRAFI 100X, STABILINKA T140N, OR APPROVED EQUIVALENT.
- 3. MAINTENANCE SHALL BE PERFORMED AS NEEDED AND MATERIAL REMOVED WHEN "BULGES" DEVELOP IN THE SILT FENCE.

SILT FENCE DETAIL NOT TO SCALE

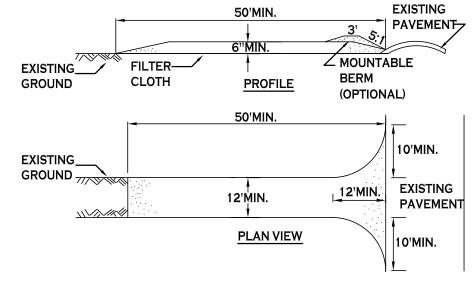


CONSTRUCTION SPECIFICATIONS

- 1. STONE SIZE USE 2" STONE, OR RECLAIMED OR RECYCLED CONCRETE EQUIVALENT.
- 2. LENGTH NOT LESS THAN 50 FEET (EXCEPT ON A SINGLE RESIDENCE LOT WHERE A 30 FOOT MINIMUM LENGTH WOULD APPLY).
- 3. THICKNESS NOT LESS THAN SIX (6) INCHES.
- 4. WIDTH-TWELVE (12) FOOT MINIMUM, BUT NOT LESS THAN THE FULL WIDTH AT POINTS WHERE INGRESS OR EGRESS OCCURS. TWENTY-FOUR (24) FOOT IF SINGLE ENTRANCE
- 5. FILTER CLOTH WILL BE PLACED OVER THE ENTIRE AREA PRIOR TO PLACING OF
- 6. SURFACE WATER ALL SURFACE WATER FLOWING OR DIVERTED TOWARD CONSTRUCTION ENTRANCES SHALL BE PIPED ACROSS THE ENTRANCE. IF PIPING IS IMPRACTICAL, A MOUNTABLE BERM WITH 5:1 SLOPES WILL BE PERMITTED.
- MAINTENANCE THE ENTRANCE SHALL BE MAINTAINED IN A CONDITION WHICH WILL PREVENT TRACKING OR FLOWING OF SEDIMENT ONTO PUBLIC RIGHTS-OF-WAY, ALL SEDIMENT SPILLED, DROPPED, WASHED OR TRACTED ONTO PUBLIC RIGHTS-OF-WAY MUST BE REMOVED IMMEDIATELY.
- 8. WHEN WASHING IS REQUIRED, IT SHALL BE DONE ON A AREA STABILIZED WITH STONE AND WHICH DRAINS INTO AN APPROVED SEDIMENT TRAPPING DEVICE.
- 9. PERIODIC INSPECTION AND NEEDED MAINTENANCE SHALL BE PROVIDED AFTER EACH

STABILIZED CONSTRUCTION ENTRANCE DETAIL

NOT TO SCALE

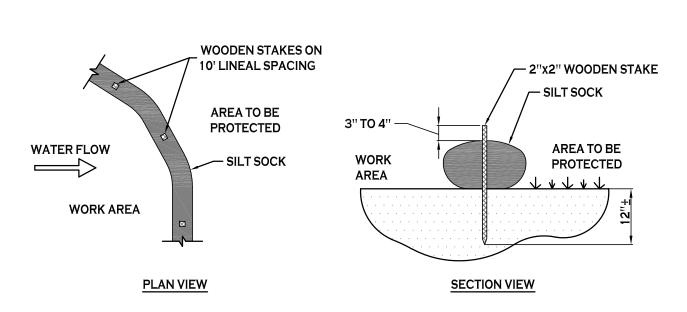


NOTES:

CONTRACTOR SHALL INSPECT AND MAINTAIN SILT SOCK AS NEEDED DURING THE DURATION

OF CONSTRUCTION PROJECT.

CONTRACTOR SHALL REMOVE SEDIMENT COLLECTED AT THE BASE OF THE SILT SOCK WHEN IT HAS REACHED \$\frac{1}{2}\$ OF THE EXPOSED HEIGHT OF THE SILT SOCK. ALTERNATIVELY, RATHER THAN CREATE A SOIL DISTURBING ACTIVITY, THE ENGINEER MAY CALL FOR ADDITIONAL SILT SOCK TO BE ADDED AT AREAS OF HIGH SEDIMENTATION, PLACED IMMEDIATELY ON TOP OF THE EXISTING SEDIMENT LADEN SILT SOCK.

> SILT SOCK DETAIL NOT TO SCALE

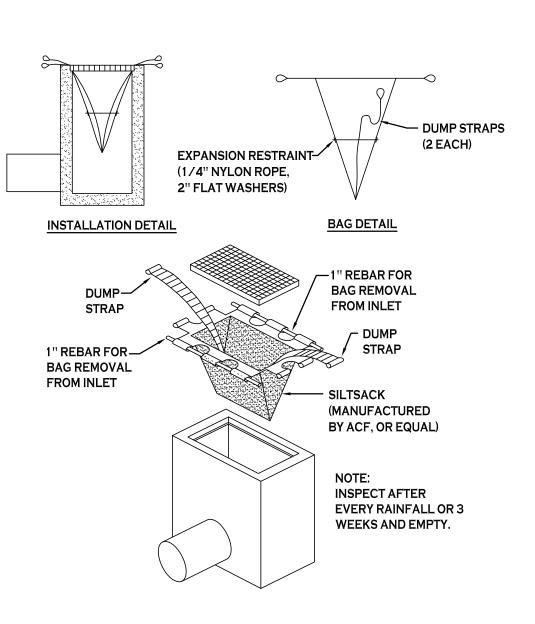

SILT SACK DETAIL

ag

Wood

Morr is '

487 Main Street Suite 500

Buffalo, New York 14203

P 716.842.3165 F 716.842.0263

Date:

Drawn by: Scale:

DRAWING NAME: Demolition &

Erosion Control

12/7/18

P. Sheedy

DRAWING NO.

Details

PROPOSED CURB

PROPOSED SIGN

PROPOSED LIGHT POLE

PROPOSED WALL MOUNTED LIGHT

PROPOSED ASPHALT PAVEMENT

PROPOSED SIDEWALK / CONCRETE PAD

NUMBER OF PARKING SPACES

N/A

N/A


25% LOT WIDTH *

20' *

5 FT


20 FT

48 SPACES

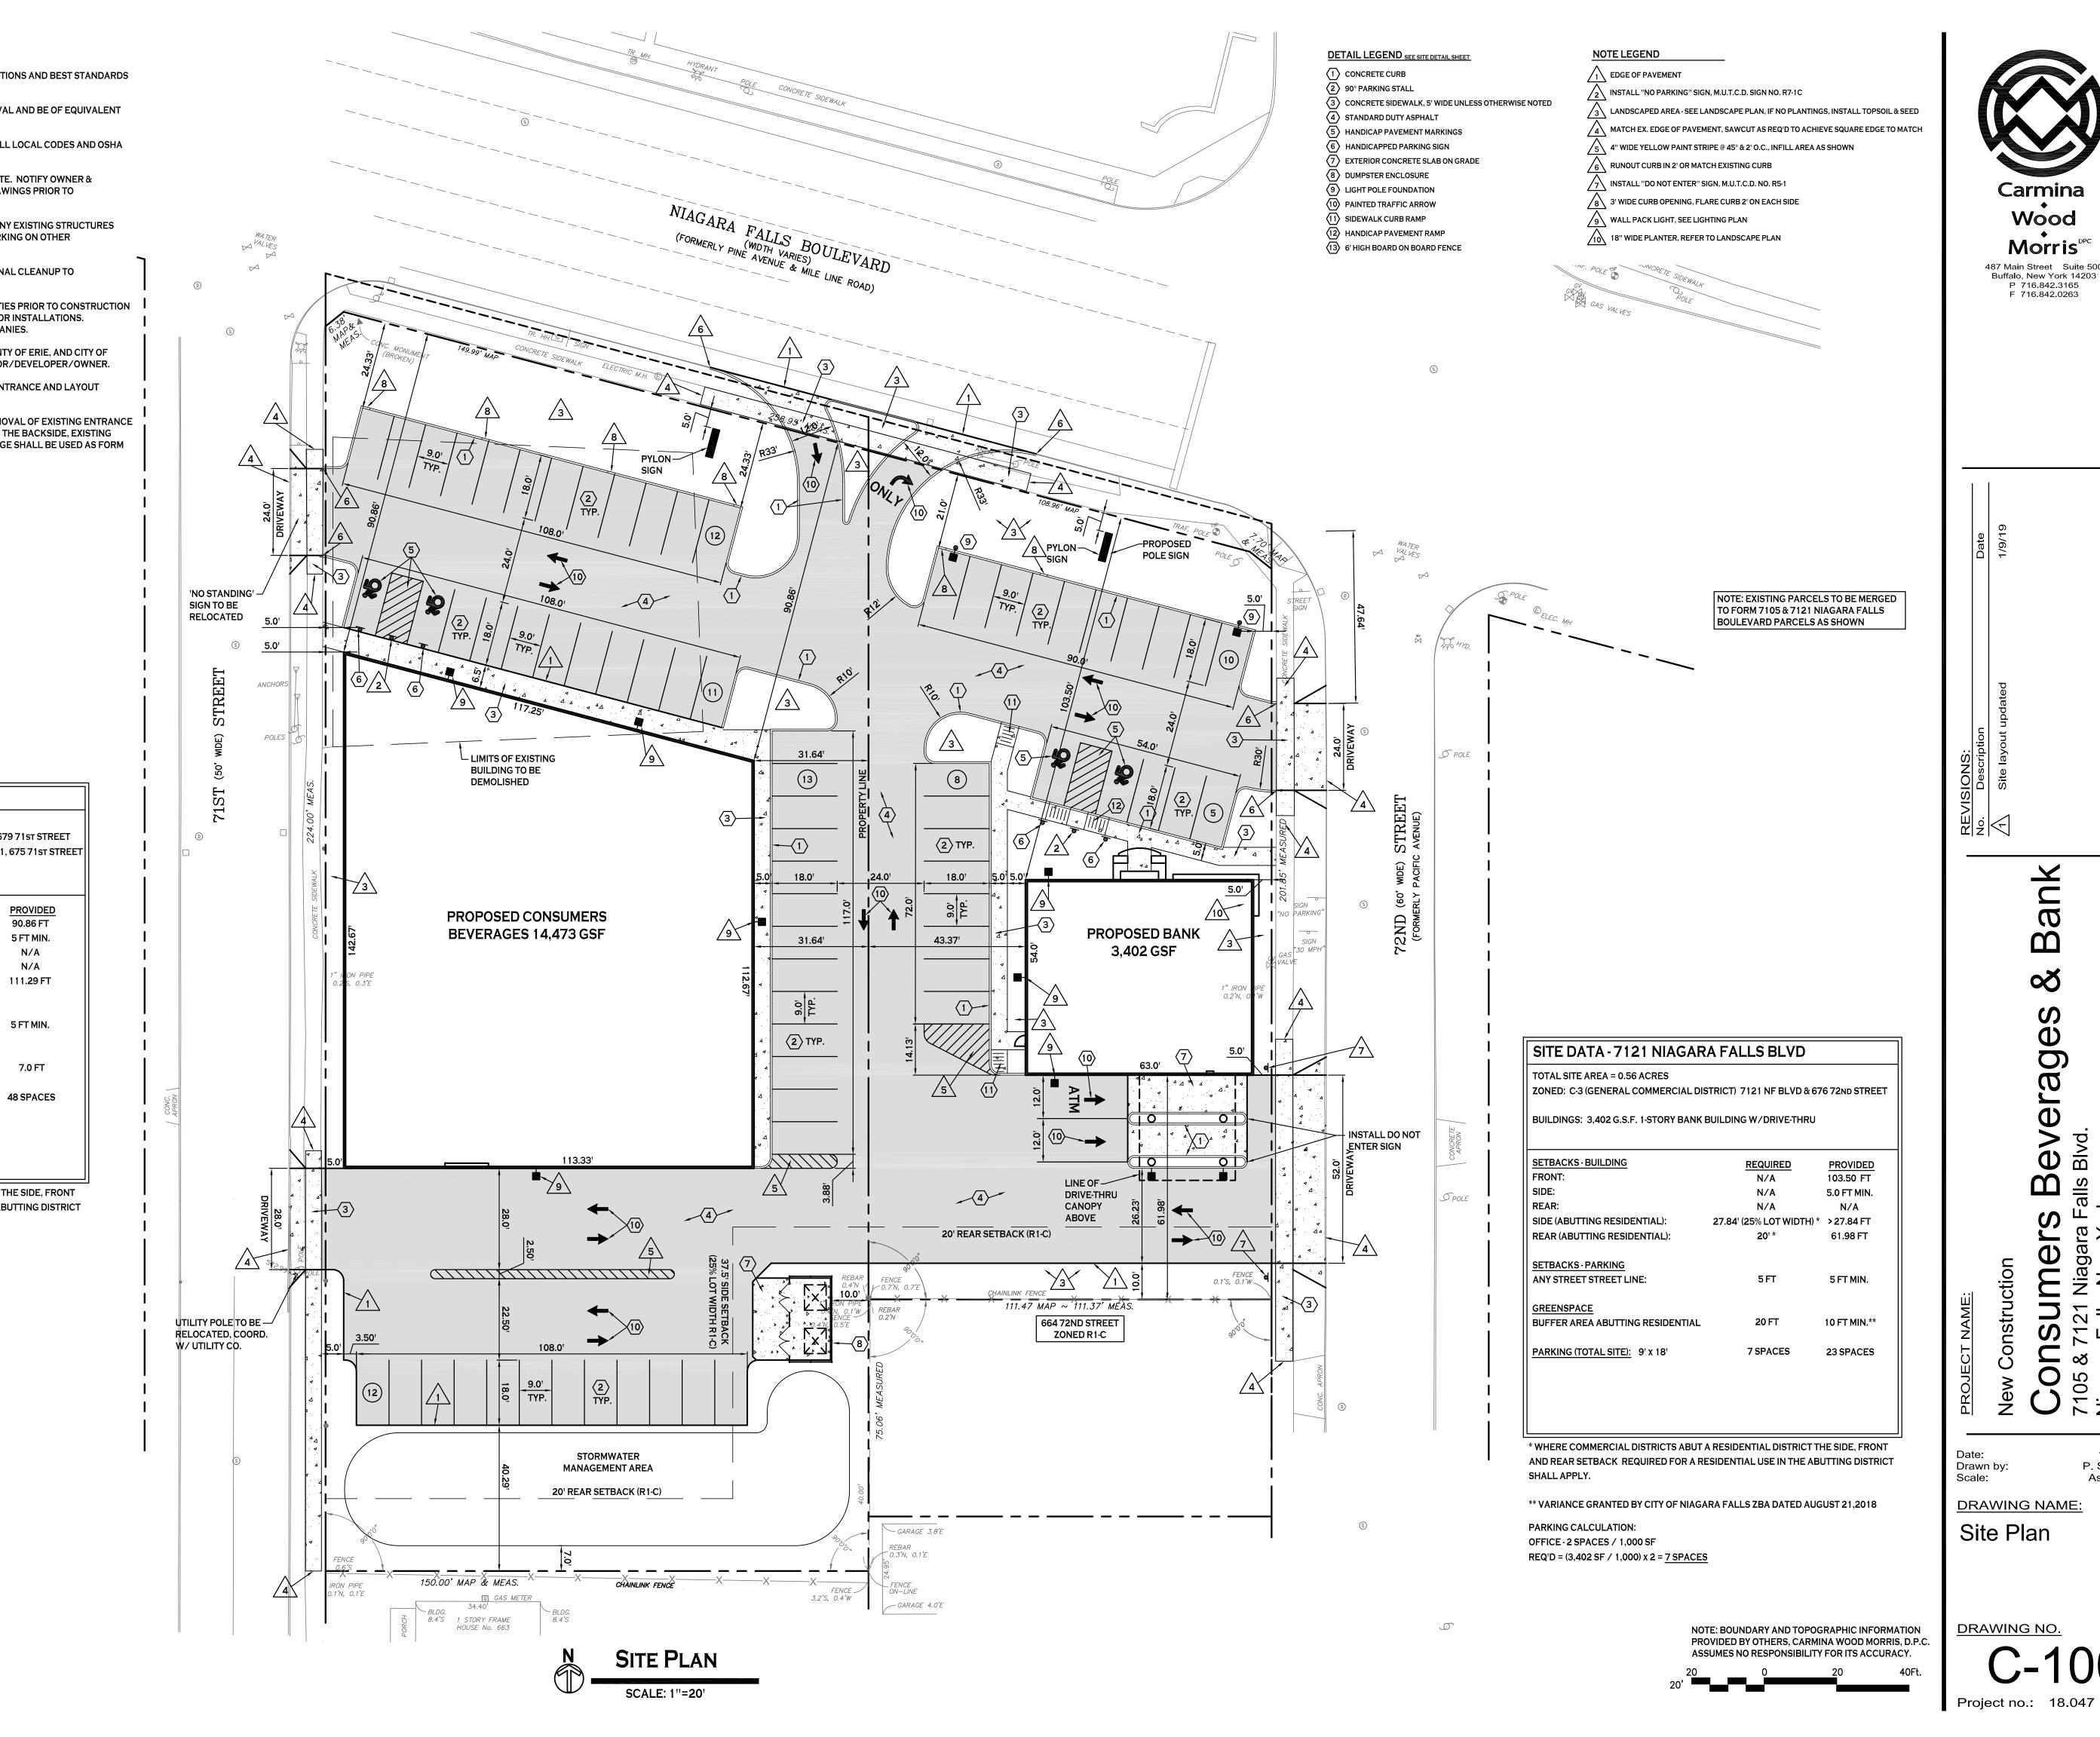

12/7/18

P. Sheedy As Noted

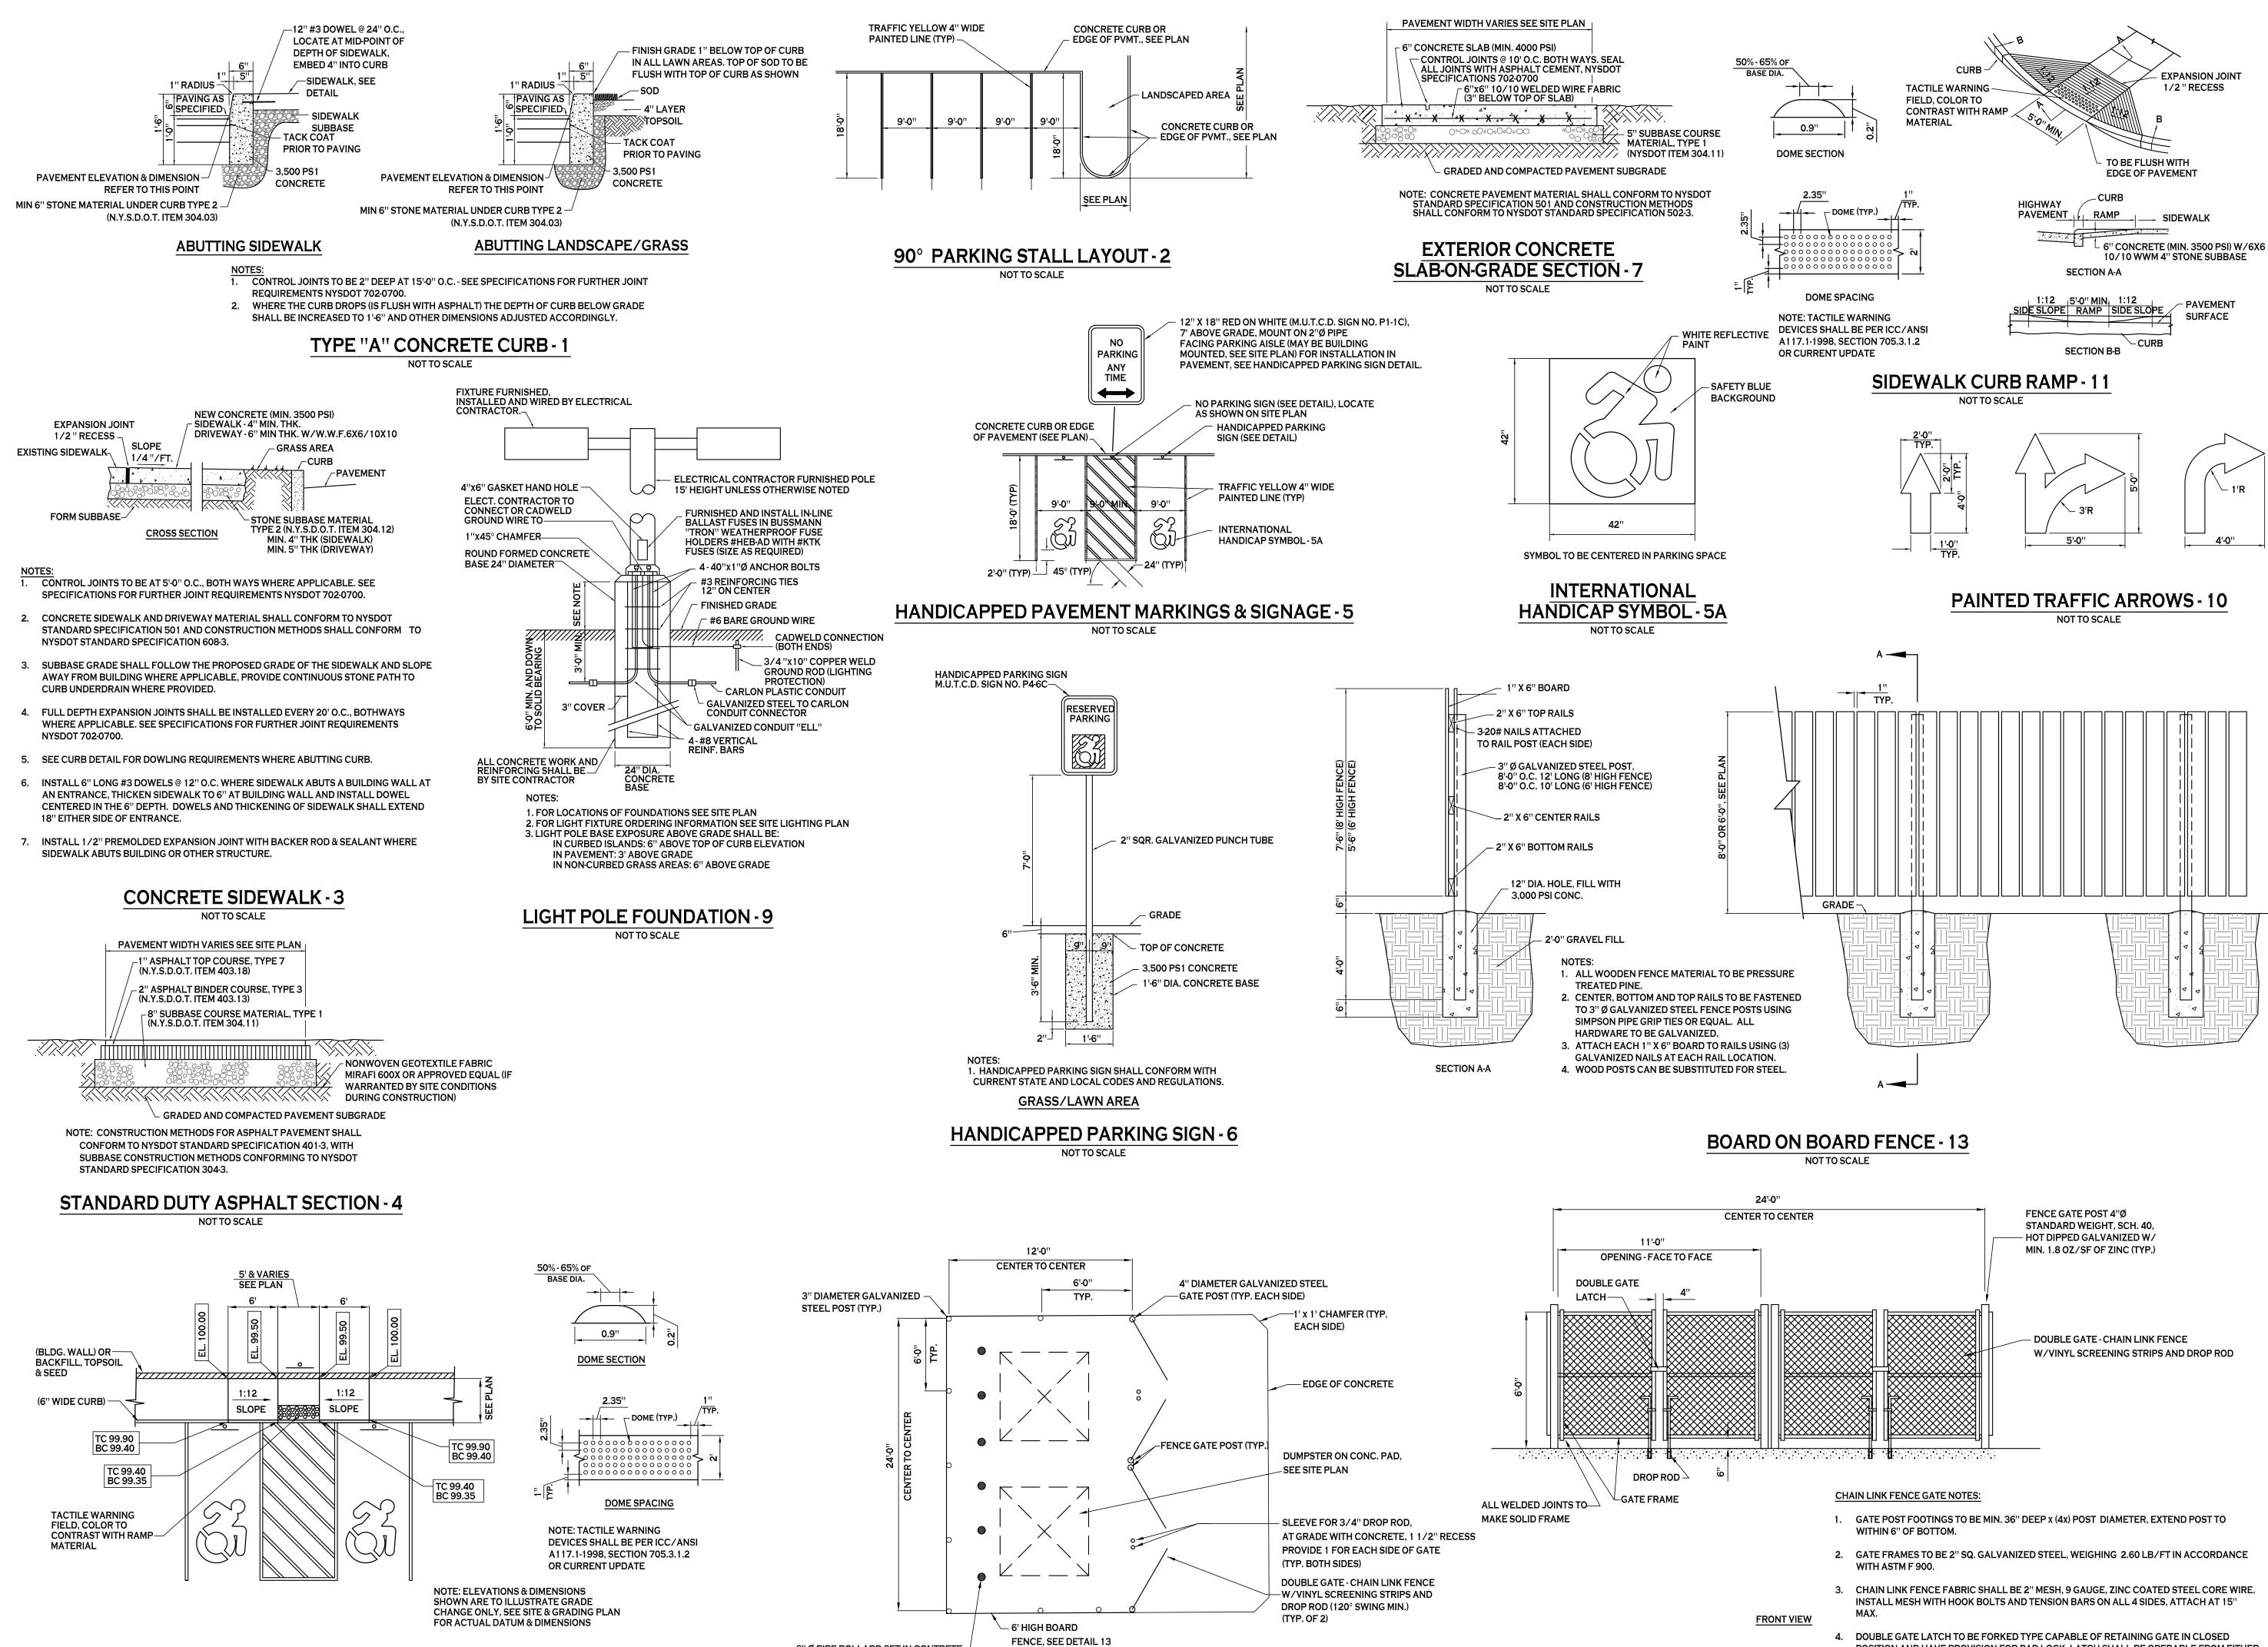

PLAN VIEW

6" Ø PIPE BOLLARD SET IN CONTRETE -

3' BELOW GRADE, EXTEND 4' ABOVE

GRADE, FILL W/CONCTRETE, PAINT

OSHA YELLOW (TYP. OF 6)

HANDICAPPED PAVEMENT RAMP - 12

NOT TO SCALE

Wood

Morris 487 Main Street Suite 500 Buffalo, New York 14203 P 716.842.3165 F 716.842.0263

Date: Drawn by: Scale:

DRAWING NAME

12/7/18

P. Sheedy

As Noted

Site Details

DRAWING NO.

POSITION AND HAVE PROVISION FOR PAD LOCK. LATCH SHALL BE OPERABLE FROM EITHER

5. ALL HARDWARE TO BE HOT DIPPED GALVANIZED STEEL TO SUIT GATE SIZE.

SIDE OF GATE.

DUMPSTER ENCLOSURE - 8


NOT TO SCALE

× 573.6

SCALE: 1"=20"

GRADING PLAN

× 573.6

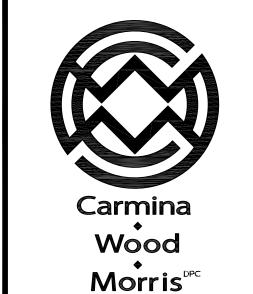

487 Main Street Suite 500 Buffalo, New York 14203 P 716.842.3165 F 716.842.0263

verages

Drawn by: Scale:

12/7/18 P. Sheedy As Noted DRAWING NAME:


Grading Plan

DRAWING NO.

NOTE: BOUNDARY AND TOPOGRAPHIC INFORMATION PROVIDED BY OTHERS, CARMINA WOOD MORRIS, D.P.C. ASSUMES NO RESPONSIBILITY FOR ITS ACCURACY.

573.55

Project no.: 18.047

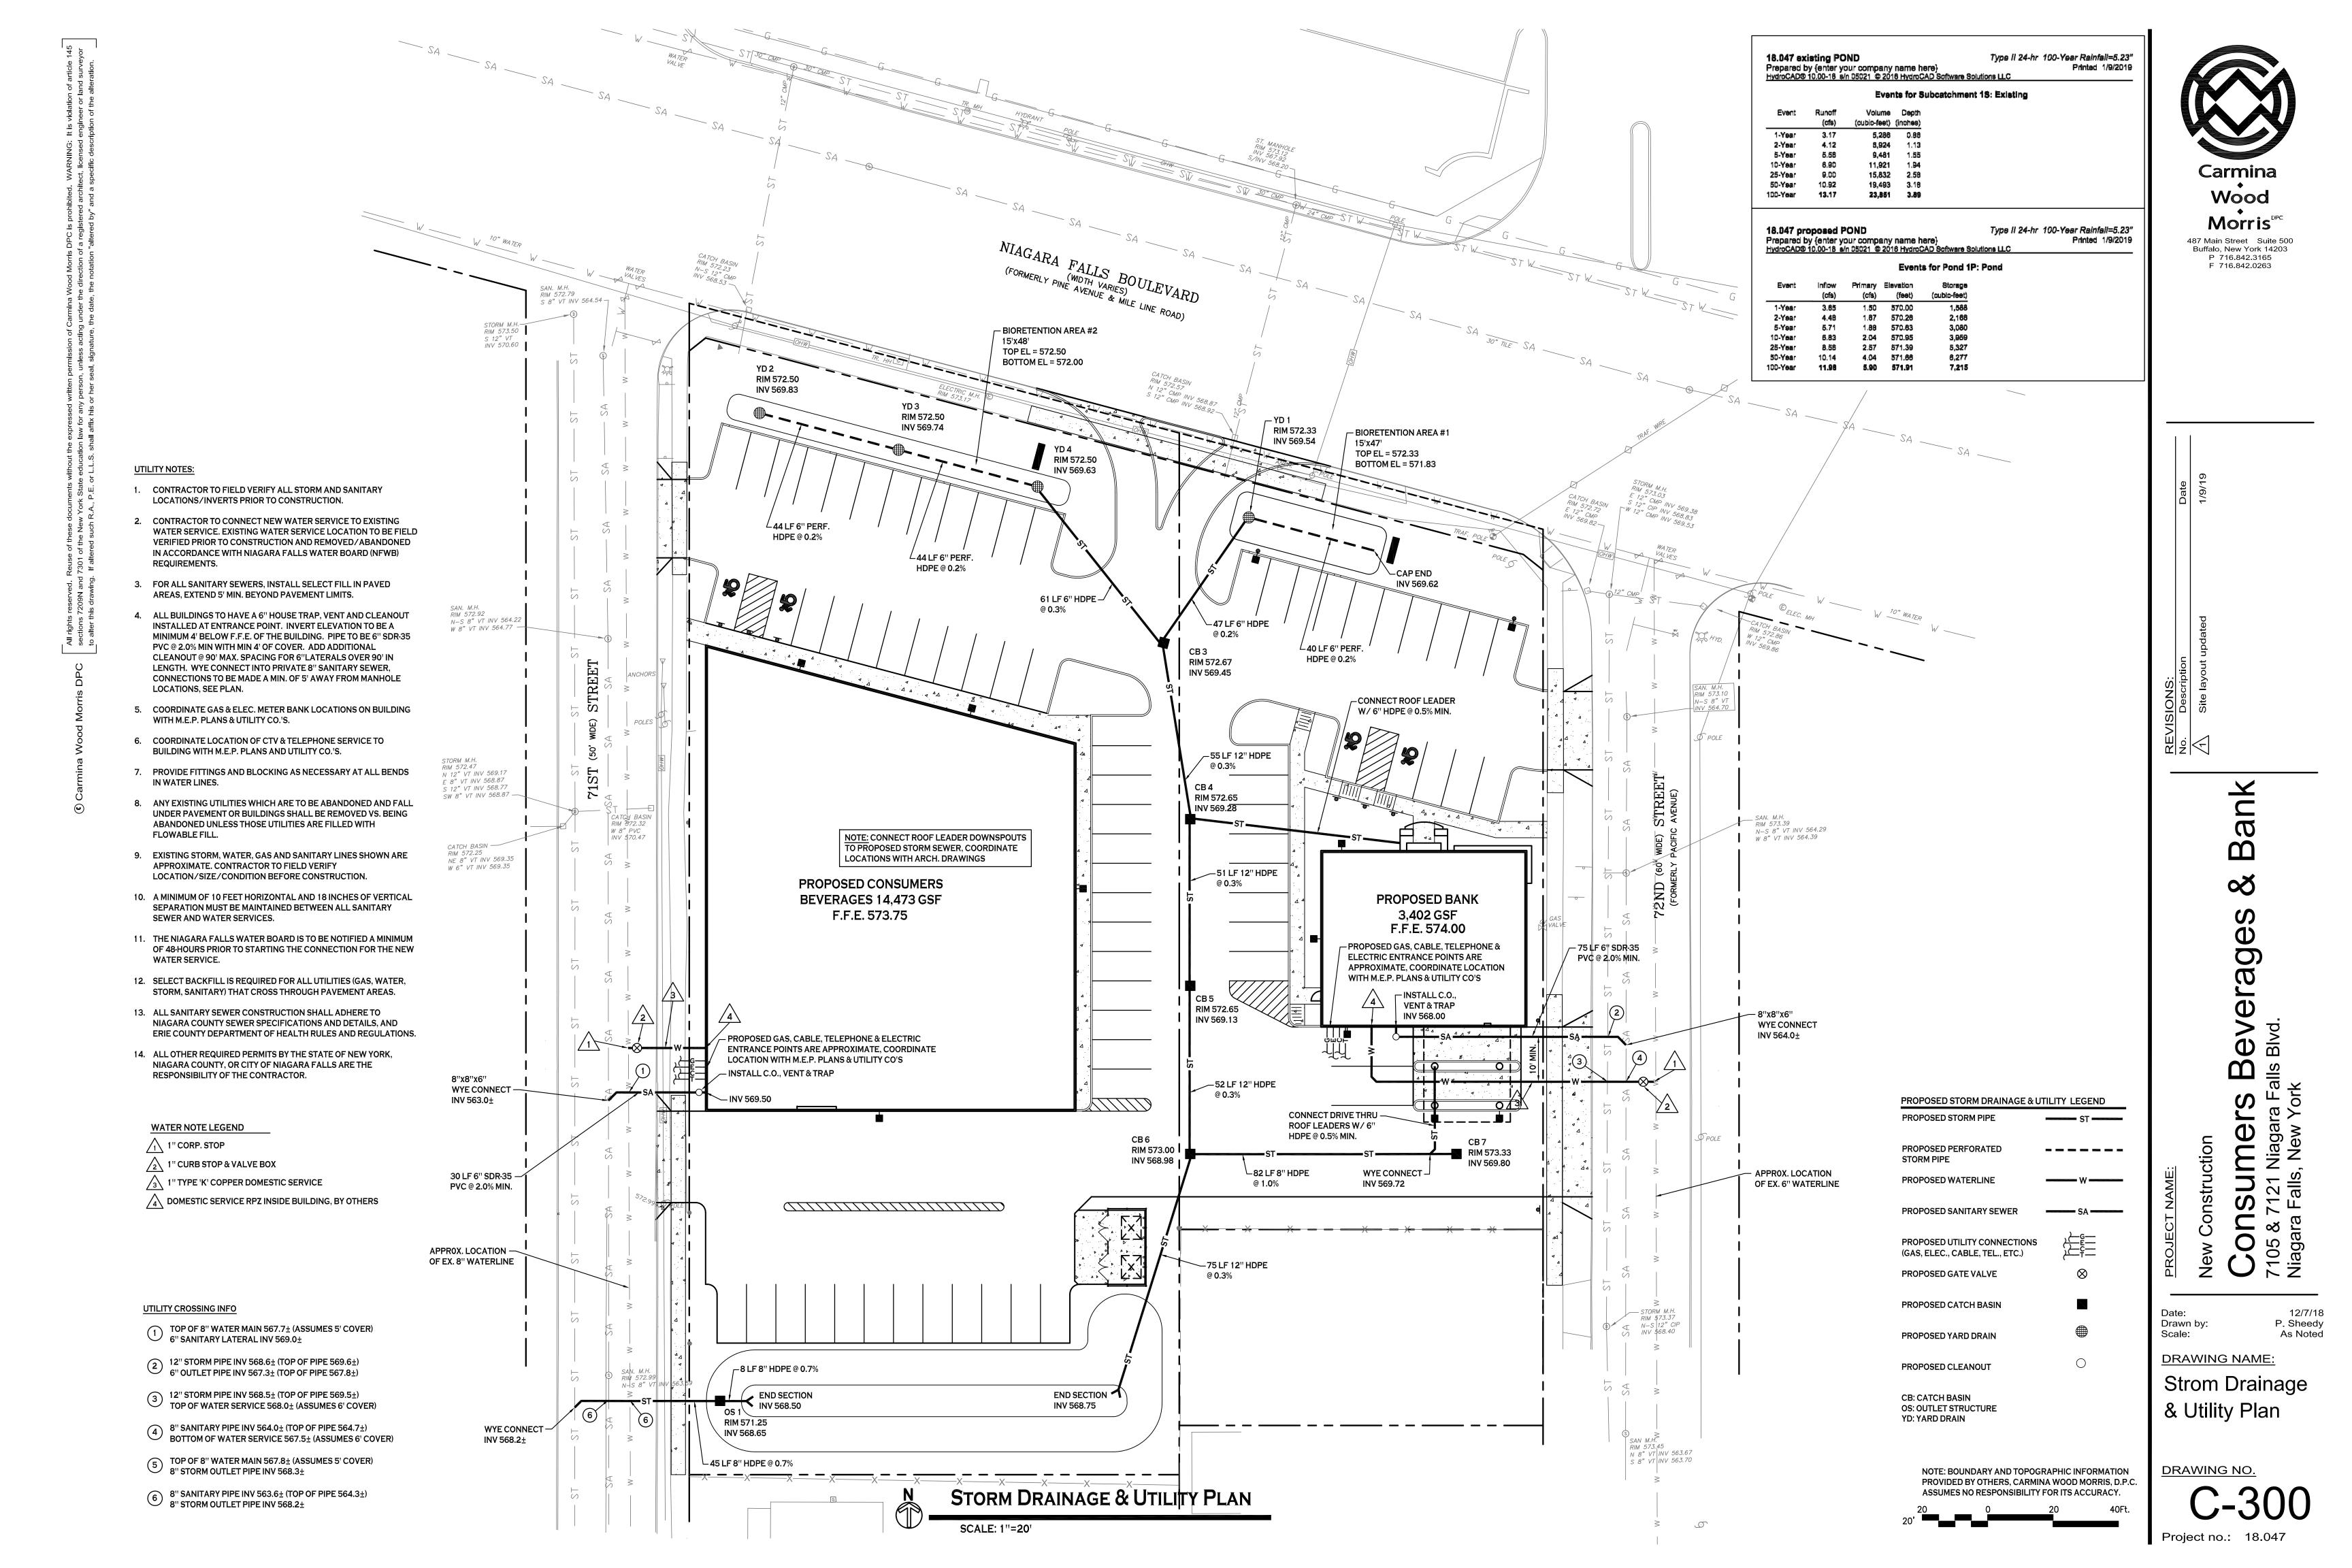

A. PIPE INSTALLATION SHALL BE IN ACCORDANCE WITH MANUFACTURERS RECOMMENDATIONS.

- B. TRENCHING OPERATIONS SHALL INCLUDE ALL NECESSARY DEWATERING.
- C. TRENCH DETAILS ARE ONLY SHOWN FOR PURPOSES OF MATERIAL PLACEMENT AND MAXIMUM PAY LIMITS.
- D. AN OSHA APPROVED MOVABLE PROTECTIVE TRENCH SHIELD SHALL BE USED IN ALL UNSHEETED TRENCH AREAS.

<u>MATERIALS</u>

PIPE BEDDING MATERIAL (NYSDOT 1985 EDITION)

NO. 1 CRUSHED STONE OR CRUSHED GRAVEL WITH A GRADATION CONFORMING WITH NYSDOT SECTION 703-02. THE MATERIAL SHALL BE WELL GRADED WITH NO PARTICLES LARGER THAN ONE INCH AND HAVING A MAXIMUM GRADATION MEETING THE LIMITS DESCRIBED IN THE SPECIFICATIONS. THE BEDDING SHALL BE COMPACTED IN 6" LIFTS WITH EQUIPMENT ACCEPTABLE TO THE PIPE MANUFACTURER.

NO SLAG SHALL BE ALLOWED FOR MATERIAL (1)

(2) TYPE 2 CRUSHED STONE OR CRUSHED GRAVEL WITH A GRADATION CONFORMING WITH NYSDOT SECTION 304-2.02 TYPE 2. THE MATERIAL SHALL BE WELL GRADED WITH NO PARTICLES LARGER THAN TWO INCHES AND HAVING A MAXIMUM GRADATION MEETING THE LIMITS DESCRIBED IN THE SPECIFICATIONS. THE BEDDING SHALL BE COMPACTED IN 6" LIFTS WITH EQUIPMENT ACCEPTABLE TO THE PIPE MANUFACTURER.

NO SLAG SHALL BE ALLOWED FOR MATERIAL (2)

STORM SEWER TRENCH SECTION **IN PAVED AREAS**


STORM PIPE W/END SECTIONS (SEE PLANS FOR SIZE AND TYPE)

NEW CULVERT W/END SECTIONS

PIPE BEDDING, SEE -

TRENCH SECTION

(SEE PLANS FOR SIZE AND TYPE)

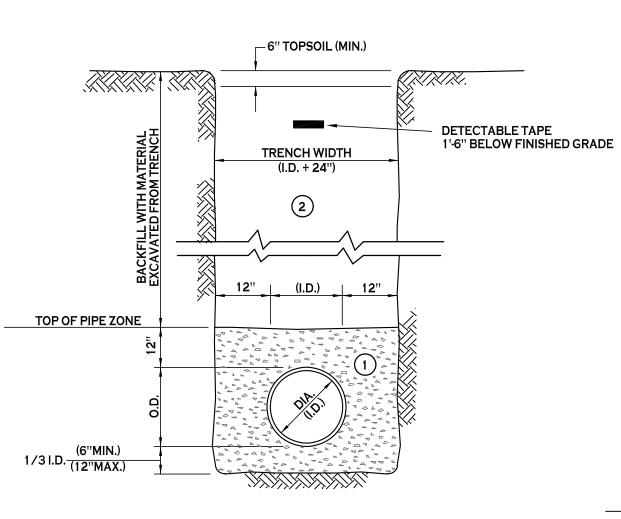

- A. PIPE INSTALLATION SHALL BE IN ACCORDANCE WITH MANUFACTURERS RECOMMENDATIONS.
- B. TRENCHING OPERATIONS SHALL INCLUDE ALL NECESSARY DEWATERING.
- C. TRENCH DETAILS ARE ONLY SHOWN FOR PURPOSES OF MATERIAL PLACEMENT AND MAXIMUM PAY LIMITS.
- D. AN OSHA APPROVED MOVABLE PROTECTIVE TRENCH SHIELD SHALL BE USED IN ALL UNSHEETED TRENCH AREAS.

PIPE BEDDING MATERIAL (NYSDOT 1985 EDITION)

NO. 1 CRUSHED STONE OR CRUSHED GRAVEL WITH A GRADATION CONFORMING WITH NYSDOT SECTION 703-02. THE MATERIAL SHALL BE WELL GRADED WITH NO PARTICLES LARGER THAN ONE INCH AND HAVING A MAXIMUM GRADATION MEETING THE LIMITS DESCRIBED IN THE SPECIFICATIONS. THE BEDDING SHALL BE COMPACTED IN 6" LIFTS WITH EQUIPMENT ACCEPTABLE TO THE PIPE MANUFACTURER.

NO SLAG SHALL BE ALLOWED FOR MATERIAL (1)

(2) BACKFILL MATERIAL SHALL BE NATIVE SOIL CONTAINING NO UNSUITABLE MATERIAL COMPACTED IN 6" LIFTS.

STANDARD END SECTIONS

PLACE STONE FILL - HALFWAY UP THE SIDE OF

12" OF STONE FILL SEE PLAN FOR TYPE


PIPE UNLESS OTHERWISE NOTED

NOTE: LIMITS OF STONE SHOWN


ARE MINIMUMS, PLAN MAY

INDICATE GREATER LIMITS

STORM SEWER TRENCH SECTION **IN UNPAVED AREAS**

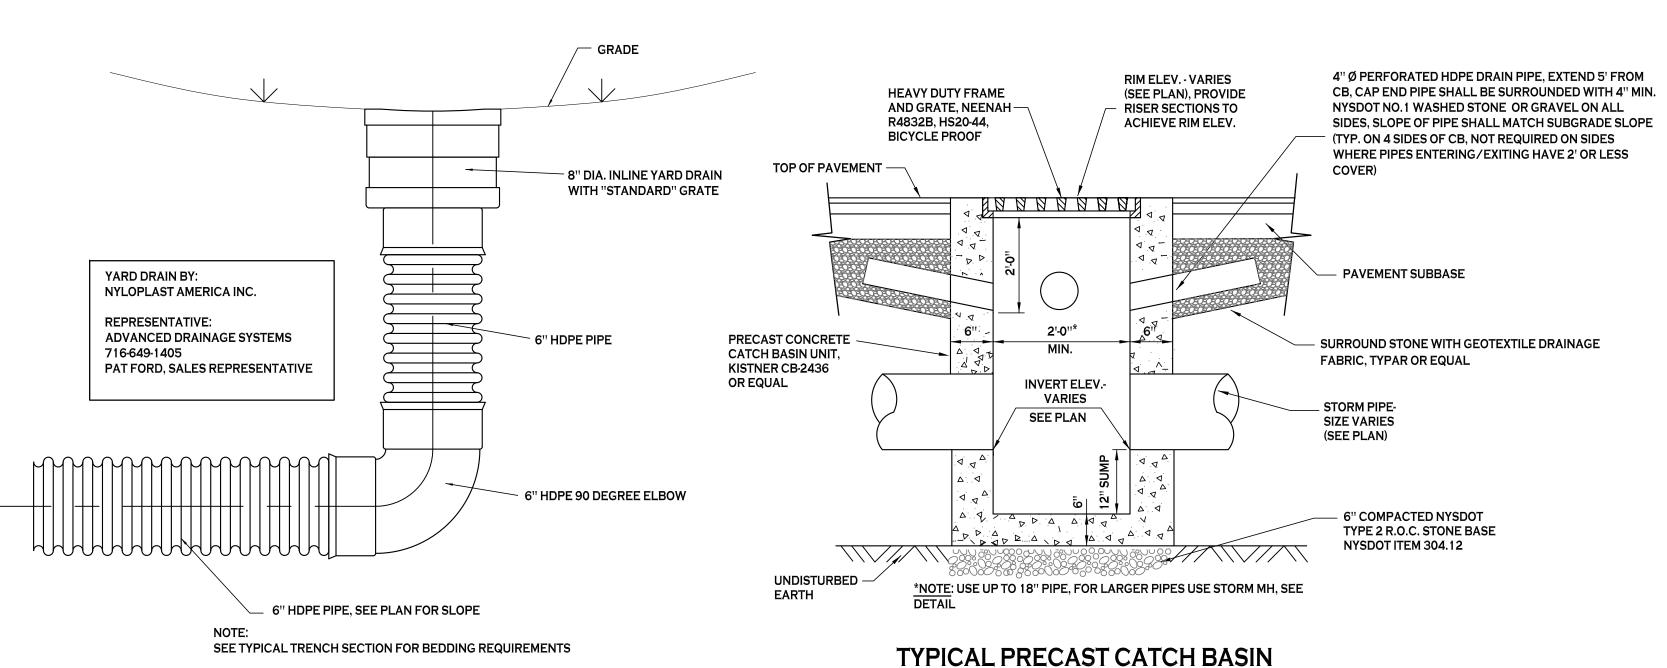


TYPICAL YARD DRAIN DETAIL NOT TO SCALE

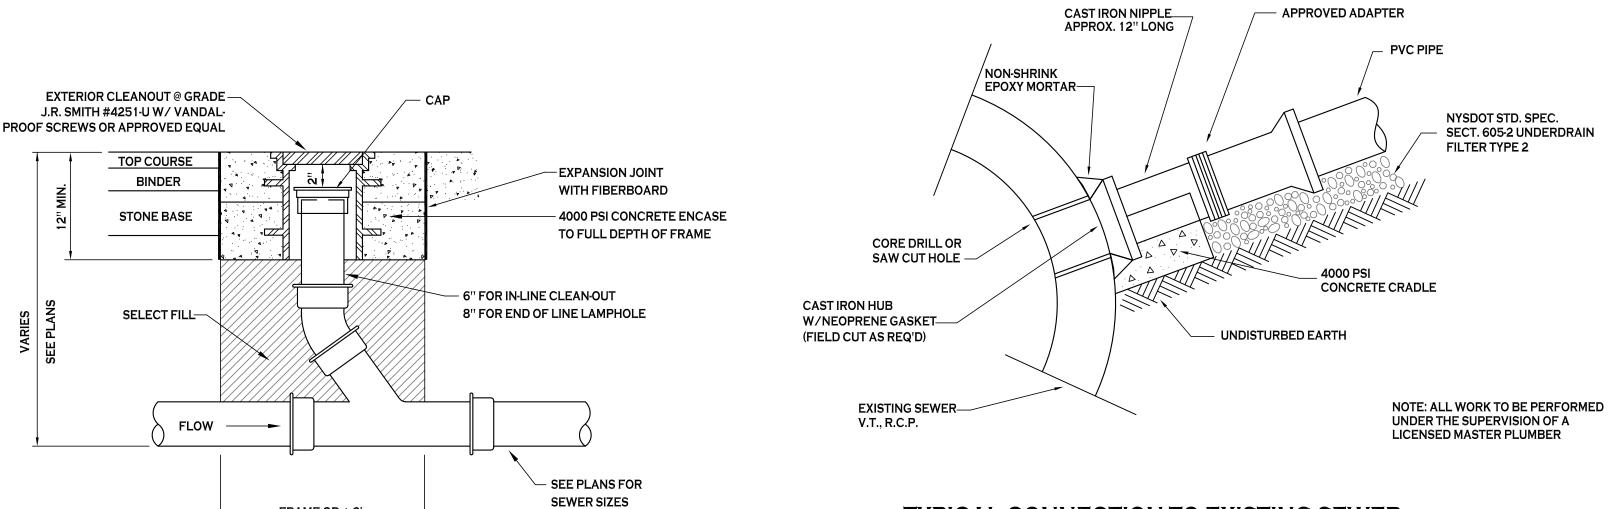


NOT TO SCALE

LAMPHOLE/CLEANOUT IN PAVEMENT/SIDEWALK

FRAME OD + 2'

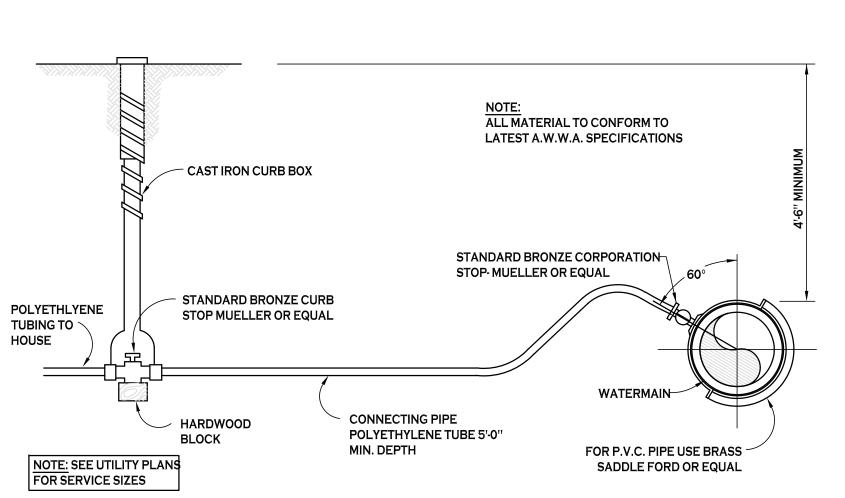



TYPICAL WATER SERVICE LINE INSTALLATION

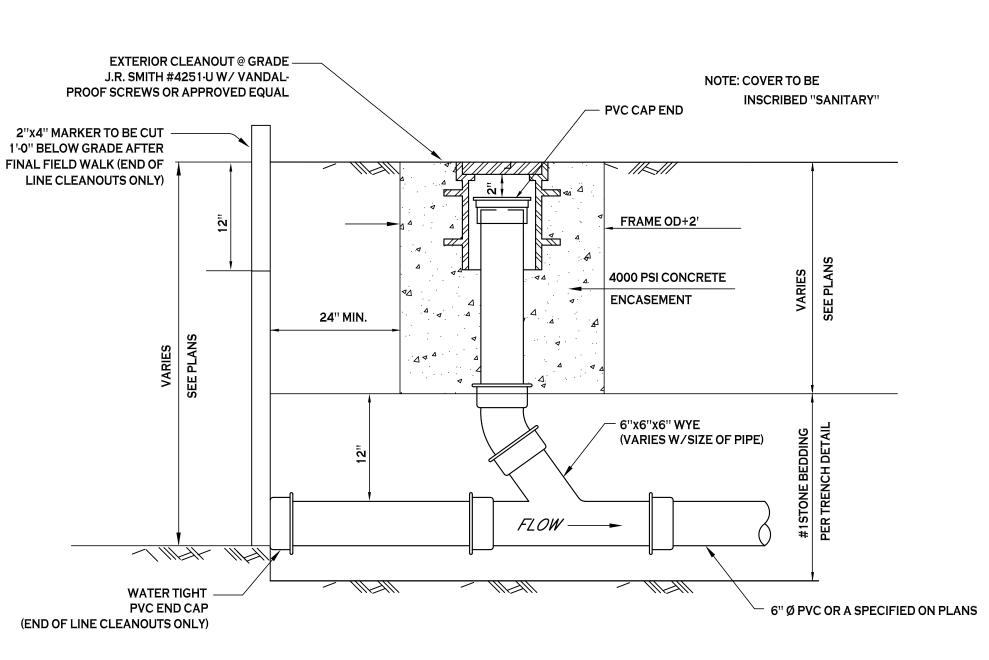

TYPICAL CONNECTION TO EXISTING SEWER

LAMPHOLE/CLEANOUT IN LAWN/FIELD AREAS NOT TO SCALE

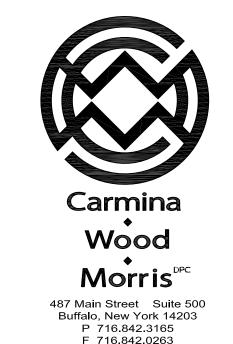

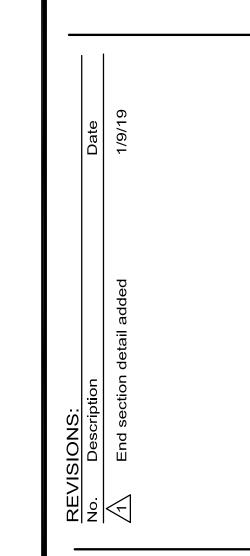

erage

P. Sheedy As Noted Drawn by: Scale:

DRAWING NAME:


Storm Drainage & Utility Details

DRAWING NO.

ELEVATION

STANDARD END SECTIONS

PLAN VIEW

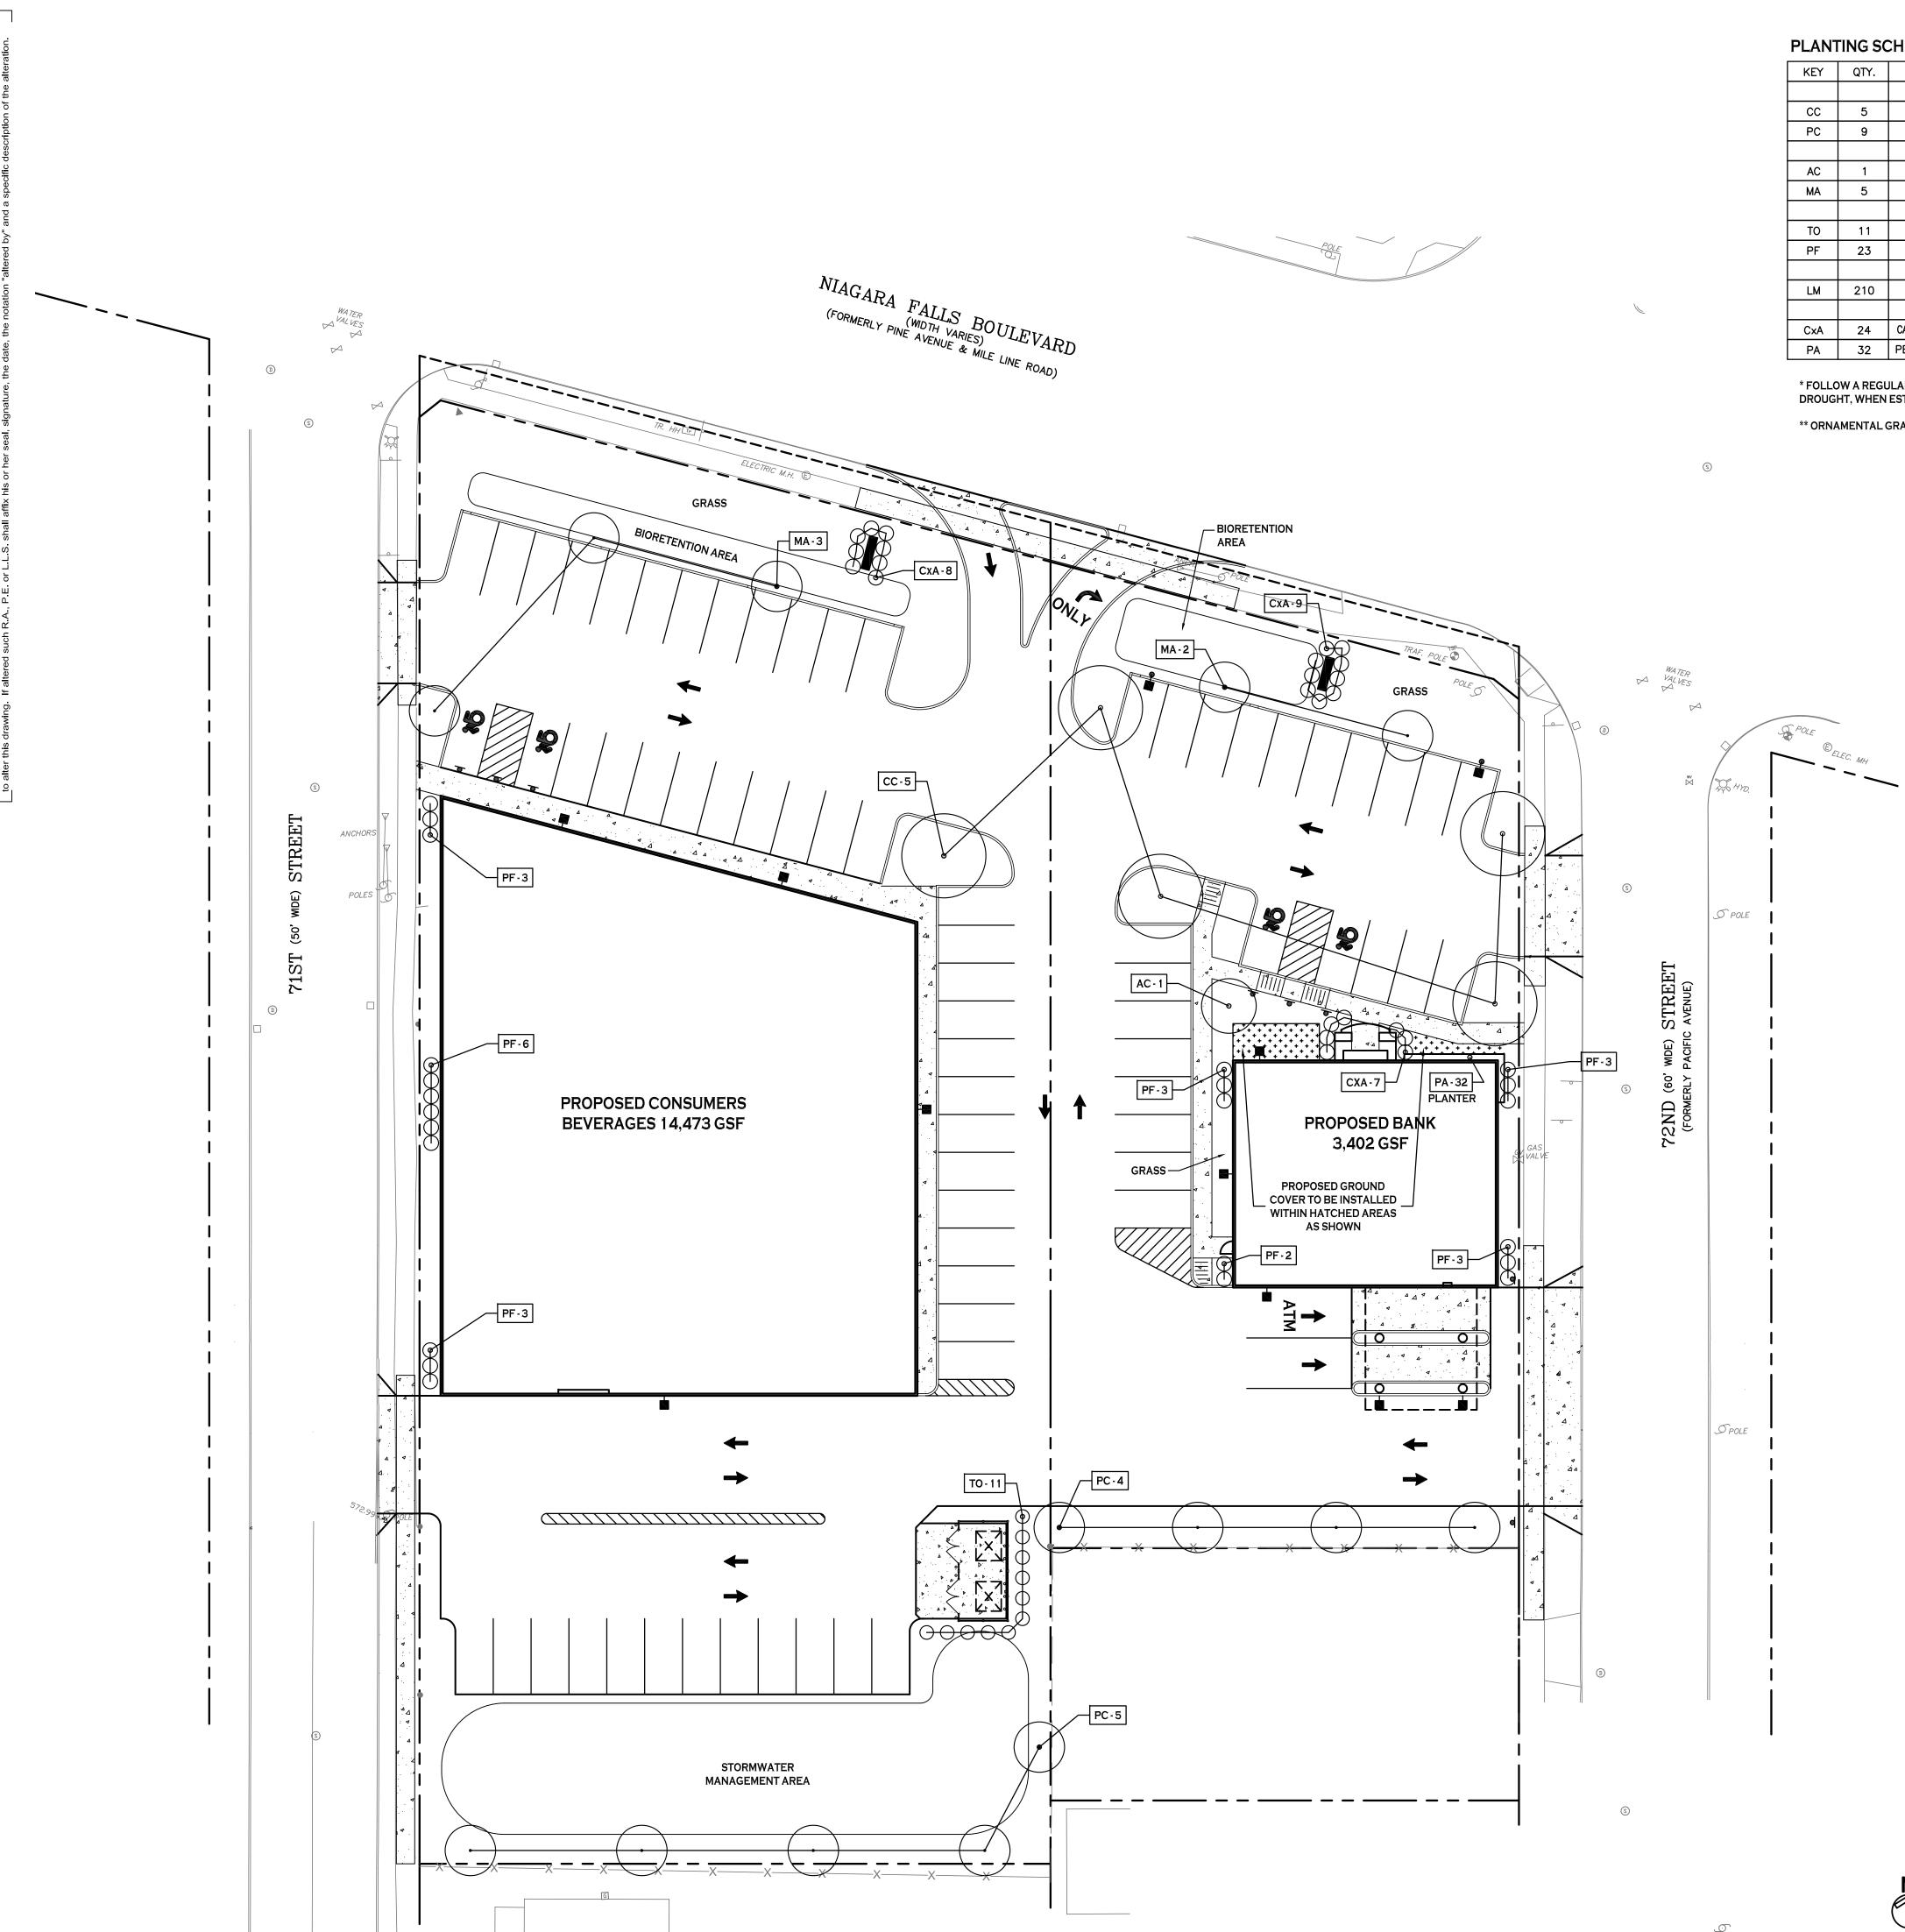

PLANTING SCHEDULE - CONSUMERS BEVERAGES, NIAGARA FALLS NY


KEY	QTY.	BOTANICAL NAME	COMMON NAME	MIN. SIZE	REMARKS
		DECIDUOUS TREES			
СС	5	CERCIS CANADENSIS 'FOREST PANSY'	FOREST PANSY REDBUD	2" - 2 1/2" CAL.	B&B
PC	9	PYRUS CALLERYANA 'HOLMFORD'	NEW BEDFORD FLOWERING PEAR	2" - 2 1/2" CAL.	B&B
		SMALL/ORNAMENTAL TREES			
AC	1	AMELANCHIER CANADENSIS	SERVICEBERRY	6'-8' HIGH	B&B MULTI-STEM
MA	5	MALUS X 'ADIRONDACK'	ADIRONDACK CRABAPPLE	1 3/4" - 2" CAL.	B&B
		SHRUBS			
ТО	11	THUJA OCCIDENTALIS 'TECHNY'	TECHNY ARBORVITAE	4' HIGH	B&B FULL TO GROUND
PF	23	POTENTILLA FRUITICOSA 'GOLDFINGER'	GOLDFINGER POTENTILLA	NO. 5 CONT.	18"-24" HT., SPACE 3' O.C.
		GROUND COVER			
LM	210	LIRIOPE MUSCARI 'BIG BLUE'*	BIG BLUE LILYTURF	NO. 1 CONT.	SPACE 15" O.C.
		ORNAMENTAL GRASSES			
CxA	24	CALAMAGROSTIS X ACUTIFOLIA 'KARL FOERSTER'**	KARL FOERSTER FEATHER REED GRASS	NO. 3 CONT.	SPACE 3'-4' O.C.
PA	32	PENISETUM ALOPECUROIDES 'LITTLE BUNNY'	LITTLE BUNNY DWARF FOUNTAIN GRASS	NO. 2 CONT.	SPACE 12" O.C.

* FOLLOW A REGULAR WATERING SCHEDULE DURING THE FIRST GROWING SEASON TO ESTABLISH A DEEP, EXTENSIVE ROOT SYSTEM. TOLERATED MILD DROUGHT, WHEN ESTABLISHED.

** ORNAMENTAL GRASSES SHOULD BE PRUNED BACK IN ATE FALL OR EARLY SPRING TO ALLOW NEW FOLIAGE TO GROW IN SPRING.


PLANTING NOTES:

- 1. ALL INTERIOR LANDSCAPED AREAS SHALL HAVE A MINIMUM PLANTING SOIL DEPTH OF THREE (3) FEET AND BE FREE FROM ALL FORMS OF CONSTRUCTION DEBRIS AND FOREIGN MATERIAL.
- 2. ALL TREE PIT SAUCERS, SHRUB BEDS, ORNAMENTAL GRASS BEDS, AND PERENNIAL FLOWER BEDS SHALL RECEIVE THREE (3) INCHES DEPTH OF DARK SHREDDED HARDWOOD BARK MULCH.
- 3. ALL SEASONAL FLOWER BEDS SHALL BE A MINIMUM OF TWELVE (12) INCHES DEEP WITH A WELL-BLENDED MIXTURE OF 50% PEAT MOSS & 50% SCREENED TOPSOIL. NO MULCH SHALL BE INSTALLED IN THE SEASONAL FLOWER BEDS.
- 4. ALL DECIDUOUS AND EVERGREEN TREES SHALL BE STAKED WITH TWO (2) TREE STAKES AS PER TREE PLANTING DETAIL.

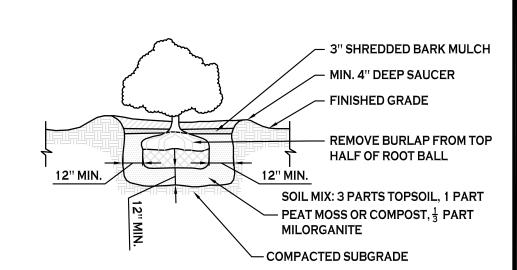


SHRUB PLANTING DETAIL


N.T.S.

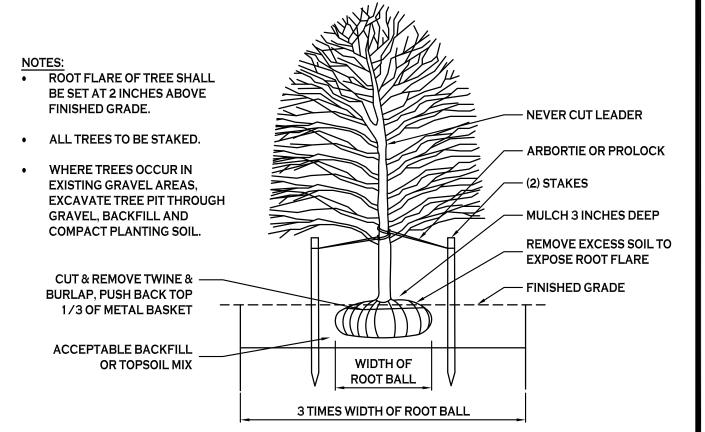

DECIDUOUS TREE PLANTING W/STAKES



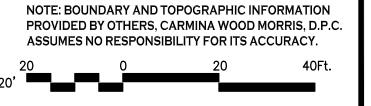

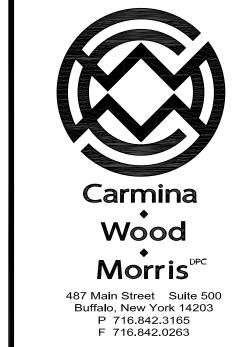

ROBERT C. WALTER, RLA

REGISTERED LANDSCAPE ARCHITECT

MEMBER AMERICAN SOCIETY OF LANDSCAPE ARCHITECTS

2765 DODGE ROAD, EAST AMHERST, NY 14051-2113

PHONE: 716-364-5564

765 DODGE ROAD , EAST AMHERST, NY 14051-2
PHONE: 716-364-5564
RCWLANDSCAPEARCHITECT@GMAIL.COM

tion Date out updated 1/9/19

Sumers Beverages

lew Constructi

Date: 12/7/18
Drawn by: P. Sheedy
Scale: As Noted

DRAWING NAME:

Landscape Plan

L-10

Project no.: 18.047

SCALE: 1"=20'



REVISIONS:

No. Description

A Site layout updated 1/9/19

onsumers Beverages

& 7121 Niagara Falls Blvd.

te:

Date: Drawn by: Scale:


DRAWING NAME:

12/7/18 P. Sheedy As Noted

Lighting Plan

DRAWING NO.

Project no.: 18.047

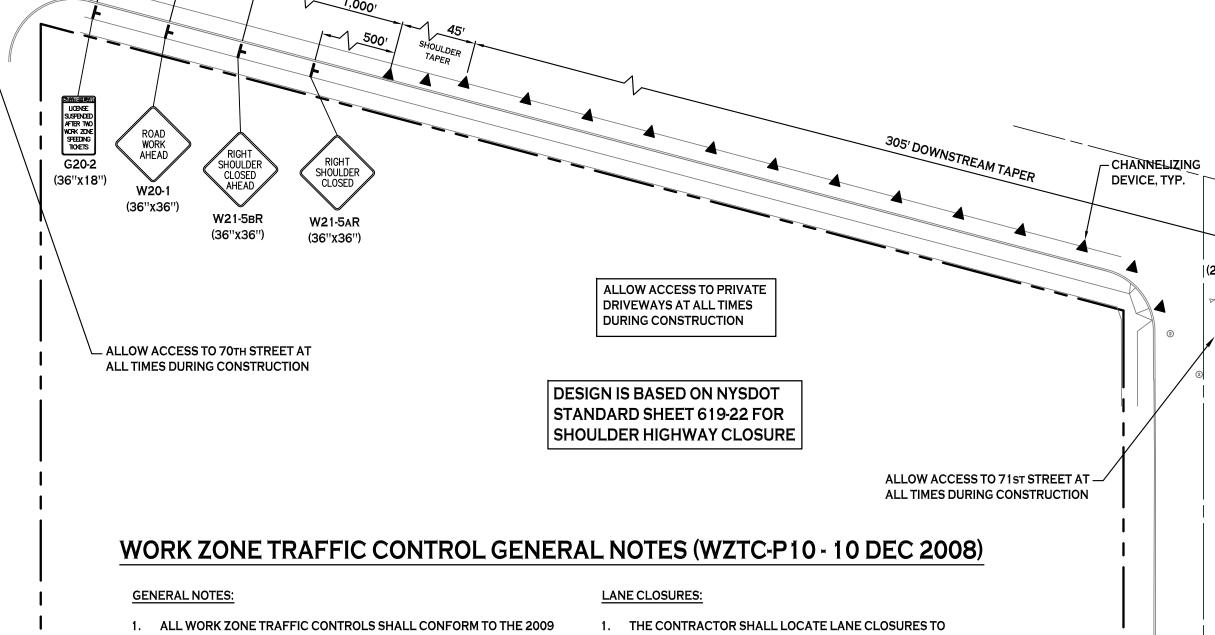

- MANUAL OF UNIFORM TRAFFIC CONTROL DEVICES (MUTCD), THE CURRENT STATE OF NEW YORK SUPPLEMENT, NYSDOT STANDARD SPECIFICATIONS, NYSDOT STANDARD SHEETS AND NYSDOT WORK **ZONE TRAFFIC CONTROL MANUAL DATED JANUARY 2012.**
- 2. THE TYPICAL DETAILS DEPICTED ON THE STANDARD SHEETS AND IN THE MUTCD, REFLECT THE MINIMUM REQUIREMENTS
- 3. THE CONTRACTOR MUST SUBMIT TO THE ENGINEER, IN WRITING, PROPOSED REVISIONS TO THE TRAFFIC CONTROL PLAN FOR REVIEW AND APPROVAL BY THE REGIONAL DIRECTOR OR HIS/HER DESIGNEE FIVE (5) WORK DAYS PRIOR TO THE PLANNED IMPLEMENTATION OF SUCH PROPOSED REVISIONS, EXCEPT FOR CHANGES THE ALTER THE SCOPE OF THE TRAFFIC CONTROL PLAN. SUCH CHANGES IN SCOPE MUST BE SUBMITTED TO THE ENGINEER FOR APPROVAL BY THE REGIONAL DIRECTOR OR HIS/HER DESIGNEE THIRTY (30) WORKING DAYS PRIOR TO THE IMPLEMENTATION OF SUCH REVISIONS.
- 4. THE CONTRACTOR SHALL PROVIDE THE ENGINEER, IN WRITING, WITH THE NAMES, ADDRESSES, AND TELEPHONE NUMBERS OF HIS STAFF WHO ARE AUTHORIZED TO SECURE LABOR, MATERIALS, AND EQUIPMENT FOR EMERGENCY REPAIRS OUTSIDE NORMAL WORKING HOURS. THE ENGINEER WILL PROVIDE THE SUBMITTED INFORMATION TO REGIONAL MANAGEMENT, THE NEW YORK STATE POLICE, THE RESIDENT ENGINEER, AND THE LOCAL POLICE.
- 5. NO WORK SHALL TAKE PLACE WITHIN ON THE STATE HIGHWAY BETWEEN THE HOURS OF 6AM TO 9AM AND 3PM TO 6PM. THESE TIME RESTRICTIONS INCLUDE THE SET UP AND TAKE DOWN OF WORK

ACTIVITY AREA:

- 1. THE CONTRACTOR SHALL MAINTAIN A MINIMUM 500'LONGITUDINAL DISTANCE BETWEEN CONSTRUCTION OPERATIONS ON ALTERNATE SIDE OF THE ROADWAY, UNLESS OTHERWISE APPROVED BY THE ENGINEER.
- 2. WHEN TWO OR MORE AREAS ARE ADJACENT, OVERLAP, OR ARE IN CLOSE PROXIMITY, THE CONTRACTOR SHALL ENSURE THERE ARE NO CONFLICTING SIGNS AND THAT LANE CONTINUITY IS MAINTAINED THROUGHOUT ALL WORK AREAS.

- 1. THE LOCATIONS OF THE SIGNS SHOWN ON THE WORK ZONE TRAFFIC CONTROL PLANS AND THE DETAILS MAY BE ADJUSTED BASED ON SIGHT DISTANCE AND OTHER CONSIDERATIONS. THE FINAL LOCATIONS OF SIGNS ARE SUBJECT TO THE APPROVAL BY THE ENGINEER.
- 2. ANY EXISTING SIGNS, INCLUDING OVERHEAD SIGNS, WHICH CONFLICT WITH THE TEMPORARY TRAFFIC CONTROL SIGN LAYOUT SHALL BE COVERED, REMOVED, STORED OR RESET, AS APPROVED BY THE ENGINEER. ALL APPROPRIATE EXISTING SIGNS SHALL BE RESTORED TO THEIR ORIGINAL CONDITION AND/OR LOCATION UNLESS OTHERWISE REPLACED IN THIS CONTRACT.
- 3. SINGS AT OR NEAR INTERSECTIONS SHALL BE PLACED SO THAT THEY DO NOT OBSTRUCT A MOTORIST'S LINE OF SIGHT.
- 4. ALL WARNING AND REGULATORY SIGNS SHALL BE POSTED ON BOTH SIDES OF MULTI-LANE DIVIDED HIGHWAYS, MULTI-LANE RAMPS, AND ONE-WAY STREETS. IN CASES WHERE LANE RESTRICTIONS REDUCE THE TRAVEL LANE TO ONE LANE, SIGNS SHALL BE POSTED ON THE RIGHT SIDE OF THE ACTIVE TRAVEL LANE, UNLESS OTHERWISE AUTHORIZED BY THE ENGINEER.
- 5. SIGNS MOUNTED ON THE MEDIAN OF DIVIDED HIGHWAYS WHERE MEDIAN BARRIER IS IN PLACE MAY BE MOUNTED ON THE BARRIER WITH A SADDLE TYPE BRACKET. LAYING THE SIGN DOWN IN A HORIZONTAL POSITION IS NOT PERMITTED.
- 6. THE DIMENSIONS OF WORK ZONE TRAFFIC CONTROL SIGNS ARE DESCRIBED IN THE MUTCD. ANY CHANGES TO THE DIMENSIONS SHALL BE APPROVED BY THE REGIONAL DIRECTOR OR BY HIS/HER DESIGNEE.
- 7. NYR9-12 MAY BE USED IN PLACE OF THE NYR9-11.

- PROVIDE OPTIMUM VISIBILITY, I.E. BEFORE CURVES AND CRESTS, TO THE EXTENT CONDITIONS PERMIT.
- THE ENGINEER MAY REQUIRE THAT ALL LANES BE RE-OPENED AT ANY TIME IF THE ROUTE IS NEEDED FOR EMERGENCY PURPOSES. THIS COULD INCLUDE INCIDENTS AT THE LOCATIONS OUTSIDE THE CONTRACT

- UNLESS AUTHORIZED BY THE ENGINEER, THE MINIMUM LANE WIDTHS FOR WORK ZONE TRAVEL SHALL BE AS FOLLOWS: FREEWAYS ABND/OR EXPRESSWAYS IS 11 THE MINIMUM LANE WIDTH FOR ALL OTHERS TYPES OF ROADWAYS IS 10'.
- THE CONTRACTOR SHALL PROVIDE A WRITTEN NOTICE TO THE ENGINEER, A MINIMUM OF 21 CALENDAR DAYS IN ADVANCE OF PERFORMING ANY WORK THAT RESULTS IN THE REDUCED WIDTH OF AN EXISTING ROADWAY, SO THAT THE ENGINEER MAY NOTIFY THE REGIONAL PERMIT ENGINEER IN A TIMELY MANNER.
- WHEN THE MINIMUM LANE WIDTH OF 10' CANNOT BE MAINTAINED DUE TO A SHOULDER CLOSURE, A SINGLE LANE CLOSURE SHOULD BE USED (NYSDOT 619-30 STANDARD SHEET).

BARRIER/SHADOW VEHICLES:

- BARRIER AND SHADOW VEHICLES SHALL BE REQUIRED AS PER STANDARD SHEET TITLED "WORK ZONE TRAFFIC CONTROL LEGEND AND TABLES".
- NO WORK ACTIVITY, EQUIPMENT, VEHICLES AND/OR MATERIALS SHALL BE LOCATED BETWEEN THE BARRIER OR SHADOW VEHICLE AND THE ACTIVE WORK AREA (ROLL AHEAD DISTANCES).
- 3. THE CONTRACTOR MAY BE REQUIRED TO PROVIDE A BARRIER VEHICLE IN CONJUNCTION WITH POLICE PRESENCE IN THE WORK ZONE, TO BE INCLUDED IN THE UNIT BID PRICE FOR BASIC WORK ZONE TRAFFIC
- LANE CLOSURE DETAILS AND TIMES SHALL BE APPROVED BY THE NYSDOT ENGINEER IN CHARGE.

CHANNELIZING DEVICES:

- WHERE POSSIBLE ALL CHANNELIZING AND GUIDING DEVICES ARE TO BE PLACED SO AS TO PROVIDE A MINIMUM 2' LATERAL CLEARANCE TO THE TRAVELED
- DRUMS SHALL BE USED FOR ANY LANE CLOSURES OR SHOULDER CLOSURES WHICH ARE TO REMAIN OVERNIGHT.

PUBLIC ACCESS:


- PROPERTY OWNERS WHOSE DRIVEWAYS WILL BE MADE INACCESSIBLE SHALL BE NOTIFIED BY THE CONTRACTOR AT LEAVE 24 HOURS PRIOR TO THE RESTRICTING USE OF THE DRIVEWAY. FOR MULTIPLE ACCESS PROPERTIES, AT LEAST ONE DRIVEWAY SHALL BE OPEN AT ALL TIMES. ACCESS SHALL BE RESTORED TO ALL DRIVEWAYS AS SOON AS POSSIBLE.
- SUITABLE RAMPS SHALL BE INSTALLED TO MAINTAIN SMOOTH TRANSITIONS FROM RESIDENTIAL AND COMMERCIAL DRIVEWAYS TO AND FROM THE WORK AREA.

MAINTENANCE & PROTECTION OF TRAFFIC PLAN

PROPOSED CONSUMERS

BEVERAGES 14,473 GSF



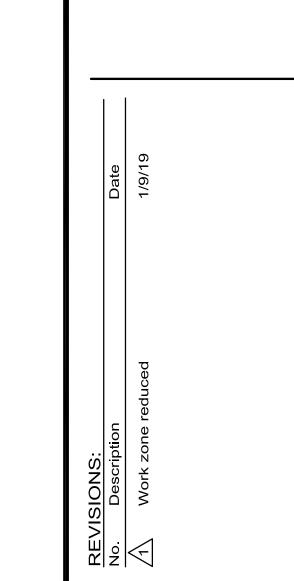

SIDEWALK CLOSED AHEAD CROSS HERE

(NYSDOT STD. SHEET 619-50)

PROPOSED BANK

END ROAD WORK

(36"x18")

ALLOW ACCESS TO 72ND STREET AT

MTP LEGEND

CONTROL SIGN

(20' SPACING)

WORK SPACE

TYPE III BARRIACDE

CHANNELIZING DEVICE

TEMPORARY WORK ZONE TRAFFIC

NOTE: BOUNDARY AND TOPOGRAPHIC INFORMATION

PROVIDED BY OTHERS, CARMINA WOOD MORRIS, D.P.C

ASSUMES NO RESPONSIBILITY FOR ITS ACCURACY.

ALL TIMES DURING CONSTRUCTION

Drawn by:

DRAWING NAME:


Maintenance & Protection of

P. Sheedy

DRAWING NO.

Traffic

SCALE: 1"=20"

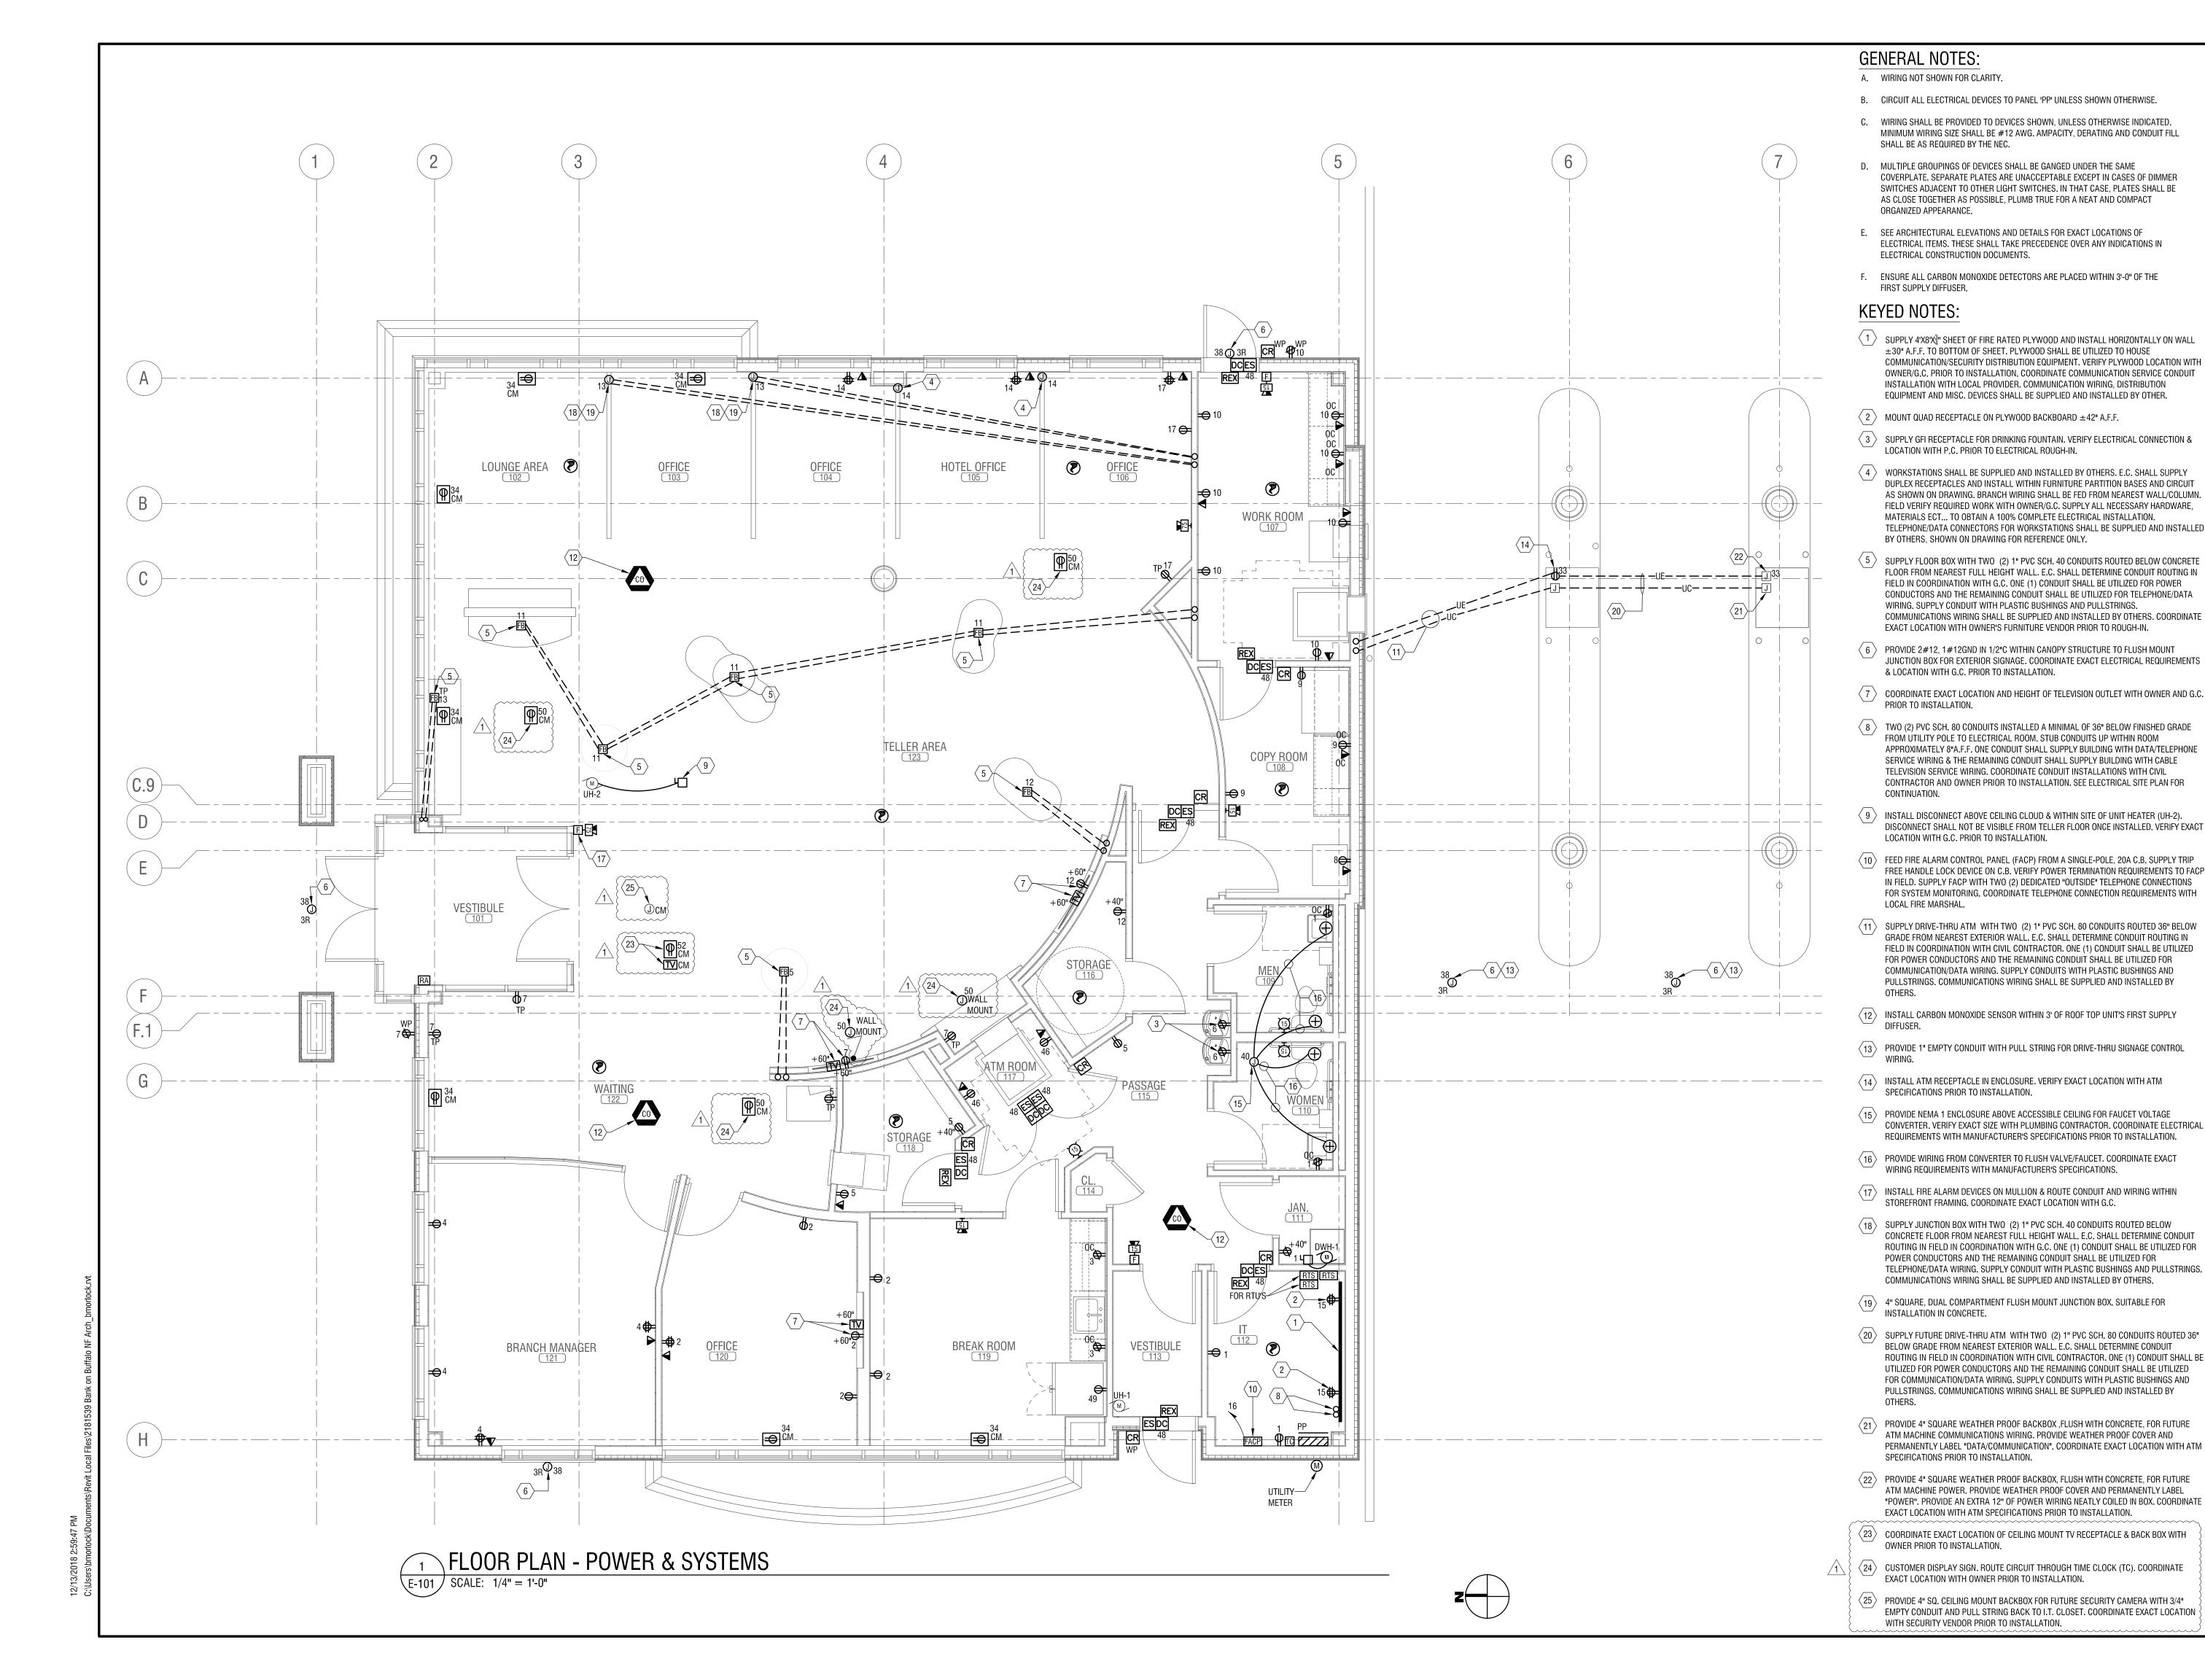



300 Pearl Street, Suite 130 Buffalo, NY 14202 716-551-6281

labellapc.com

It is a violation of New York Education Law Article 145 Sec.7209, for any person, unless acting under the direction of a licensed architect, professional engineer, or land surveyor, to alter an item in any way. If an item bearing the seal of an architect, engineer, or land surveyor is altered; the altering architect, engineer, or land surveyor shall affix to the item their seal and notation "altered by" followed by their signature and date of such alteration, and a specific description of the alteration.

BANK ON BUFFALO



NEW COMMUNITY BRANCH - NIAGARA FALLS

7121 Niagara Falls Blvd. Niagara Falls, NY 14304

ADDENDUM 1


NO:	DATE:	DESC	CRIPTION:
Revisions			
PROJECT N	NUMBER:	2181539	
DRAWN BY	/ :	ВТМ	
REVIEWED	BY:	DMR	
ISSUED FO	PR:	PERMIT	
DATE:		8 FEB 2019	
DRAWING	NAME:		


1 02-15-19


FLOOR PLAN - POWER & SYSTEMS

DRAWING NUMBER:

E-101

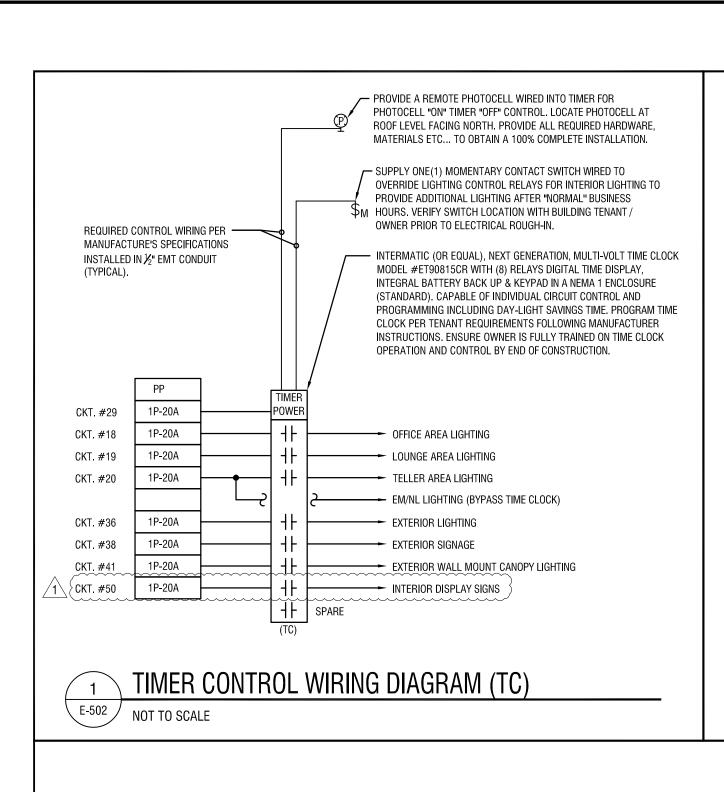


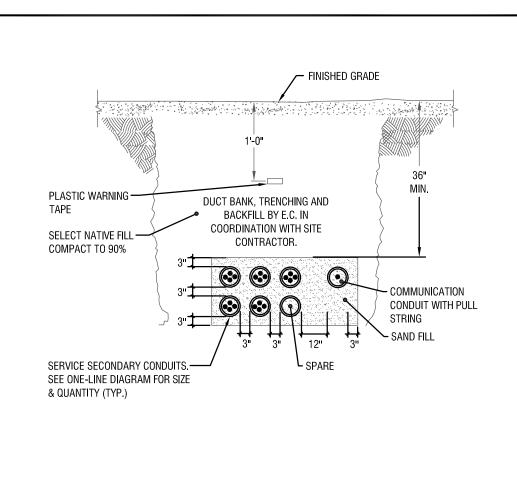

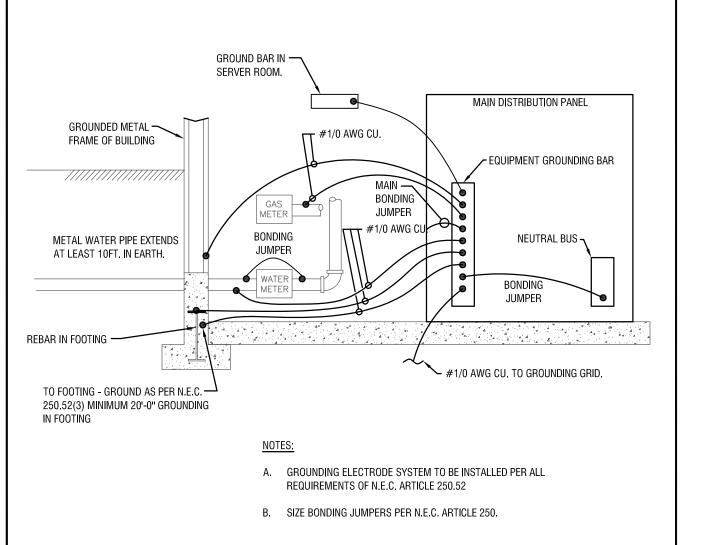

TYPICAL GROUNDING SYSTEM

E-502 NOT TO SCALE

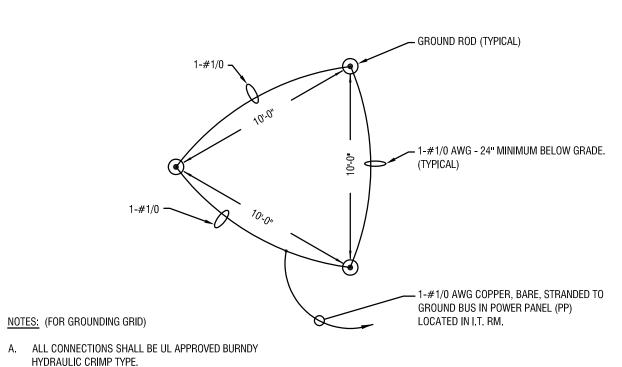

A. ALL CONNECTIONS SHALL BE UL APPROVED BURNDY

B. GROUND CABLES CONNECT TO SWITCHBOARD GROUND

C. ALL GROUND CABLE TO BE #1/0 AWG COPPER, BARE, STRANDED (NO EXCEPTIONS).

D. ALL TO CONFORM TO N.E.C. ARTICLE 250.

E. ELECTRICAL CONTRACTOR SHALL VERIFY GROUNDING GRID LOCATION IN FIELD. COORDINATE LOCATION WITH CIVIL CONTRACTOR.

GROUNDING GRID


E-502 NOT TO SCALE

GENERAL NOTES:

E-502 NOT TO SCALE

A. PROVIDE ARC FLASH ANALYSIS WITH WARNING LABELS AFFIXED TO PANELBOARDS AS REQUIRED BY NFPA 70E.

SECONDARY DUCTBANK (TYP.)

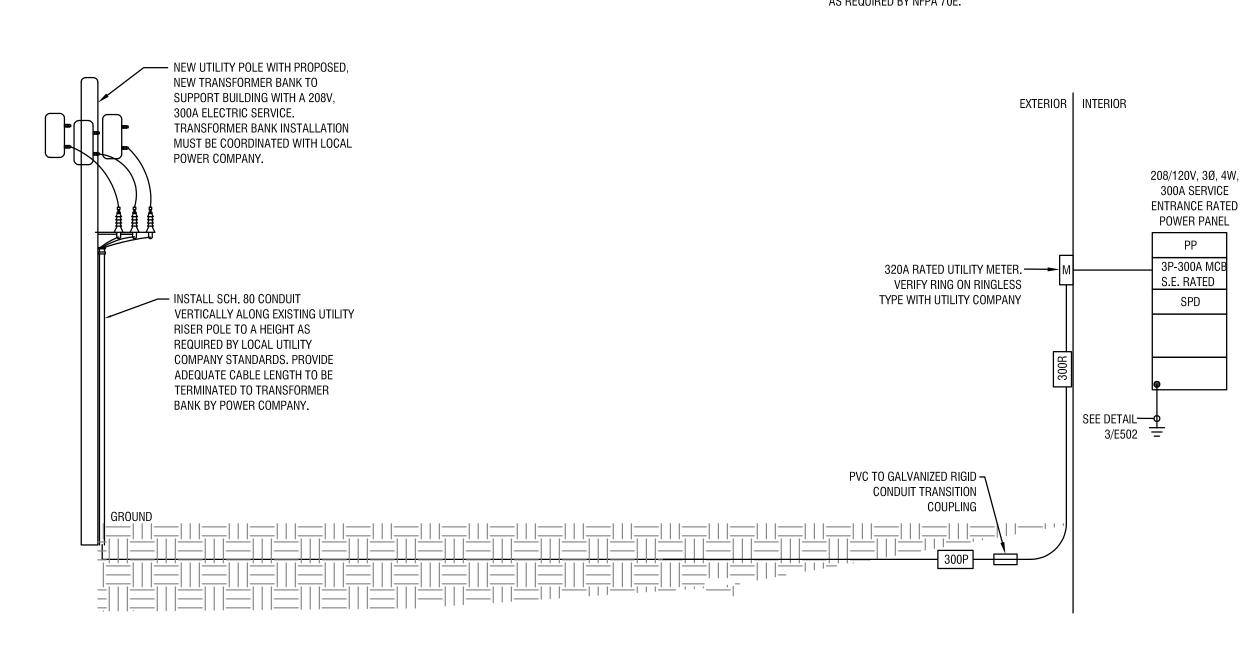

5 ONE-LINE DIAGRAM E-502 / SCALE: N.T.S.

LOW VOLTAGE FEEDER SCHEDULE (UNDER 600V)											
SYMB0L	DESCR	IPTION .									
300P	4-#350 MCM THWN Cu.	[2] 3" PVC SCH. 80 C. 36" BELOW FINISHED GRADE. ONE CONDUIT SHALL SERVE AS SPARE									
300R	4-#350 MCM THWN Cu.	[2] 3" GRC 36" BELOW FINISHED GRADE. ONE CONDUIT SHALL SERVE AS SPARE									
	[#] - INDICATES NUMBER OF CONDUIT RUNS CONTAINING THE FOLLOWING WIRING AS SHOWN.										



It is a violation of New York Education Law

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acting under the direction of a licensed

architect, professional engineer, or land

surveyor, to alter an item in any way. If an item

bearing the seal of an architect, engineer, or land surveyor is altered; the altering architect,

engineer, or land surveyor shall affix to the item their seal and notation "altered by"

followed by their signature and date of such alteration, and a specific description of the

alteration.

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NEW COMMUNITY BRANCH -NIAGARA FALLS

7121 Niagara Falls Blvd. Niagara Falls, NY 14304

1 NO: Revisions PROJECT N DRAWN BY REVIEWED ISSUED FOR			
1	02-15-19	ADDENDUM 1	
NO:	DATE:	DESCRIPTION:	
Revisions			
PROJECT N	IUMBER:	0101500	
		2181539	
DRAWN BY	/. ·	BTM	
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REVIEWED	BY:	DMR	
ISSUED EO	ıD.		
ISSUED FU	ın.	PERMIT	
DATE:		8 FEB 2019	
		OTED ZOTO	

DRAWING NAME:

DETAILS & ONE-LINE DIAGRAM -**ELECTRICAL**

DRAWING NUMBER:

								LUMI	NAIRE SCHEDULE			
TYPE	DESCRIPTION	INSTALLATION	MAX	LAMP/LIGHT SO	DURCE	BALLAST/DRIV	ER	MAX	SHIELDING / OPTICS	FEATURES / OPTIONS	REFERENCED PRODUCTS	NOTES
FA	2'x2' LED RECESSED BASKET LUMINAIRE. DIE-FORMED STEEL HOUSING.	METHOD RECESSED	DEPTH -	SPEC REFN LED 3500°K	QTY -	SPEC REFN 0-10V LED DIMMING DRIVER		WATTS 39	CURVED, LINEAR PRISM DIFFUSER	- FEATURES / OPTIONS	LITHONIA LIGHTING: 2BLT2-40L-ADP-EZ1-LP835 OR	- NOTES
	PROVIDE 1400 LUMEN BATTERY PACK FOR EM/NL LUMINAIRES.			4000 LUMENS		(1-100% LIGHT OUTPUT RANGE)			DIFFUSEN		APPROVED EQUAL	
FA1	2'x2' LED RECESSED BASKET LUMINAIRE. DIE-FORMED STEEL HOUSING.	RECESSED	-	LED 3500°K 3300 LUMENS	-	0-10V LED DIMMING DRIVER (1-100% LIGHT OUTPUT RANGE)	UNIV	39	CURVED, LINEAR PRISM DIFFUSER	-	LITHONIA LIGHTING: 2BLT2-33L-ADP-EZ1-LP835 OR APPROVED EQUAL	<u>-</u>
FB	6" DIAMETER RECESSED LED LUMINAIRE. GALVANIZED STEEL HOUSING.	RECESSED	-	LED 3500°K 2000 LUMENS	-	0-10V LED DIMMING DRIVER (10-100% LIGHT OUTPUT RANGE)	UNIV	23	SEMI-SPECULAR FINISH	-	LITHONIA LIGHTING: LDN6-35-20-L06-AR-LSS-MVOLT-EZ10 OR APPROVED EQUAL	-
FC	6" DIAMETER RECESSED LED LUMINAIRE. GALVANIZED STEEL HOUSING. WET LOCATION LISTED	RECESSED	-	LED 3500°K 2000 LUMENS	-	0-10V LED DIMMING DRIVER (10-100% LIGHT OUTPUT RANGE)	UNIV	23	SEMI-SPECULAR FINISH	-	LITHONIA LIGHTING: LDN6-35-20-L06-AR-LSS-MVOLT-EZ10-WL OR APPROVED EQUAL	-
FD	48" DIAMETER PENDANT LUMINAIRE. EXTRUDED ALUMINUM HOUSING FINISH (BY ARCHITECT)	PENDANT - AIRCRAFT CABLES 12'-0" A.F.F. VERIFY WITH ARCHITECT	-	LED 3500K 7600 LUMENS	-	0-10V LED DIMMING DRIVER (10-100% LIGHT OUTPUT RANGE)	UNIV	136	SEMI-DIRECT DISTRIBUTION WITH FLAT WHITE ACRYLIC DIFFUSER	-	PRUDENTIAL LIGHTING: 0-40-LED35-S0-FWA-CC-D9-SC-UNV- CA144-X3-DM10 FINISH BY ARCHITECT OR APPROVED EQUAL	-
FE	3' LONG SURFACE MOUNT LINEAR LED LUMINAIRE. COLD ROLLED STEEL HOUSING WITH WHITE FINISH	WALL - 1'-0" ABOVE DOOR	-	LED 4000°K 3750 LUMENS	-	0-10V LED DIMMING DRIVER (10-100% LIGHT OUTPUT RANGE)	UNIV	27	ROUND ACRYLIC LENS	-	LITHONIA LIGHTING: CLXLED-L36-SEF-RDL-MVOLT-GZ10- 40K-80CRI OR APPROVED EQUAL	-
FF	2' LONG RECESSED WALL WASH LUMINAIRE. 20 GAUGE GALVANIZED STEEL HOUSING	RECESSED	-	LED 3500°K 2000 LUMENS	-	0-10V LED DIMMING DRIVER (10-100% LIGHT OUTPUT RANGE)	120	24	(4) ADJUSTABLE LED MODULES, SOLITE DIFFUSION LENS, BLACK INTERIOR WITH MATTE WHITE FINISH	-	SPECTRUM LIGHTING: RC624FT3-LEDXT20L-35K-MD-DS10-1- S034-MBI-FT0624-MW OR APPROVED EQUAL	-
FG	EXTERIOR WALL MOUNT LED LUMINAIRE. TWO PIECE DIE-CAST ALUMINUM HOUSING WITH INTEGRAL HEAT SINKS AND PHOTOCELL.	SURFACE - WALL 14'-0" A.F.G. U.N.O.	-	LED 4000°K 10,000 LUMENS	-	LED DRIVER	120	109	MEDIUM DISTRIBUTION WITH ACRYLIC LENS	-	LITHONIA LIGHTING: DSXW2LED-30C-40K-T4M-120-PE-FINISH BY ARCHITECT OR APPROVED EQUAL	-
FH	FLEXIBLE LED COVE TAPE LUMINAIRE.	COVE	-	LED 3500°K 137 LUMENS/FT.	-	ACOLYTE LOW VOLTAGE LED DRIVER	120	3.0/FT.	CLEAR LENS	PROVIDE ACOLYTE LOW VOLTAGE 200W LED DIMMING DRIVER (ELV) FOR CEILING MOUNT COVE LIGHTING. MODEL DRV-W-24200ELV. PROVIDE 60W LED DIMMING DRIVER (ELV) FOR VERTICAL COVE LIGHTING. MODEL DRV-W-2460ELV.	ACOLYTE LIGHTING: RBS2-90-IP20-24-3.0-35-1 OR APPROVED EQUAL. VERIFY POWER FEED OPTIONS IN FIELD PRIOR TO ORDERING.	-
FI	12" SQUARE RECESSED LED LUMINAIRE. CORROSION RESISTANT ALUMINUM HOUSING AND TRIM. WET LOCATION LISTED	RECESSED	-	LED 4000°K 4,400 LUMENS	-	LED DRIVER	120	47	FLUSH LENS	-	SPECTRUM LIGHTING: SR12SQLEDOA-44L-40K-E-1-CR- FT1212-WLFINISH BY ARCHITECT OR APPROVED EQUAL	-
FJ	6" WIDE EXTERIOR WALL MOUNT LED LUMINAIRE. TWO PIECE DIE-CAST ALUMINUM HOUSING WITH INTEGRAL HEAT SINKS AND GASKETED DOOR FRAME.	WALL - 1'-0" ABOVE DOOR	-	LED 4000°K 4,500 LUMENS	-	LED DRIVER	UNIV	40	PRECISION MOLDED ACRYLIC LENS WITH TYPE III DISTRIBUTION	-	LITHONIA LIGHTING: WSQLED-P3-40K-SR3-MVOLT-FINISH BY ARCHITECT OR APPROVED EQUAL	-
	EMERGENCY LED LIGHTING WITH A WHITE IMPACT AND SCRATCH RESISTANT THERMOPLASTIC HOUSING, TWIN ADJUSTABLE HEADS AND AN INTEGRAL BATTERY PACK	WALL 8'-0" A.F.F.	-	TWO 1.5W LEDS	-	-	UNIV	3.0	<u>-</u>	-	LITHONIA LIGHTING: "QUANTUM" ELM2-LED OR APPROVED EQUAL	-
	EMERGENCY LED LIGHTING WITH A WHITE IMPACT AND SCRATCH RESISTANT THERMOPLASTIC HOUSING, TWIN ADJUSTABLE HEADS AND A HIGH OUTPUT INTEGRAL BATTERY PACK	WALL 8'-0" A.F.F.	-	TWO 1.5W LEDs	-	-	UNIV	3.0	-	-	LITHONIA LIGHTING: "QUANTUM" ELM2-LED-HO OR APPROVED EQUAL	-
$\overline{\lambda}$	REMOTE EMERGENCY LED FIXTURE WITH ADJUSTABLE LAMP HEAD AND A WEATHER-PROOF ALUMINUM HOUSING. FOR EMERGENCY EGRESS ILLUMINATION. LAMP HEADS SHALL BE SUPPLIED BY A AN LED REMOTE BATTERY PACK OR COMBO UNIT.		-	ONE 1.5W LED	-	-	UNIV	1.5	-	-	LITHONIA LIGHTING: ELA-QWP-L0304 OR APPROVED EQUAL	-
X1	EXIT SIGN. RECESSED MOUNT CEILING OR BACK, HIGH POLISH, INJECTION MOLDED ACRYLIC PANEL. RED LETTERS WITH INTEGRAL BATTERY PACK.	WALL OR CEILING	-	LED	-	-	UNIV	-	<u>-</u>	-	LITHONIA LIGHTING: "EDGE" LRP-1-RC-120/277-ELN OR APPROVED EQUAL	-

- A. REFERENCED PRODUCTS LISTED OF MANUFACTURER'S SERIES &/OR MODEL NUMBERS ARE LISTED TO GIVE A REPRESENTATION OF ACCEPTABLE BUILD QUALITY AND GENERALLY CONFORM TO THE LUMINAIRE DESIGN INTENT LISTED MANUFACTURER'S STANDARD PRODUCTS MAY REQUIRE CUSTOM MODIFICATIONS TO MEET THE REQUIREMENTS SPECIFIED IN THE LUMINAIRE SCHEDULE & IN THE SPECIFICATIONS. LISTED SIZES, LAMPING, LUMEN OUTPUT, EFFICACY, INPUT POWER, OPTIONS, & TYPES OF LUMINAIRES MAY NOT BE AVAILABLE FROM ANY GIVEN MANUFACTURER OR SERIES LISTED. IT IS THE RESPONSIBILITY OF THE CONTRACTOR TO PROVIDE PRODUCTS THAT MEET ALL LISTED REQUIREMENTS IN THE LUMINAIRE SCHEDULE AND SPECIFICATIONS. EQUIVALENT PRODUCTS BY OTHER MANUFACTURERS MAY BE CONSIDERED, PRIOR TO BID, AND APPROVED AT THE DISCRETION OF THE DESIGN ENGINEER.
- B. DETERMINE SPECIFIC LUMINAIRE PART NUMBERS BASED ON THE REFERENCED PRODUCT SERIES, WRITTEN DESCRIPTIONS, & SPECIFICATIONS.
- C. ALERT ARCHITECT/ENGINEER TO DISCREPANCIES PRIOR TO BID.
- D. UNLESS NOTED OTHERWISE, LED DRIVERS SHALL HAVE A POWER FACTOR OF NOT LESS THAN 0.9 AND A TOTAL HARMONIC DISTORTION OF NOT MORE THAN 20%.
- E. LUMINAIRE SHALL HAVE A WARRANTY OF NOT LESS THAN 5 YEARS.

	EQUIPMENT CONNECTION SCHEDULE													
LABEL	DESCRIPTION	LOCATION	LOAD	VOLTS, PHASE	FEED	CIRCUIT BREAKER	WIRE & CONDUIT	CONTROLLER TYPE	CONTROLLER SIZE	CONTROLLER ACCESSORIES	DISCONNECT	REMARKS		
DWH-1	DOMESTIC WATER HEATER	JANITORS CLOSET 111	6kW	208V, 3PH	PP/35,37,39	25A/3P	3#10, 1#10GND IN 3/4"C	-	-	-	SS, 30A, NEMA 1	-		
EF-1	EXHAUST FAN	R00F	1/6HP	120V, 1PH	PP/21	15A/1P	2#12, 1#12GND IN 1/2"C	-	-	-	IDS	2		
RTU-1	ROOF-TOP UNIT	R00F	18MCA	208V, 3PH	PP/22,24,26	25A/3P	3#10, 1#10GND IN 3/4"C	-	-	-	IDS	1		
RTU-2	ROOF-TOP UNIT	R00F	19MCA	208V, 3PH	PP/23,25,27	25A/3P	3#10, 1#10GND IN 3/4"C	-	-	-	IDS	1		
RTU-3	ROOF-TOP UNIT	R00F	43MCA	208V, 3PH	PP/28,30,32	50A/3P	3#6, 1#10GND IN 1"C	-	-	-	IDS	1		
UH-1	UNIT HEATER	VESTIBULE 113	1.5kW	208V, 1PH	PP/42,44	15A/2P	2#12, 1#12GND IN 1/2"C	FWU	-	-	-	-		
UH-2	UNIT HEATER	TELLER AREA 123	5.0kW	208V, 3PH	PP/43,45,47	20A/3P	3#12, 1#12GND IN 1/2"C	-	-	-	SS, 30A, NEMA 1	3		

EQUIPMENT CONNECTION SCHEDULE NOTES

- . PROVIDE FIRE ALARM FAN SHUTDOWN.
- EXHAUST FAN CONTROLLED BY BOTH THE MEN AND WOMEN'S ROOM'S LOCAL LIGHT SWITCHES. SEE WIRING DIAGRAM 7/E-501 FOR FURTHER INFORMATION.
- INSTALL DISCONNECT ABOVE CEILING CLOUD & WITHIN SITE OF UH-2.PROVIDE ALL NECESSARY MOUNTING HARDWARE FOR A 100% COMPLETE INSTALLATION.

- MOTOR CONTROLLER TYPES:

 TYPE A (FULL VOLTAGE, NON-MAGNETIC, SINGLE PHASE): SURFACE MOUNT, TOGGLE SWITCH, STAINLESS STEEL WALLPLATE.
- TYPE A1 (FULL VOLTAGE, NON-MAGNETIC SINGLE PHASE): SIMILAR TO TYPE A ABOVE EXCEPT WITH RED PILOT LIGHT.

EQUIPMENT CONNECTION SCHEDULE LEGEND

- FSS FUSIBLE SAFETY SWITCH, NUMBER INDICATES SWITCH SIZE. FUSES SHALL BE SIZED FOR EQUIPMENT MANUFACTURERS REQUIREMENTS.
- AU AT UNIT. SS - SAFETY SWITCH, NON-FUSED.
- PCU PACKAGED CONTROL UNIT, PROVIDE BY OTHERS. TS - TOGGLE TYPE SWITCH (SINGLE GANG).
- IDS INTEGRAL DISCONNECT SWITCH. R - RELAY FOR AUTOMATIC OPERATION BY THE FMS SYSTEM.
- LINE VOLTAGE THERMOSTAT.
- VFD VARIABLE FREQUENCY DRIVE.
- TSP TOGGLE SWITCH WITH PILOT LIGHT. ECTR - EXISTING CONTROLLER TO REMAIN.
- 3R NEMA 3R ENCLOSURE. OS - OCCUPANCY SENSOR.
- ST- TIMER SWITCH. SMPX - SIMPLEX RECEPTACLE.
- FWU FURNISHED WITH UNIT

DESIGN BASE: SQUARE D OR APPROVED EQUAL	
LOCATION: I.T. RM. 112	
BUS RATING: 300 Amps	
MAIN: 300 Amp MCB WITH INTEGRAL SPD	
SERVICE ENTRANCE LABEL: YES	

TOTAL CONNECTED AMPS

SCHEDULE

PANEL

FULLY RATED AIC: 42,000 Amps RMS SYM. SERVICE: 208/120V, 3Ø, 4W MOUNTING: SURFACE

	: 300 Amp MCB WITH INTEGRAL SPD ICE ENTRANCE LABEL: YES				P	ANE	L 'F	P				FED FROM: UTILITY TRANSFORMER ENCLOSURE TYPE: NEMA 1		
CKT.	LOAD DESIGNATION	WIRE SIZE	BREAKER	L1	(VA)	L2	(VA)	L3 (VA)		BREAKER	WIRE SIZE	LOAD DESIGNATION	CKT.	
1	RESTROOM RECEPTACLES		20A/1P	720	1260					20A/1P		OFFICE 120 RECEPTACLES	2	1
3	BREAK ROOM 119 RECEPTACLES		20A/1P			540	1260			20A/1P		BRANCH MANAGER 121 RECEPTACLES	4	
5	STORAGE ROOM 118 RECEPTACLES		20A/1P					720	720	20A/1P		DRINKING FOUNTAIN RECEPTACLES	6	
7	WAITING ROOM 122 RECEPTACLES		20A/1P	900	720					20A/1P		COPY ROOM PRINTER RECEPTACLES	8	
9	COPY ROOM 108 RECEPTACLES		20A/1P			900	1260			20A/1P		WORK ROOM 107 RECEPTACLES	10	
11	TELLER AREA 123 FLOOR RECEPTACLES		20A/1P					360	360	20A/1P		TELLER AREA 123 FLOOR RECEPTACLES	12	
13	OFFICE 103 RECEPTACLES		20A/1P	1260	1260					20A/1P		OFFICE 104 RECEPTACLES	14	
15	I.T. ROOM RECEPTACLES		20A/1P			720	720			20A/1P		FIRE ALARM CONTROL PANEL	16	
17	OFFICE 106 RECEPTACLES		20A/1P					540	1060	20A/1P		OFFICE AREA LIGHTING	18	
19	LOUNGE AREA LIGHTING		20A/1P	820	1080					20A/1P		TELLER AREA LIGHTING	20	
21	EXHAUST FAN (EF-1)		15A/1P	5A/1P 540 2160					22					
23								2280	2160	25A/3P		ROOF-TOP UNIT (RTU-1)	24	
25	ROOF-TOP UNIT (RTU-2)		25A/3P	2280	2160								26	
27						2280	5160						28	
29	TIME CLOCK		20A/1P					540	5160	50A/3P		ROOF-TOP UNIT (RTU-3)	30	1
31	ROOF TOP RECEPTACLES		20A/1P	540	5160					ĺ			32	1
33	DRIVE-THRU ATM		20A/1P			720	1260			15A/1P		CEILING MOUNT RECEPTACLES	34	
35								2000	660	20A/1P		EXTERIOR LIGHTS	36	
37	DOMESTIC HOT WATER HEATER (DWH-1)		25A/3P	2000	600					20A/1P		EXTERIOR SIGNS	38	
39						2000	600			15A/1P		AUTOMATIC FLUSH VALVES	40	
41	EXTERIOR WALL MOUNT CANOPY LIGHTS		20A/1P					200	750	15A/2D		UNIT HEATER (UH-1)	42	
43				1667	750					15A/2P		ONIT HEATEN (OH-1)	44	
45	UNIT HEATER (UH-2)		20A/3P			1667	540			20A/1P		ATM ROOM 117 RECEPTACLES	46	
47								1667	720	20A/1P		ELECTRIC DOOR STRIKES	48]
49	BREAK ROOM 119 REFRIGERATOR RECEPTACLE		20A/1P*	720	1080					20A/1P		CEILING MOUNT SIGN RECEPTACLES	50	
51	SPARE		20A/1P			_	720			20A/1P		CEILING MOUNT TV RECEPTACLE	52	 } <u>/1</u> \
53	SPARE		20A/1P					_	-	20A/1P		SPARE	54	1
	TOTAL CONNECTED VA/LEG			24	977	23	047	19	897		<u>.</u>]
	TOTAL CONNECTED KVA				67.92					* INDICATES GFCI TYPE CIRCUIT BREAKER				



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It is a violation of New York Education Law Article 145 Sec.7209, for any person, unless acting under the direction of a licensed architect, professional engineer, or land surveyor, to alter an item in any way. If an item bearing the seal of an architect, engineer, or land surveyor is altered; the altering architect, engineer, or land surveyor shall affix to the item their seal and notation "altered by" followed by their signature and date of such alteration, and a specific description of the alteration.

BANK ON BUFFALO



NEW COMMUNITY BRANCH -NIAGARA FALLS

7121 Niagara Falls Blvd. Niagara Falls, NY 14304

l	02-15-19	ADDENDUM I	
NO:	DATE:	DESCRIPTION:	
Revisions			
DDO IFOT N	IIII ADED		
PROJECT N	IUIVIBEK:	2181539	
DRAWN BY	.	ВТМ	
REVIEWED	BY:	DMR	
ISSUED FO	R:	PERMIT	
DATE:		8 FEB 2019	

SCHEDULES -**ELECTRICAL**

DRAWING NUMBER:

DRAWING NAME: