



GREGORY A. TOMSIC

REGISTERED ARCHITECT

145 BATHURST DR., TONAWANDA, N.Y. 14150  
716-435-0617

# BRYANT & STRATTON COLLEGE

1320 Warwick Way  
Mt. Pleasant, WI 53406



## ARCHITECT:

**GREGORY A. TOMSIC**  
145 BATHURST DR.,  
TONAWANDA, N.Y. 14150 716-435-0617

## STRUCTURAL ENGINEER:

**STUDIO T3 ENGINEERING**  
2455 MAIN ST., SUITE 301  
BUFFALO, NEW YORK 14214

## MEP ENGINEER:

**EBS ENGINEERING, PC**  
4050 RIDGE LEA ROAD, SUITE C  
AMHERST, NY 14228 716-836-9600


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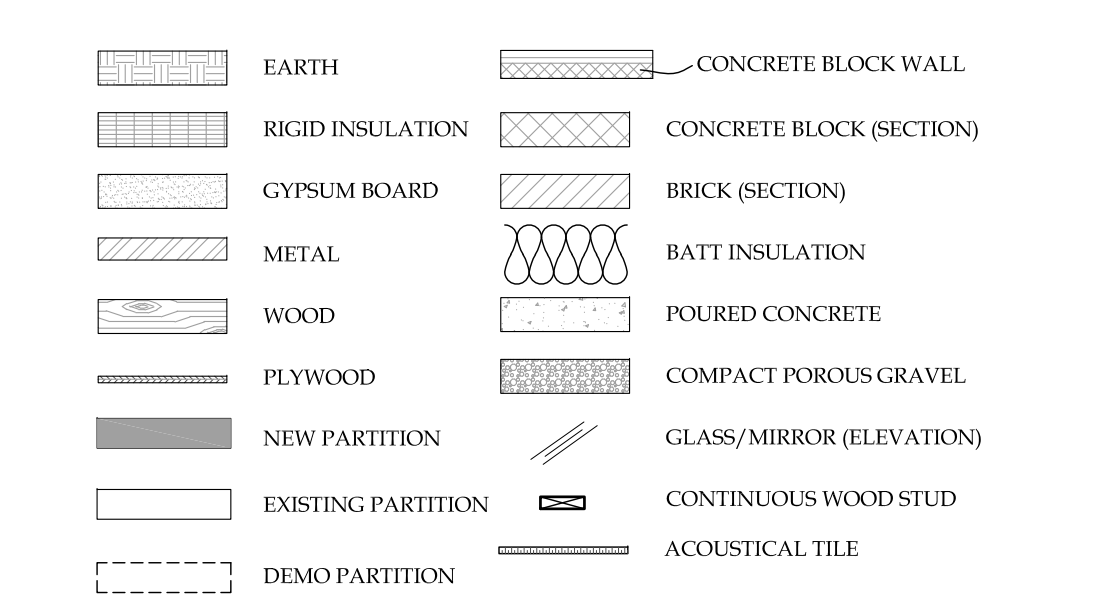
## ABBREVIATIONS

|          |  |           |   |
|----------|--|-----------|---|
| A.F.F.   | ABOVE FINISH FLOOR                       | N.I.C.    | NOT IN CONTRACT                         |
| ACT.     | ACOUSTICAL TILE                          | N.T.S.    | NOT TO SCALE                            |
| A.C.     | AIR CONDITION                            | NOM.      | NOMINAL                                 |
| ALT.     | ALTERNATE                                | NO.       | NUMBER                                  |
| ALUM.    | ALUMINUM                                 | O.C.      | ON CENTER                               |
| APPROX.  | APPROXIMATE                              | OPNG.     | OPENING                                 |
| ARCH.    | ARCHITECTURAL                            | OPP.      | OPPOSITE                                |
| AUTO.    | AUTOMATIC                                | OPPH.     | OPPOSITE HAND                           |
| BM.      | BEAM                                     | OH.       | OVERHEAD                                |
| BRG.     | BEARING                                  | PMBC.     | PREENGINEERED METAL BUILDING CONTRACTOR |
| B.M.     | BENCH MARK                               | PNT.      | PAIN (ED)                               |
| BLK.     | BLOCK                                    | PNL.      | PANEL                                   |
| BLKG.    | BLOCKING                                 | P.T.D.    | PAPER TOWEL DISPENSER                   |
| BJ.      | BOTTOMS                                  | P.T.R.    | PAPER TOWEL RECEPTOR                    |
| BRK.     | BRICK                                    | PVMT.     | PAVEMENT                                |
| B.E.J.   | BRICK EXPANSION JOINT                    | PC, BD.   | PEG BOARD                               |
| B.C.     | BRICK COURSE                             | PLAS.     | PLASTER                                 |
| BLDG.    | BUILDING                                 | P.L.      | PLYWOOD                                 |
| BUR.     | BUILT-UP ROOFING                         | PL.       | PLATE                                   |
| CL.G.    | CEILING                                  | PLSHD.    | POLISHED                                |
| CAB.     | CABINET                                  | PWD.      | PLYWOOD                                 |
| CPT.     | CAPIT                                    | PT.       | POINT                                   |
| C.W.     | CASEWORK                                 | PS.       | POUNDS PER SQ. INCH                     |
| CLB.     | CATCH BASIN                              | PSF.      | POUNDS PER SQ. FOOT                     |
| CEM.     | CEMENT                                   | PRE. FAB. | PREFABRICATED                           |
| CHD.     | CHALK BOARD                              | PREP.     | PREPARED                                |
| CLR.     | CLEAR                                    | PROJ.     | PROJECTION                              |
| COLM.    | COLUMN                                   | PL.       | PROPERTY LINE                           |
| CONC.    | CONCRETE                                 | QT.       | QUARRY TILE                             |
| CMU.     | CONCRETE MASONRY UNIT                    |           |   |
| CONT.    | CONTINUOUS                               |           |   |
| CONTR.   | CONTRACTOR                               |           |   |
| CT.      | CONTROL JOINT                            |           |   |
| C.G.     | CORNER GUARD                             |           |   |
| CRS.     | COURSE                                   |           |   |
| DET.     | DETAIL                                   | RAD.      | RADIUS                                  |
| DIA.     | DIAMETER                                 | R.W.L.    | RAIN WATER LEADER                       |
| DM.      | DIMENSION                                | RECP.     | RECEPTACLE                              |
| DISP.    | DISPENSER                                | REC.      | RECESS                                  |
| DN.      | DOWN                                     | REFR.     | REFRIGERATOR                            |
| DS.      | DOWNSPOUT                                | REG.      | REGISTER                                |
| DWG.     | DRAWING                                  | REQ'D.    | REQUIRED (D) (ING)                      |
| D.F.     | DRINKING FOUNTAIN                        | RES.      | RECESS (ED)                             |
| DIFF.    | DIFFUSER                                 | R.C.P.    | REFLECTED CEILING PLAN                  |
|          |  | RA.       | RETURN                                  |
|          |  | RVS.      | REVERSE                                 |
| EA.      | EACH                                     | REV.      | REVISION                                |
| EIBS.    | EXTERIOR INSULATION & FINISH SYSTEM      | RH.       | RIGHT HAND                              |
| ELEC.    | ELECTRICAL                               | RHW.      | RIGHT OF WAY                            |
| EPNL.    | ELECTRIC PANEL                           | R.        | RISER                                   |
| ELEV.    | ELEVATOR                                 | R.D.      | ROOF DRAIN                              |
| EQ.      | EQUAL                                    | ROOF.     | ROOFING                                 |
| E.Q.F.   | EQUALIZED FAN                            | RM.       | ROOM                                    |
| EXIST.   | EXISTING                                 | RND.      | ROUND                                   |
| EXP. JT. | EXPANSION JOINT                          | SDL.      | SADDLE                                  |
| FB.      | FACE BRICK                               | STG.      | SEATING                                 |
| FIN.     | FINISH (ED)                              | SHTH.     | SHEATHING                               |
| F.A.     | FIRE ALARM                               | SHR.      | SHOWER                                  |
| F.H.C.   | FIRE HOSE CABINET                        | SIM.      | SIMILAR                                 |
| F.P.     | FIRE PROOFING                            | SPKR.     | SPEAKER                                 |
| FL.      | FLOOR                                    | SPEC.     | SPECIFICATIONS                          |
| F.D.     | FLOOR DRAIN                              | SQ.       | SQUARE                                  |
| FOOT.    | FOOT                                     | SS.       | STAINLESS STEEL                         |
| F.W.C.   | FACE WALL COVERING                       | ST.       | STANDARD                                |
| FTG.     | FOOTING                                  | STD.      | STANDARD                                |
| FTDN.    | FOUNDATION                               | SD.       | STORM DRAIN                             |
| FUR.     | FURRING                                  | SGT.      | STRUCTURAL GLAZED TILE                  |
| GAL.     | GALLON                                   | STRUC.    | STRUCTURAL                              |
| GA.      | GAGE                                     | SUSP.     | SUSPENDED                               |
| G.C.     | GENERAL CONTRACTOR                       | SW.       | SWITCH                                  |
| GL.      | GLASS                                    | SWBD.     | SWITCH BOARD                            |
| G.B.     | GIB BAR                                  | SV.       | SHEET VINYL                             |
| G.W.B.   | GYPSON WALL BOARD                        |           |   |
| GYP.     | GYPSON                                   | T.B.      | TACKBOARD                               |
| HDW.     | HARDWARE                                 | TEL.      | TELEPHONE                               |
| HD. WD.  | HARDWOOD                                 | TEMP.     | TEMPERATURE                             |
| HVAC.    | HEATING, VENTILATING, & AIR CONDITIONING | TEX.      | TEXTURE                                 |
| HT.      | HEIGHT                                   | THR.      | THICK (NESS)                            |
| HC.      | HOLLOW CORE                              | THR.      | THRESHOLD                               |
| HM.      | HOLLOW METAL                             | TP.       | TOILET PAPER HOLDER                     |
| HWBIZ.   | HORIZONTAL                               | T/O.      | TOP OF                                  |
| HB.      | HOSE BIB                                 | TB.       | TOWEL BAR                               |
| H.W.     | HOT WATER                                | TYP.      | TYPICAL                                 |
| INSUL.   | INSULATE (D) (ION)                       | U.C.L.    | UNDER CABINET LIGHT                     |
| INS. GL. | INSULATED GLASS                          | UR.       | URINAL                                  |
| INS.     | INSULATION                               |           |   |
| JAN.     | JANITOR                                  | V.T.R.    | VENT THRU ROOF                          |
| JT.      | JOINT                                    | VENT.     | VENTILATOR                              |
| KIT.     | KITCHEN                                  | VERT.     | VERTICAL                                |
| KO.      | KNOCK OUT                                | VEST.     | VESTIBULE                               |
| LAM.     | LAMINATED                                | V.C.T.    | VINYL COMPOSITE TILE                    |
| LAV.     | LAVATORY                                 | V.I.F.    | VERIFY IN FIELD                         |
| LH.      | LEFT HAND                                | V.W.C.    | VINYL WALL COVERING                     |
| LGT.     | LENGTH                                   |           |   |
| LGHT.    | LIGHT                                    | WSCT.     | WAINSCOT                                |
| L.F.     | LINEAR FEET                              | WS.       | WEATHER STRIP                           |
| LTL.     | LINTEL                                   | WEGHT.    | WEIGHT                                  |
| LI.      | LEVEL                                    | WWF.      | WIRE FABRIC                             |
| L.L.H.   | LONG LEG HORIZONTAL                      | W.C.D.F.  | WHEELCHAIR DRINKING FOUNTAIN            |
| L.V.     | LONG LEG VERTICAL                        | W.        | WITH                                    |
| L.M.F.   | LIGHT GAUGE METAL FRAMING                | W/O.      | WITHOUT                                 |
| L.V.R.   | LOOK VIEW                                | WD.       | WOOD                                    |
| L.P.     | LOW POINT                                |           |   |
| MACH.    | MACHINE                                  |           |   |
| M.H.     | MANHOLE                                  |           |   |
| MFR.     | MANUFACTURE                              |           |   |
| MAS.     | MASONRY                                  |           |   |
| M.O.     | MASONRY OPENING                          |           |   |
| MATL.    | MATERIAL                                 |           |   |
| MAX.     | MAXIMUM                                  |           |   |
| MECH.    | MECHANICAL                               |           |   |
| MEMB.    | MEMBRANE                                 |           |   |
| MET.     | METAL                                    |           |   |
| M.T.P.   | METAL TOILET PARTITION                   |           |   |
| MIN.     | MINIMUM                                  |           |   |
| MIS.C.   | MISCELLANEOUS                            |           |   |
| MULL.    | MULLION                                  |           |   |


## DRAFTING SYMBOLS



## MATERIAL SYMBOLS

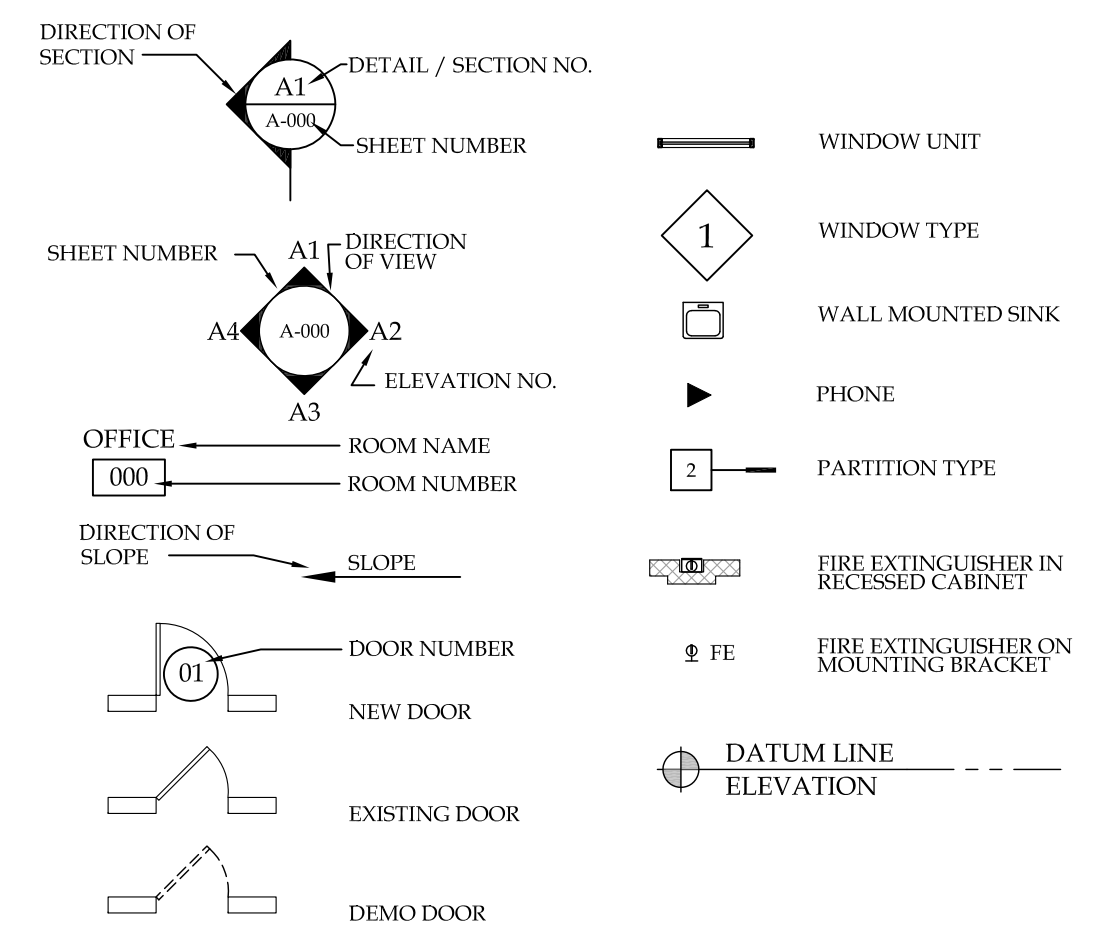

## SHEET IDENTIFICATION LOGIC

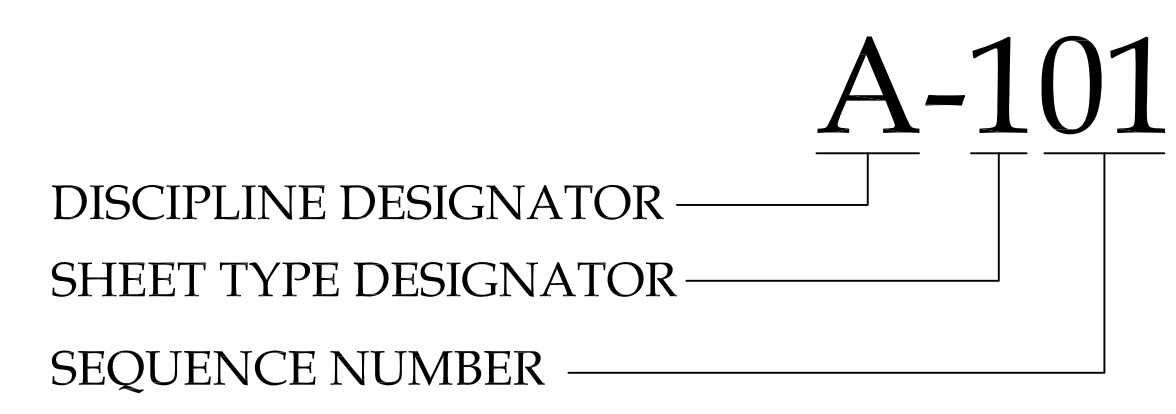

| DISCIPLINE DESIGNATOR | SHEET TYPE DESIGNATOR |
|-----------------------|-----------------------|
| G                     | GENERAL               |
| C                     | CIVIL                 |
| L                     | LANDSCAPE             |
| S                     | STRUCTURAL            |
| A                     | ARCHITECTURAL         |
| F                     | FIRE PROTECTION       |
| P                     | PLUMBING              |
| M                     | MECHANICAL            |
| E                     | ELECTRICAL            |
| 0                     | GENERAL               |
| 1                     | PLANS                 |
| 2                     | ELEVATIONS            |
| 3                     | SECTIONS              |
| 4                     | LARGE SCALE VIEWS     |
| 5                     | DETAILS               |
| 6                     | SCHEDULES & DIAGRAMS  |

## BUILDING DATA


OCCUPANCY CLASSIFICATION: B  
CONSTRUCTION TYPE: IIB  
GROSS PROJECT AREA: 14,625 SF  
NET PROJECT AREA: 14,625 SF  
SPRINKLERED: NFPA 13

## ISSUE

1/10/18 ADDENDUM 2

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**GENERAL NOTES:**


1. THE STRUCTURAL DESIGN IS IN ACCORDANCE WITH CHAPTER 16 2015 INTERNATIONAL BUILDING CODE.
2. THE GENERAL CONTRACTOR SHALL INSURE THAT ALL WORK IS COMPLETED IN ACCORDANCE WITH ALL APPLICABLE FEDERAL, STATE AND LOCAL BUILDING CODES AND ORDINANCES.
3. REPRODUCTION OF ANY PORTION OF THE STRUCTURAL DRAWINGS IS A VIOLATION OF COPYRIGHT LAWS. ALL PLANS, NOTES, DETAILS, AND SECTIONS MUST BE REDRAWN AND COORDINATED WITH THE ARCHITECTURAL DRAWINGS. REPRODUCED CONTRACT DOCUMENTS THAT ARE SUBMITTED WILL NOT BE REVIEWED.
4. THE GENERAL CONTRACTOR SHALL VERIFY ALL INFORMATION SHOWN ON THE PLANS PRIOR TO INITIATING CONSTRUCTION, AND SHALL NOTIFY THE ENGINEER IMMEDIATELY OF ANY DISCREPANCIES BETWEEN EXISTING CONDITIONS AND THOSE SHOWN ON THE PLANS FOR POSSIBLE MODIFICATION OF THE DESIGN OR DETAILS.
5. THE CONTRACTOR SHALL REFER TO ARCHITECTURAL DRAWINGS FOR INFORMATION NOT NOTED ON THE STRUCTURAL DRAWINGS. THE CONTRACTOR SHALL COMPARE THE STRUCTURAL DRAWINGS WITH THE ARCHITECTURAL DRAWINGS AND REPORT ANY DISCREPANCIES TO THE ENGINEER PRIOR TO COMPLETION OF SHOP DRAWINGS.
6. ANY DEVIATION FROM, ADDITION TO, SUBSTITUTION FOR, OR MODIFICATIONS TO THE STRUCTURE SHOWN ON THESE DRAWINGS SHALL BE SUBMITTED IN WRITING TO THE ENGINEER FOR REVIEW. SHOP DRAWINGS THAT ARE SUBMITTED FOR REVIEW DO NOT CONSTITUTE "IN WRITING" UNLESS IT IS CLEARLY NOTED THAT SPECIFIC CHANGES ARE BEING SUGGESTED.
7. THE STRUCTURAL DRAWINGS AND SPECIFICATIONS REPRESENT THE FINISHED STRUCTURE. THEY DO NOT INDICATE THE METHODS OF CONSTRUCTION UNLESS SO STATED OR NOTED. THE CONTRACTOR SHALL PROVIDE ALL MEASURES NECESSARY TO PROTECT WORKERS AND OTHER PERSONS DURING CONSTRUCTION.
8. THE STRUCTURAL DRAWINGS ARE NOT TO BE SCALED FOR DETERMINATION OF QUANTITIES, LENGTHS OR FIT OF MATERIALS.
9. THE GENERAL CONTRACTOR SHALL BE SOLELY AND EXCLUSIVELY RESPONSIBLE FOR THE ADEQUACY OF ALL SHORING AND BRACING. THE CONTRACTOR SHALL PROVIDE TEMPORARY ERECTION SHORING AND BRACING OF ALL STRUCTURAL WORK AS REQUIRED FOR THE STABILITY OF THE STRUCTURE DURING ALL PHASES OF CONSTRUCTION. THE CONTRACTOR SHALL IMMEDIATELY INFORM THE ENGINEER OF ANY CONDITION WHICH, IN HIS OPINION, MIGHT ENDANGER THE STABILITY OF THE STRUCTURE OR CAUSE DISTRESS IN THE STRUCTURE.
10. THE GENERAL CONTRACTOR SHALL VERIFY ALL DIMENSIONS IN THE FIELD PRIOR TO INITIATING FABRICATION.
11. DESIGN LOADS:  
LIVE LOADS:  
SNOW LOAD (GROUND): 30 PSF  
SNOW DRIFT LOADS AS REQUIRED BY IBC SECTION 1603.1.3 & 1608.  
WIND LOAD: 3 SECOND GUST SPEED = 115 MPH  
WIND EXPOSURE CATEGORY 'B'  
SEISMIC LOADING: SEISMIC DESIGN CATEGORY 'B'  
SITE CLASS 'D' (ASSUMED)  
DEAD LOADS:  
ROOF: 25 P.S.F.  
  
OTHER DEAD LOADS HAVE BEEN CALCULATED TO INCLUDE THE ACTUAL WEIGHT OF ALL WORK SHOWN ON THE STRUCTURAL DRAWINGS. NO EQUIPMENT SHALL BE PLACED ON OR HUNG FROM THE ROOF SYSTEM WITHOUT WRITTEN APPROVAL OF THE ENGINEER.
12. COMPLETE SHOP DRAWINGS FOR THE STRUCTURAL WORK SHALL BE SUBMITTED TO THE ENGINEER FOR REVIEW PRIOR TO COMMENCEMENT OF CONSTRUCTION. REVIEW OF SHOP DRAWINGS BY THE ENGINEER DOES NOT RELIEVE THE CONTRACTOR OF FULL RESPONSIBILITY FOR CORRECT FABRICATION AND CONSTRUCTION OF THE WORK.
13. PRINCIPAL OPENINGS ARE SHOWN ON THE STRUCTURAL DRAWINGS. THE CONTRACTOR SHALL REFER TO ARCHITECTURAL DRAWINGS FOR SLEEVES, CURBS, INSERTS, AND SIMILAR DETAILS NOT SHOWN. SIZE AND LOCATION OF ALL OPENINGS SHALL BE VERIFIED BY THE CONTRACTOR. ANY DEVIATION FROM OPENINGS SHOWN ON THE ARCHITECTURAL DRAWINGS SHALL BE BROUGHT TO THE ENGINEER'S ATTENTION FOR APPROVAL PRIOR TO CONSTRUCTION.
14. CONSTRUCTION MATERIALS SHALL NOT BE STORED ON ROOF IN EXCESS OF THE DESIGN LIVE LOADS UNLESS SPECIFICALLY APPROVED IN WRITING BY THE STRUCTURAL ENGINEER OF RECORD. IMPACT SHALL BE AVOIDED WHEN PLACING MATERIALS ON ROOF. IT IS THE CONTRACTOR'S RESPONSIBILITY TO ENFORCE THESE REQUIREMENTS.

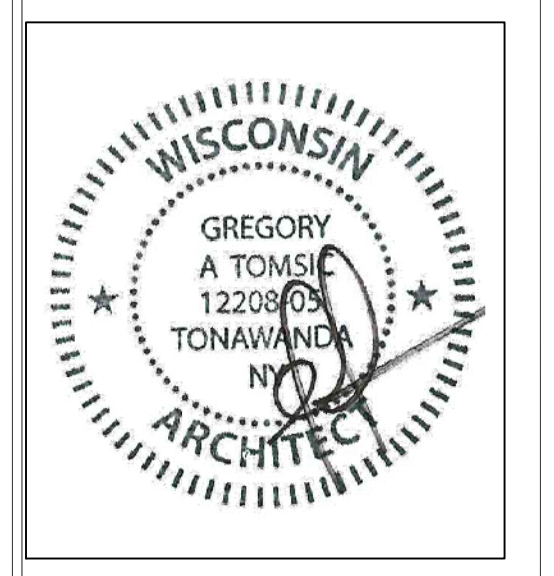**FOUNDATION AND CONCRETE NOTES:**

1. FOOTINGS SHALL BEAR ON UNDISTURBED SOIL HAVING AN ALLOWABLE BEARING CAPACITY OF 4,000 POUNDS PER SQ. FT. PER EXISTING STRUCTURAL DRAWING 1 BY ANDERSON-ASHTON INC. DATED 8/25/78.
2. IF BEARING MATERIALS WITH A LOWER BEARING CAPACITY THAN 4,000 POUNDS PER SQ. FT. ARE ENCOUNTERED, THE UNDERLYING UNSUITABLE MATERIAL SHALL BE REMOVED AND REPLACED WITH SUITABLE MATERIAL APPROVED BY THE ENGINEER.
3. THE ARCHITECT AND ENGINEER ASSUME NO RESPONSIBILITY FOR THE ADEQUACY OF THE SUBSURFACE CONDITIONS.
4. ANY OBSTRUCTIONS ENCOUNTERED DURING EXCAVATION WHICH MAY INTERFERE WITH THE CONSTRUCTION OF ANY OF THE FOUNDATIONS OR WALLS MUST BE REMOVED AND REPLACED IN COMPLIANCE WITH THE ENGINEER'S RECOMMENDATIONS.
5. GENERAL CONTRACTOR SHALL INSURE COMPLIANCE WITH ALL APPLICABLE STATE, COUNTY, AND LOCAL BUILDING ORDINANCES.
6. NO CONCRETE SHALL BE PLACED IN WATER OR ON FROZEN GROUND.
7. ALL CONCRETE AND FOUNDATIONS SHALL BE PROTECTED AGAINST FROST UNTIL THE PROJECT IS COMPLETED.
8. BACKFILL UNDER ANY PORTION OF THE BUILDING OR FOUNDATION SHALL BE COMPACTED IN 6" LIFTS OF 95% COMPACTED FILL AS APPROVED BY THE GEOTECHNICAL ENGINEER.
9. ALL CONCRETE WORK SHALL CONFORM TO "BUILDING CODE REQUIREMENTS FOR REINFORCED CONCRETE" (ACI 318-LATEST EDITION) AND "SPECIFICATIONS FOR STRUCTURAL CONCRETE FOR BUILDINGS" (ACI 301, LATEST EDITION).
10. CONCRETE SHALL HAVE A MINIMUM COMPRESSIVE STRENGTH OF 3,000 P.S.I. AT 28 DAYS.
11. CONCRETE SHALL HAVE A SLUMP OF NO MORE THAN 5" AND AIR ENTRAINMENT OF 4-6%. THE USE OF CALCIUM CHLORIDE IS NOT PERMITTED. PROVIDE PROPER CONCRETE PROTECTION IN COLD WEATHER AND MAINTAIN PROPER CURING PROCEDURES IN ACCORDANCE WITH ALL A.C.I. REQUIREMENTS.
12. STEEL REINFORCEMENT SHALL CONFORM TO A.S.T.M. A-615, GRADE 60.
13. ALL REINFORCING BARS SHALL BE COLD BENT IN ACCORDANCE WITH THE PROPER RADI ESTABLISHED BY THE A.C.I. UNDER NO CIRCUMSTANCES SHALL HEAT BE APPLIED TO THE BARS TO OBTAIN BENDS.
14. ALL CONCRETE SLABS PLACED ON GROUND SHALL BE REINFORCED WITH FIBERMESH REINFORCING.
15. WHERE CONTINUOUS BARS ARE CALLED FOR, THEY SHALL BE RUN CONTINUOUSLY AROUND CORNERS AND LAPPED AT NECESSARY SPLICES OR HOOKED AT DISCONTINUOUS ENDS. LAPS SHALL BE 40 BAR DIAMETERS, UNLESS OTHERWISE SHOWN.
16. CONCRETE SHALL REACH 75% OF SPECIFIED STRENGTH BEFORE CONSTRUCTION LOADS ARE APPLIED, UNLESS SPECIFICALLY APPROVED BY THE STRUCTURAL ENGINEER-OF-RECORD. CONCRETE STRENGTH SHALL BE VERIFIED WITH 7-DAY CYLINDER BREAKS.
17. CONCRETE PROTECTION FROM REINFORCING BARS:  
FOUNDATION & BASEMENT WALLS: 2" CLEAR  
BOTTOM OF FOOTINGS & GRADE BEAMS: 3" CLEAR  
BEAMS, COLUMNS & STRUCTURAL SLABS: 1½" CLEAR.

**STRUCTURAL STEEL NOTES:**

1. ALL STEEL SHALL BE NEW STEEL, CONFORMING TO A.I.S.C. "SPECIFICATIONS FOR DESIGN, FABRICATION & ERECTION OF STRUCTURAL STEEL FOR BUILDINGS", LATEST EDITION, AND A.S.T.M. GRADE 50. ANGLES, PLATES, ETC. TO BE GRADE 36
2. STRUCTURAL STEEL TUBING SHALL CONFORM TO A.S.T.M. A 500, GRADE B, WITH A MINIMUM YIELD STRESS OF 46 K.S.I.
3. ALL CONNECTIONS SHOWN ARE "TYPE 2" CONNECTIONS AS DEFINED IN THE A.I.S.C. MANUAL OF STEEL CONSTRUCTION, UNLESS NOTED OTHERWISE. NO PERMANENT CONNECTIONS SHOULD BE MADE UP UNTIL THE STRUCTURE HAS BEEN PROPERLY ALIGNED. PROVIDE TEMPORARY BRACING AS REQUIRED.
4. ALL CONNECTIONS SHALL BE DESIGNED AS "TYPE 2" CONNECTIONS (UNLESS NOTED OTHERWISE) AND SHALL BE CAPABLE OF SUPPORTING ONE-HALF OF THE MAXIMUM ALLOWABLE UNIFORM LOAD AS INDICATED UNDER PART 2 OF THE MANUAL OF STEEL CONSTRUCTION, LATEST EDITION.
5. ALL SHOP AND FIELD WELDS SHOWN SHALL BE MADE BY APPROVED CERTIFIED WELDERS AND SHALL CONFORM TO THE A.W.S. CODE FOR BUILDINGS. ALL WELDS SHALL DEVELOP THE FULL STRENGTH OF THE MATERIAL BEING WELDED. USE E-70XX ELECTRODES.
6. ALL STEEL SHALL HAVE ONE COAT OF RUST INHIBITIVE PRIMER PAINT. TOUCH UP ALL WELDS, SCRATCHES, OR SCRAPES AFTER ERECTION.
7. WELD ALL STEEL CONTACT SURFACES (OTHER THAN BOLTED CONNECTIONS) WITH A CONTINUOUS 3/16" (MINIMUM) FILLET WELD.
8. THE FABRICATOR SHALL DESIGN ALL CONNECTIONS. CONNECTION DESIGNS SHALL COMPLY WITH ALL APPLICABLE PROVISIONS OF THE A.I.S.C. "MANUAL OF STEEL CONSTRUCTION, ALLOWABLE STRESS DESIGN," LATEST EDITION, WHERE DESIGN REACTIONS ARE SHOWN ON DRAWINGS, THESE VALUES SUPERSEDE THE MINIMUM CRITERIA IN THE A.I.S.C. MANUAL.
9. REPRODUCTION OF THE CONTRACT DRAWINGS FOR USE IN SHOP DRAWING SUBMITTAL IS PROHIBITED. ALL PLANS, SECTIONS, NOTES, AND DETAILS SHALL BE COORDINATED WITH THE ARCHITECTURAL PLANS AND REDRAWN. REPRODUCED CONTRACT DRAWINGS SUBMITTED WILL NOT BE REVIEWED.
10. ALL STRUCTURAL STEEL CONNECTIONS & DETAILS SHALL CONFORM TO THE A.I.S.C. "CODE OF STANDARD PRACTICE FOR STEEL BUILDINGS & BRIDGES."
11. UNFINISHED THREADED FASTENERS SHALL CONFORM TO A.S.T.M. A 307 GRADE A BOLTS & NUTS WITH HEXAGONAL HEADS. UNFINISHED THREADED FASTENERS SHALL BE USED ONLY FOR ANCHORAGE TO CONCRETE CONSTRUCTION.
12. BOLTED CONNECTIONS OF PRIMARY MEMBERS SHALL CONFORM TO THE REQUIREMENTS OF THE A.I.S.C. "SPECIFICATIONS FOR STRUCTURAL JOINTS USING A.S.T.M. A 325 BOLTS." ALL PRIMARY CONNECTIONS SHALL USE A.S.T.M. A 325 BOLTS AND HEAVY HEX NUTS. ALL BOLTS AND NUTS SHALL BE NEW.
13. ALL STEEL BEAMS SHALL BE ERECTED WITH NATURAL CAMBER UP.
14. BOLTED CONNECTIONS SHALL BE BEARING TYPE WITH THREADS EXCLUDED FROM SHEAR PLANE UNLESS NOTED OTHERWISE.
15. THE USE OF OVERSIZED, SHORT-SLOTTED, OR LONG SLOTTED HOLES IN LIEU OF STANDARD HOLES REQUIRES THE APPROVAL OF THE ENGINEER-OF-RECORD.
16. THE USE OF THERMAL CUTTING IN THE PRODUCTION OR ALTERATION OF BOLT HOLES REQUIRES THE APPROVAL OF THE ENGINEER-OF-RECORD.
17. MOMENT CONNECTIONS ARE TO BE WELDED UNLESS NOTED OTHERWISE.

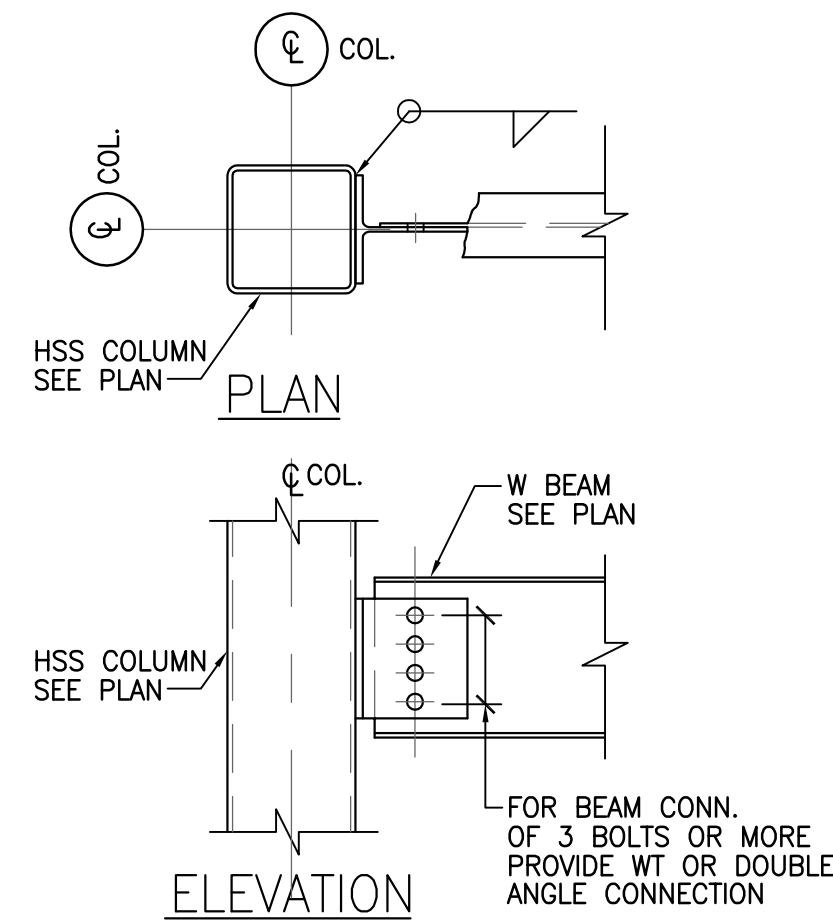


**TYPICAL CONNECTION  
W BEAM TO  
HSS COLUMN DETAIL**  
SCALE: 1" = 1'-0"

NOTE: PROVIDE MOMENT CONNECTION DETAILS IN ADDITION TO THE STANDARD SHEAR CONNECTION SHOWN.

| REVISION RECORD |      |         |
|-----------------|------|---------|
| NO.             | DATE | REMARKS |
|                 |      |         |

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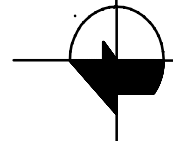
  
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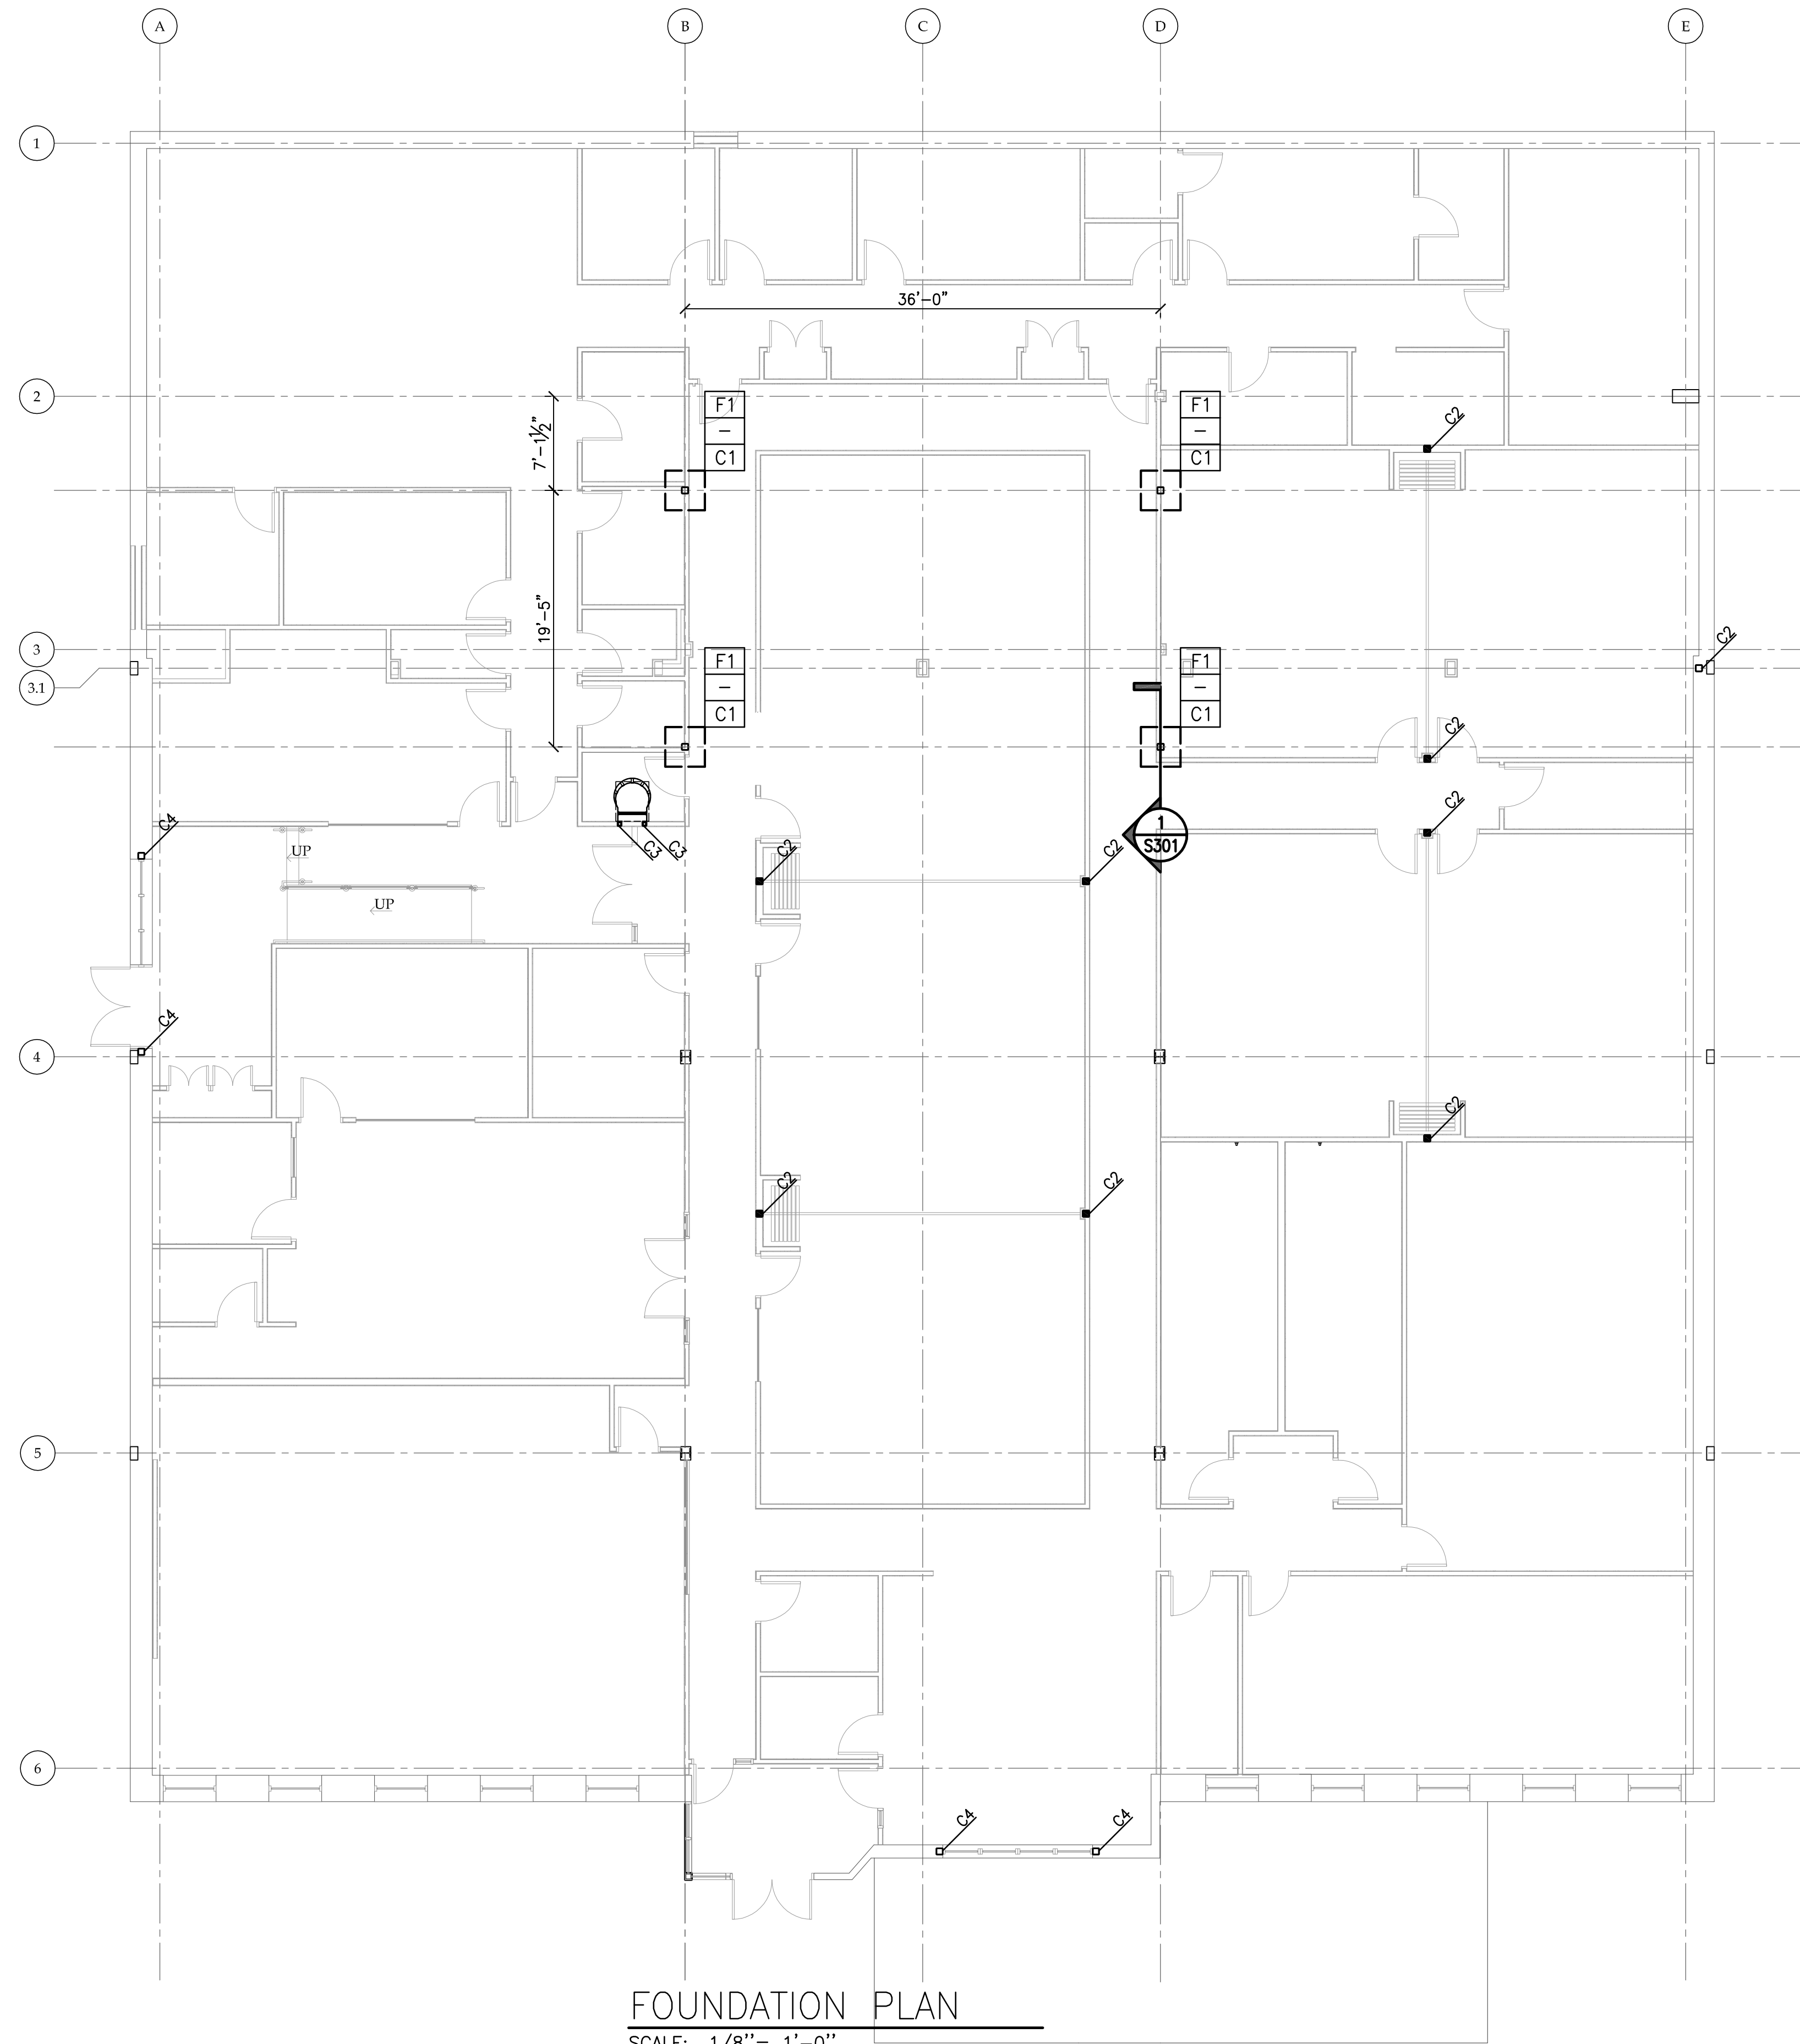
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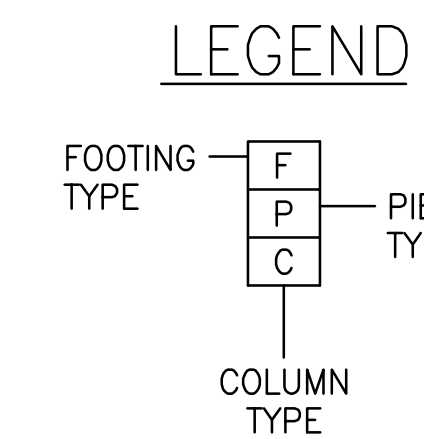
STRUCTURAL  
NOTES

  
**GREGORY A. TOMSIC**  
 REGISTERED ARCHITECT  
 145 BATHURST DR., TONAWANDA, N.Y. 14150  
 716-433-0617

|                    |                          |
|--------------------|--------------------------|
| SCALE<br>AS NOTED  | JOB NO.                  |
| DRAWN<br>MLK       | DWG. NO.<br><b>S-001</b> |
| CHECKED<br>LGT/MG  | CONTRACT NO.             |
| DATE<br>12.22.2017 |                          |



FOUNDATION PLAN  
SCALE: 1/8" = 1'-0"



| FOOTING SCHEDULE |                     |             |
|------------------|---------------------|-------------|
| TYPE             | SIZE                | REINFORCING |
| F1               | 4'-0" x 4'-0" x 18" | 5-#6 E.W.   |

| COLUMN SCHEDULE |                         |           |
|-----------------|-------------------------|-----------|
| TYPE            | SIZE                    | BASEPLATE |
| C1              | HSS6x6x5/16             | 1/S301    |
| C2              | HSS6x6x5/16             | 2/S301    |
| C3              | HSS3 1/2 x 3 1/2 x 5/16 | 4/S301    |
| C4              | HSS6x6x5/16             | 3/S301    |

NOTE: VERIFY ALL COLUMN LOCATIONS WITH ARCHITECTURAL DRAWINGS.

TOP OF SLAB ELEV. 0'-0" = REFERENCE ELEV.

NOTE: VERIFY LOCATIONS & SIZES OF ALL EXTERIOR DOORS WITH ARCH. DWGS. VERIFY DIMENSIONS WITH ARCH. DWGS.

| REVISION RECORD |      |         |
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SEAL:

FOUNDATION PLAN

GREGORY A. TOMSIC

REGISTERED ARCHITECT

145 BATHURST DR., TONAWANDA, N.Y. 14150  
716-433-0617

|                    |                          |
|--------------------|--------------------------|
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| DATE<br>12.22.2017 |                          |

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| NO.             | DATE   | REMARKS    |
| 1               | 1/3/18 | Addendum 1 |

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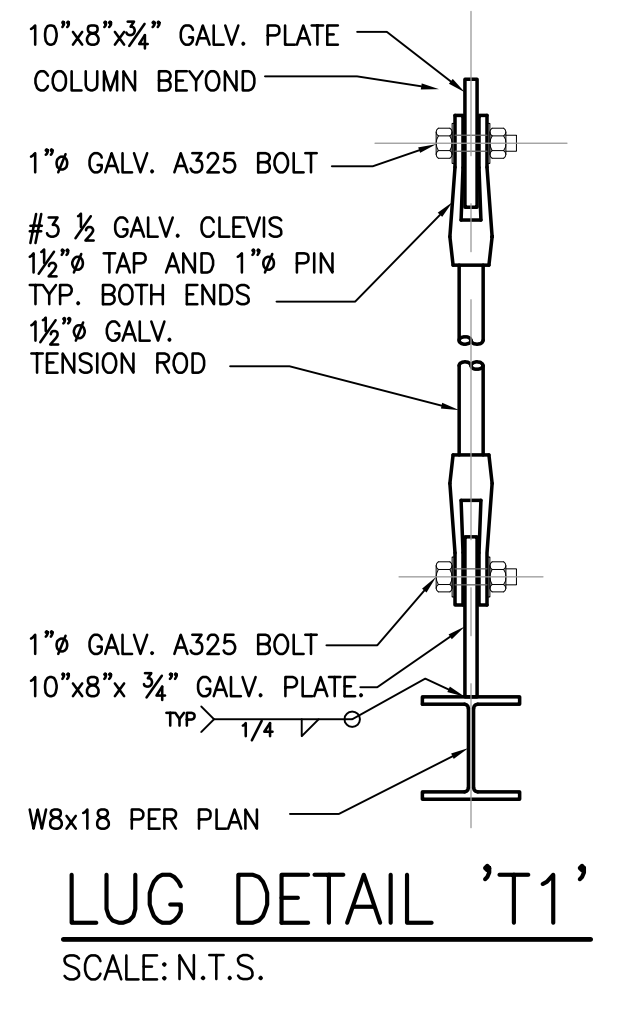
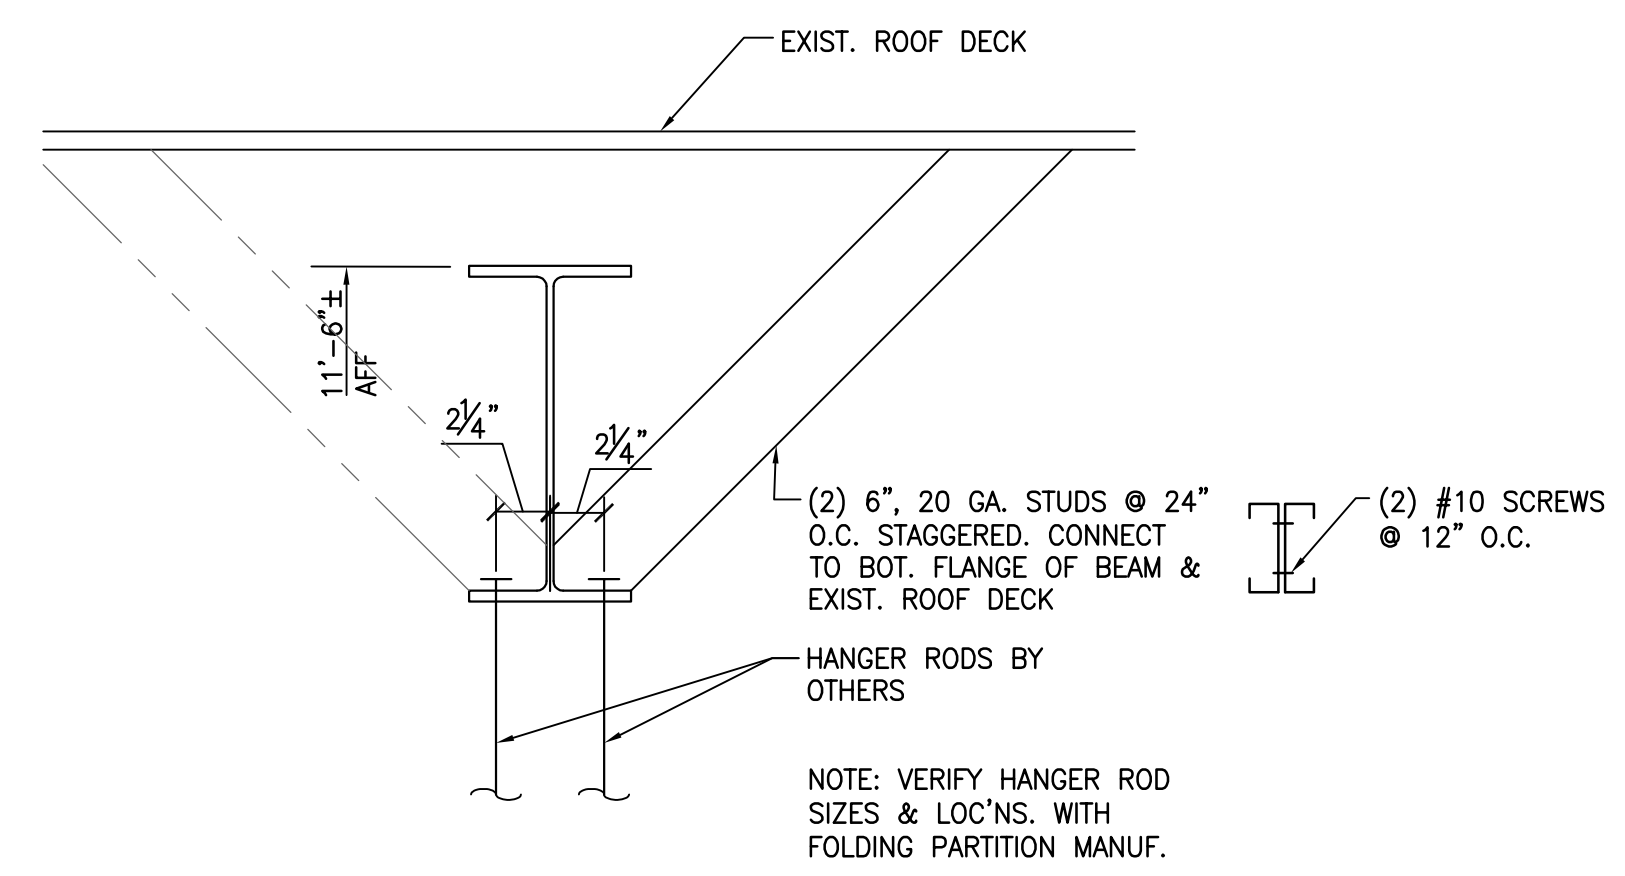
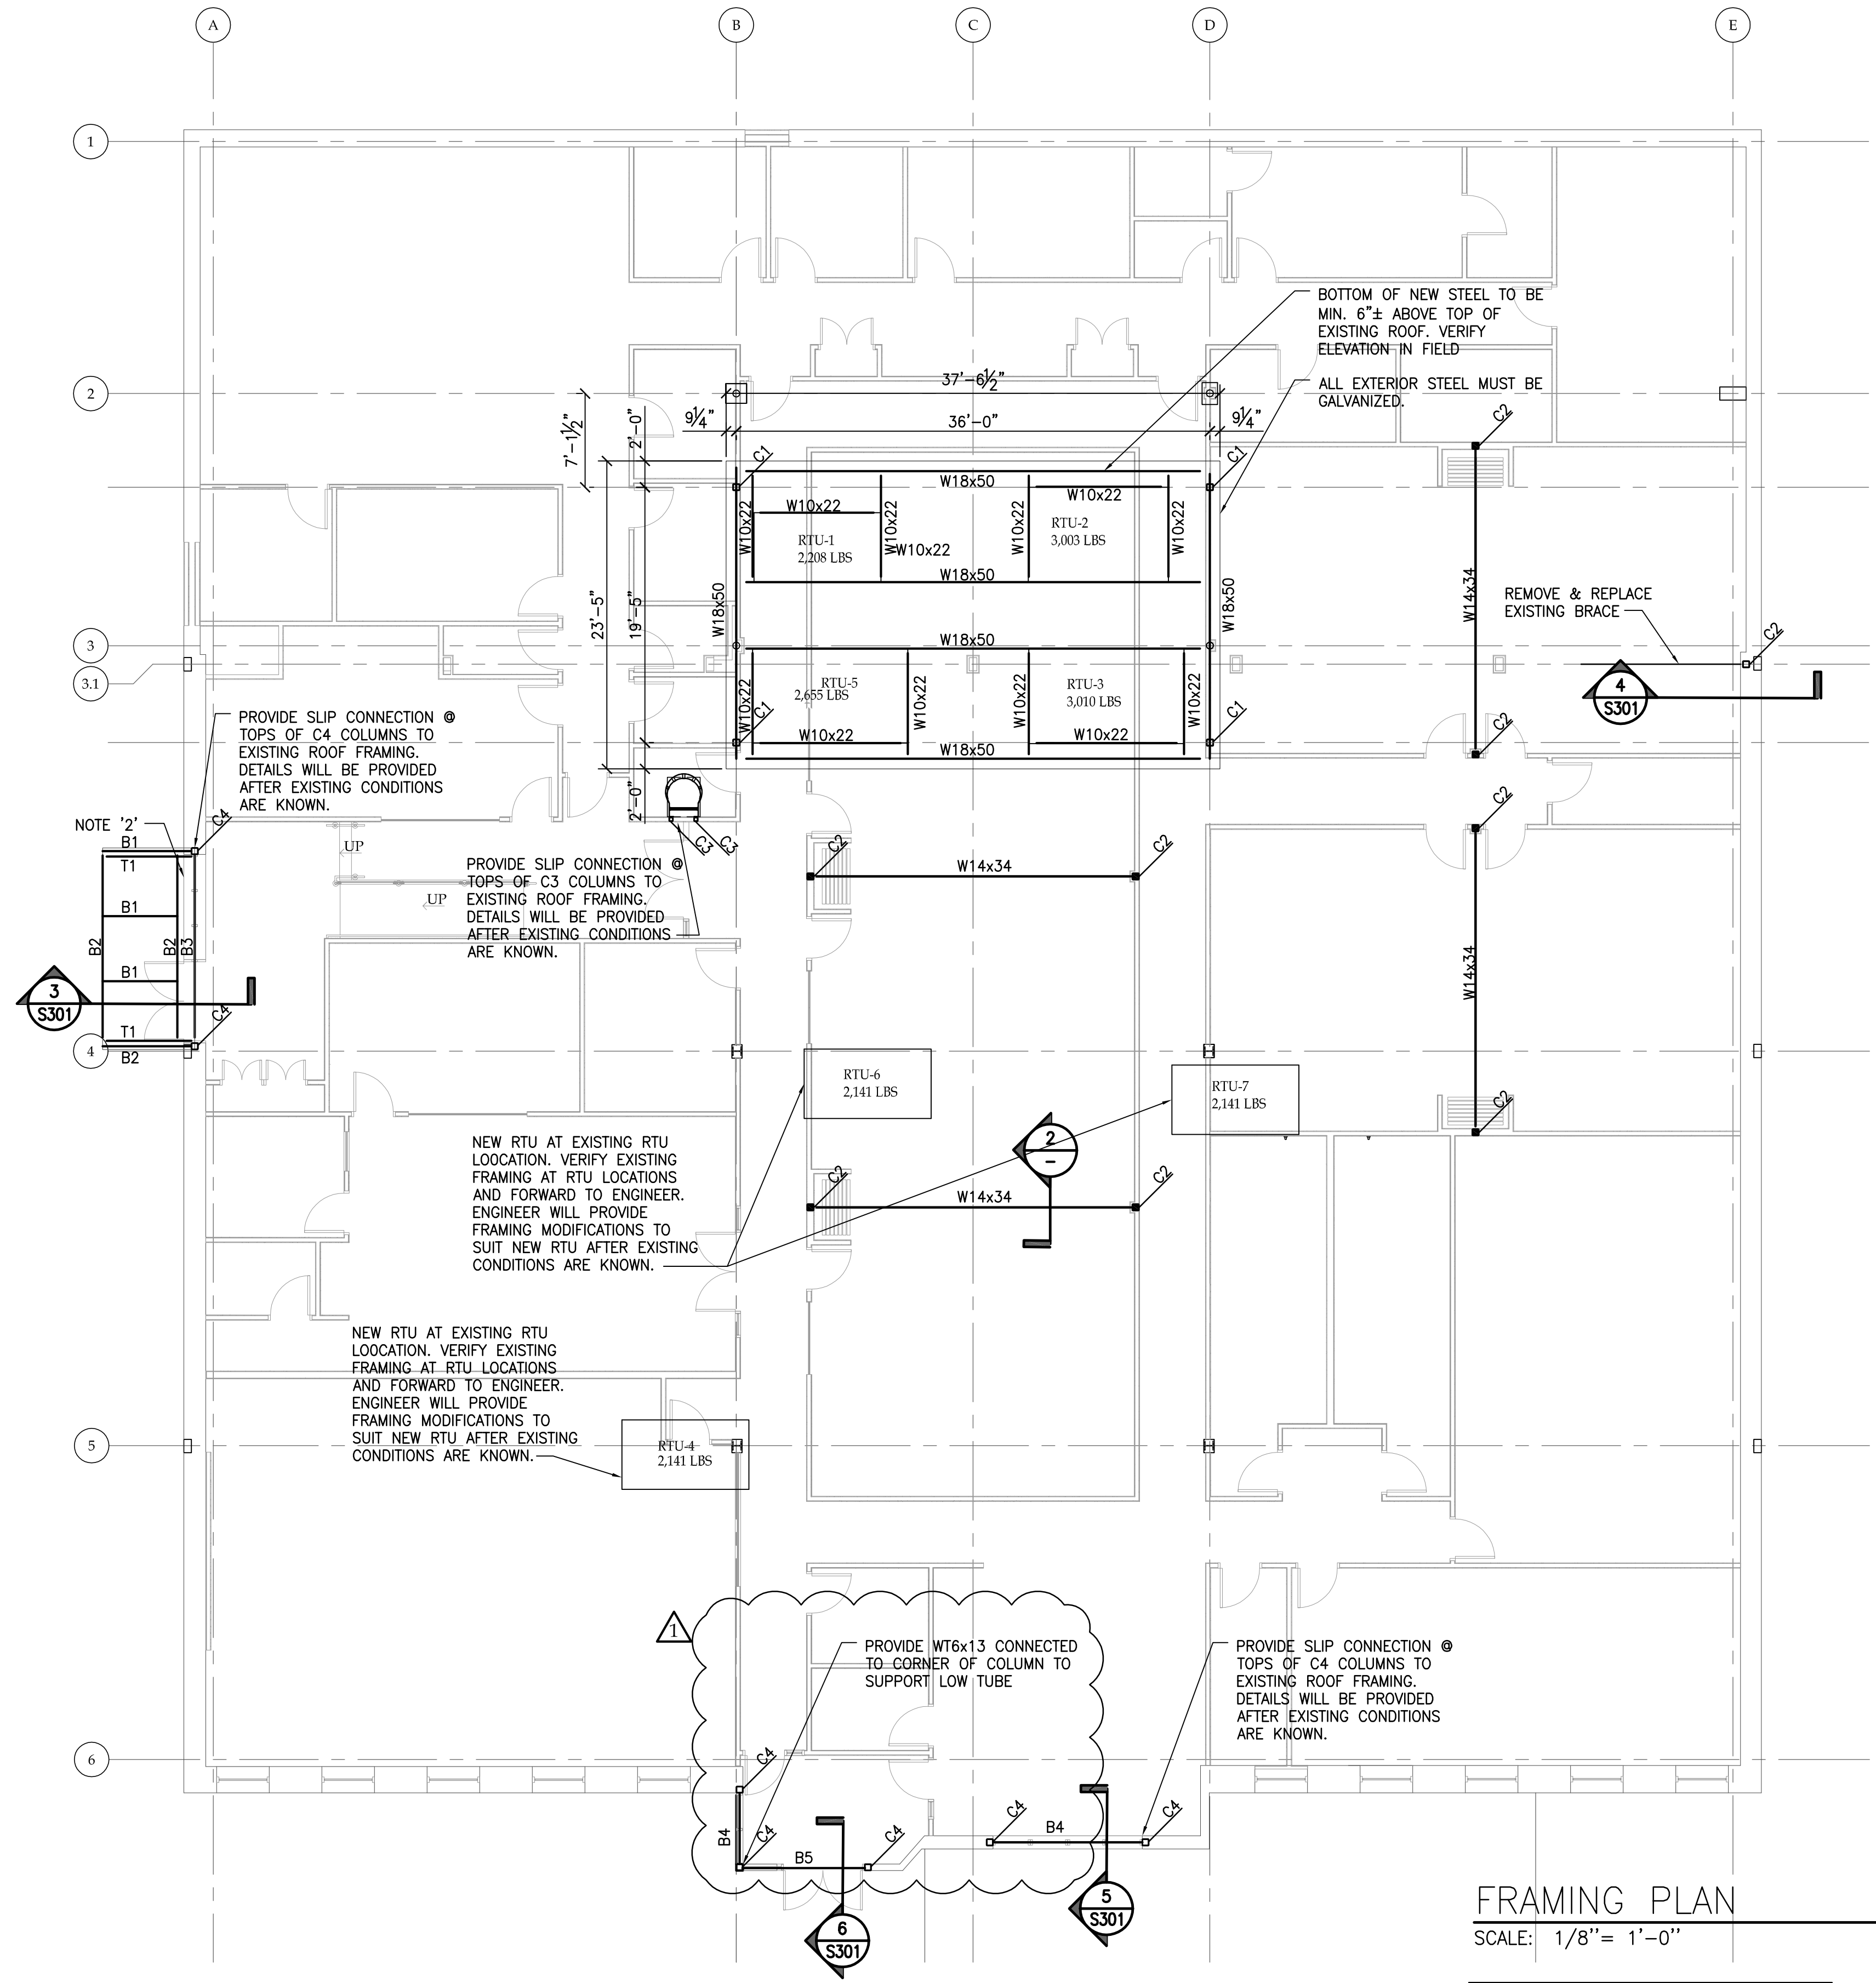
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SEAL:

**FRAMING PLAN**

**GREGORY A. TOMSIC**  
REGISTERED ARCHITECT  
145 BATHURST DR., TONAWANDA, N.Y. 14150  
716-433-0617

|                    |                          |
|--------------------|--------------------------|
| SCALE<br>AS NOTED  | JOB NO.                  |
| DRAWN<br>MLK       | DWG. NO.<br><b>S-201</b> |
| CHECKED<br>LGT/MG  | CONTRACT NO.             |
| DATE<br>12.22.2017 |                          |



PROVIDE SLIP CONNECTION @ TOPS OF C4 COLUMNS TO EXISTING ROOF FRAMING. DETAILS WILL BE PROVIDED AFTER EXISTING CONDITIONS ARE KNOWN.

PROVIDE SLIP CONNECTION @ TOPS OF C3 COLUMNS TO EXISTING ROOF FRAMING. DETAILS WILL BE PROVIDED AFTER EXISTING CONDITIONS ARE KNOWN.

NEW RTU AT EXISTING RTU LOCATION. VERIFY EXISTING FRAMING AT RTU LOCATIONS AND FORWARD TO ENGINEER. ENGINEER WILL PROVIDE FRAMING MODIFICATIONS TO SUIT NEW RTU AFTER EXISTING CONDITIONS ARE KNOWN.

NEW RTU AT EXISTING RTU LOCATION. VERIFY EXISTING FRAMING AT RTU LOCATIONS AND FORWARD TO ENGINEER. ENGINEER WILL PROVIDE FRAMING MODIFICATIONS TO SUIT NEW RTU AFTER EXISTING CONDITIONS ARE KNOWN.

PROVIDE W16x13 CONNECTED TO CORNER OF COLUMN TO SUPPORT LOW TUBE

PROVIDE SLIP CONNECTION @ TOPS OF C4 COLUMNS TO EXISTING ROOF FRAMING. DETAILS WILL BE PROVIDED AFTER EXISTING CONDITIONS ARE KNOWN.

BOTTOM OF NEW STEEL TO BE MIN. 6"± ABOVE TOP OF EXISTING ROOF. VERIFY ELEVATION IN FIELD

ALL EXTERIOR STEEL MUST BE GALVANIZED.

REMOVE & REPLACE EXISTING BRACE



| REVISION RECORD |        |            |
|-----------------|--------|------------|
| NO.             | DATE   | REMARKS    |
| 1               | 1/3/18 | Addendum 1 |

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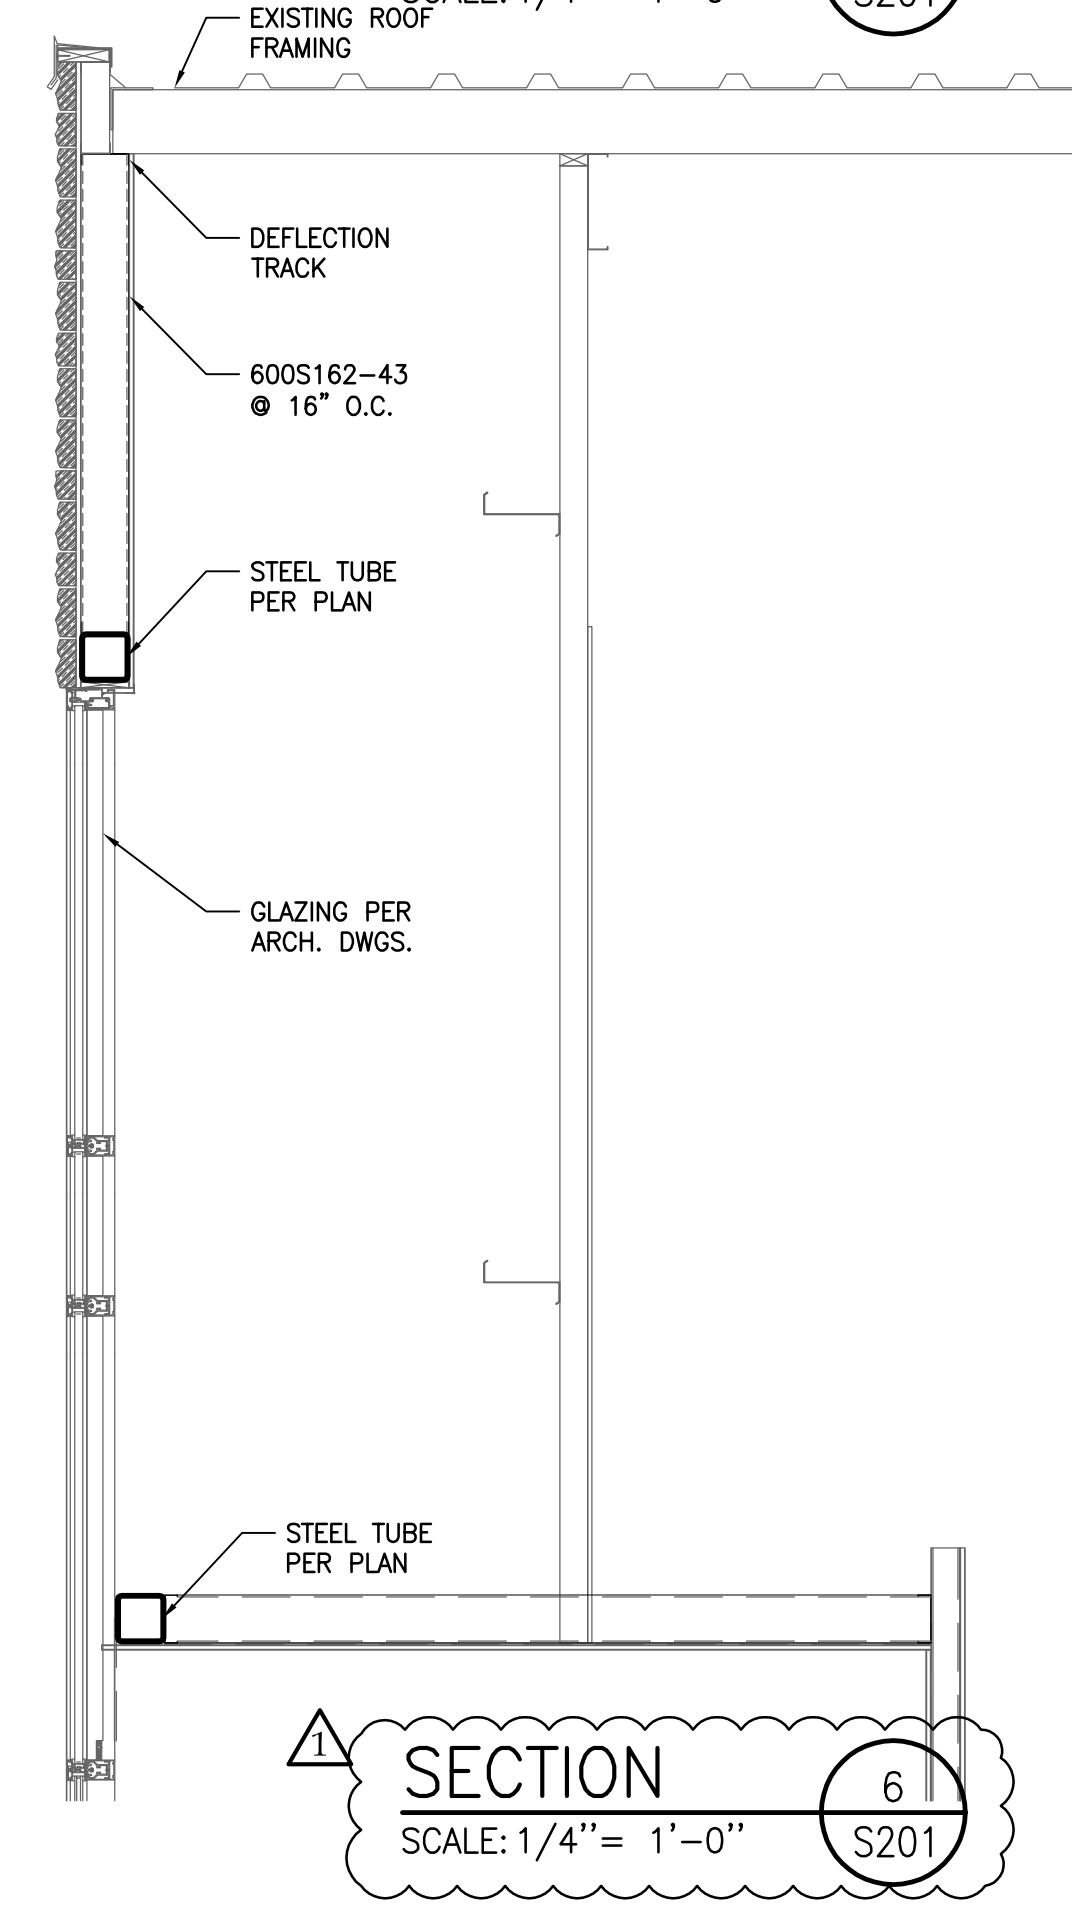
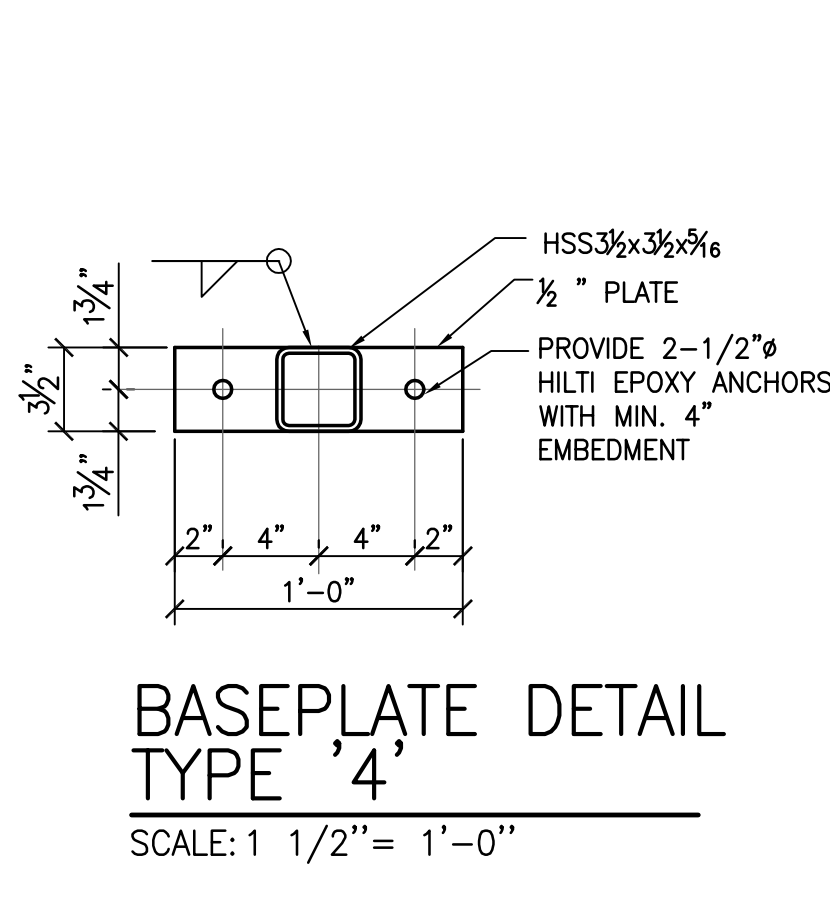
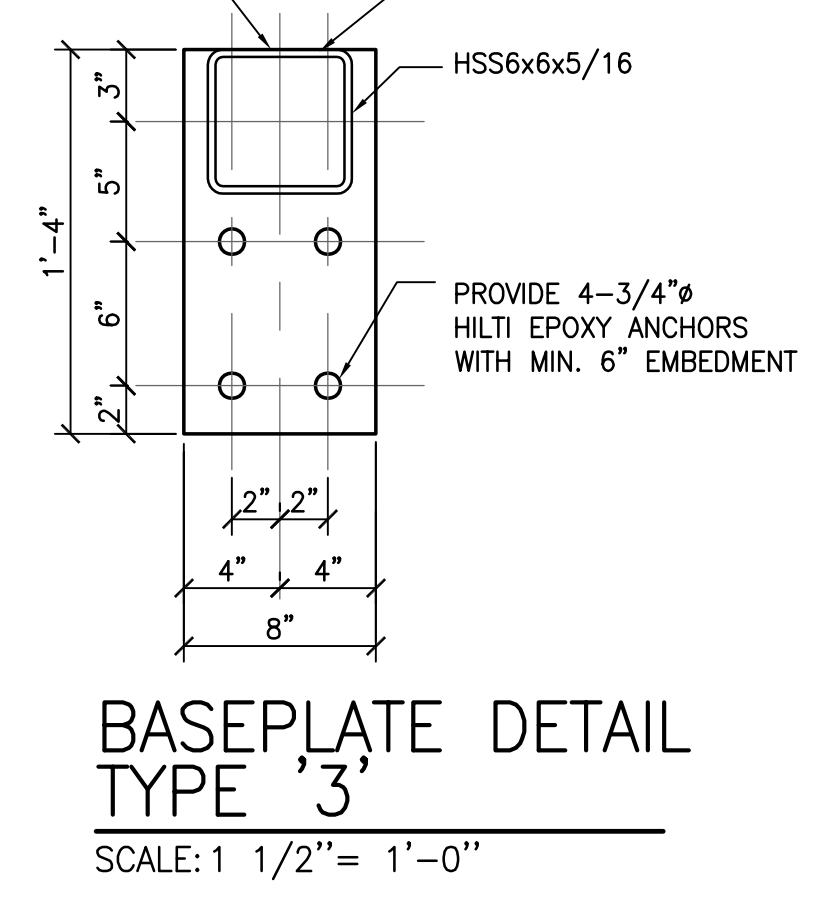
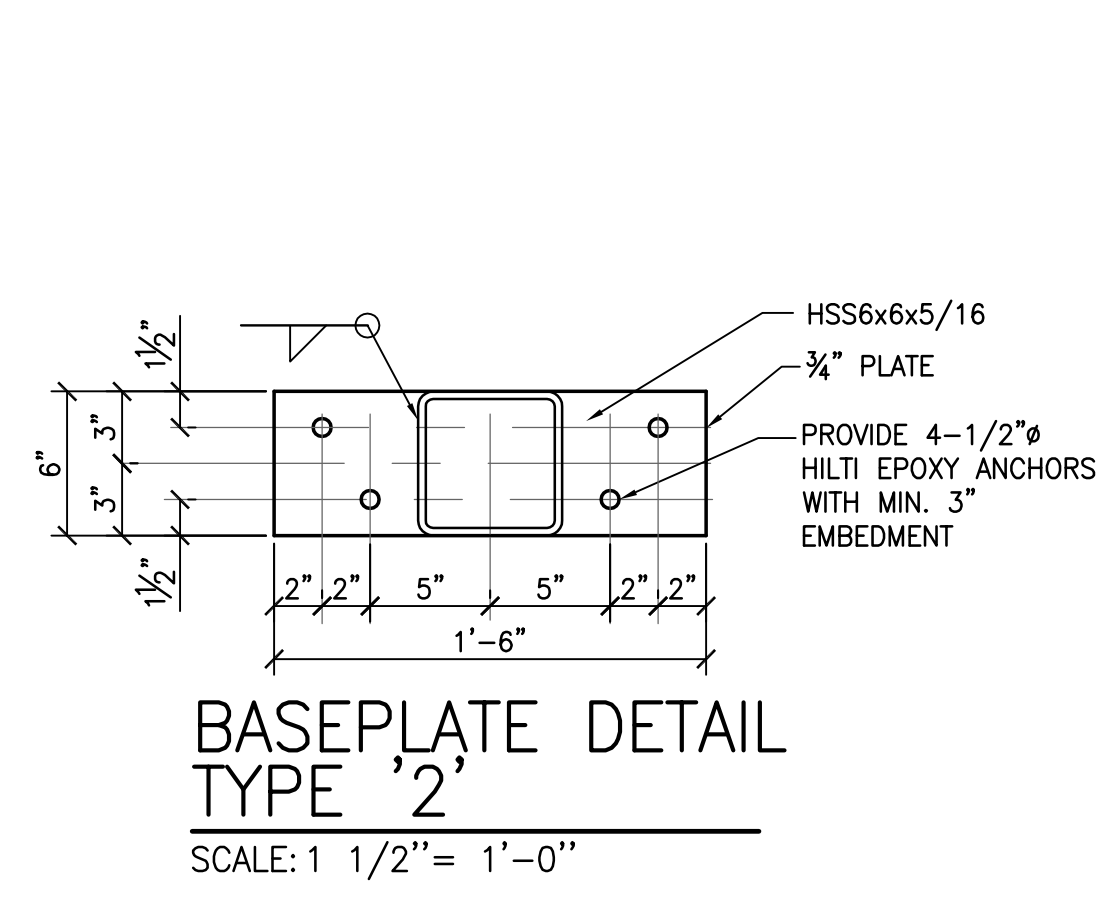
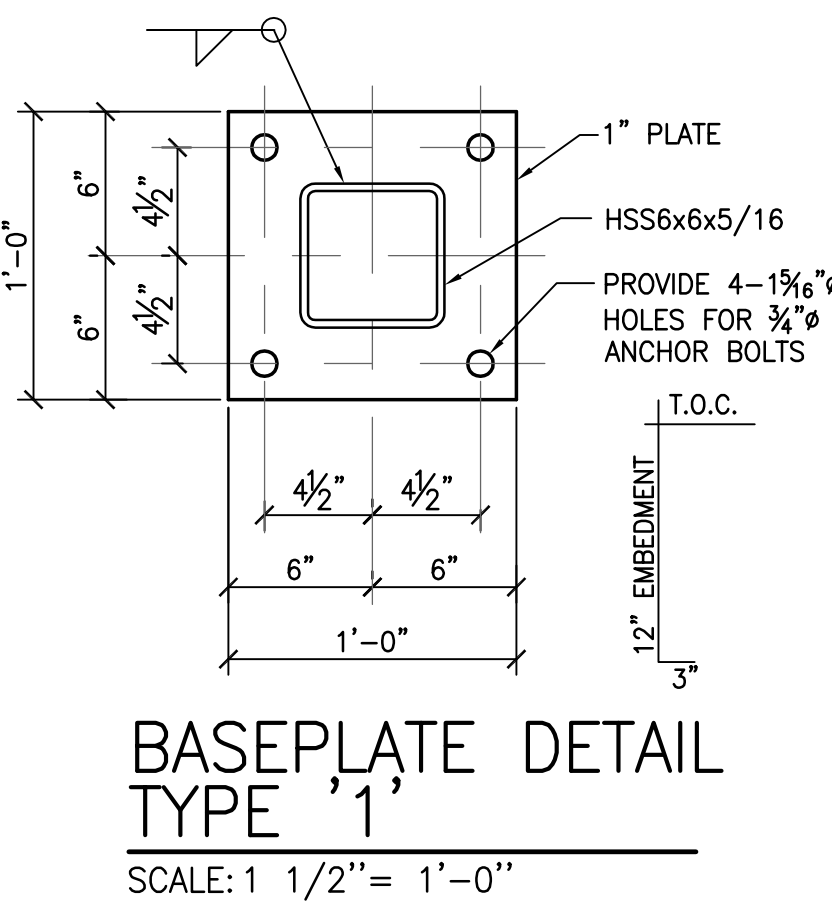
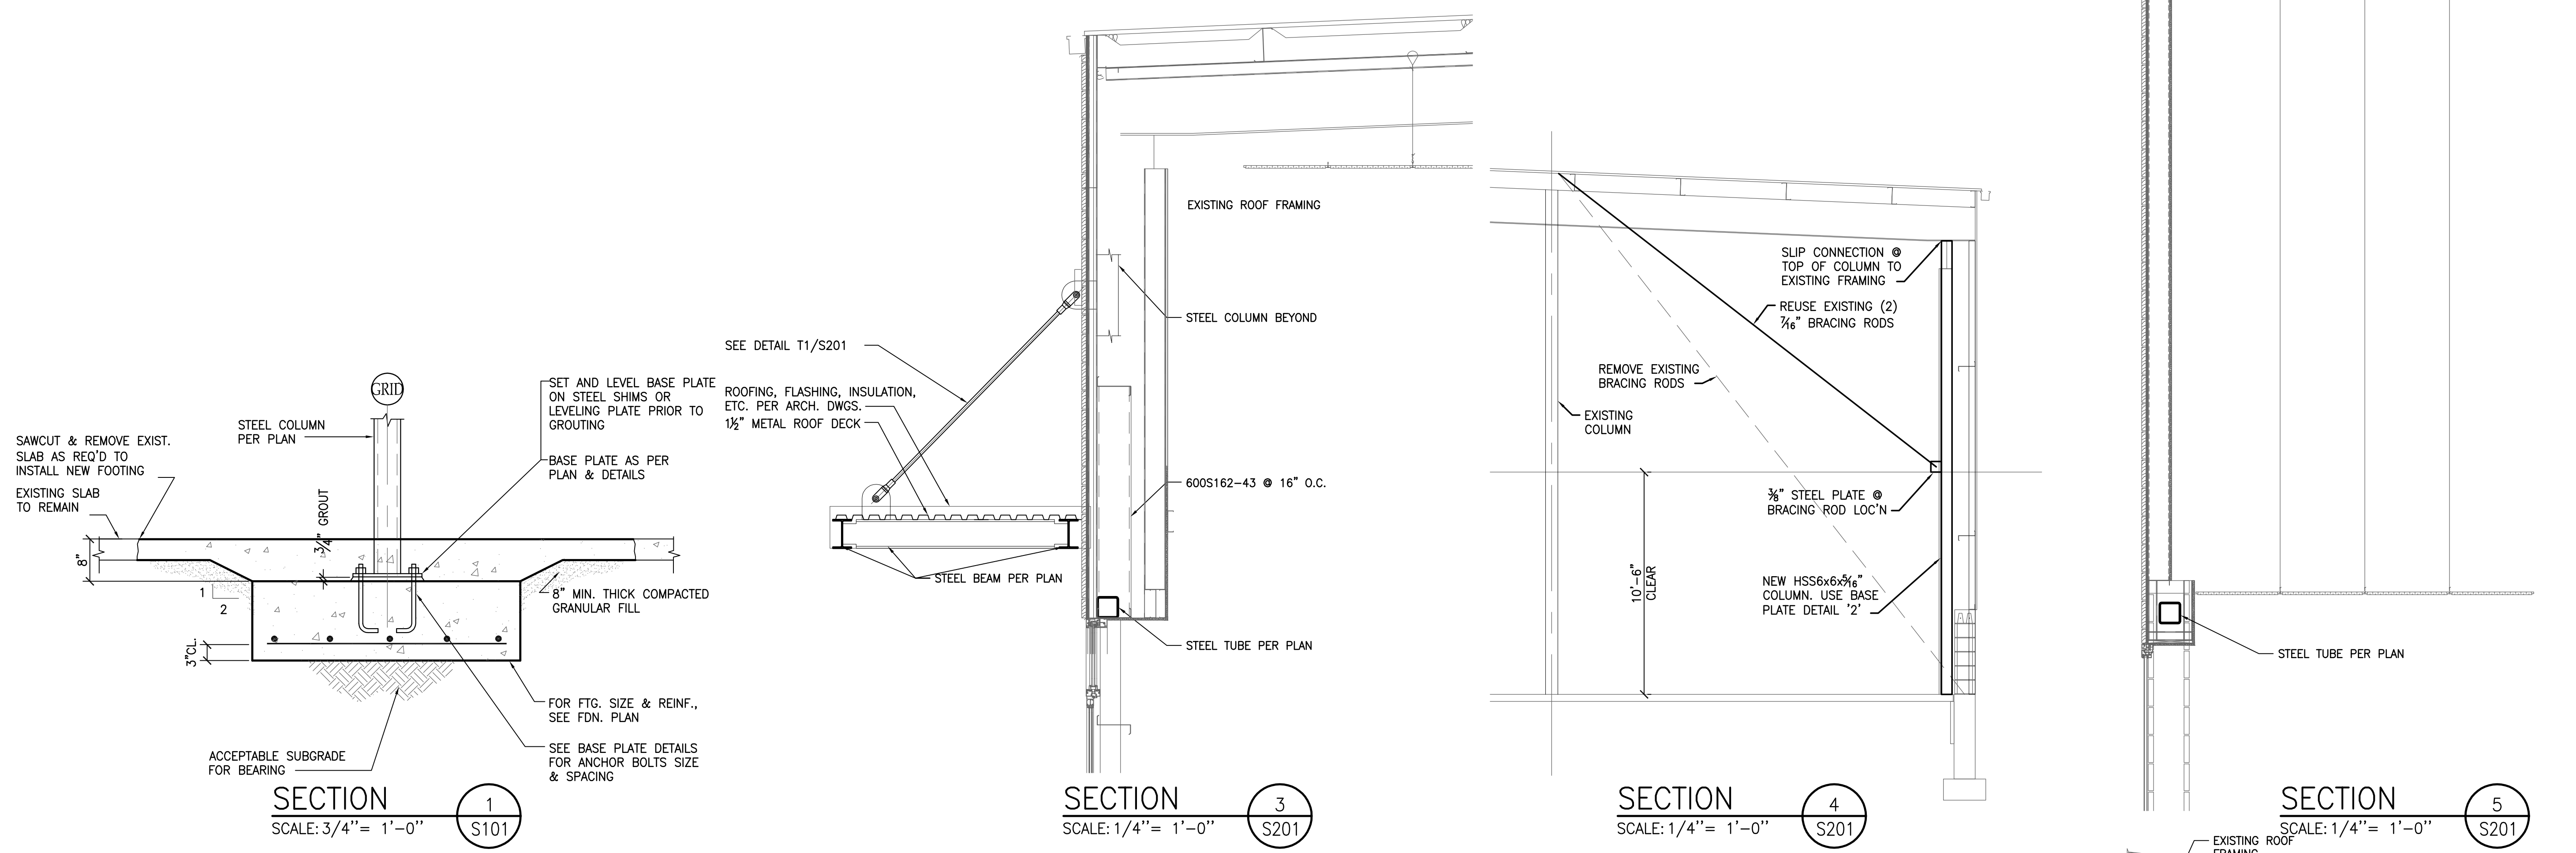
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SEAL:

**FOUNDATION SECTIONS**

**GREGORY A. TOMSIC**  
 REGISTERED ARCHITECT  
 145 BATHURST DR., TONAWANDA, N.Y. 14150  
 716-433-0617

|                    |                          |
|--------------------|--------------------------|
| SCALE<br>AS NOTED  | JOB NO.                  |
| DRAWN<br>MLK       | DWG. NO.<br><b>S-301</b> |
| CHECKED<br>LGT/MG  | CONTRACT NO.             |
| DATE<br>12.22.2017 |                          |







4.2 SPACE ALLOWANCES AND REACH RANGES

SECTIONS 4.2.1 - WHEELCHAIR PASSAGE WIDTH

- A. The minimum clear width for single wheelchair passage shall be 32" at a point and 36" continuously

SECTION 4.2.2 - WIDTH FOR WHEELCHAIR PASSING

- A. The minimum clear width for two wheelchairs to pass is 60"

SECTION 4.2.4.1 - SIZE AND APPROACH

- A. Minimum clear floor space for a wheelchair and occupant shall be 30" wide x 48" long. Clear floor space shall be centered on the element it serves.

4.3 ACCESSIBLE ROUTE

SECTION 4.3.2 - LOCATION

- A. At least one accessible route shall be provided from public transportation stops, accessible parking and loading zones, and public streets or sidewalks to the accessible building entrance.

SECTIONS 4.3.3 - WIDTH

- A. The minimum clear width of an accessible route shall be 36" except at doors.

SECTION 4.3.4 - PASSING SPACE

- A. If an accessible route is less than 60" in width, then passing spaces of at least 60" x 60" shall be provided at 200' max. spacing.

SECTION 4.3.5 - HEAD ROOM

- A. Accessible routes shall have 80" min. clear head room.


SECTIONS 4.3.7 - SLOPE

- A. Running slope shall not exceed 1:20. (If slope exceeds 1:20, refer to section 4.8)
B. Cross slope shall not exceed 1:50

4.4 PROTRUDING OBJECTS (REFERENCE DETAIL 4.4.1 & 4.4.2)

SECTIONS 4.4.1 - GENERAL

- A. Objects projecting from walls (for example, telephones) with their leading edges between 27"-80" above the finished floor shall protrude no more than 4" into walks, halls, corridors, passageways, or aisles. Objects mounted with their leading edges at or below 27" above the finished floor may protrude any amount. Free-standing objects mounted on posts or pylons may overhang 12" maximum from 27"-80" above the ground or finished floor. Protruding objects shall not reduce the clear width of an accessible route or maneuvering space.

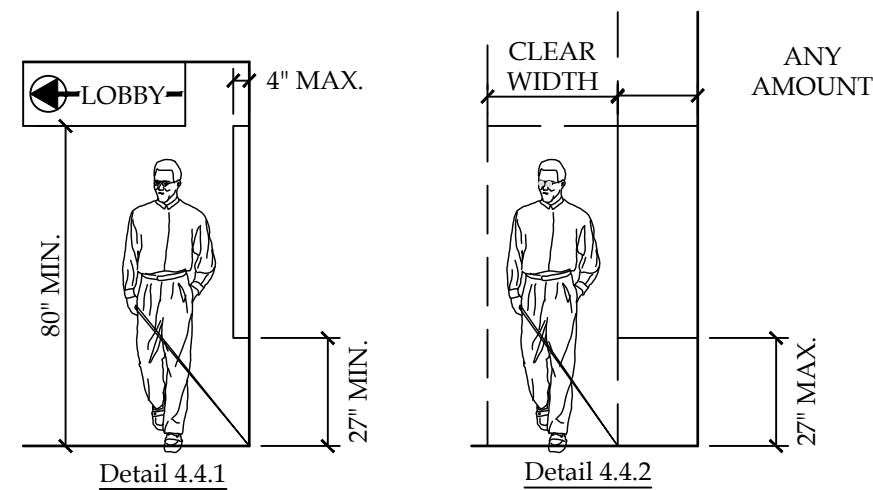

SECTIONS 4.6.5 - VERTICAL CLEARANCE

- A. Provide minimum vertical clearance of 114" at accessible passenger loading zones and along at least one vehicle access route from site entrances and exits.

SECTION 4.6.6 - PASSENGER LOADING ZONE

- A. Passenger loading zones shall provide an access aisle at least 60" wide and 20 ft long adjacent and parallel to the vehicle pull-up space. If there are curbs between the access aisle and the vehicle pull-up space, then a curb ramp complying with 4.7 shall be provided. Vehicle standing spaces and access aisles shall be level with surface slopes not exceeding 1:50 in all directions.

4.7 CURB RAMP

SECTIONS 4.7.2 - SLOPE (REFERENCE DETAIL 4.7)


- A. Slopes of curb ramps shall comply with 4.8.2.
B. Maximum slopes of adjoining gutters, road surface immediately adjacent to the curb ramp, or accessible route shall not exceed 1:20.

SECTIONS 4.7.3 - WIDTH (REFERENCE DETAIL 4.7)

- A. The minimum width of a curb ramp shall be 36", exclusive of flared sides.

SECTION 4.7.5 - SIDES OF CURB RAMP (REFERENCE DETAIL 4.7)

- A. If a curb ramp is located where pedestrians must walk across the ramp or where it is not protected by handrails or guardrails, it shall have flared sides; the maximum slope of the flare shall be 1:10

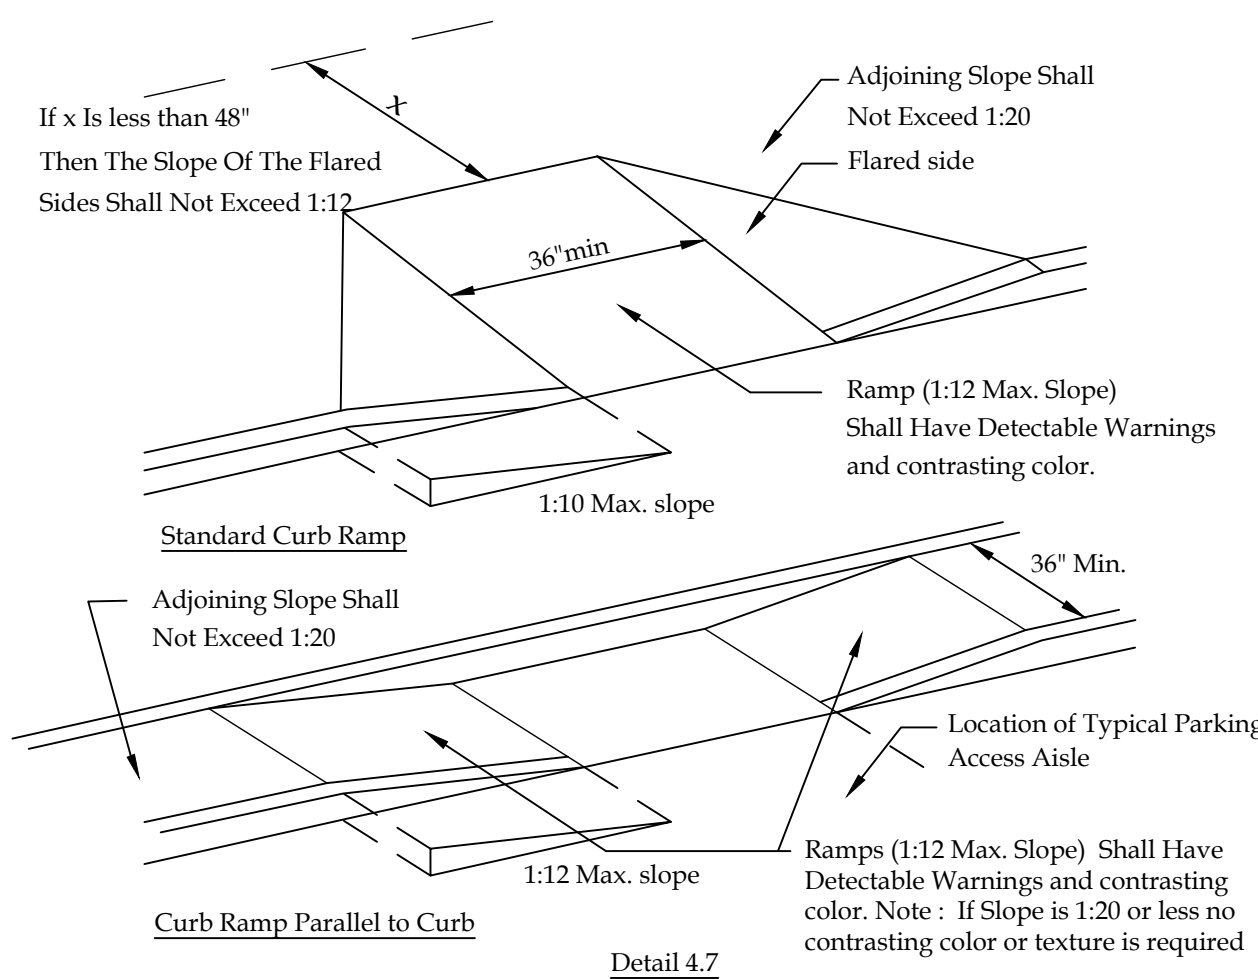

SECTIONS 4.7.10 - DIAGONAL CURB RAMP

- A. If diagonal curb ramps have returned curbs or other well-defined edges, such edges shall be parallel to the direction of pedestrian flow. The bottom of diagonal curb ramps shall have 48" minimum clear space. If diagonal curb ramps are provided at marked crossings, the 48" clear space shall be within the markings. If diagonal curb ramps have flared sides, they shall also have at least a 24" long segment of straight curb located on each side of the curb ramp and within the marked crossing.

SECTIONS 4.7.11 - ISLANDS

- A. Any raised islands in crossings shall be cut through level with the street or curb ramps at both sides and a level area at least 48" long between the curb ramps in the part of the island intersected by the crossings.

4.8 RAMPS

SECTIONS 4.8.1 - GENERAL

- A. Any part of an accessible route with a slope greater than 1:20 shall be considered a ramp and shall comply with 4.8.

SECTIONS 4.8.2 - SLOPE AND RISE

- A. The least possible slope shall be used for any ramp. The maximum slope of a ramp in new construction shall be 1:12. The maximum rise for any run shall be 30".

SECTIONS 4.8.3 - CLEAR WIDTH

- A. The minimum clear width of a ramp 30 ft or less in length shall be 36". Ramps more than 30 ft. in length shall have a minimum clear width of 44".

SECTION 4.8.4 - LANDINGS

- A. Level landings required at top and bottom of each run, with the following features:
1. Minimum Width: Equal to width of ramp
2. Length: Minimum 60" clear
3. At change of direction landing shall be 60" x 60" min.

SECTION 4.8.5 - HANDRAILS

- A. Handrails are required at all ramps with > 6" rise.
B. Height: 34"-38" above ramp surface.
C. The clear space between the handrail and the wall shall be 1-1/2".

SECTIONS 4.8.1 - EDGE PROTECTION

- A. Ramps and landings with drop offs shall have curbs, walls, railings, or projecting surfaces that prevent slipping off the ramp. Curbs shall be a minimum of 2" high.

4.9 STAIRS

SECTION 4.9.2 - TREADS AND RISERS

- A. All steps on a flight of stairs shall have uniform risers heights and tread widths
1. Minimum tread depth shall be 11", measured from riser to riser (not including nosing)
2. Open risers are not permitted

SECTIONS 4.9.4 - HANDRAILS

- A. Non-continuous handrails shall extended 12" beyond the top riser and 12" plus the width of one tread beyond the bottom riser. At the top, the extension shall be parallel to the floor. At the bottom, the handrail shall continue to slope for a distance of one tread width (11"); the remaining extension shall be horizontal.
B. Height: 34" - 38", measured from the stair nosing.

4.10 ELEVATORS

SECTIONS 4.10.3 - HALL CALL BUTTONS

- A. Shall be centered 42" above floor

SECTIONS 4.10.3 - HALL LANTERNS

- A. Visible signals shall have the following features:
1. Fixtures shall be mounted with centerline at least 72" above the lobby floor
2. Visual elements shall be at least 2-1/2" in the smallest dimension

SECTIONS 4.10.5 - RAISED AND BRAILLE CHARACTERS ON HOISTWAY ENTRANCES

- A. All elevator hoistway entrances shall have raised and Braille floor no. designations provided on both jambs. Centerline of the characters shall be 60" above the floor. Characters shall be 2" high.

SECTIONS 4.10.6 - DOOR PROTECTIVE AND REOPENING DEVICE

- A. Elevator doors shall open and close automatically. They shall be provided with a reopening device that will stop and reopen a car door and hoistway door automatically if the door becomes obstructed by an object or person.

SECTIONS 4.10.12 - CAR CONTROLS

- A. All floor buttons shall be:
1. All control buttons shall be at least 3/4" in their smallest dim. They shall be flushed or raised.
2. All control buttons shall be designated by Braille and be raised standard alphabet characters for letters, Arabic numerals for numerals. The call button for the main entry floor shall be designated by a raised star at the left of a floor designation.
3. Maximum 54" above floor where side approach is provided
4. Maximum 48" where forward approach is provided
B. Emergency Controls:
1. Shall have centerlines 35" minimum above floor
2. Shall be grouped at bottom of panel
C. The emergency communication system shall not require voice communication.

4.11 PLATFORM LIFTS

NOTE: REQUIRES A VARIANCE FROM THE T.D.L.R. TO USE IN LIEU OF AN ELEVATOR

SECTIONS 4.11.2, 4.27.3 - OTHER REQUIREMENTS CONTROLS AND OPERATING SYSTEMS

- A. Height permitted: Controls and operating mechanisms shall be located for either a forward or side approach from any direction of travel. They shall be located 28" min. and 48" maximum above the floor. They shall be operable with one hand. There shall be at least one handrail complying with 4.26. Wheelstops and guardrails shall be provided where necessary.

4.13 DOORS

SECTION 4.13.4 - DOUBLE - LEAF DOORWAYS

- A. Doorways with two independently operated leaves shall have at least one active leaf that meets the requirements in 4.13.5 and 4.13.6.

SECTION 4.13.5 - CLEAR WIDTH

- A. Doorways shall provide a clear opening of 32" minimum, with the door open 90°.
1. Clear opening shall be measured between the face of the door and opposite stop.
2. Openings more than 24" in depth shall provide a clear opening of 36" minimum.

Exception: Doors not requiring full user passage, such as shallow closets, shall have a clear opening of 20" minimum.

SECTION 4.13.6 - MANEUVERING CLEARANCES AT DOORS

Provide level (1:50 max. slope) and clear maneuvering area at doors as follows:

- A. Front approach pull side - 60" min. width & 18" min. beside strike edge
Front approach push side - 48" min. width & 0" beside strike edge (12" @ strike if door has both a closer and a latch)
B. Hinge side approach pull side - 60" min. width; 36" min. beside strike edge or 54" min. width; 42" min. beside strike edge
Hinge side approach push side - 42" min. width & 18" min. beside hinge edge (48" min. width if door has both a closer and a latch)
C. Latch side approach pull side - 48" min. width and 24" min. beside strike edge (54" min. width if door has a closer)
Latch side approach push side - 42" min. width and 24" min. beside strike edge (48" min. width if door has a closer)

SECTION 4.13.8 - THRESHOLDS AT DOORWAYS

- A. Maximum threshold height: 1/2" (3/4" at exterior sliding doors). Raised thresholds and floor level changes shall be beveled with a slope no greater than 1:2.

SECTION 4.13.9 - DOOR HARDWARE

- A. Handles, pulls, latches, locks, and other operating devices shall have a shape that is easy to grasp with one hand and does not require tight grasping, tight pinching, or twisting of the wrist to operate.
1. Lever-operated mechanisms, push-type mechanisms, and U-shaped handles are acceptable designs.
2. When sliding doors are fully open, operating hardware shall be exposed and usable from both sides.
3. Hardware required for accessible door passage shall be mounted no higher than 48" above finished floor.

SECTION 4.13.10 - DOOR CLOSERS

- A. If a door has a closer, then the sweep period of the closer shall be adjusted so that from an open position of 70°, the door will take at least 3 seconds to move to a point 3" from the latch, measured to the leading edge of the door.

SECTION 4.13.11 - DOOR OPENING FORCE

- A. The maximum force for pushing or pulling open a door shall be as follows:
1. Fire doors shall have a minimum opening force allowable by the appropriate administrative authority.
2. Other doors
a. Exterior hinged doors: no requirement.
b. Interior hinged doors: 5.0 lbf.
c. Sliding or folding doors: 5.0 lbf.
These forces do not apply to the force required to retract latch bolts or disengage other devices that may hold the door in a closed position.

4.15 DRINKING FOUNTAINS

SECTION 4.15.2 - SPOUT HEIGHT (REFERENCE DETAIL 4.15 for accessible unit)

- A. Accessible spouts shall be no higher than 36", measured from the floor or ground surface to the spout outlet.
B. In addition to accessible unit, at least one drinking fountain shall be at standard height (may be "high/low" type if located in one location).

SECTION 4.15.3 - SPOUT LOCATION


- A. Spouts shall be located at the front of the unit and shall direct the water flow in a trajectory that is parallel or nearly parallel to the front of the unit.
1. The spout shall provide a flow of water at least 4" high.
2. If the fountain has a round or oval bowl, the spout must be positioned so the flow of water is within 3" of the front edge of the fountain.

SECTION 4.15.4 - CONTROLS

- A. Unit controls shall be front mounted or side mounted near the front edge.

SECTION 4.15.5 - CLEARANCES (REFERENCE DETAIL 4.15)


- A. Wall and post mounted cantilever fountains shall have clear knee space as follows:
1. Minimum 27" high (from apron bottom to floor) minimum 30" wide, and 17" - 19" deep.
2. A minimum 30" by 48" clear floor space allowing a forward approach to the unit shall be provided.
B. Free standing or built-in units having a clear knee space shall have a minimum 30" by 48" clear floor space allowing a parallel approach to the unit.

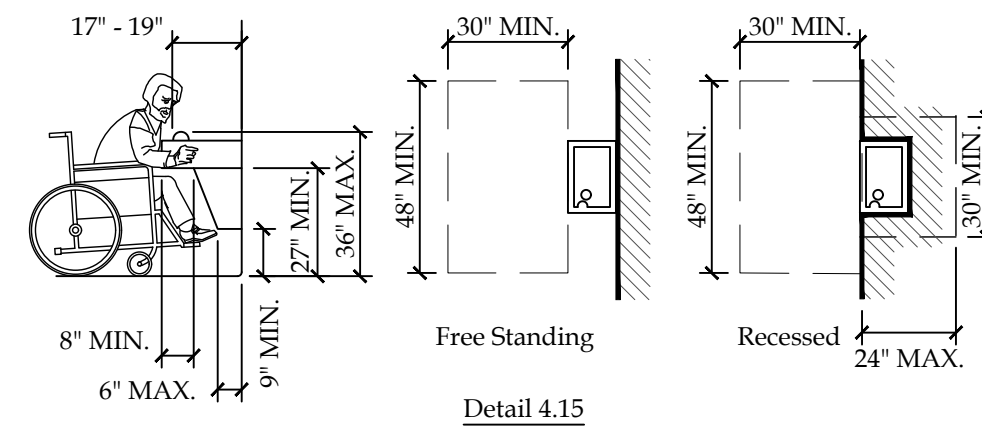

4.16 WATER CLOSETS


SECTION 4.16.2 - CLEAR FLOOR SPACE

- A. Clear floor space for water closets not in stalls shall be provided as follows:
Front approach - 48" min. wide x 66" min. long
Side approach - 56" min. to front of toilet x 48" min. wide
Both approach - 60" min. wide x 56" min. long (Reference Detail 4.16)
B. No door swings are allowed in clear floor area.

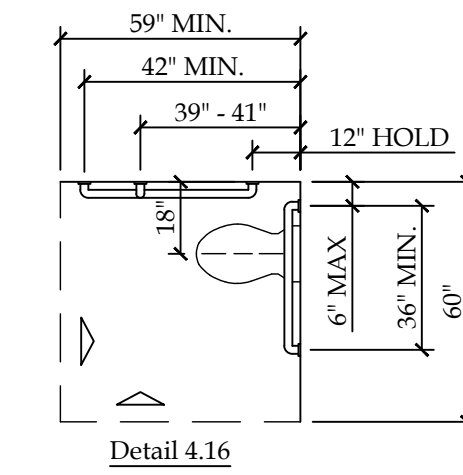

SECTION 4.16.6 - DISPENSERS (REFERENCE DETAIL 4.16.2)

- A. Toilet paper dispensers shall be installed on the side wall, a minimum 19" above the floor, and a maximum 36" from the rear wall.
1. Dispensers that control delivery or do not permit continuous paper flow shall not be used.

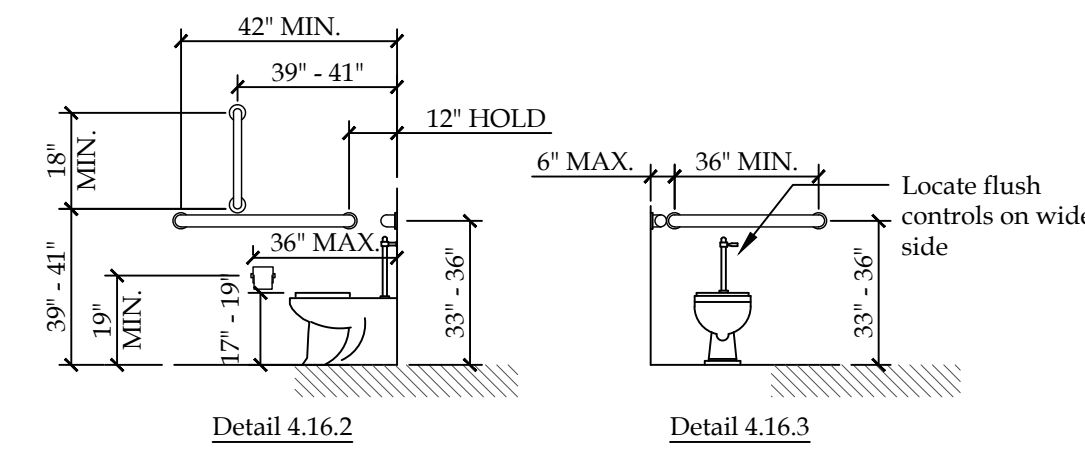


4.17 TOILET STALLS

SECTION 4.22.4 - WHERE APPLICABLE

- A. If toilet stalls are provided in a toilet room or bathroom, then at least one shall be a "standard" accessible toilet stall (for wheelchair users) complying with this section. (REFERENCE DETAIL 4.17.1)
B. If 6 or more toilet stalls are provided in a toilet room or bathroom in addition to the "standard" accessible stall required; an additional "alternate A" accessible stall 36" wide (for ambulatory persons with disabilities) complying with this section shall be provided. (REFERENCE DETAIL 4.17.2)
C. Alternations/Existing Conditions: In alteration work, where provision of a "standard" accessible stall is technically infeasible, or where plumbing code requirements prevent combining existing stalls to provide space, either "alternate A" stall (A or B) complying with this section may be provided in lieu of the standard stall. (Note: requires a variance from T.D.L.R.)

SECTION 4.17.3 - SIZE AND ARRANGEMENT (REFERENCE DETAIL 4.17)

- A. Toilet stalls may be arranged to provide either a left or a right handed approach. Accessible toilet stalls shall have the following dimensions:
1. 'Standard' Accessible Stall
60" minimum width.
59" minimum depth, with floor mounted water closet
56" minimum depth, with wall mounted water closet
Door: outward swinging (if door swings into stall, depth shall be increased by 36". Stall door must have 18" on pull strike jamb)
2. 'Alternate A' Accessible Stall (required when more than 6 stalls)
36" width - hold this dim.
69" minimum depth, with floor mounted water closet.
66" minimum depth with wall mounted water closet
Door: outward swinging.
3. 'Alternate B' Accessible Stall (permitted in lieu of standard stall only with variance from T.D.L.R.)
48" minimum width.
54" minimum depth.
Door: outward swinging.

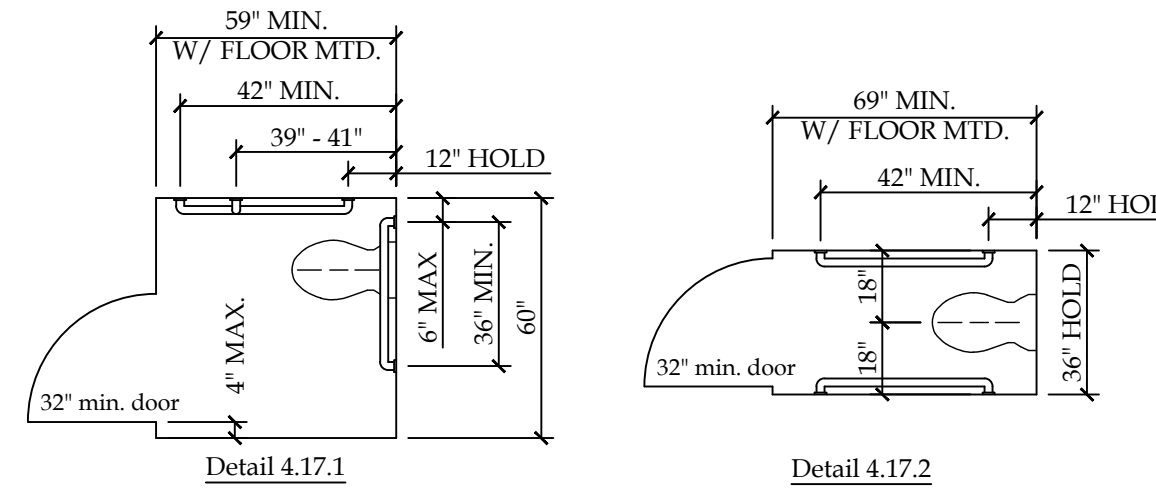

SECTION 4.17.4 - TOE CLEARANCES

- A. In "standard" accessible stalls, the front partition and at least one side partition shall provide a toe clearance of at least 9" above the floor.
B. If the depth of the stall is greater than 60", the toe clearance is not required.

SECTION 4.17.5 - DOORS

- A. Toilet stall doors, including hardware, shall comply with 4.13 DOORS
B. If toilet stall approach is from the latch side of the stall door, clearance between the door side of the stall and any obstruction shall be 42" minimum. (This is an exception from the typical door maneuvering clearances)

SECTION 4.17.6 - GRAB BARS (REFERENCE DETAILS 4.16.2, 4.16.3, 4.17.1 & 4.17.2)

- A. Grab Bars shall be mounted 33" - 36" above the floor.
B. A vertical grab bar 18" long minimum shall be mounted with the bottom of the bar located between 39" - 41" above the floor, and with the center line of the bar located between 39" - 41" from the rear wall.

Refer to 4.26 Grab Bars for size and structural requirements.

4.18 URINALS

SECTION 4.18.2 - HEIGHT (REFERENCE DETAIL 12.3.1)

- A. Urinals shall be stall-type or wallhung with a tapered, elongated rim at 17" maximum above the finished floor. The rim shall extend a minimum of 14" from the wall.

GENERAL NOTES: NOT ALL CODE DEFINITIONS LISTED ON THIS SHEET MAY BE IN PROJECT

REVISION RECORD table with columns for NO., DATE, and REMARKS.

IF IS A VIOLATION OF STATE LAW FOR ANY PERSON, UNLESS ACTING UNDER THE DIRECTION OF A NEW YORK STATE ARCHITECT OR ENGINEER, TO ALTER ANY ITEM ON THIS DOCUMENT IN ANY WAY, IF ANY ITEM ON THIS DOCUMENT IS ALTERED, THE ALTERING ARCHITECT OR ENGINEER SHALL AFFIX TO HIS ITEM HIS SEAL AND THE NOTATION "ALTERED BY" FOLLOWED BY HIS SIGNATURE, THE DATE OF SUCH ALTERATION, AND A SPECIFIC DESCRIPTION OF SUCH ALTERATION.



BRYANT & STRATTON COLLEGE
1320 Warwick Way
Mt. Pleasant, WI 53406

SEAL area for the architect.

ADA DETAILS & NOTES

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REGISTERED ARCHITECT
145 BATHURST DR., TONAWANDA, N.Y. 14150
716-455-4617

Table with SCALE (1/8" = 1'-0"), DRAWN, CHECKED, DATE (12.22.2017), JOB NO., DWG. NO. (A-001), and CONTRACT NO.




**SECTION 4.18.5 - CLEAR FLOOR SPACE (REFERENCE DETAIL 4.18.1)**


- A. A clear floor space 30" wide by 48" deep minimum shall be provided in front of urinal to allow forward approach.
- 1. This space shall adjoin or overlap an accessible route.
- 2. Urinal shield that do not extend beyond the front edge of the urinal rim may be provided with 29" clearance between them.
- 3. Urinals installed in alcoves deeper than 24" require a maneuvering area of at least 36" minimum wide, centered on fixture.

**SECTION 4.18.4 - FLUSH CONTROLS (REFERENCE DETAIL 4.18.2)**

- A. Controls shall be 44" maximum above the finished floor.
- 1. Controls shall be 44" maximum above the finished floor.
- 2. Controls shall be hand operated or automatic.
- 3. The force required to activate controls shall be no greater than 5 lbf.

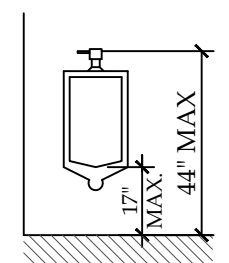

Detail 4.18.1

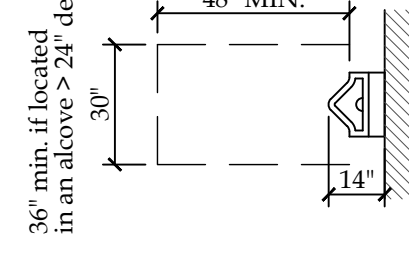


Detail 4.18.2


**4.19 LAVATORIES & MIRRORS**

**SECTION 4.19.2 - HEIGHT & CLEARANCES (REFERENCE DETAIL 4.19.1 & 4.19.2)**

- A. Lavatories shall be mounted with the rim or counter surface no higher than 34" above the finished floor.
- 1. Lavatories shall extend 17" minimum from the wall.
- 2. Clearance of 29" minimum shall be provided from the finished floor to bottom apron.
- 3. Knee clearance of 27" minimum shall extend 8" minimum under the edge of the lavatory.
- 4. Toe clearance of 9" minimum shall be provided for the full depth of the lavatory.

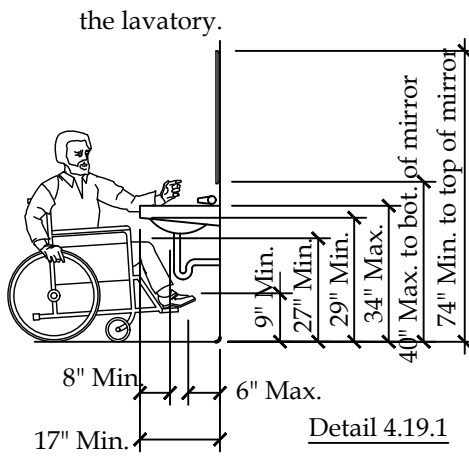

Detail 4.19.1

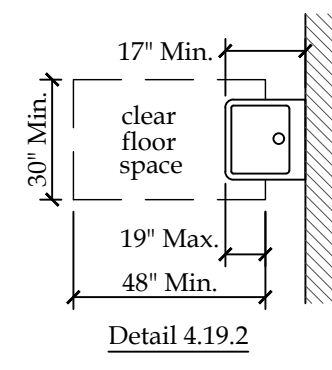

Detail 4.19.2

**SECTION 4.19.4 - EXPOSED PIPES AND SURFACES**

- A. Hot water and drain pipes under the lavatories shall be insulated or otherwise configured to protect against contact.
- B. There shall be no sharp or abrasive surfaces under lavatories.

**SECTION 4.19.5, 4.27.4 - FAUCETS**

- A. Controls shall be operable with one hand and shall not require tight grasping, pinching, or twisting of the wrist.
- B. The force required to activate controls shall be no greater than 5 lbf.
- C. Lever-operated, push-type, and electronically controlled mechanisms are examples of acceptable designs.
- D. If self-closing valves are used the faucet shall remain open for at least 10 seconds.

**SECTION 4.19.6 - MIRRORS (REFERENCE DETAIL 4.19.1)**

- A. Mirrors shall be mounted with the bottom edge of the reflecting surface 40" maximum above the finished floor.
- B. The top edge of the reflecting surface must be at least 74" AFF.

**4.20 BATHTUBS**

**SECTION 4.20.2 - FLOOR SPACE**

- A. Clear floor space shall be provided in front of bathtubs as follows: 30" wide x 60" long beside the bathtub for side approach 48" x 60" long beside the bathtub for front approach with seat at head of tub - 30" x 75" long beside tub

**SECTION 4.20.3 - SEAT**

- A. An in-tub seat or seat at the head of the tub shall be provided. Seats shall be mounted securely and shall not slip during use.

**SECTION 4.20.4 - GRAB BARS**

- A. Heights permitted:
  - With In Tub Seat: Foot control wall: 24" long minimum, from outside wall, 33-36" above floor Back wall: 2 bars, 24" long minimum, 12" maximum from foot wall, 24" maximum from head wall; one 33-36" above floor, one 9" above the tub Head wall: 12" minimum, from outside wall, 33-36" above floor
  - With Seat at Head of Tub: Control wall: 24" long minimum, from the outside wall, 33-36" above floor Back wall: 2 bars, 48" long minimum, 12" maximum from foot end, 15" maximum from head end; one 33-36" above floor, one 9" above the tub Head wall: none

**SECTION 4.20.5 - CONTROLS**

- A. Controls must be located up front to the open side of the tub

**SECTION 4.20.6 - SHOWER UNIT**

- A. A shower spray unit with a hose at least 60" long shall be provided that can be used both as fixed and hand held.

**4.21 SHOWER STALLS**

**SECTION 4.21.2 - SIZE AND CLEARANCES**

- A. Shower stalls shall be either 36"x36" clear inside dimension (hold) at transfer type or 30" min. x 60" min. clear inside dimension at roll in type.

**SECTIONS 4.21.3 - SEAT**

- A. Seat is required in 36" x 36" stalls, and shall have the following features:
  - Shall be 17"-19" above bathroom floor
  - Shall extend the full depth of the stall
  - Shall be located on the wall opposite control wall
  - Maximum space between wall and seat edge shall be 1-1/2"
  - Shall project 16" maximum into stall width, except at the rear 15" maximum of the stall, where the seat may project 23"
  - Where a seat is provided in a roll in type shower it must be the fold-up type.

**SECTIONS 4.21.4 - GRAB BARS**

- A. Grab bars shall be mounted 33-36" above floor
- B. Vertical grab 18" min. in length shall be provided on the control end wall 3" - 6" above the horizontal grab bar, and 4" maximum inward from the front edge of the shower.

**SECTION 4.21.5 - CONTROLS**



- A. All shower controls shall be located 38" minimum and 48" maximum above the floor, up front on the open side.

**SECTION 4.21.6 - SHOWER UNIT**

- A. A shower spray unit with a hose at least 60" long that can be used both as a fixed shower head and as a hand held shower shall be provided. The mounting device shall comply with the requirements for Forward Reach.

**SECTIONS 4.21.7 - CURBS**

- A. If provided, curbs on transfer showers shall be no higher than 1/2" roll-in showers shall not have curbs

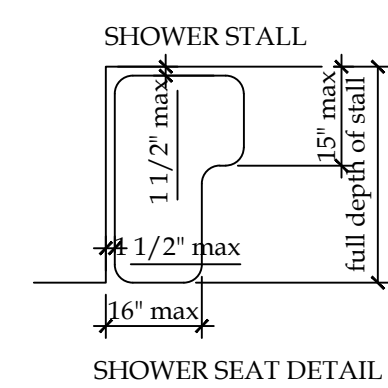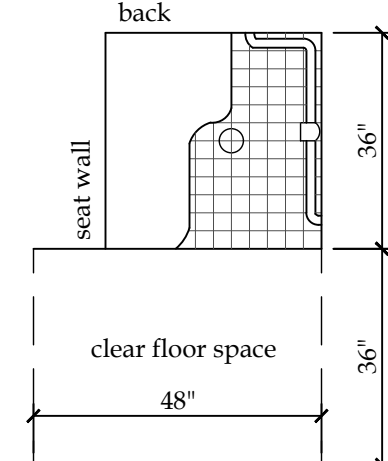

SHOWER SEAT DETAIL

**4.22 TOILET ROOMS**

**SECTION 4.22.2 - DOORS**

- A. All doors to accessible toilet rooms shall comply with 4.13. Doors shall not swing into clear floor space required for any fixture. Clear floor turning space may overlap door swings.

**SECTION 4.22.3 - CLEAR FLOOR SPACE**

- A. The accessible fixtures and controls required in 4.22.4, 4.22.5, 4.22.6, 4.22.7 shall be on an accessible route. An unobstructed turning space complying with 4.2.3 shall be provided within an accessible toilet room. The clear floor space at fixtures and controls, the accessible route, and the turning space may overlap, however, the only turning space provided shall not be located within a stall.

**SECTIONS 4.22.2 - WATER CLOSETS**

- A. If toilet stalls are provided, then at least one shall be a standard toilet stall complying with 4.17; where 6 or more stalls are provided in addition to the stall complying with 4.17.3, at least one stall 36" wide with an outward swinging, self-closing door and parallel grab bars shall be provided. Water closets in such stalls shall comply with 4.16.

**SECTION 4.22.5 - URINALS**

- A. If urinals are provided, then at least one shall comply with 4.18.

**SECTION 4.22.6 - LAVATORIES AND MIRRORS**

- A. If controls, dispensers, receptacles, or other equipment are provided, then at least one of each shall be on an accessible route and shall comply with 4.27.1 (Controls & Operating Mechanisms).

**4.23 - BATHROOMS, BATHING FACILITIES, AND SHOWER ROOMS**

**SECTION 4.23.8 - BATHING AND SHOWER FACILITIES**

- A. In addition to the requirements of 4.22, toilet rooms : If tubs and showers are provided, then at least one accessible shower that complies with 4.21 shall be provided

**4.24 - SINKS**

**SECTION 4.24.2 - HEIGHT**

**SECTION 4.24.3 - KNEE CLEARANCE**

- A. Knee clearance of 27" high minimum, 30" wide minimum, 19" deep minimum shall be provided underneath sinks.

**SECTION 4.24.4 - DEPTH**

- A. Each sink shall be a maximum of 6-1/2" deep.

**SECTION 4.24.6 - EXPOSED PIPES AND SURFACES**

- A. Hot water and drain pipes under sinks shall be insulated or otherwise configured to protect against contact.
- B. There shall be no sharp or abrasive surfaces under the sinks.

**SECTION 4.24.7, 4.27.4 - FAUCETS**

- A. Controls shall be operable with one hand and shall not require tight grasping, pinching, or twisting of the wrist.
- B. The force required to activate controls shall be no greater than 5 lbf.
- C. Lever-operated, push-type, and electronically controlled mechanisms are examples of acceptable designs.
- D. If self-closing valves are used the faucet shall remain open for at least 10 seconds.

**4.25 - STORAGE**

**SECTION 4.25.1 - DEPTH (REFERENCE DETAIL 4.25.1)**

- A. Storage areas may be 36" in depth or less. If more than 36" in depth then area must allow 60" diameter of clear floor space for turning.


**SECTION 4.25.2 - CLEAR FLOOR SPACE (REFERENCE DETAIL 4.25.2)**

**SECTION 4.25.3 - HEIGHT (REFERENCE DETAIL 14.3 AND 4.25.3 & 4.25.4)**

- A. Where a forward reach is required, accessible storage spaces shall be 48" maximum and 15" minimum above the floor. If the forward reach is over obstruction (with knee space equal to or greater than reach distance) 20"-25" deep, the maximum height shall be 44"; if the obstruction is less than 20", maximum height shall be 48".
- B. Where a side reach is provided, accessible storage spaces shall be 54" maximum and 9" minimum above the floor. Maximum height shall be 46" for side reach over an obstruction 34" maximum high and 24" maximum deep.
- C. Clothes rods or shelves shall be a maximum 54" above floor where a side reach is required.
- D. Where the distance from the wheelchair to the clothes rod or shelf exceeds 10" (as at closets with inaccessible doors) the following criteria shall be met:
  - Shelves: Reach: 21" maximum; height: 48" maximum, 9" minimum.
  - Clothes rods: reach 21" maximum; height: 48" maximum.


**SECTION 4.25.4, 4.27.4 - HARDWARE**

- A. Hardware for accessible storage facilities shall be operable with one hand and shall not require tight grasping, pinching, or twisting of the wrist.
- B. The force required to activate the hardware shall be no greater than 5 lbf

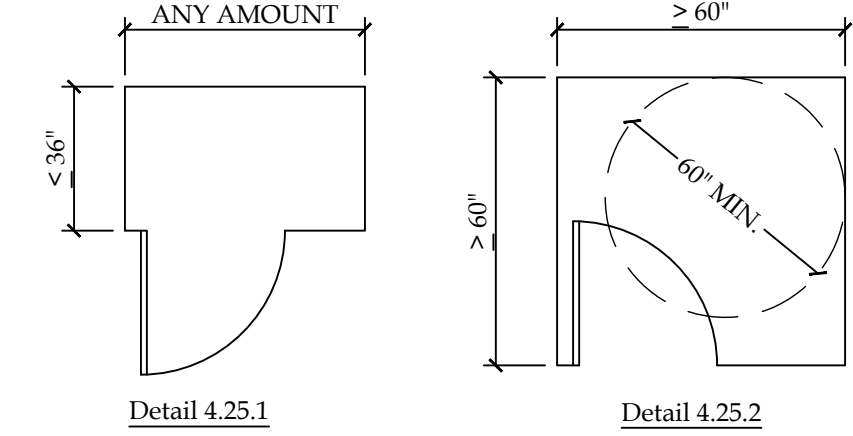

Detail 4.25.1

Detail 4.25.2

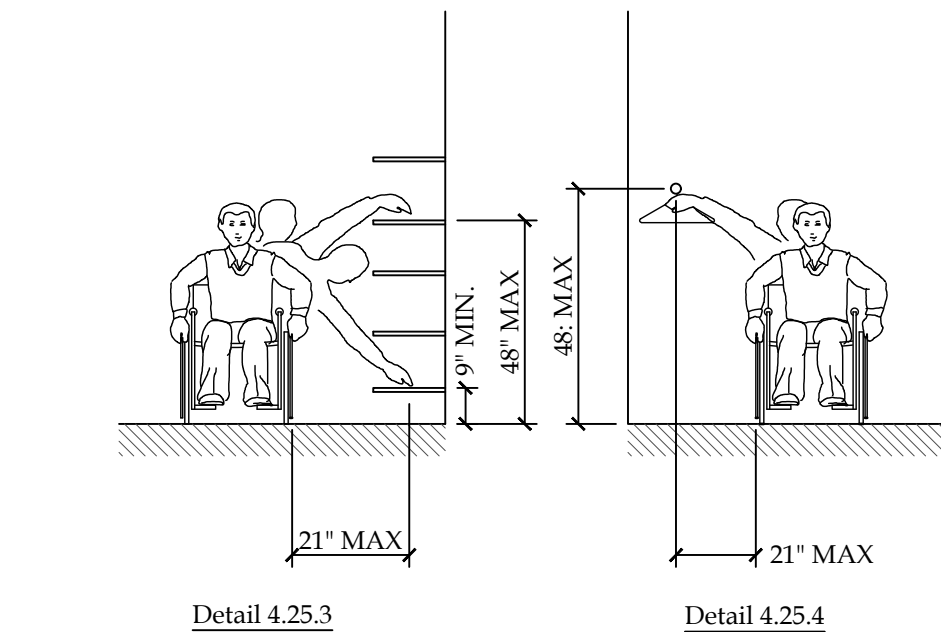

Detail 4.25.3

Detail 4.25.4

**4.26 - GRAB BARS**

**SECTION 4.26.2 - SIZE AND SPACING**

- A. Diameter or width of gripping surface shall be 1-1/4" to 1-1/2", or the shape shall provide an equivalent gripping surface.

- 1. The space between grab bars and adjacent walls shall be 1-1/2"

**SECTION 4.26.3 - STRUCTURAL STRENGTH**

- A. Grab bars and mounting devices shall meet the following requirements:
  - Bending stress induced by maximum bending moment from application of 250 lbf shall be less than allowable stress for material used.
  - Shear stress induced by application of 250 lbf shall be less than allowable shear stress for material used. If connection between grab

- 3. Shear force induced in a fastener or mounting device from application of 250 lbf shall be less than allowable lateral load of either the fastener or mounting device or the supporting structure, whichever is the smaller allowable load.
- 4. Tensile force induced in a fastener by a direct tension force of 250 lbf plus the maximum moment from the application of 250 lbf shall be less than the allowable withdrawal load between the fastener and the supporting structure.
- 5. Grab bars shall not rotate within their fittings.

**SECTION 4.26.4 - ELIMINATING HAZARDS**

- A. Grab bars and adjacent wall surfaces shall be free of sharp or abrasive surfaces.
- B. Edges shall have a radius of 1/8" minimum.

**4.27 - CONTROLS AND OPERATING MECHANISMS**

**SECTION 4.27.3 - HEIGHT (REFERENCE DETAIL 4.30.3)**

- A. Front approach - 48" max. to 15" min. Controls located in an alcove >24" deep must have 36" clear floor width.
- B. Side approach - 54" max. to 9" min., except per below.
- C. Electrical & communication system receptacles shall be mounted no less than 15" above the floor.

**4.28 - ALARMS**

**SECTION 4.28.1 - GENERAL**

- A. When required, visual alarms shall be provided in each of the following areas, as a minimum: restrooms and any other general usage areas (e.g., meeting rooms), hallways, lobbies, and any other area for common use.

**SECTION 4.28.2 - AUDIBLE ALARMS**

- A. If provided, audible alarms shall produce a sound that exceeds the prevailing equivalent sound level in the room or space by at least 15 dba or exceeds any maximum sound level with a duration of 60 seconds by 5 dba, whichever is louder.
- B. Sound levels for alarm signals shall not exceed 120 dba.

**SECTION 4.28.3 - VISUAL ALARMS**

- A. Visual alarm signal appliances shall be integrated into the building or facility alarm system. If single station audible alarms are provided then single station visual alarm signals shall be provided.

Visual Alarm appliances shall have the following features:

- The lamp shall be a xenon strobe type or equivalent.
- The color shall be clear or nominal white (i.e. unfiltered or clear filtered white light).
- The maximum pulse duration shall be two-tenths of one second with a maximum duty cycle of 40% (the pulse duration is defined as the time interval between initial and final points of 10% of max signal)
- The intensity shall be a minimum of 75 candela.
- The flash rate shall be a minimum of 1 Hz and a maximum of 3 Hz
- The appliance shall be placed 80" above the highest floor level within the space or 6" below the ceiling, whichever is lower.
- In general, no place in any room or space shall be more than 50' from the signal (measured in a horizontal plane).
  - a. In large rooms and spaces exceeding 100' across, without obstructions 6' above the finished floor, such as auditoriums, devices may be placed around the perimeter, spaced a maximum 100' apart, in lieu of suspending appliances from the ceiling.
- No place in common corridors or hallways shall be more than 50' from the signal.

**4.30 - SIGNAGE**

**SECTIONS 4.1.3(16)(a) - WHERE APPLICABLE**

- A. Signs which designate permanent rooms and spaces shall comply with the requirements listed below for:
  - Raised and Braille Characters, and Pictograms
  - Finish and Contrast

Exception: Employee name signs are not required to comply.

**SECTION 4.1.2(7), 4.1.3(16)(b) - WHERE APPLICABLE**

- A. Signs which provide direction to, or information about, functional spaces of the building shall comply with the requirements listed below for:
  - Character Proportion
  - Character Height
  - Finish and Contrast

Exception: Building directories, menus, and all other signs which are temporary are not required to comply.

**SECTION 4.1.2(7) - WHERE APPLICABLE (REFERENCE DETAIL 4.30.1)**

- A. Element and spaces of accessible facilities which shall be identified by the International Symbol of Accessibility are:
  - Parking spaces designated as reserved for persons with disabilities.
  - Accessible passenger loading zones.
  - Accessible entrances when not all are accessible (inaccessible entrances shall have directional Signage to indicate route to nearest accessible entrance.)
  - Accessible toilet and bathing facilities when not all are accessible.

**SECTION 4.30.2 - CHARACTER PROPORTION (REFERENCE DETAIL 4.30.2)**

- A. Letters and numbers on signs shall have a width-to-height ratio between 3:5 and 1:1, and a stroke-width-to-height ration between 1:5 and 1:10.

**SECTION 4.30.3 - CHARACTER HEIGHT**

- A. Characters and numbers on overhead signs shall be sized according to the viewing distance from which they are to be read.
  - For signs higher than 80" above the finished floor, character size shall be 3" minimum.
  - The minimum height is measured using an upper case X.
  - Lower case letters are permitted.

**SECTION 4.30.4 - RAISED AND BRAILLE CHARACTERS AND PICTOGRAMS**


- A. Letter and numerals shall be raised 1/32", upper case, sans serif and shall be accompanied by grade 2 Braille.
  - Raised character height: 5/8" minimum, 2" high maximum
  - Pictograms shall be accompanied by the equivalent verbal description placed directly below the pictogram.
  - The border dimension of the pictogram shall be 6" minimum

**SECTION 4.30.5 - FINISH AND CONTRAST**

- A. The character and background of the signs shall be eggshell, matte, or other non-glare finish. Characters and symbols shall contrast with their background (either light characters on a dark background or dark characters on a light background).

**SECTION 4.30.6 - MOUNTING LOCATION AND HEIGHT (REFERENCE DETAIL 4.30.3)**


- A. Where permanent identification is provided for rooms and spaces, signs shall be installed on the wall adjacent to the latch side of the door.
- B. Where there is no wall space to the latch side of the door, including at double-leaf doors, signs shall be placed on the nearest adjacent wall.
- C. Mounting height shall be 60" above the finished floor to the centerline of the sign.
- D. Mounting location for such Signage shall be so that a person may approach within 3' of Signage without encountering protruding objects or standing within the swing of a door.

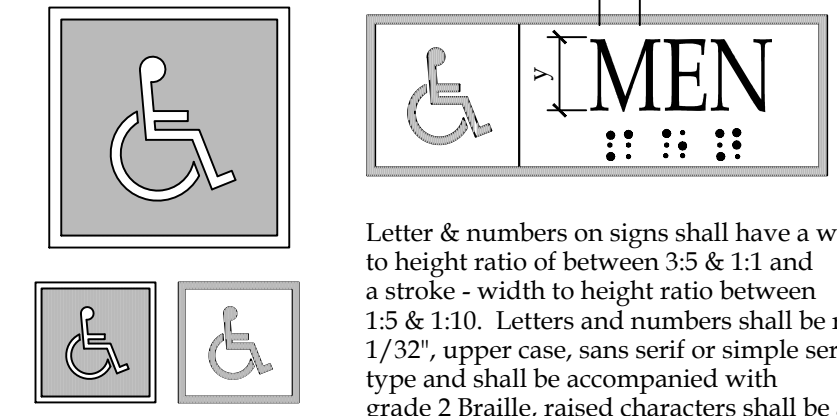

International Symbol of Accessibility

Detail 4.30.1

Detail 4.30.2

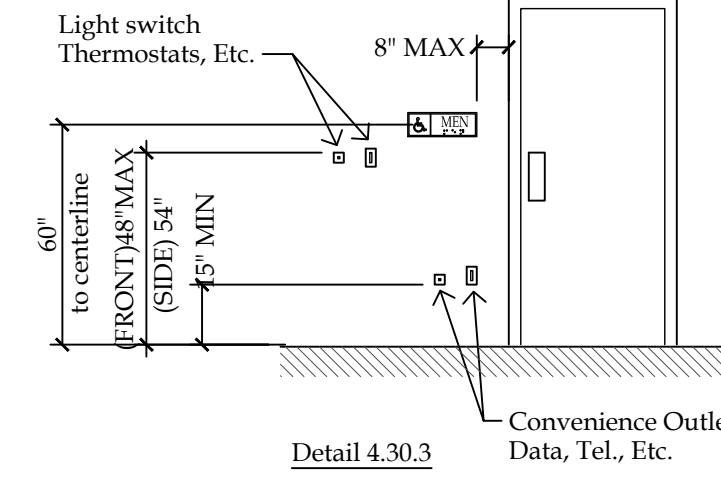

Detail 4.30.3

**4.31 - PUBLIC TELEPHONES**

**SECTION 4.1.3(17)(a) - WHERE APPLICABLE**

- A. If public telephones, public closed circuit telephones, or other public telephones if provided, then shall comply with this section in the quantities below:
  - If one or more single unit of a type of public telephone is provided on a floor, then at least one of those phones shall comply with this section.
  - If one bank (defined as two or more adjacent public telephones, often installed as a unit) of a type of those phones shall comply with this section.
  - If two or more banks of a type of public telephone are provided on a floor, then at least one telephone per bank shall comply with this section. The accessible unit may be installed as a single unit in proximity (either visible or with signage) to the bank. At least one public telephone per floor shall meet the requirements for a forward reach telephone.

Additional public telephones may be installed at any height.


Unless otherwise specified, accessible telephones may be either forward or side reach telephones.

**SECTION 4.1.3(17)(b) - WHERE APPLICABLE**

- A. All telephones required to be accessible shall be equipped with a volume control.
- B. In addition, 25%, but never less than one, of all public telephones provided shall be equipped with a volume control and shall be dispersed all type of telephones, including closed circuit telephones, throughout the building or facility.
- C. Signage displaying the International Symbol of Access for Hearing Loss shall be provided at each telephone equipped with a volume control.

**SECTION 4.31.3 - MOUNTING HEIGHT (REFERENCE DETAIL 4.31)**

- A. The highest operable part of the telephone shall be 48" max above the floor where a forward reach is required, and 54" maximum for a side reach is required.
- B. If the forward reach is over an obstruction (with knee space equal to or greater than the reach distance) 20"-25" deep the maximum height shall be 44"; if the obstruction is less than 20", maximum height shall be 48".
- C. Maximum height shall be 46" for side reach over an obstruction 34" maximum high and 24" maximum deep.

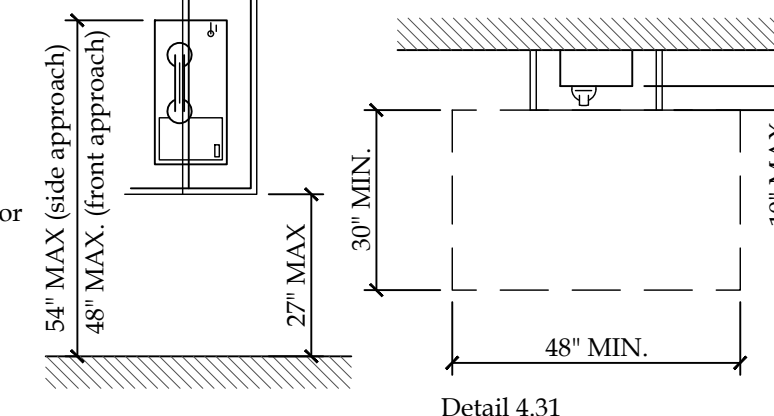

Detail 4.31

**4.32 - SEATING AND TABLES**

**SECTION 4.32.2 - SEATING**

- A. If seating spaces for people in wheelchairs are provided at fixed tables or counters, clear floor space of 30" x 48" shall be provided. Floor space shall not overlap required knee space by more than 19"

**SECTION 4.32.3 - KNEE SPACE**

- B. If seating for people in wheelchairs is provided at fixed tables or counters, knee space at least 27" high, 30" wide and 19" deep shall be provided.







**ACCESSIBILITY NOTES**

- ACCESSIBILITY TO PERSONS WITH DISABILITIES SHALL BE REQUIRED THROUGHOUT ALL AREAS OF THE LEASED SPACE IN ACCORDANCE WITH THE MORE STRINGENT OF: 2010 ADA STANDARDS FOR ACCESSIBLE DESIGN, INTERNATIONAL BUILDING CODE 2003, 2010 BUILDING CODE OF NEW YORK STATE, 2004 ARCHITECTURAL BARRIERS ACT ACCESSIBILITY GUIDELINES (ABAAS) & ANSI-A117.1-2003, AND SHALL BE INSTALLED AND COORDINATED WITH TENANT IMPROVEMENTS, TO THE EXTENT THE STANDARD REFERENCED IN THE PRECEDING SENTENCE CONFLICTS WITH LOCAL ACCESSIBILITY REQUIREMENTS, THE MORE STRINGENT STANDARD SHALL APPLY.

**2004 ARCHITECTURAL BARRIERS ACT ACCESSIBILITY GUIDELINES (ABA) ICC/ANSI A117.1-2003**

ADA (ARCHITECTURAL BARRIERS ACT ACCESSIBILITY STANDARDS) & 2010 STANDARDS FOR ACCESSIBLE DESIGN -

**MOST STRINGENT APPLIES**

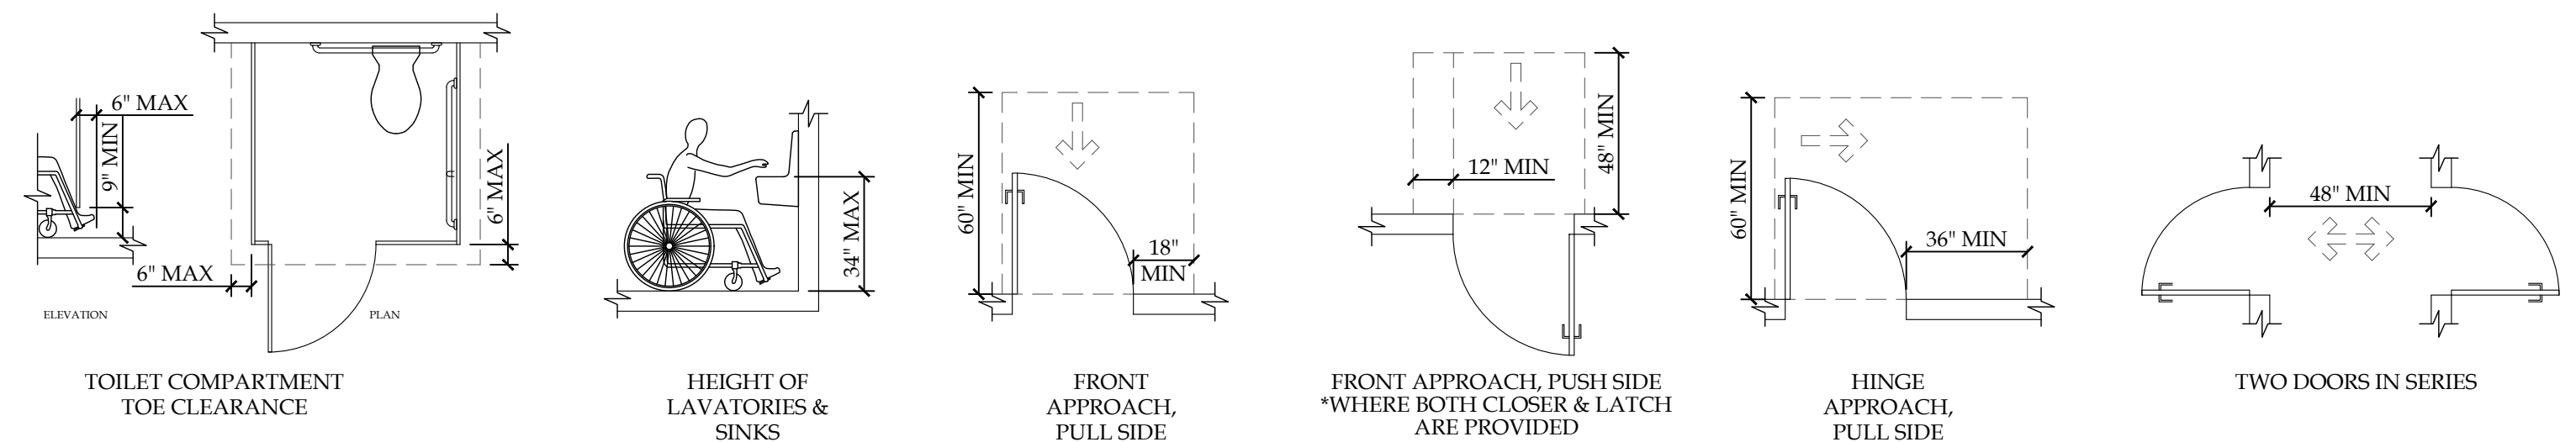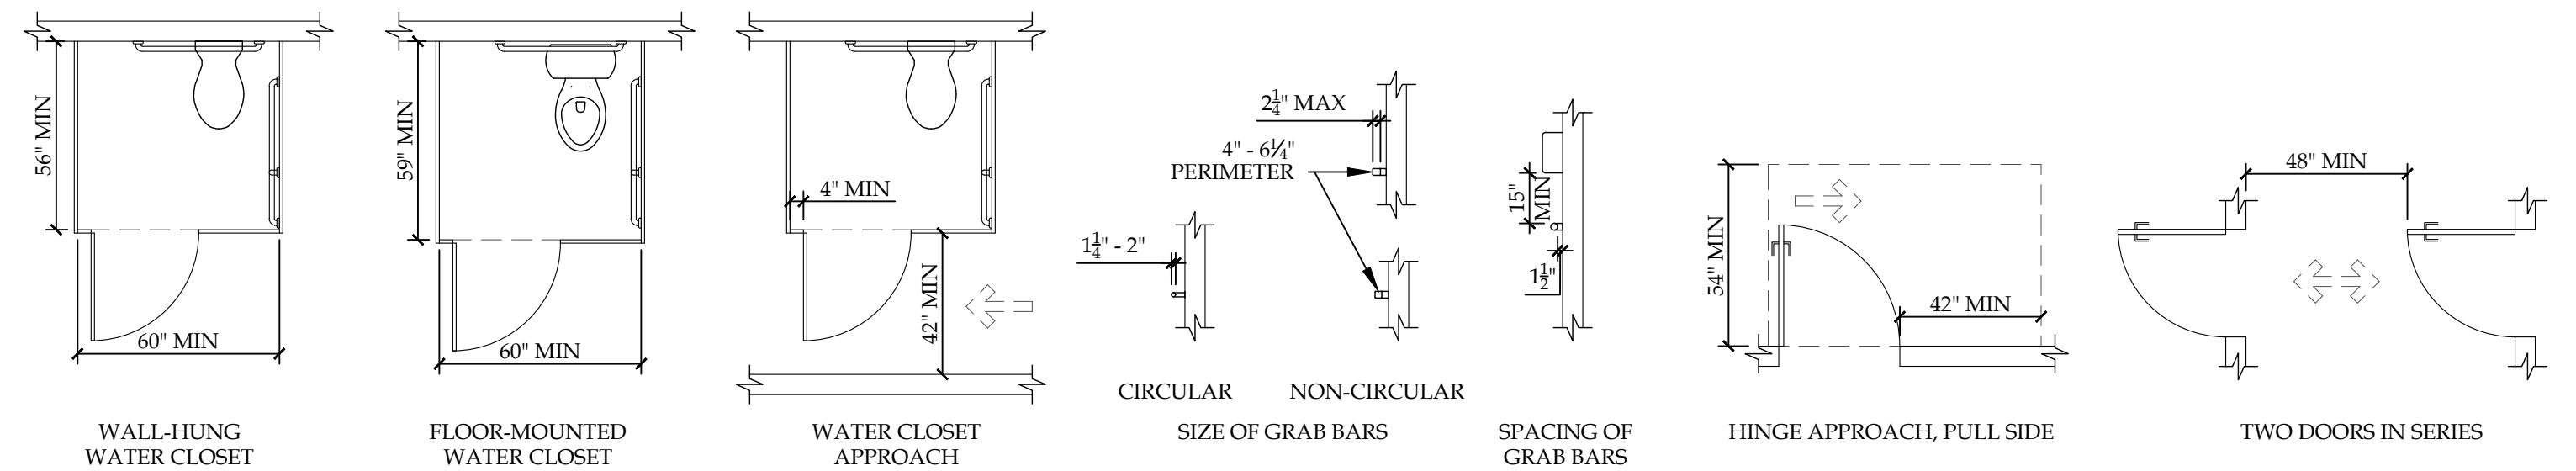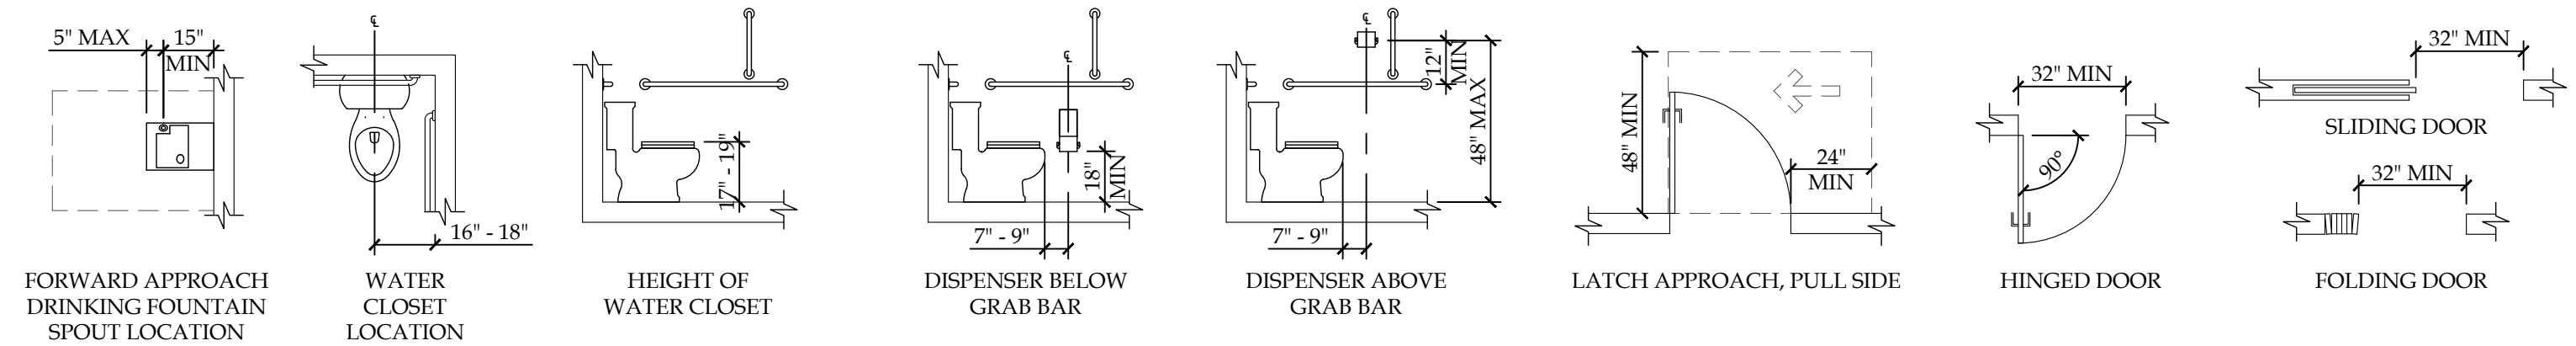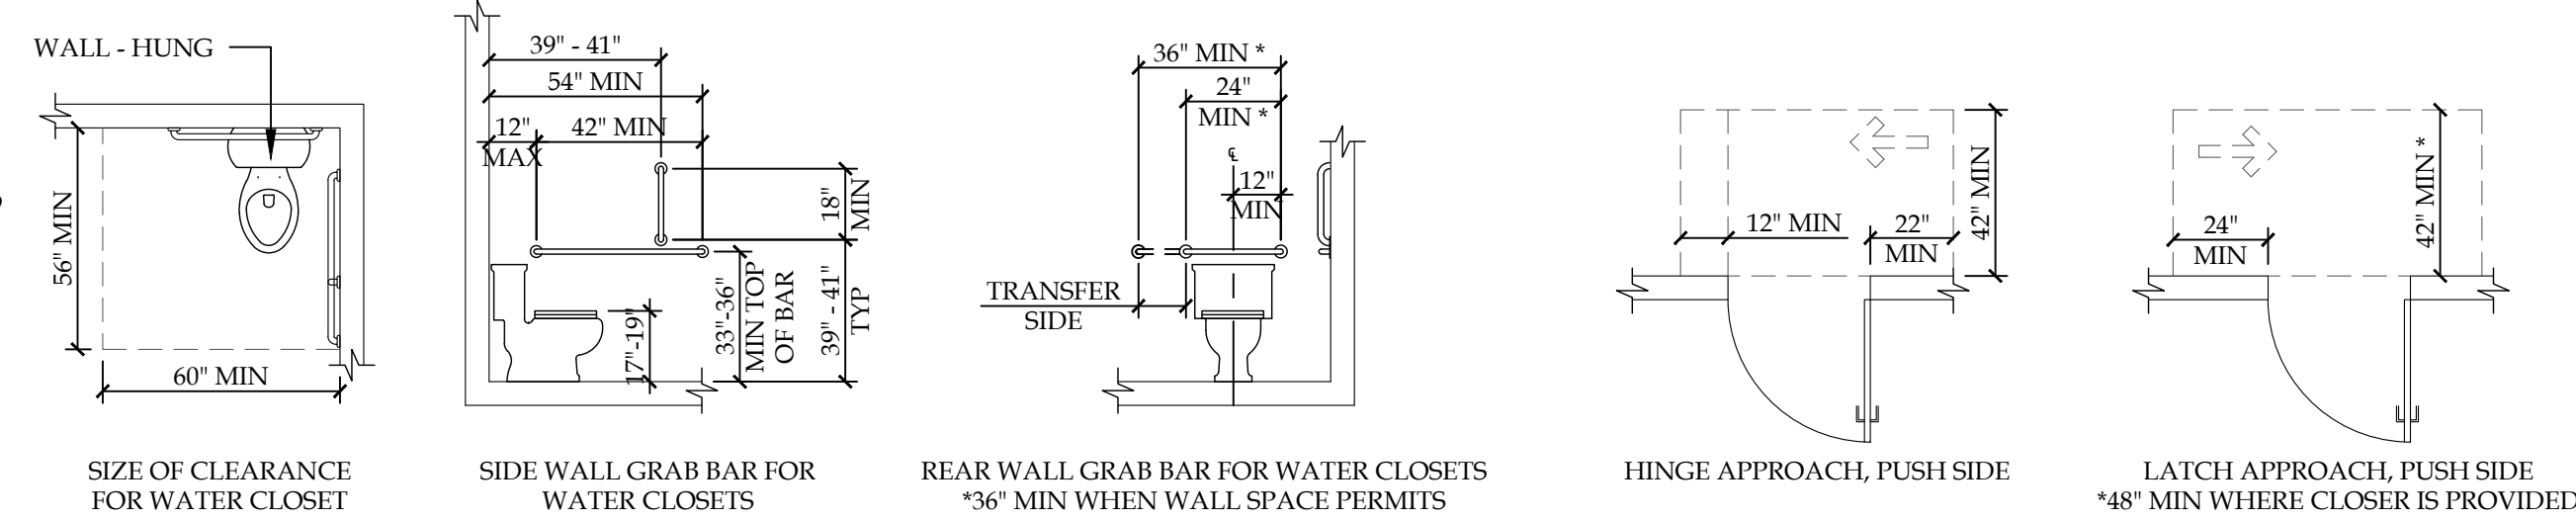

**GENERAL NOTES**

- CONSTRUCTION SHALL CONFORM TO ALL APPLICABLE NEW YORK STATE BUILDING CODES, OSHA STANDARDS AND FIRE SAFETY CODE / RELEVANT SECTIONS OF THE N.E.P.A. & ANY LOCAL CODES BEING MORE RESTRICTIVE THAN THE MINIMUMS LISTED.
- CONSTRUCTION MEANS, METHODS, TECHNIQUES AND CRAFTSMANSHIP ARE THE RESPONSIBILITY OF THE CONTRACTOR. G.C. SHALL VERIFY ALL DIMENSIONS AND CONDITIONS IN THE FIELD. CONTACT ARCHITECT IF MAJOR DISCREPANCIES OCCUR BETWEEN DRAWINGS AND EXISTING CONDITIONS.
- THE CONTRACTOR IS REQUIRED TO INSPECT THE PROJECT SITE IN ORDER TO DETERMINE THE EXTENT OF THE REQUIRED WORK. THIS INSPECTION SHALL BE COMPLETED PRIOR TO THE SUBMISSION OF ANY PROPOSAL TO COMPLETE THIS PROJECT. INSPECTION TIMES SHALL BE COORDINATED WITH THE OWNER.
- THE CONTRACTOR IS RESPONSIBLE FOR COMPLIANCE WITH ALL INFORMATION ON THE DRAWINGS.
- ALL DIMENSIONS SHOWN FOR EXISTING STRUCTURES ARE BASED ON RECORD DRAWINGS AND FIELD MEASUREMENTS. THE CONTRACTOR IS ADVISED THAT SAID DRAWINGS MAY NOT ACCURATELY REFLECT AS-BUILT CONDITIONS. ACCURATE FIELD MEASUREMENTS SHOULD BE MADE PRIOR TO ORDERING ANY PREFABRICATED MATERIALS. DISCREPANCIES SHALL BE REPORTED TO THE ARCHITECT AND SHALL BE REFLECTED ON THE CONTRACTOR'S SHOP DRAWINGS.
- THE DRAWINGS, SPECIFICATIONS AND OTHER DOCUMENTS FOR THIS PROJECT WILL BE COMPLETED TO THE SCOPE OF THE PROJECT IN COMPLIANCE WITH THE OWNER AND DESIGN TEAM. ANY CHANGES TO THESE DRAWINGS, SPECIFICATIONS AND OTHER DOCUMENTS WILL ONLY BE DONE BY A CHANGE ORDER THAT IS APPROVED BY THE OWNER.
- CONSIDERATION WILL NOT BE GRANTED FOR ANY ALLEGED MISUNDERSTANDINGS AS TO THE AMOUNT AND / OR SCOPE OF WORK TO BE PERFORMED. TENDER OF PROPOSAL SHALL CONVEY FULL AGREEMENT TO THE ITEMS, AND CONDITIONS INDICATED IN THE CONSTRUCTION DOCUMENTS OR OMISSIONS IN THE CONSTRUCTION DOCUMENTS OR BE IN DOUBT AS TO THE INTENT THEREOF. THE CONTRACTOR SHALL IMMEDIATELY OBTAIN CLARIFICATION FROM THE ARCHITECT PRIOR TO SUBMITTING A PROPOSAL FOR THE WORK.
- CONTRACTORS SHALL RECORD ALL DEVIATIONS FROM THE DESIGN DOCUMENTS IN THE DRAWINGS, AND PROVIDE A COPY TO THE ARCHITECT UPON THE COMPLETION OF WORK.
- PROVIDE APPROVED SEPARATION BY MEANS OF COATINGS, GASKETS, OR OTHER EFFECTIVE MEANS TO PREVENT GALVANIC CORROSION BETWEEN ALL DISSIMILAR METALS.
- THE CONTRACTOR SHALL BE RESPONSIBLE FOR REPAIRING ANY DAMAGE CAUSED BY THE CONSTRUCTION OPERATIONS OF THIS PROJECT TO ADJACENT PROPERTY, UTILITIES, PAVEMENT, LANDSCAPING, STRUCTURES OR IMPROVEMENTS OF ANY KIND. THE CONTRACTOR SHALL REPAIR ALL SUCH DAMAGED ITEMS TO THE CONDITION THEY WERE IN PRIOR TO COMMENCEMENT OF CONSTRUCTION ACTIVITIES OR BETTER.
- WHERE IT IS NECESSARY TO INSURE STABILITY, CONTRACTOR IS TO PROVIDE ADDITIONAL ANCHORING AND/OR BLOCKING IN STUD PARTITIONS OR BRACE PARTITIONS ABOVE CEILINGS.
- ALL OWNER SUPPLIED ITEMS WILL BE COORDINATED WITHIN THE CONTRACTOR'S CONSTRUCTIONS SCHEDULES PRIOR TO CONSTRUCTION COMMENCEMENT.
- THE CONTRACTOR SHALL CAREFULLY REVIEW THE DRAWINGS, SPECIFICATIONS, AND SITE AND VERIFY ALL DIMENSIONS AND SITE CONDITIONS PRIOR TO BEGINNING WORK. THE CONTRACTOR SHALL REPORT ANY INCONSISTENCIES TO THE ARCHITECT IMMEDIATELY FOR RESOLUTION BEFORE BEGINNING CONSTRUCTION.
- ALL PHASES OF THE WORK SHALL CONFORM TO THE MINIMUM STANDARDS OF THE INTERNATIONAL BUILDING CODE AND THE LIFE SAFETY CODE (NFPA-101). HOWEVER, WHERE THE DRAWINGS AND/OR SPECIFICATIONS ARE MORE STRINGENT THEY SHALL GOVERN. THE CONTRACTOR SHALL INFORM THE ARCHITECT OF ANY CODE DISCREPANCY PRIOR TO COMMENCEMENT OF WORK.
- ALL WORK SHALL COMPLY WITH OSHA STANDARDS.
- ALL DIMENSIONS SHALL HAVE PRECEDENCE OVER SCALE. DO NOT SCALE DRAWINGS. ALL DIMENSIONS ARE TO FACE OF CONCRETE OR MASONRY, CENTERLINE OF COLUMNS AND BEAMS, AND FINISH TO FINISH, UNLESS OTHERWISE NOTED.
- THE STRUCTURAL, MECHANICAL, ELECTRICAL AND PLUMBING DRAWINGS ARE SUPPLEMENTARY TO THE ARCHITECTURAL DRAWINGS. IT SHALL BE THE RESPONSIBILITY OF THE CONTRACTOR TO CHECK WITH THE ARCHITECTURAL DRAWINGS BEFORE THE INSTALLATION OF STRUCTURAL, MECHANICAL, ELECTRICAL AND PLUMBING WORK. ANY DISCREPANCIES BETWEEN THE ARCHITECT'S AND ENGINEER'S DRAWINGS AND SPECIFICATIONS SHALL BE BROUGHT TO THE ARCHITECT'S ATTENTION FOR CLARIFICATION PRIOR TO PROCEEDING WITH SAID WORK.
- DETAILS MARKED "TYPICAL" SHALL APPLY IN ALL CASES UNLESS SPECIFICALLY INDICATED OTHERWISE.
- ALL SYMBOLS AND ABBREVIATIONS USED ON THE DRAWINGS ARE CONSIDERED TO BE CONSTRUCTION STANDARDS. IF THE CONTRACTOR HAS QUESTIONS REGARDING SOME, OR THEIR EXACT MEANING, THE ARCHITECT SHALL BE NOTIFIED FOR CLARIFICATION.
- CONTRACTOR SHALL VERIFY AND ESTABLISH THE LOCATIONS AND ELEVATIONS OF ALL UTILITIES WITHIN THE WORK AREA, AND SHALL COORDINATE WITH THE OWNER AND THE UTILITY COMPANIES PRIOR TO THE START OF THE PROJECT.
- THE CONTRACTOR SHALL PROVIDE ALL SHORING AND BRACING REQUIRED TO ADEQUATELY PROTECT PERSONAL AND ADJACENT PROPERTY AND TO INSURE SAFETY OF THE STRUCTURE THROUGHOUT THE CONSTRUCTION PERIOD.
- ALL CEILING HEIGHTS AS SHOWN ON DETAILS OR PLANS OR NOTES ARE FROM TOP OF CONCRETE DECK TO FINISH CEILING. USE OF THE TERM ABOVE FINISH FLOOR (A.F.F.) MEANS MEASURED FROM THE TOP OF CONCRETE DECK. CONTRACTOR SHALL ALLOW FOR AND COORDINATE WORK WITH FLOOR FINISH MATERIAL AND INSTALLATION METHOD.
- PROVIDE INDEPENDENT SUSPENSION FOR ALL LIGHT FIXTURES. SUSPENSION FOR CEILING AND LIGHT FIXTURES SHALL BE INDEPENDENT OF SUSPENSION FOR DUCT WORK.
- ALL EQUIPMENT AND MATERIALS INSTALLED IN THIS JOB SHALL BE NEW AND FREE OF ANY DEFECTS UNLESS OTHERWISE NOTED.
- ALL RUBBISH AND DEBRIS RESULTING FROM DEMOLITION AND/OR NEW WORK IS THE PROPERTY OF THE CONTRACTOR AND SHALL BE DISPOSED OF OFF-SITE IN A LEGAL MANNER. MAINTAIN BUILDING AREAS CLEAN AND FREE OF ACCUMULATED DIRT AND DEBRIS.
- CONTRACTOR IS RESPONSIBLE FOR COORDINATION OF THE WORK WITH EQUIPMENT INSTALLATIONS AND OWNERS REQUIREMENTS.
- INTERIOR AND/OR EXTERIOR THRESHOLDS SHALL BE A MAXIMUM 1/2" ABOVE THE ADJACENT FLOOR.
- ALL EXIT DOORS SHALL BE OPERABLE FROM THE INSIDE WITHOUT ANY SPECIAL EFFORT OR KNOWLEDGE.
- ALL CONSTRUCTION AND MATERIALS SHALL BE OF THE HIGHEST QUALITY AND CONFORM TO ACCEPTED INDUSTRY/TRADE STANDARDS FOR GOOD DESIGN AND CONSTRUCTION.
- LOCATE ALL CONVENIENCE OUTLETS A MINIMUM OF 18" FROM THE FINISHED FLOOR.
- NEITHER THE OWNER NOR THE ARCHITECT/ENGINEER ASSUMES RESPONSIBILITY FOR THE POSSIBILITY THAT UTILITIES OTHER THAN THOSE SHOWN EXIST.
- THE CONTRACTOR IS RESPONSIBLE FOR THE COORDINATION OF HIS WORK AND SCHEDULE WITH WORK BEING PERFORMED BY OTHERS AND THE USER/OWNER OF THE BUILDING.
- THE CONTRACTOR SHALL COORDINATE HIS WORK AND SCHEDULE WITH THE OWNER FOR ALL BUILDING AND CONSTRUCTION SIGNAGE.
- THE CONTRACTOR SHALL PROVIDE ALL ELECTRICAL AND PLUMBING HOOK-UPS AND/OR CONNECTIONS FOR ALL OWNER FURNISHED EQUIPMENT.
- ALL HARDWARE, PANIC BARS, PUSH-PULL ACTIVATING BARS, OR OTHER HARDWARE SHALL BE ADA COMPLIANT HARDWARE DESIGNED TO PROVIDE PASSAGE WITHOUT REQUIRING THE ABILITY TO GRASP THE OPENING HARDWARE.
- OPEN EXTERIOR JOINTS AROUND WINDOW AND DOOR FRAMES, BETWEEN WALLS AND FOUNDATIONS, BETWEEN WALL AND ROOF, BETWEEN WALL PANELS, AT PENETRATIONS OF UTILITIES THROUGH THE ENVELOPE, SHALL BE SEALED, CAULKED, OR WEATHERSTRIPPED AND MADE WATER TIGHT UNLESS NOTED OTHERWISE.
- ALL MANUALLY OPERATED SWITCHES AND CONTROLS ARE TO BE MOUNTED BETWEEN 36" AND 48" A.F.F., UNLESS NOTED.
- CONTRACTOR SHALL INSTALL CONTROL JOINTS ON ALL INTERIOR GYP. BOARD PARTITIONS AT 30'-0" MAX. IN EITHER DIRECTION AND AT ALL DOOR JOINTS (TWO PER OPENING).
- ELECTRICAL CONTRACTOR RESPONSIBLE TO PROVIDE POWER FOR ALL OTHER TRADES' EQUIPMENT.
- ALL SUBMITTALS AND RFTS ARE TO BE SUBMITTED, THROUGH THE CONSTRUCTION MANAGER, TO THE ARCHITECT IN WRITING.

| REVISION RECORD |      |         |
|-----------------|------|---------|
| NO.             | DATE | REMARKS |
|                 |      |         |

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**BRYANT & STRATTON COLLEGE**  
1320 Warwick Way  
Mt. Pleasant, WI 53406

SCALE:  
1/8" = 1'-0"

**GENERAL NOTES & ACCESSIBILITY DIAGRAMS**

**GREGORY A. TOMSIC**  
REGISTERED ARCHITECT  
145 BATHURST DR., TONAWANDA, N.Y. 14150  
716-455-4617

|                       |                          |
|-----------------------|--------------------------|
| SCALE<br>1/8" = 1'-0" | JOB NO.                  |
| DRAWN                 | DWG. NO.<br><b>A-003</b> |
| CHECKED               |                          |
| DATE<br>12.22.2017    | CONTRACT NO.             |

### GENERAL WALL NOTES

- SEE SPECIFICATIONS FOR APPLICATIONS OF GYPSUM PRODUCTS, UNLESS NOTED ON DRAWINGS. REFER TO SPECIFICATIONS FOR SPECIAL APPLICATIONS, THICKNESS, AND TYPES. (I.E. MOLD & MOISTURE RESISTANCE, TILE BACKER BOARDS, ETC.)
- REFER TO THE LATEST EDITION OF UNDERWRITERS LABORATORIES, INC. FIRE RESISTANCE DIRECTORY FOR ADDITIONAL REQUIREMENTS ON UL RATED ASSEMBLIES AS NOTED IN THE WALL SCHEDULE.
- USE ONLY PARTITIONS IDENTIFIED ON THE PLANS.
- STC = SOUND TRANSMISSION CLASS - REFER TO THE WALL SCHEDULE IN PLAN FOR WALLS THAT ARE SOUND RATED.
- ALL SEALANTS IN RATED WALL LOCATIONS REFERENCED IN THE WALL TYPE DETAILS SHALL BE SELECTED AND INSTALLED IN ACCORDANCE WITH THE MINIMUM REQUIREMENTS OF THE UNDERWRITERS LABORATORIES, INC FIRE RESISTANCE DIRECTORY. IN ADDITION TO FIRE RESISTANCE, WALL LOCATIONS CALLED OUT WITH REQUIRED ACOUSTICAL VALUE, AS NOTED IN WALL SCHEDULE, SHALL HAVE SEALANTS THAT MAINTAIN THE MINIMUM SOUNDS VALUE OF THE WALL PARTITION.
- FIRE CAULK ALL PENETRATIONS IN RATED WALL ASSEMBLIES.
- ASSEMBLIES SHOULD BE AIRTIGHT. HAIRLINE CRACKS AND HOLES ARE NOT ALLOWED.
- RECESSED WALL FIXTURES SUCH AS CABINETS, OUTLETS, AND OTHER ITEMS WHICH PENETRATE THE GYPSUM BOARD SURFACE SHOULD NOT BE LOCATED BACK TO BACK IN THE SAME STUD CAVITY.
- ANY OPENINGS CUT FOR ANY FIXTURES SHALL BE CAREFULLY CUT TO SIZE, PROPERLY FASTENED, INSULATED PER WALL ASSEMBLY AND PROPERLY CAULKED.
- THE ENTIRE PERIMETER OF A SOUND INSULATING ASSEMBLY MUST BE MADE AIRTIGHT TO PREVENT SOUND FROM "FLANKING".
- AN ACOUSTICAL SEALANT SHOULD BE USED TO SEAL BETWEEN THE SOUND INSULATING ASSEMBLY AND ALL DISSIMILAR ASSEMBLIES AND BETWEEN THE ASSEMBLY AND SIMILAR SURFACES WHERE PERIMETER RELIEF IS REQUIRED. TAPING AND CAULKING OF GYPSUM BOARD WALL AND WALL-CEILING INTERSECTIONS PROVIDES AN ADEQUATE AIR SEAL AT THESE LOCATIONS.
- ASTM RECOMMENDED PRACTICES E-497 SHOULD BE FOLLOWED FOR GOOD SOUND CONTROL. ALSO CONSULT THE MANUFACTURER OF THE GYPSUM BOARD FOR ANY SPECIAL RECOMMENDATIONS RELATING TO THEIR SYSTEM.
- USE MOISTURE & MOLD RESISTANT GYP. BD. AT ALL WET LOCATIONS

| REVISION RECORD |      |         |
|-----------------|------|---------|
| NO.             | DATE | REMARKS |
|                 |      |         |

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Bryant and Stratton College

**BRYANT & STRATTON COLLEGE**

1320 Warwick Way  
Mt. Pleasant, WI 53406

SEAL:


### PARTITION TYPES & DETAILS

GREGORY A. TOMSIC

REGISTERED ARCHITECT

145 BATHURST DR., TONAWANDA, N.Y. 14150  
716-455-4617

|                       |                          |
|-----------------------|--------------------------|
| SCALE<br>1/8" = 1'-0" | JOB NO.                  |
| DRAWN                 | DWG. NO.<br><b>A-004</b> |
| CHECKED               | CONTRACT NO.             |
| DATE<br>12.22.2017    |                          |

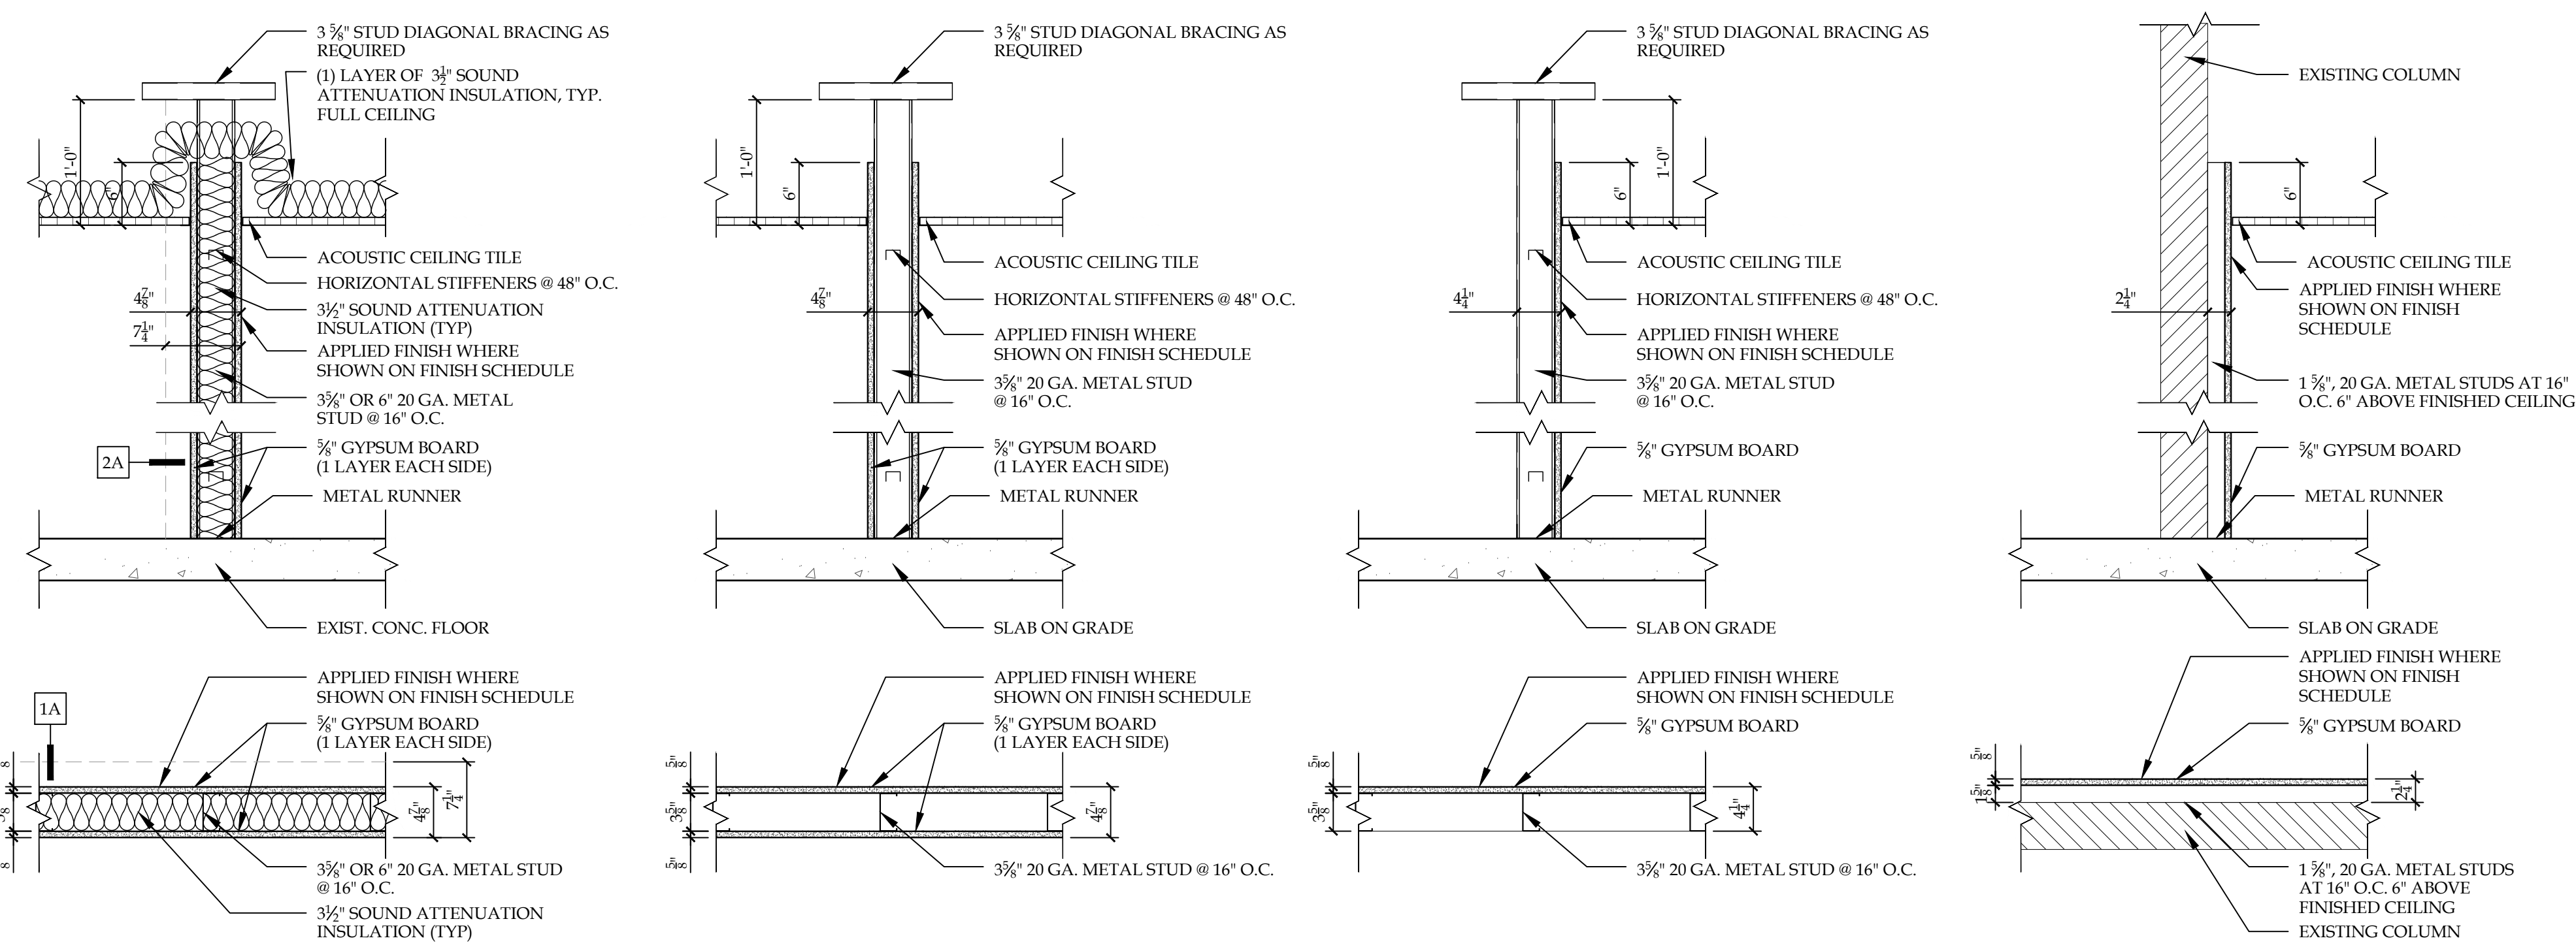


- 1 3/8" ACOUSTIC PARTITION
- 1A 6" ACOUSTIC PARTITION

**1 INTERIOR PARTITION TYPES**  
SCALE: 1" = 1'-0"




| REVISION RECORD |            |             |
|-----------------|------------|-------------|
| NO.             | DATE       | REMARKS     |
| #1              | 09.06.2017 | ADDENDUM #1 |
| #2              | 01.10.2018 | ADDENDUM #2 |

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**BRYANT & STRATTON COLLEGE**  
1320 Warwick Way  
Mt. Pleasant, WI 53406



**FIRST FLOOR  
CODE  
COMPLIANCE  
PLAN**

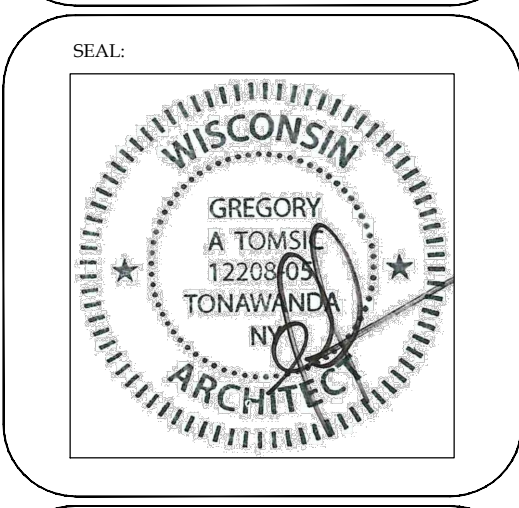**GREGORY A. TOMSIC**  
REGISTERED ARCHITECT  
145 BATHURST DR., TONAWANDA, N.Y. 14150  
716-435-4617

|                       |                          |
|-----------------------|--------------------------|
| SCALE<br>1/8" = 1'-0" | JOB NO.                  |
| DRAWN                 | DWG. NO.<br><b>A-005</b> |
| CHECKED               | CONTRACT NO.             |
| DATE<br>12.22.2017    |                          |

**FIRE & LIFE SAFETY PLAN KEY**

- EXIT SIGN, SEE ELECTRICAL DRAWINGS
- EMERGENCY LIGHT, SEE ELECTRICAL DRAWINGS
- FIRE EXTINGUISHER
- FIRE EXTINGUISHER IN CABINET W/BREAK AWAY GLASS 4A-8013.C

**2009 IBC**

PRESENT USAGE: FITNESS CENTER, GYMNASIUM  
NEW USE: BUSINESS (EDUCATIONAL FOR STUDENTS ABOVE 12th GRADE)

SPRINKLER SYSTEM: REQUIRED - TO BE INSTALLED, NFPA13  
CONSTRUCTION TYPE: IIB, 1 STORY

INTERNAL MEZZANINE TO BE REMOVED.  
BUILDING HEIGHT TO REMAIN:  
ALLOWABLE TABULAR FIRE AREA & HEIGHT: 23,000 SQ. FT., 3 STORIES, 55'-0"  
ACTUAL FIRE AREA & HEIGHT: 14,625 SQ. FT., 1 STORY, 25'-7" ± TO PEAK

ALLOWABLE FIRE AREA INCREASE FOR SPRINKLER = 2 x 23,000 = 46,000 SQ. FT.


OCCUPANT LOAD (TOTAL BUILDING, 1ST & 2ND FLOORS):

| USE                   | AREA  | AREA / PERSON | TOTAL OCCUPANTS |
|-----------------------|-------|---------------|-----------------|
| CLASSROOMS            | 3,324 | 20            | 167             |
| LABS/VOCATIONAL AREAS | 3,099 | 50            | 62              |
| LIBRARY               | 1,024 | 50            | 21              |
| LOUNGE                | 424   | 15            | 28              |
| REMAINING BUSINESS    | 6,757 | 100           | 68              |
| <b>TOTAL</b>          |       |               | <b>346</b>      |


REQUIRED PLUMBING FIXTURES:

TOILETS: 1/25 FOR FIRST 50 & 1/50 FOR REMAINING = 8  
LAVATORIES: 1/40 FOR FIRST 80 & 1/80 FOR REMAINING = 5  
DRINKING FOUNTAINS: 1/100 = 4  
MOP SERVICE SINKS: = 1

CORRIDOR RATING: 0 HOURS - NFPA13 SPRINKLER SYSTEM

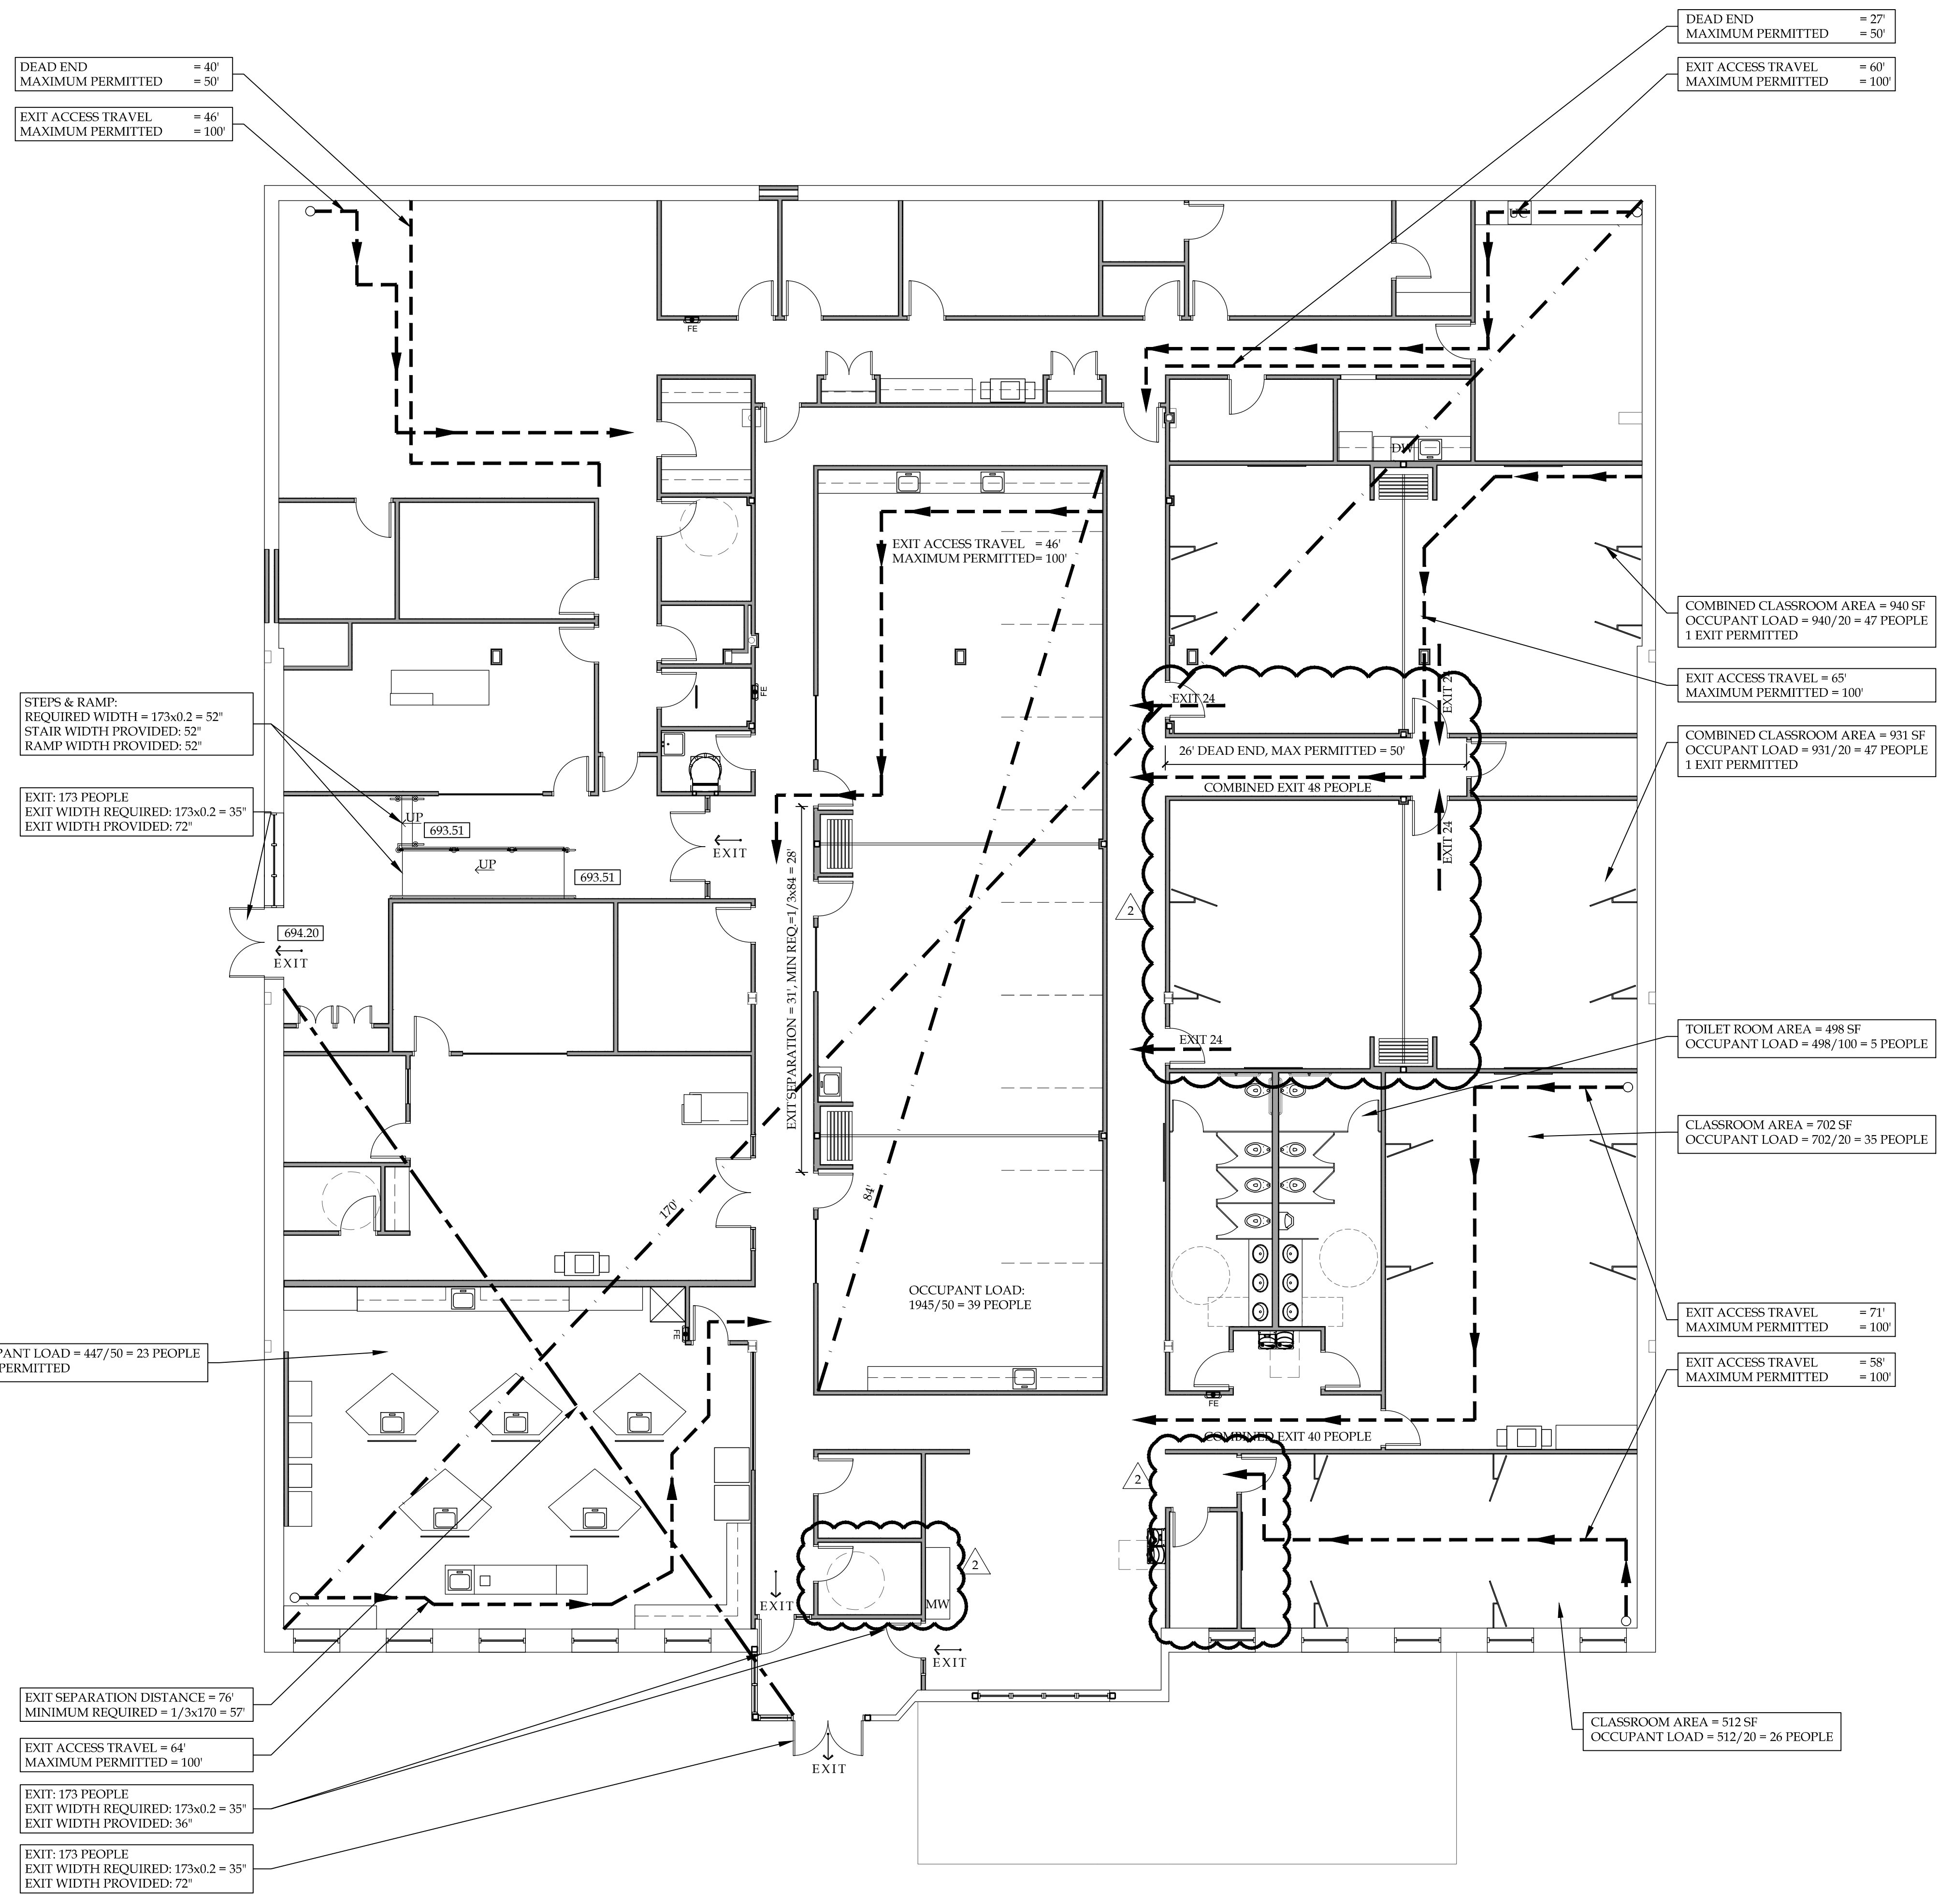

**A1 FIRST FLOOR CODE COMPLIANCE PLAN**  
SCALE: 1/8" = 1'-0"

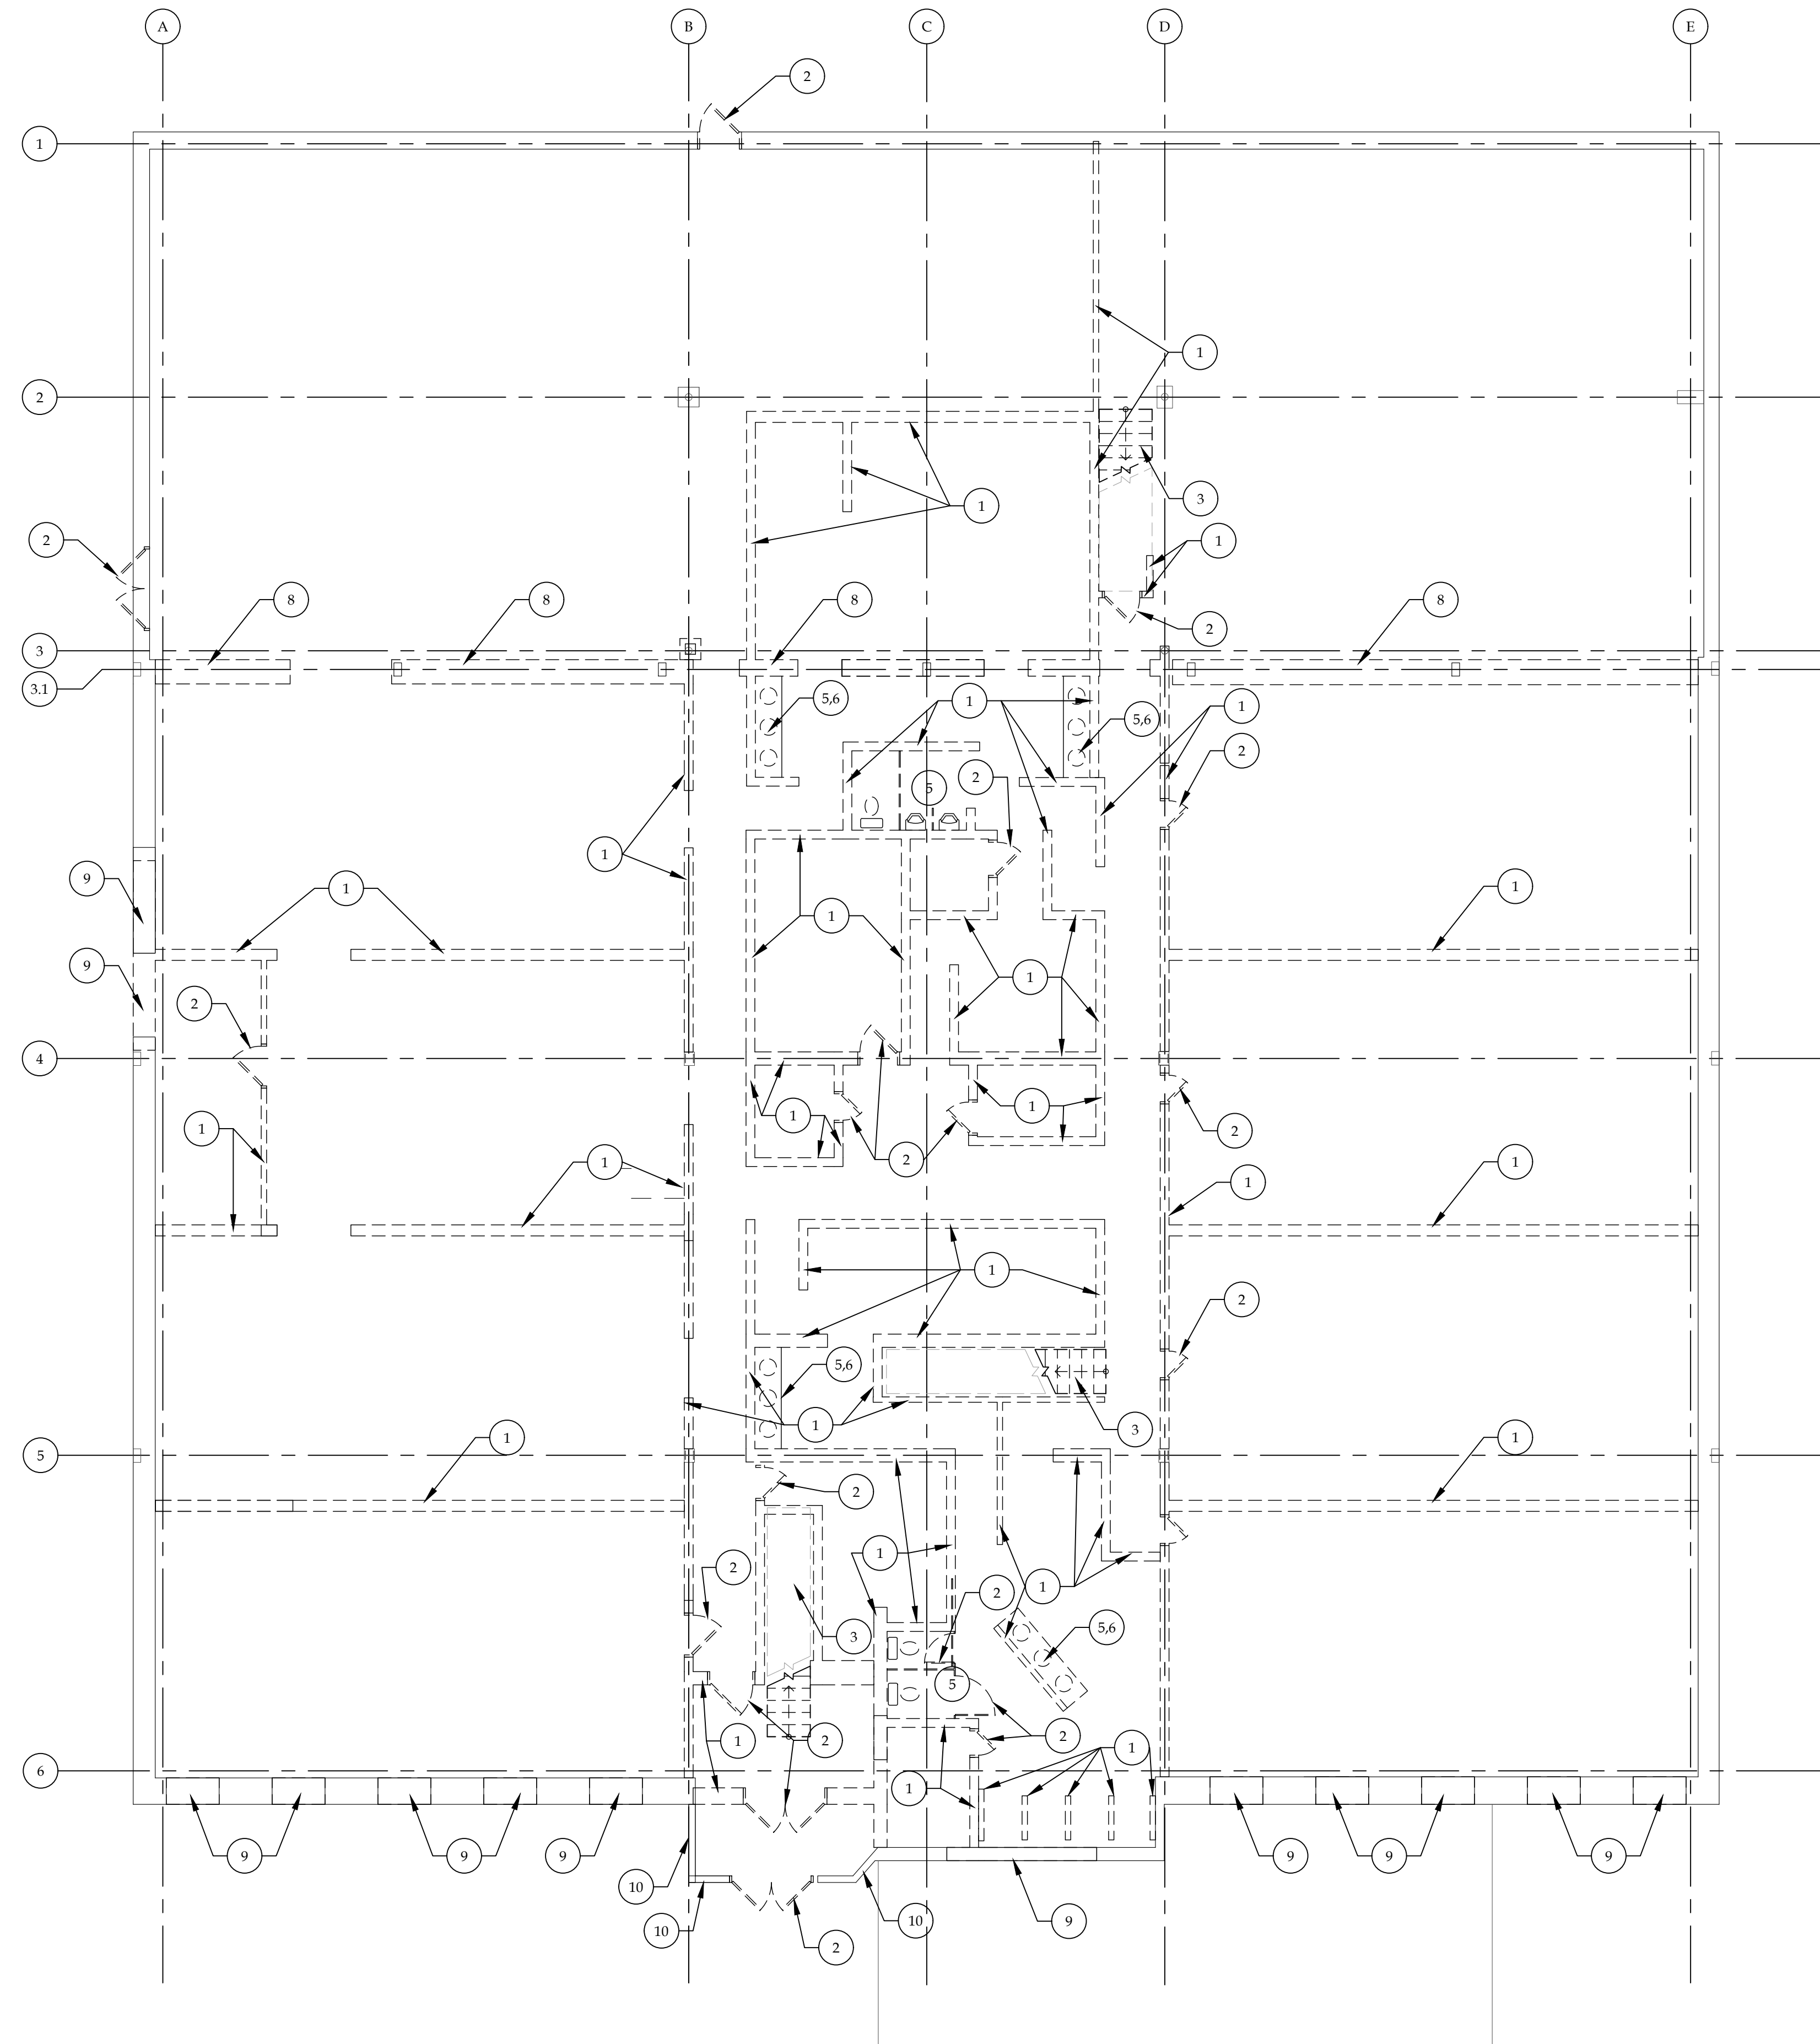

**GENERAL DEMOLITION NOTES**


- IN GENERAL, ITEMS TO BE REMOVED ARE SHOWN DASHED, HOWEVER, CONTRACTOR SHALL REMOVE ALL ITEMS AS REQUIRED TO ALLOW FOR NEW CONSTRUCTION.
- CONTRACTOR IS RESPONSIBLE FOR ALL DEMOLITION TO READY THE SITE/FLOOR FOR NEW CONSTRUCTION.
- CONTRACTOR TO PROTECT ALL EXISTING FINISHES TO REMAIN DURING CONSTRUCTION AND REPLACE DAMAGED FINISHES AS REQUIRED.
- CONTRACTOR TO VERIFY IN FIELD ANY ADDITIONAL DEMOLITION REQUIRED TO PREPARE AREA FOR NEW CONSTRUCTION PER PLANS.

**(X) DEMOLITION PLAN NOTES**

1. REMOVE EXISTING WALL TO THE EXTENT SHOWN. PROVIDE SHORING AS REQUIRED, SEE STRUCTURAL DRAWINGS.
2. REMOVE EXISTING DOOR AND FRAME.
3. REMOVE EXISTING STAIR AND HANDRAIL.
4. REMOVE EXISTING GLAZING.
5. REMOVE EXISTING PLUMBING FIXTURE.
6. REMOVE EXISTING CASEWORK.
7. REMOVE ALL 2ND FLOOR CONCRETE PLANK AND ASSOCIATED SUPPORTS, SEE STRUCTURAL.
8. REMOVE EXISTING WALL TO THE EXTENT SHOWN UP TO 12' CLEAR HIGH. EXISTING COLUMN IN WALL TO REMAIN. PROVIDE SHORING AS REQUIRED, SEE STRUCTURAL DRAWINGS.
9. REMOVE PORTION OF EXISTING WALL FOR NEW OPENING. VERIFY EXACT LOCATION WITH NEW FLOOR PLAN.
10. EXISTING CURTAIN WALL TO BE REMOVED.
11. EXISTING MANSARD ROOF TO BE REMOVED.

| REVISION RECORD |      |         |
|-----------------|------|---------|
| NO.             | DATE | REMARKS |
|                 |      |         |

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1320 Warwick Way  
Mt. Pleasant, WI 53406


SEAL:

**1st FLOOR DEMOLITION PLAN**

**GREGORY A. TOMSIC**  
REGISTERED ARCHITECT  
145 BATHURST DR., TONAWANDA, N.Y. 14150  
716-433-0617

|                       |                           |
|-----------------------|---------------------------|
| SCALE<br>1/8" = 1'-0" | JOB NO.                   |
| DRAWN                 | DWG. NO.<br><b>AD-101</b> |
| CHECKED               | CONTRACT NO.              |
| DATE<br>12.22.2017    |                           |



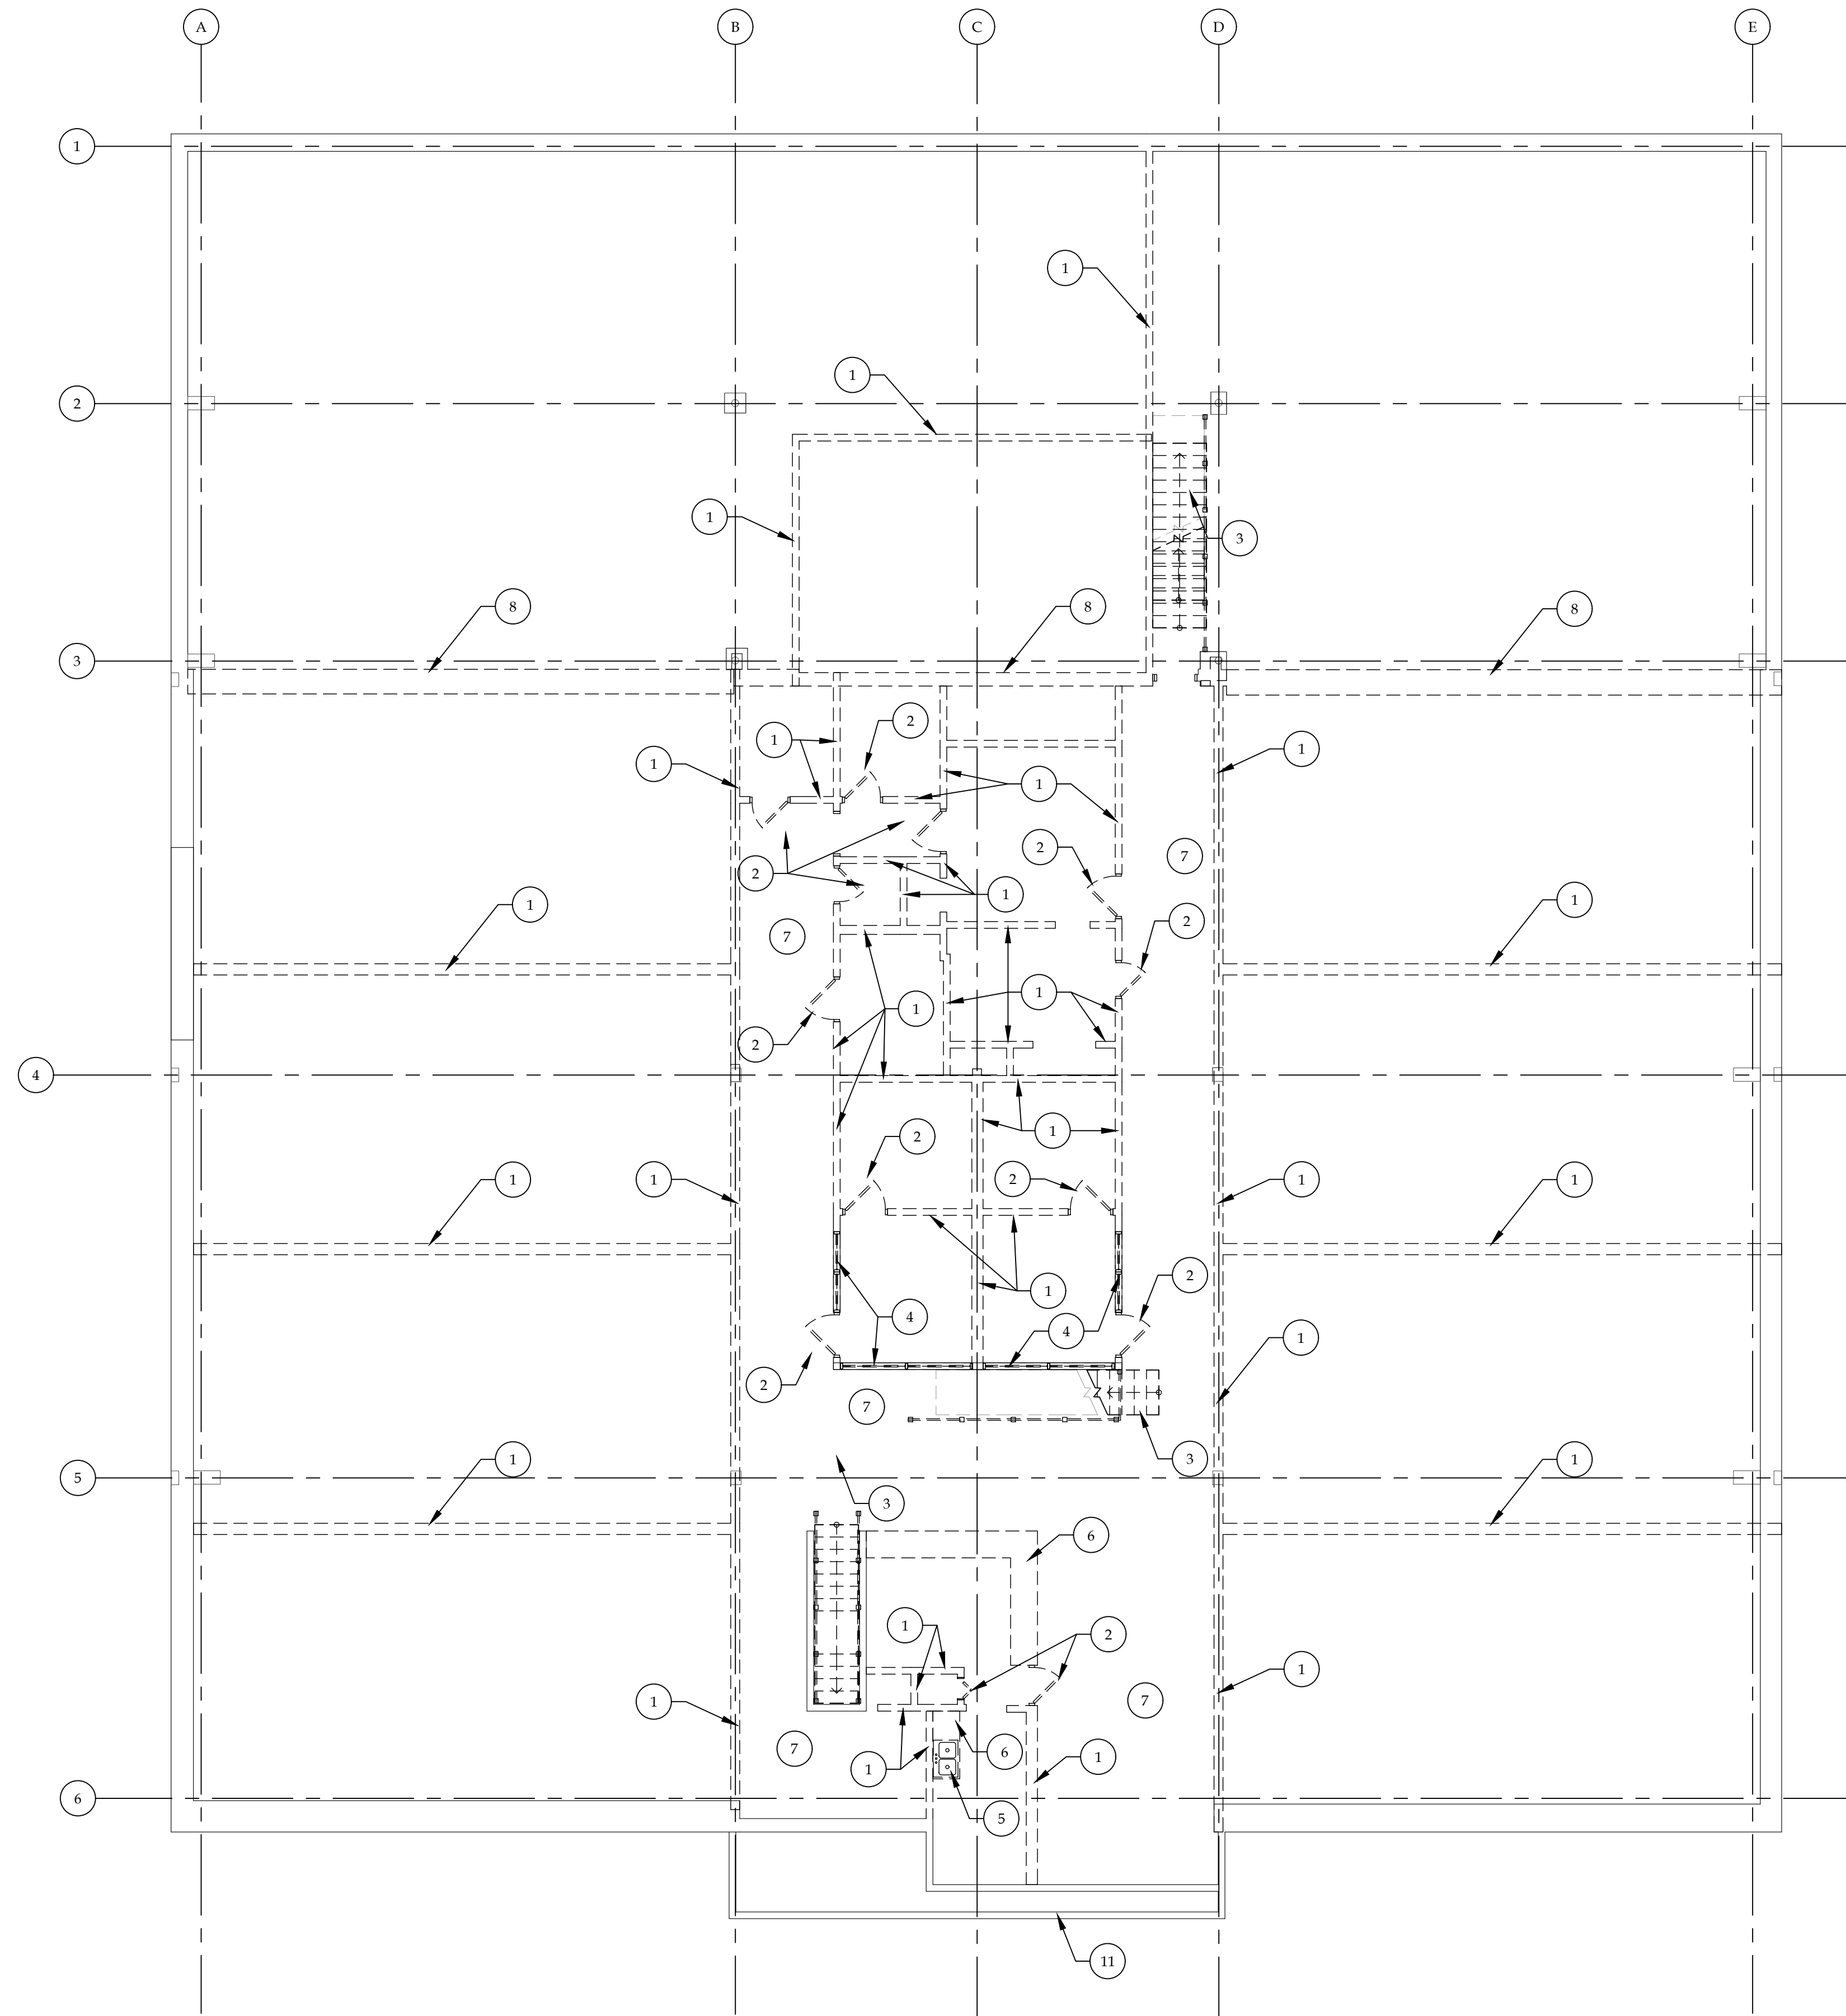

**GENERAL DEMOLITION NOTES**


- IN GENERAL, ITEMS TO BE REMOVED ARE SHOWN DASHED, HOWEVER, CONTRACTOR SHALL REMOVE ALL ITEMS AS REQUIRED TO ALLOW FOR NEW CONSTRUCTION.
- CONTRACTOR IS RESPONSIBLE FOR ALL DEMOLITION TO READY THE SITE/FLOOR FOR NEW CONSTRUCTION.
- CONTRACTOR TO PROTECT ALL EXISTING FINISHES TO REMAIN DURING CONSTRUCTION AND REPLACE DAMAGED FINISHES AS REQUIRED.
- CONTRACTOR TO VERIFY IN FIELD ANY ADDITIONAL DEMOLITION REQUIRED TO PREPARE AREA FOR NEW CONSTRUCTION PER PLANS.

**(X) DEMOLITION PLAN NOTES**

1. REMOVE EXISTING WALL TO THE EXTENT SHOWN. PROVIDE SHORING AS REQUIRED, SEE STRUCTURAL DRAWINGS.
2. REMOVE EXISTING DOOR AND FRAME.
3. REMOVE EXISTING STAIR AND HANDRAIL.
4. REMOVE EXISTING GLAZING.
5. REMOVE EXISTING PLUMBING FIXTURE.
6. REMOVE EXISTING CASEWORK.
7. REMOVE ALL 2ND FLOOR CONCRETE PLANK AND ASSOCIATED SUPPORTS, SEE STRUCTURAL.
8. REMOVE EXISTING WALL TO THE EXTENT SHOWN UP TO 12' CLEAR HIGH. EXISTING COLUMN IN WALL TO REMAIN. PROVIDE SHORING AS REQUIRED, SEE STRUCTURAL DRAWINGS.
9. REMOVE PORTION OF EXISTING WALL FOR NEW OPENING. VERIFY EXACT LOCATION WITH NEW FLOOR PLAN.
10. EXISTING CURTAIN WALL TO BE REMOVED.
11. EXISTING MANSARD ROOF TO BE REMOVED.

| REVISION RECORD |      |         |
|-----------------|------|---------|
| NO.             | DATE | REMARKS |
|                 |      |         |

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**BRYANT & STRATTON COLLEGE**  
1320 Warwick Way  
Mt. Pleasant, WI 53406

SEAL:

**2nd FLOOR DEMOLITION PLAN**

**GREGORY A. TOMSIC**  
REGISTERED ARCHITECT  
145 BATHURST DR., TONAWANDA, N.Y. 14150  
716-433-0617

|                       |                           |
|-----------------------|---------------------------|
| SCALE<br>1/8" = 1'-0" | JOB NO.                   |
| DRAWN                 | DWG. NO.<br><b>AD-102</b> |
| CHECKED               | CONTRACT NO.              |
| DATE<br>12.22.2017    |                           |

| REVISION RECORD |            |                         |
|-----------------|------------|-------------------------|
| NO.             | DATE       | REMARKS                 |
| #1              | 01.03.2018 | ADDENDUM #1             |
| #2              | 01.10.2018 | ADDENDUM #2             |
| #3              | 02.19.2018 | ADDENDUM #3<br>POST BID |

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1320 Warwick Way  
Mt. Pleasant, WI 53406

SEAL:

**FLOOR PLAN**

GREGORY A. TOMSIC  
REGISTERED ARCHITECT  
145 BATHURST DR., TONAWANDA, N.Y. 14150  
716-433-0617


|                       |                          |
|-----------------------|--------------------------|
| SCALE<br>1/8" = 1'-0" | JOB NO.                  |
| DRAWN                 | DWG. NO.<br><b>A-101</b> |
| CHECKED               | CONTRACT NO.             |
| DATE<br>12.22.2017    |                          |

- GENERAL NOTES:**
- ALL INTERIOR DIMENSIONS ARE TAKEN FINISH TO FINISH UNLESS NOTED OTHERWISE.
  - PROVIDE MOISTURE & MOLD RESISTANT GYP. BD. AT ALL WET LOCATIONS.
  - RECESSED WALL FIXTURE SUCH AS CABINETS, OUTLETS, AND OTHER ITEMS WHICH PENETRATE THE GYPSUM BOARD SURFACE SHOULD NOT BE LOCATED BACK TO BACK IN THE SAME STUD CAVITY.
  - ANY OPENINGS CUT FOR ANY FIXTURES SHALL BE CAREFULLY CUT TO SIZE, PROPERLY FASTENED, INSULATED PER WALL ASSEMBLY AND PROPERLY CAULKED.
  - ALL SURFACE MOUNTED CONDUIT SHALL BE PAINTED TO MATCH THE WALL PAINT.
  - ALL PENETRATIONS THROUGH THE PARTITION SHALL BE SEALED ALL AROUND ON BOTH SIDES OF WALL TO ELIMINATE GAPS BETWEEN THE PENETRATION AND WALL. ALL CABLE/WIRE PENETRATIONS SHALL PENETRATE THE WALL W/ SLEEVE.
  - PARTITIONS SHALL BE SEALED CONTINUOUSLY WITH AN ACOUSTICAL SEALANT WHEREVER IT ABUTS ANOTHER ELEMENT (I.E. WALL, COLUMN, FLOOR OR CEILING SLAB, OR MULLION.)
  - PROVIDE GYP. BD. CORNER PROTECTION STRIPS TO +54" A.F.F. AT ALL OUTSIDE CORNERS.
  - GWB FINISH LEVEL 4, PRIMED + (2) FINISH COATS SLAB TO CEILING. PROVIDE FINISH LEVEL 3 ABOVE CEILING. JOINTS BETWEEN GWB AND PLYWOOD SHALL BE STAGGERED.
  - PROVIDE FIRE SAFE NON-SHRINK GROUT AT ALL VOIDS IN EXCESS OF 1/2" AT UNDERSIDE OF RUNNER TRACKS INSTALLED ON CONCRETE DECKS.
  - COORDINATE ALL MECHANICAL, PLUMBING & ELECTRICAL WORK WITH M.E.P. CONTRACTORS & OWNER.
  - ALL FULL HEIGHT WALLS TO BE SMOKE TIGHT TO DECK.

**FLOOR PLAN SYMBOL LEGEND**

- = EXISTING WALL TO BE REMOVED (SEE DEMOLITION FLOOR PLAN, AD-101)
- = EXISTING WALL TO REMAIN
- = INDICATES NEW WALL CONSTRUCTION (SEE PARTITION TYPES ON A-004)
- = EXISTING DOOR TO BE REMOVED (SEE DEMOLITION FLOOR PLAN, AD-101)
- = EXISTING DOOR TO REMAIN
- = NEW DOOR
- = DOOR NUMBER (SEE DOOR SCHED.)
- = INDICATES PARTITION WALL TYPE (SEE SHEET A-004 FOR PARTITION DETAILS)
- = NEW INTERIOR WINDOW
- X = WINDOW NUMBER (SEE DETAILS ON A-601)
- FE = FIRE EXTINGUISHER

SEE ENLARGED PARTIAL FLOOR PLANS ON SHEETS: A-102 & A-103

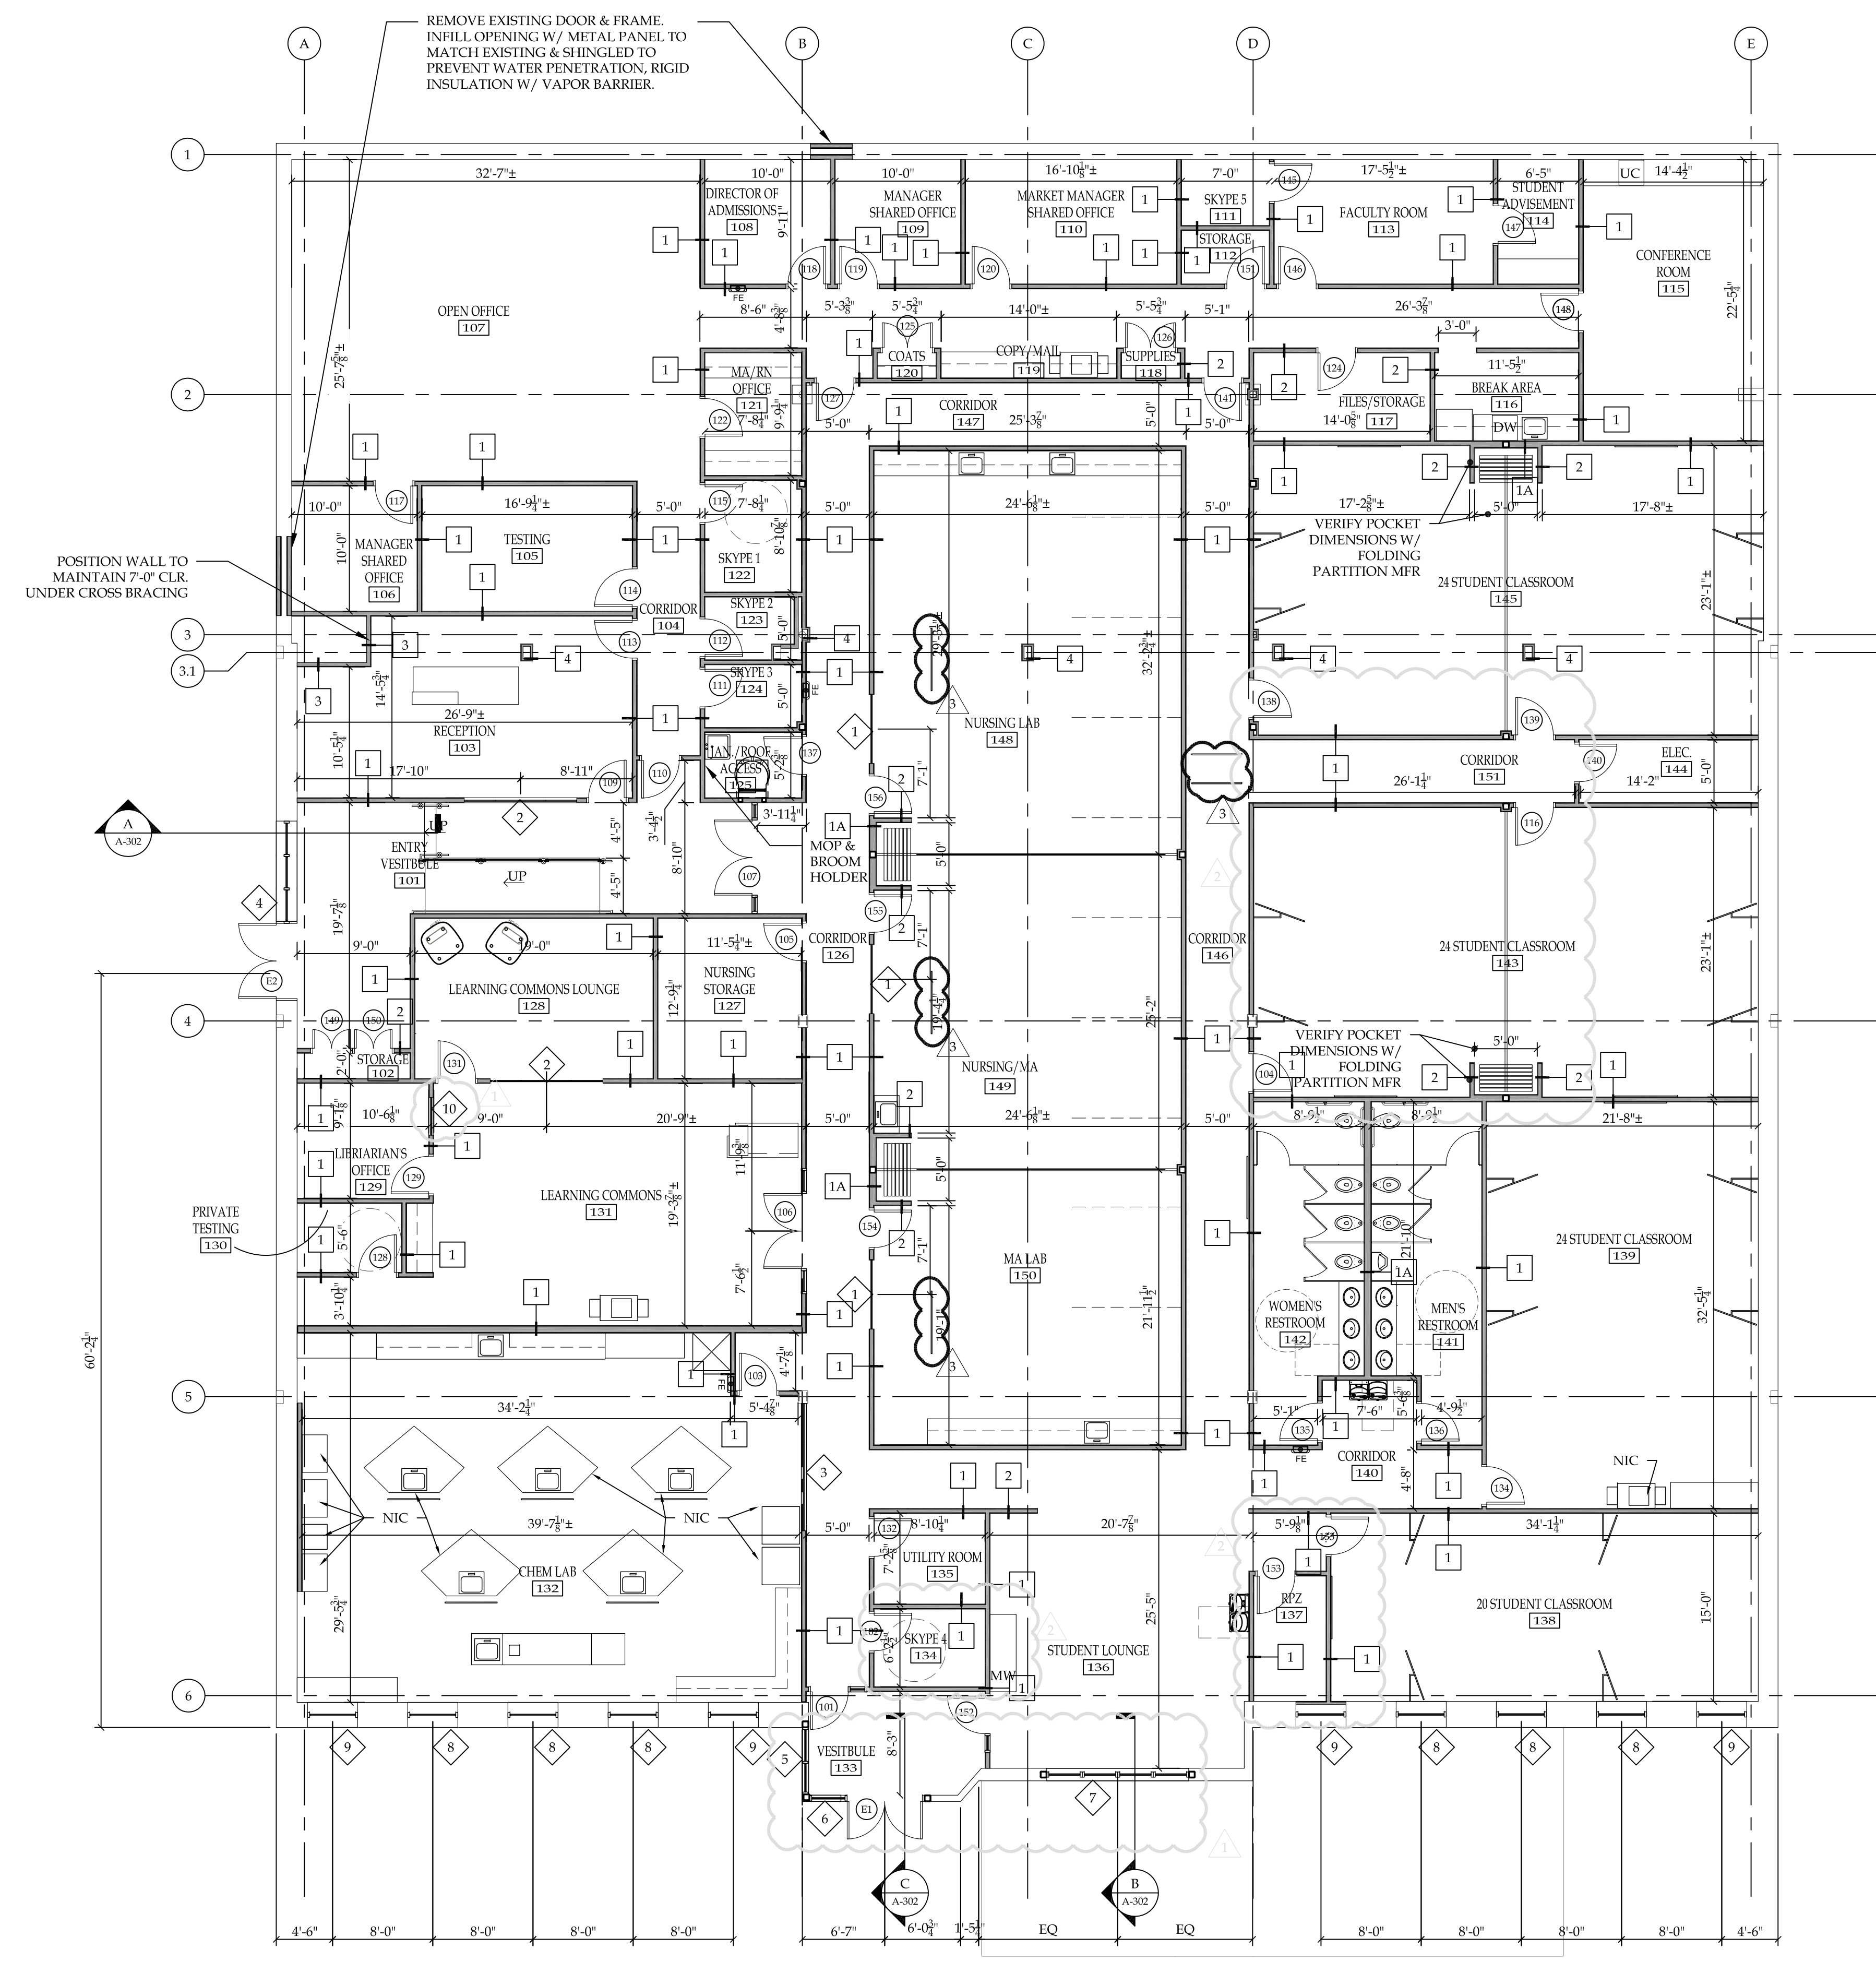

**1 FLOOR PLAN**  
SCALE: 1/8" = 1'-0"




| REVISION RECORD |            |             |
|-----------------|------------|-------------|
| NO.             | DATE       | REMARKS     |
| #2              | 01.10.2018 | ADDENDUM #2 |

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 1320 Warwick Way  
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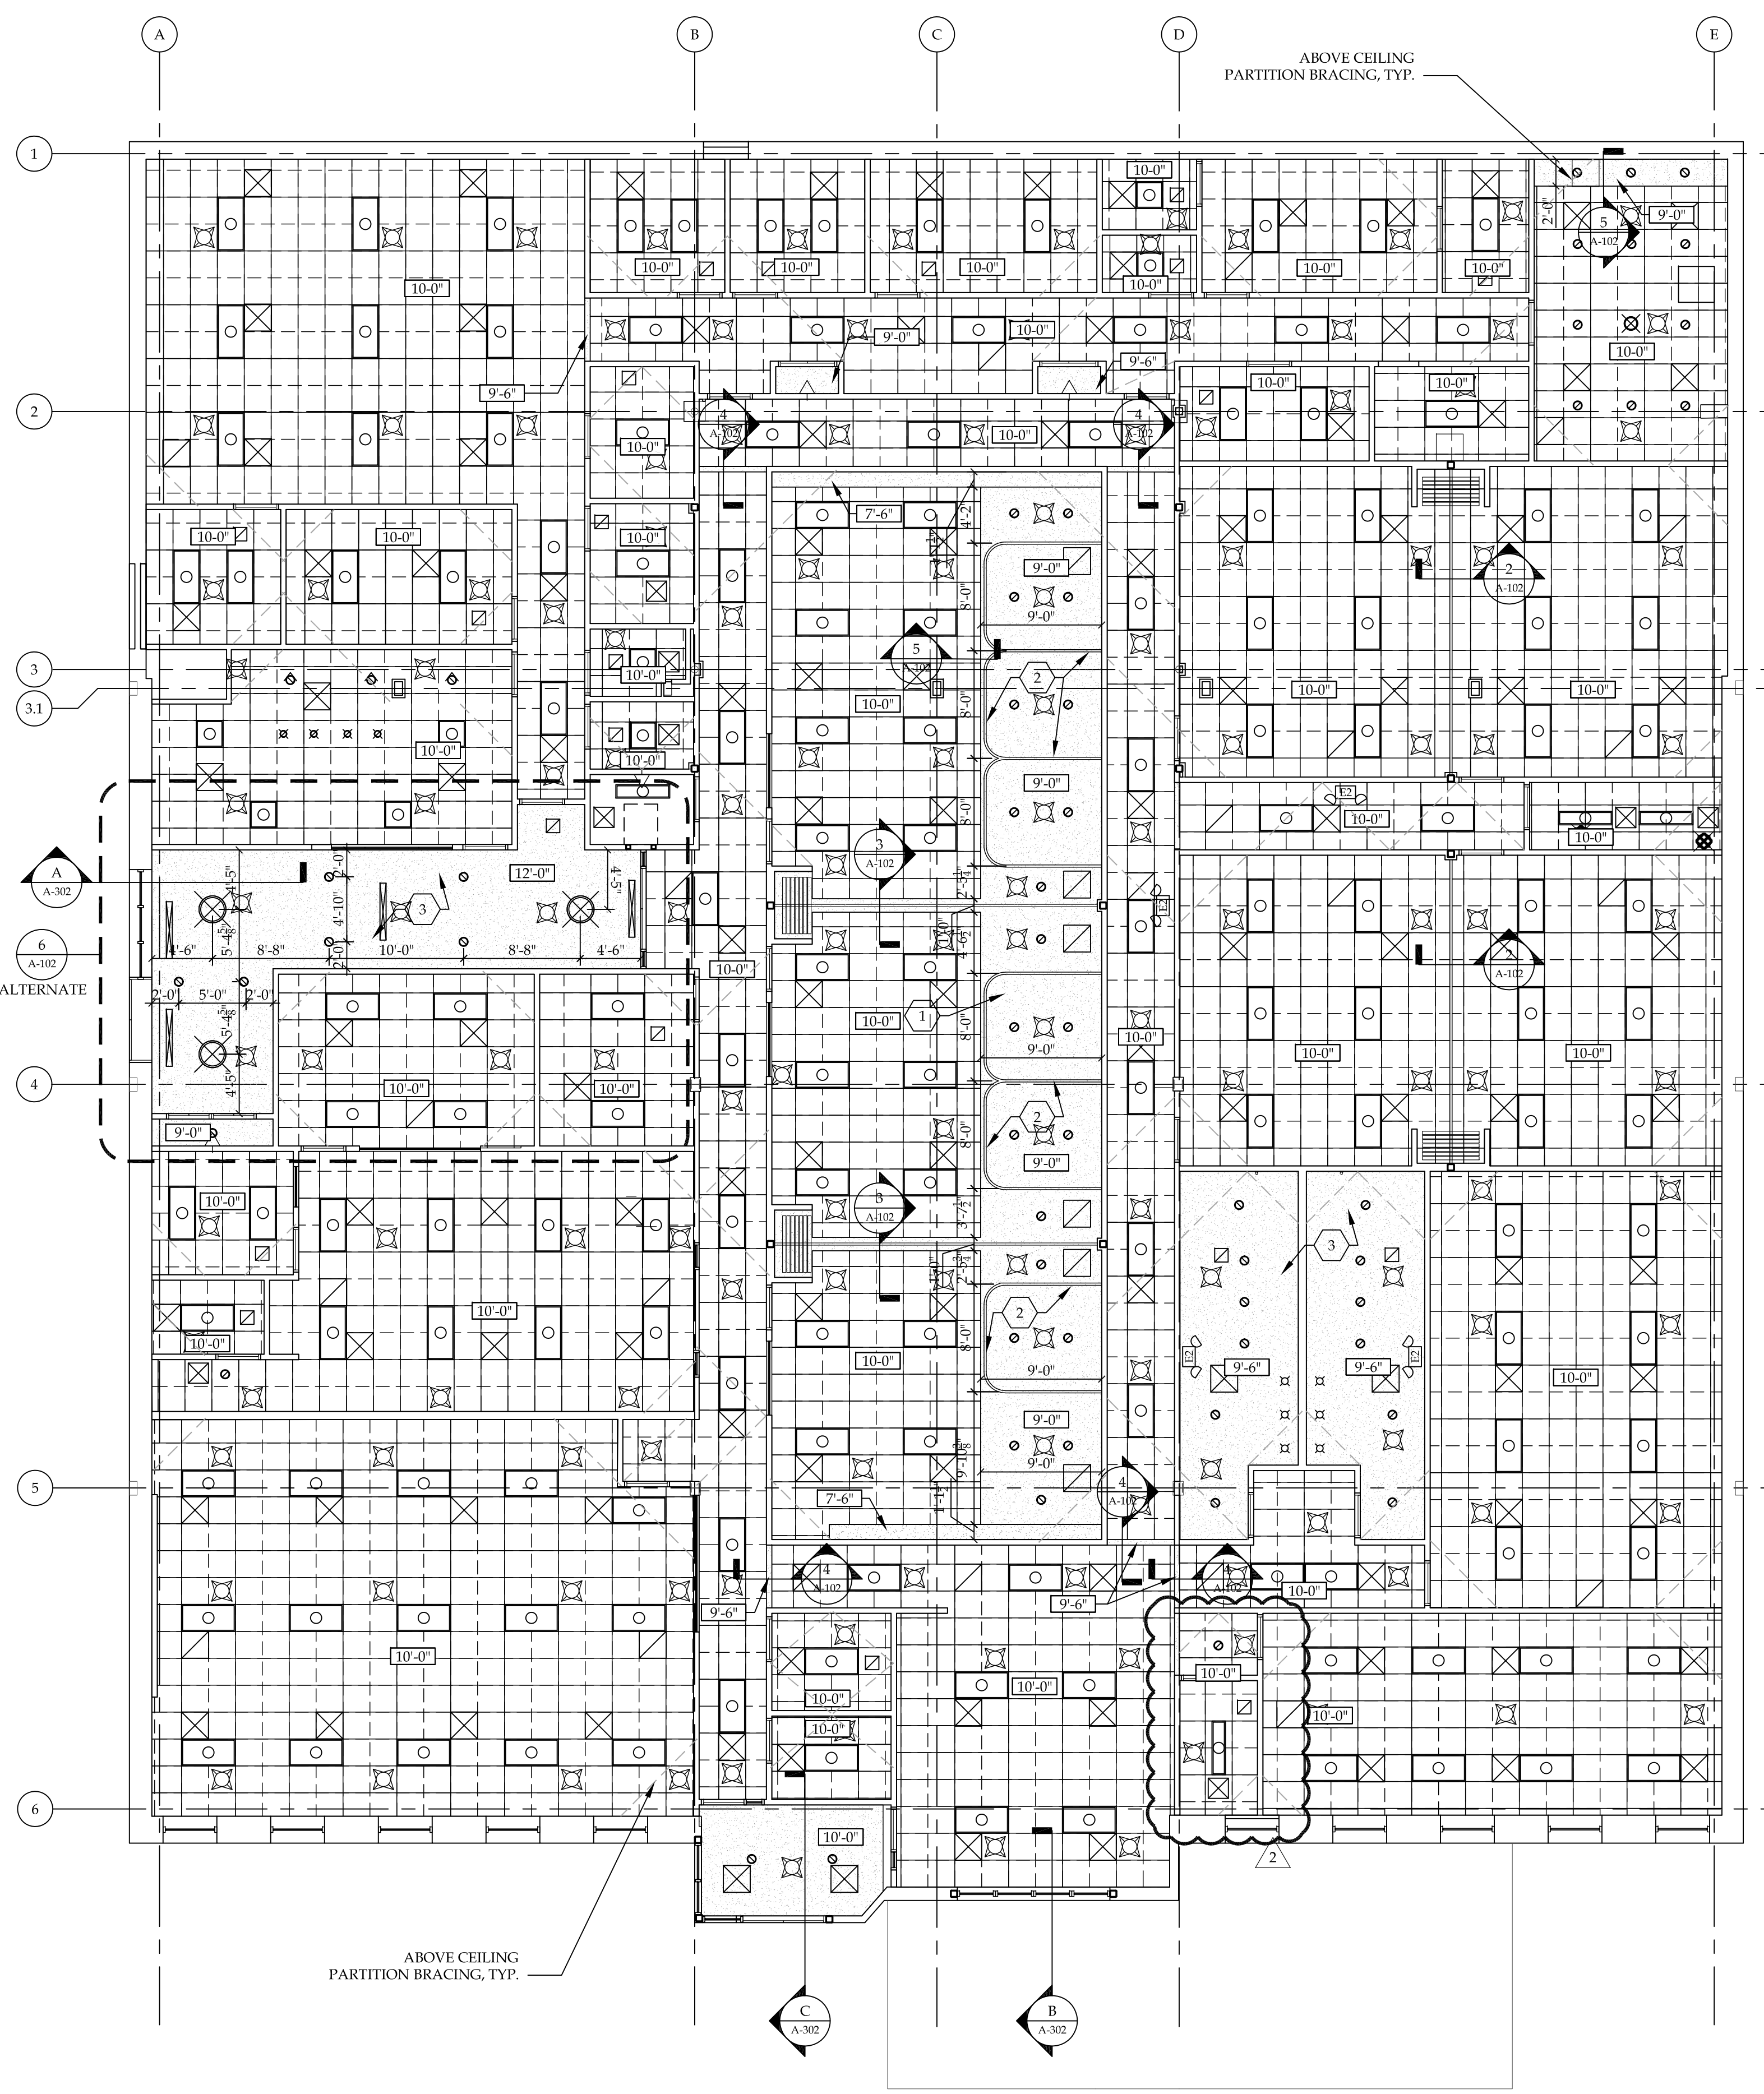
**REFLECTED CEILING PLAN**

**GREGORY A. TOMASIC**  
 REGISTERED ARCHITECT  
 145 BATHURST DR., TONAWANDA, N.Y. 14150  
 716-435-0617


|                       |                          |
|-----------------------|--------------------------|
| SCALE<br>1/8" = 1'-0" | JOB NO.                  |
| DRAWN                 | DWG. NO.<br><b>A-102</b> |
| CHECKED               | CONTRACT NO.             |
| DATE<br>12.22.2017    |                          |
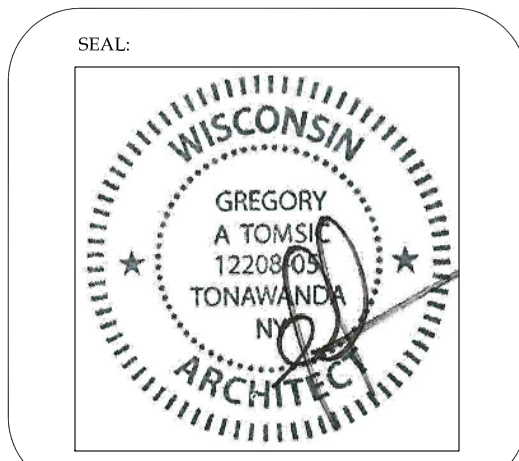
| REFLECTED CEILING SYMBOL LEGEND |  |  |  |
|---------------------------------|--|--|--|
|                                 | SUSPENDED ACOUSTIC CEILING                                       |  | 2 x 4' LIGHT FIXTURE   |
|                                 | GYPSON BOARD CEILING OR SOFFIT                                   |  | 2 x 2' LIGHT FIXTURE   |
|                                 | EXIT SIGNAGE - NEW OR RELOCATED, (SEE MEP & FP DWGS.)            |  | 1' x 4' LIGHT FIXTURE  |
|                                 | EMERGENCY LIGHT FIXTURE - NEW OR RELOCATED, (SEE MEP & FP DWGS.) |  | RECESSED CAN LIGHT   |
|                                 | CLOUD CEILING SEE DETAIL 6/A-102<br>**ALTERNATE**                |  | SUPPLY OR RETURN DIFFUSER - NEW OR RELOCATED, (MATCH EXISTING) |
|                                 |  |  | SPRINKLER HEAD   |


- # REFLECTED CEILING KEY NOTES:
- SUSPENDED GYP. CEILING, PROVIDE ADDITIONAL SUPPORTS, BLOCKING AND HANGER CABLES @ CURTAINS, TYP.
  - CEILING MOUNTED CURTAIN
  - FRAMED GYP. CEILING, INSTALL 5/8" GYPSON BOARD OVER 8" 18 GA. CEILING JOISTS @ 16" O.C. MAX.




**1 REFLECTED CEILING PLAN**  
 SCALE: 1/8" = 1'-0"

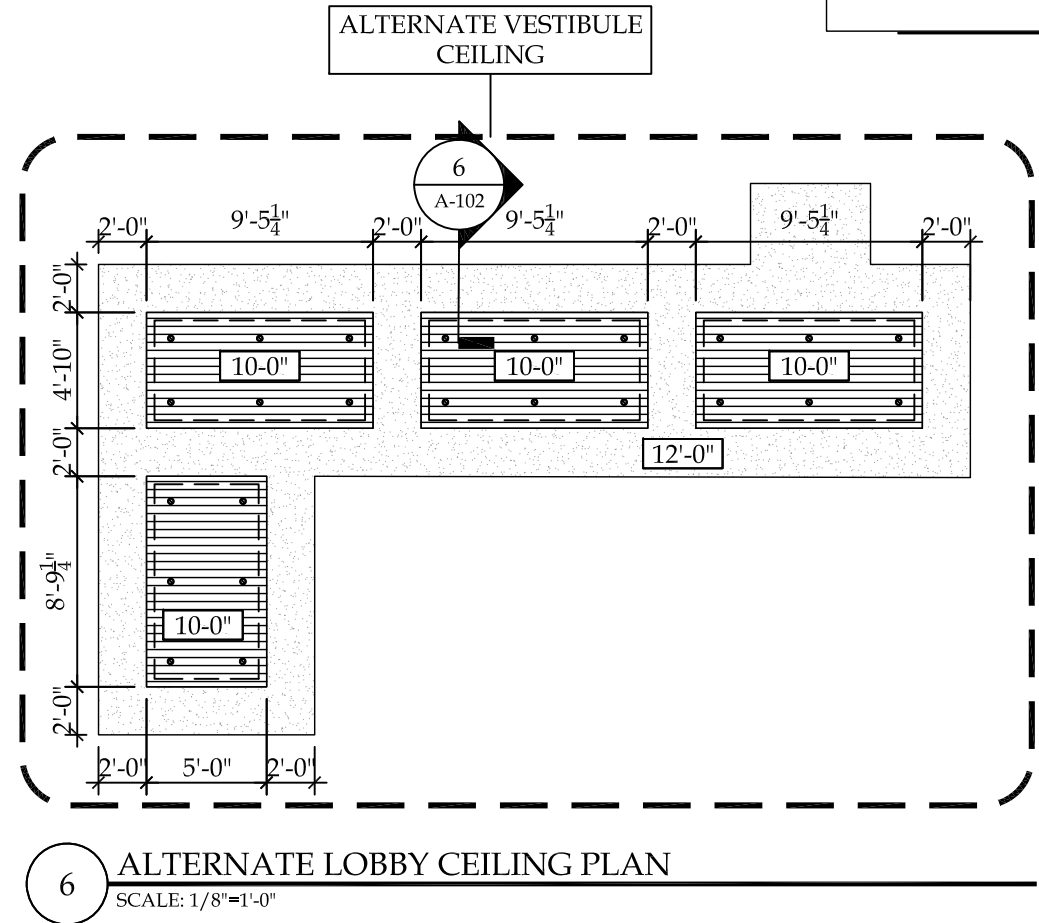


**6 ALTERNATE LOBBY CEILING PLAN**  
 SCALE: 1/8" = 1'-0"

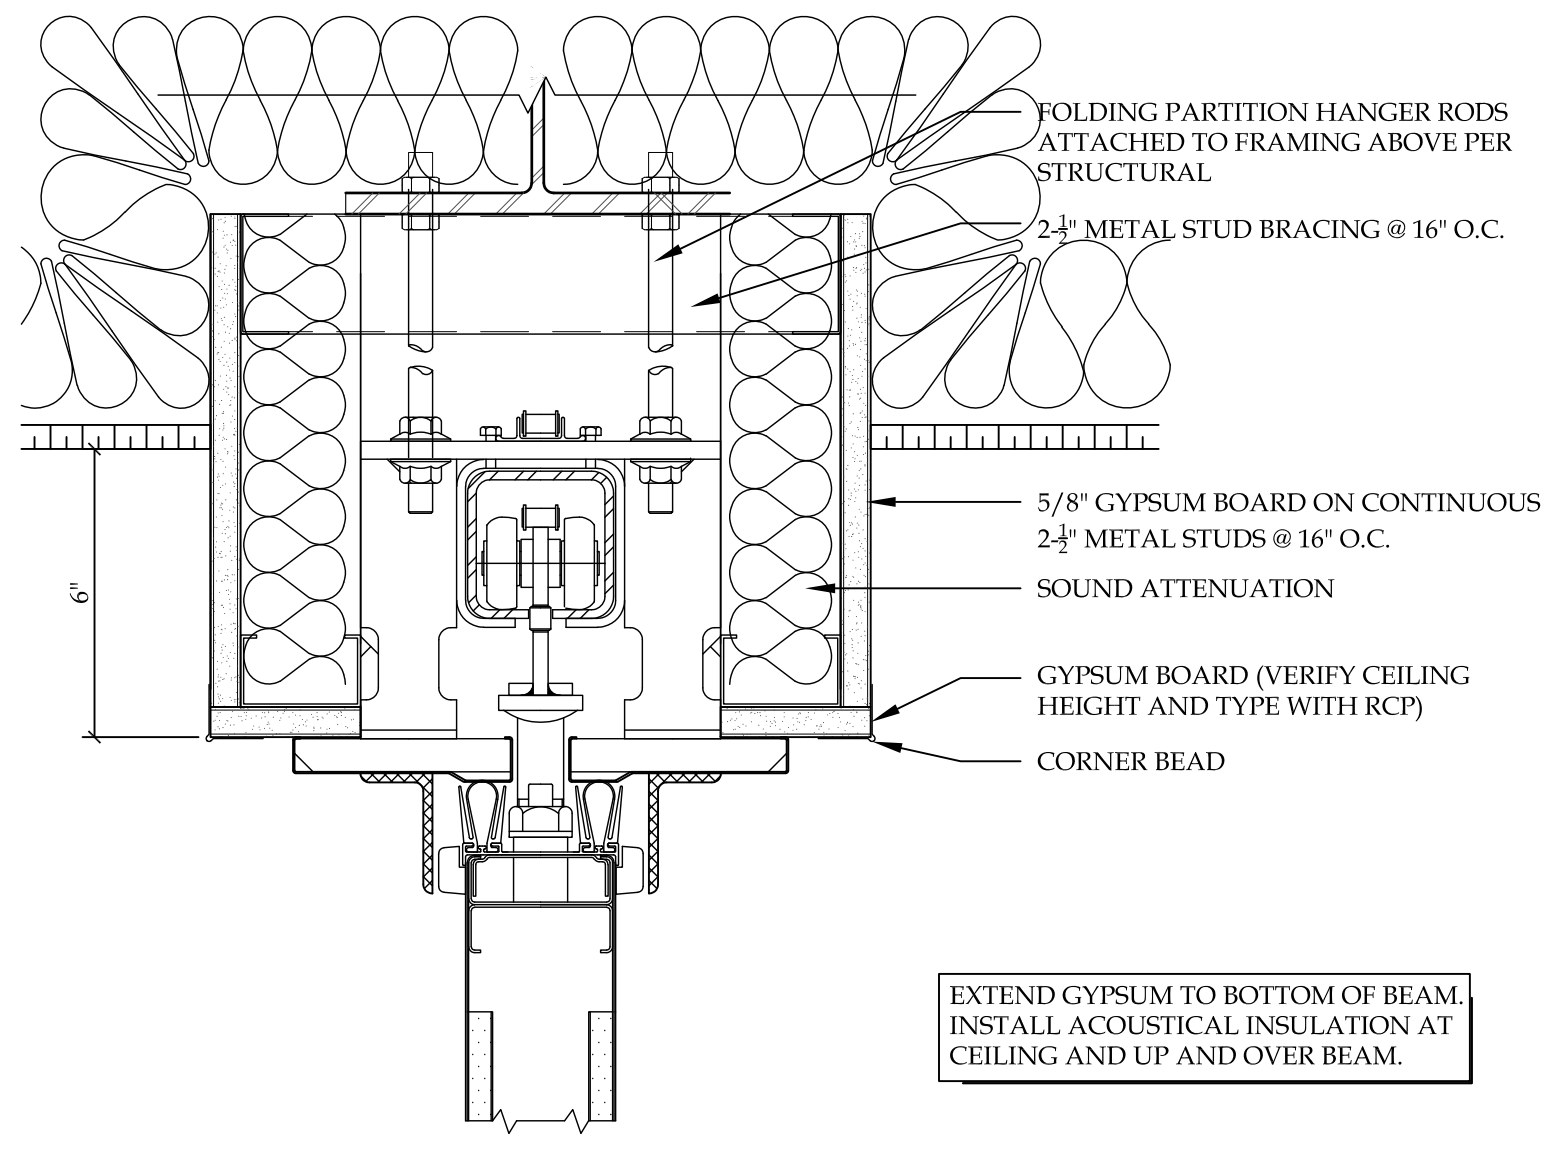


**3 OPERABLE PARTITION DETAIL**  
 SCALE: 3/4" = 1'-0"

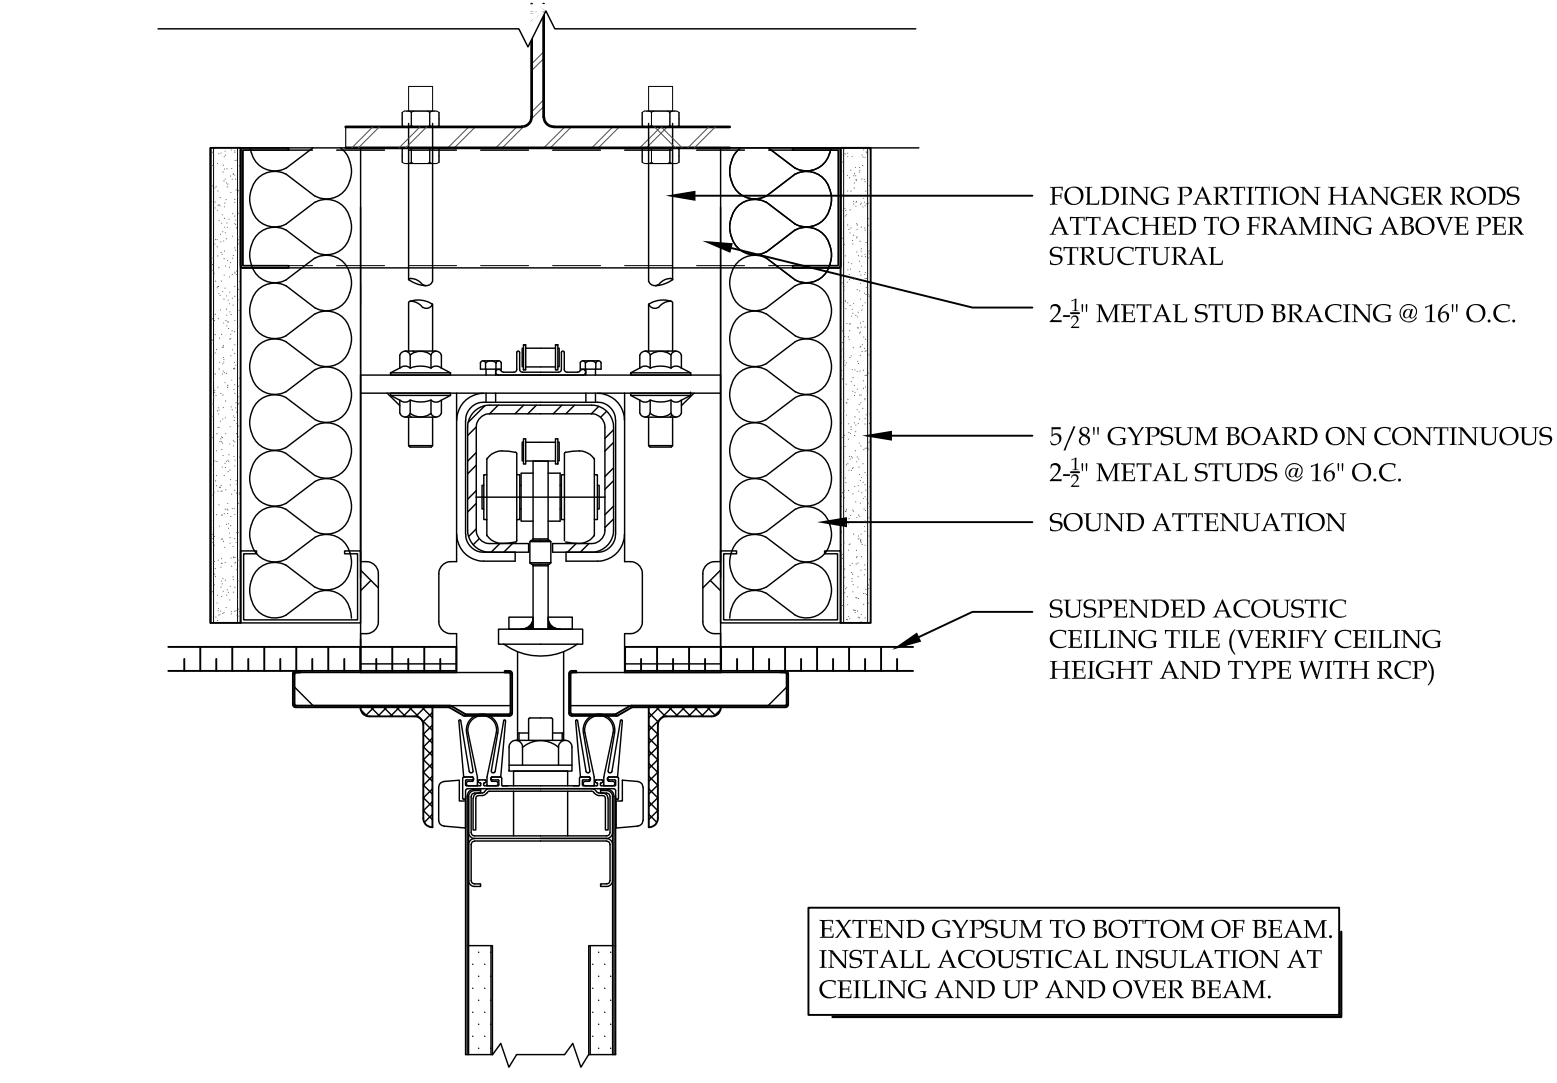


**2 OPERABLE PARTITION DETAIL**  
 SCALE: 3/4" = 1'-0"

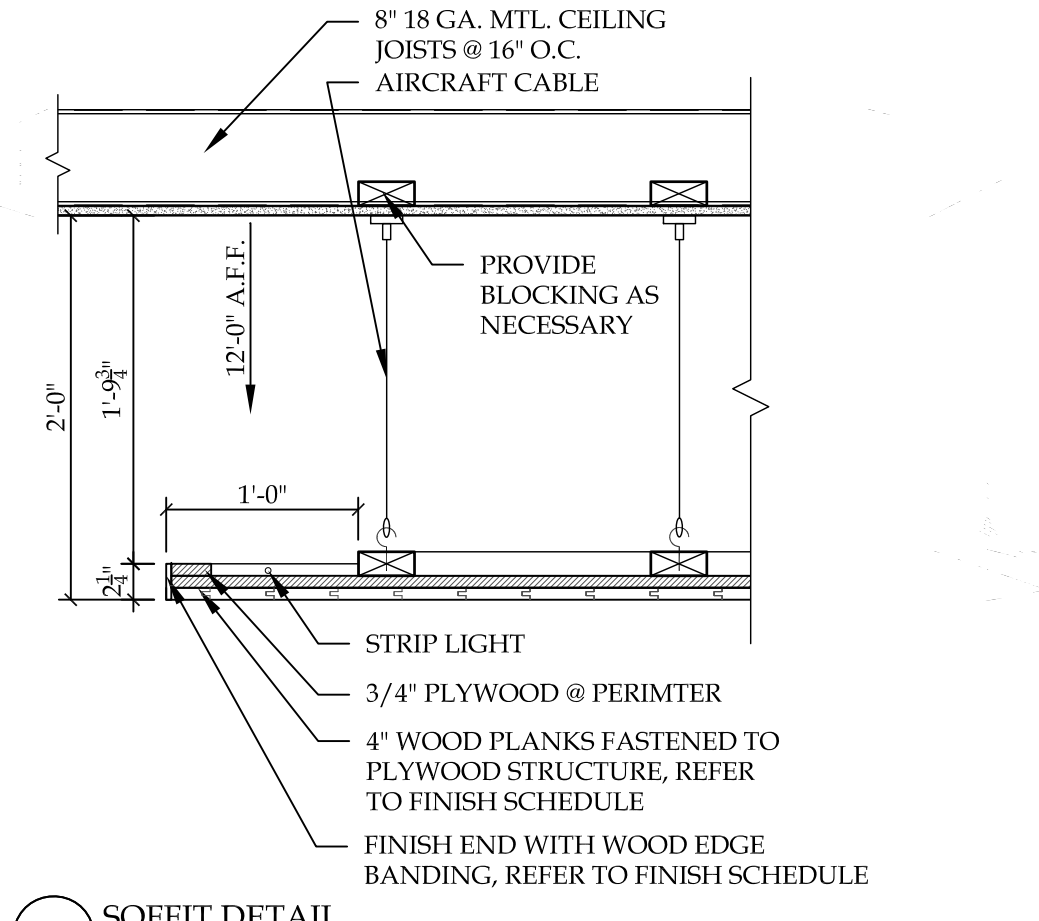

**7 SOFFIT DETAIL**  
 SCALE: 1" = 1'-0"

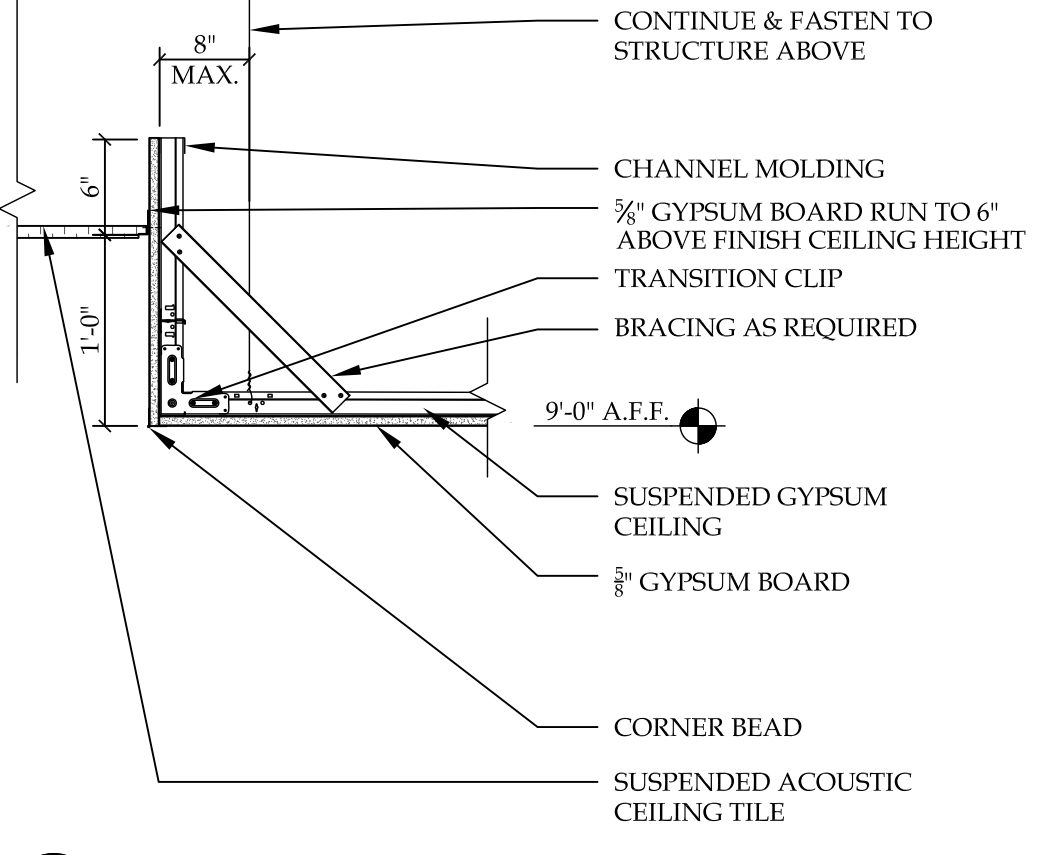

**5 SOFFIT DETAIL**  
 SCALE: 1" = 1'-0"

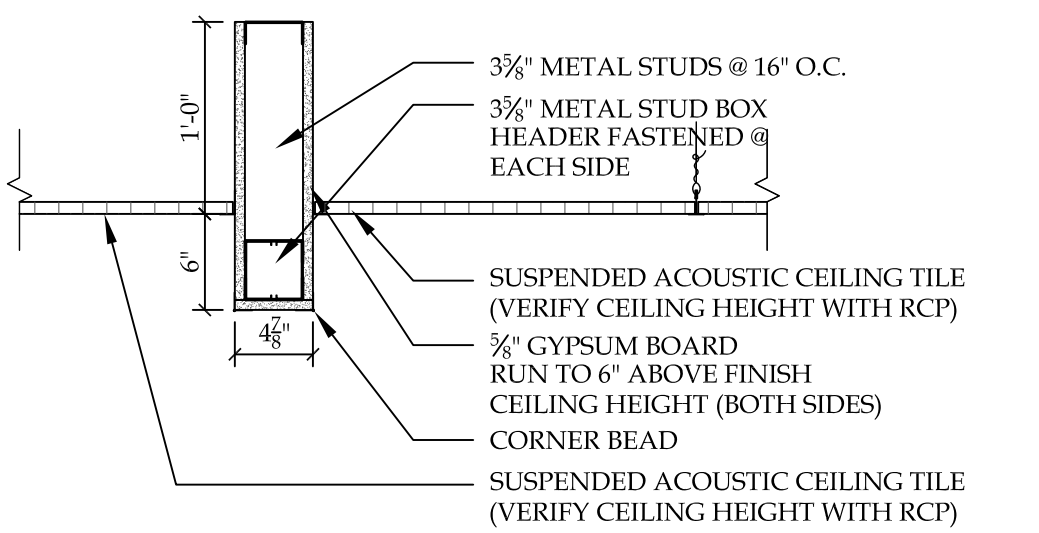

**4 SOFFIT DETAIL**  
 SCALE: 1" = 1'-0"




| REVISION RECORD |            |             |
|-----------------|------------|-------------|
| NO.             | DATE       | REMARKS     |
| #1              | 09.06.2017 | ADDENDUM #1 |
| #2              | 01.10.2018 | ADDENDUM #2 |

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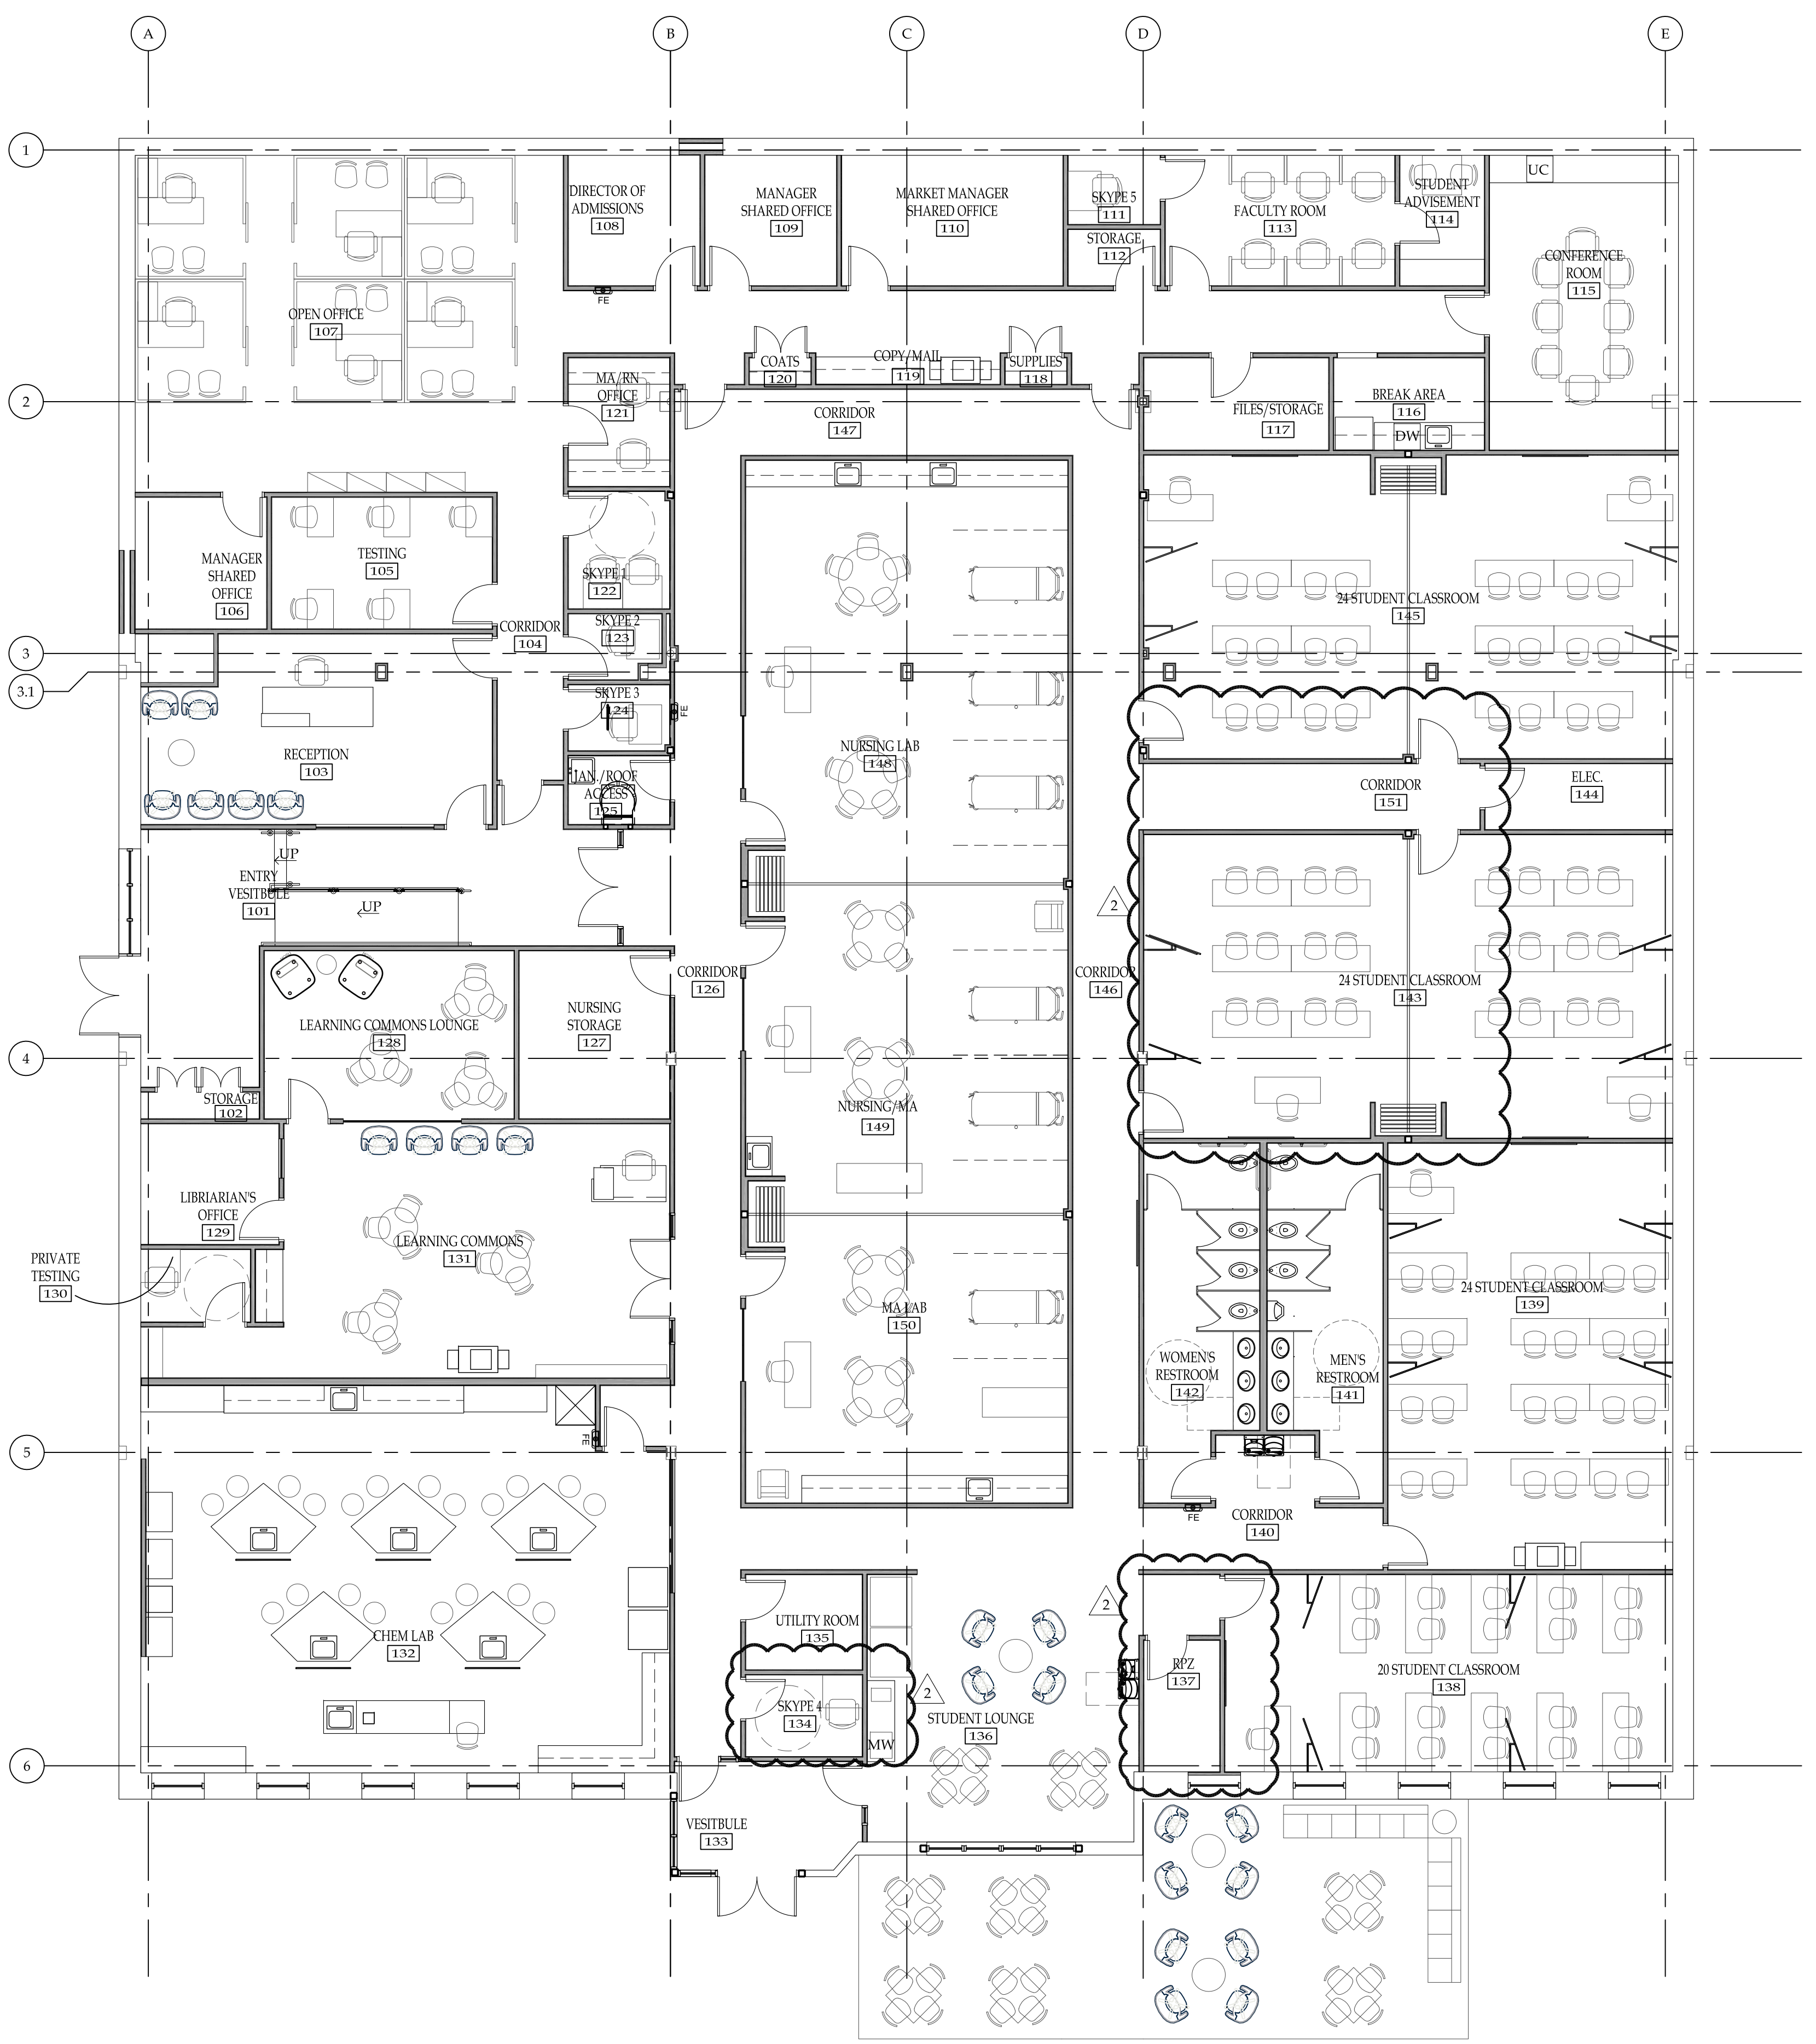
**BRYANT & STRATTON COLLEGE**  
 1320 Warwick Way  
 Mt. Pleasant, WI 53406




**SPACE ALLOCATION PLAN**  
 (FOR REFERENCE ONLY)

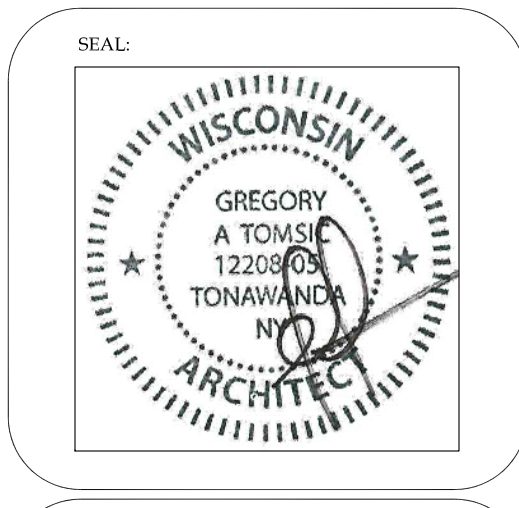**GREGORY A. TOMSIC**  
 REGISTERED ARCHITECT  
 145 BATHURST DR., TONAWANDA, N.Y. 14150  
 716-433-0617


|                       |                          |
|-----------------------|--------------------------|
| SCALE<br>1/8" = 1'-0" | JOB NO.                  |
| DRAWN                 | DWG. NO.<br><b>A-103</b> |
| CHECKED               | CONTRACT NO.             |
| DATE<br>12.22.2017    |                          |



**1 SPACE ALLOCATION PLAN**  
 SCALE: 1/8" = 1'-0"

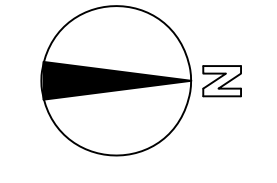




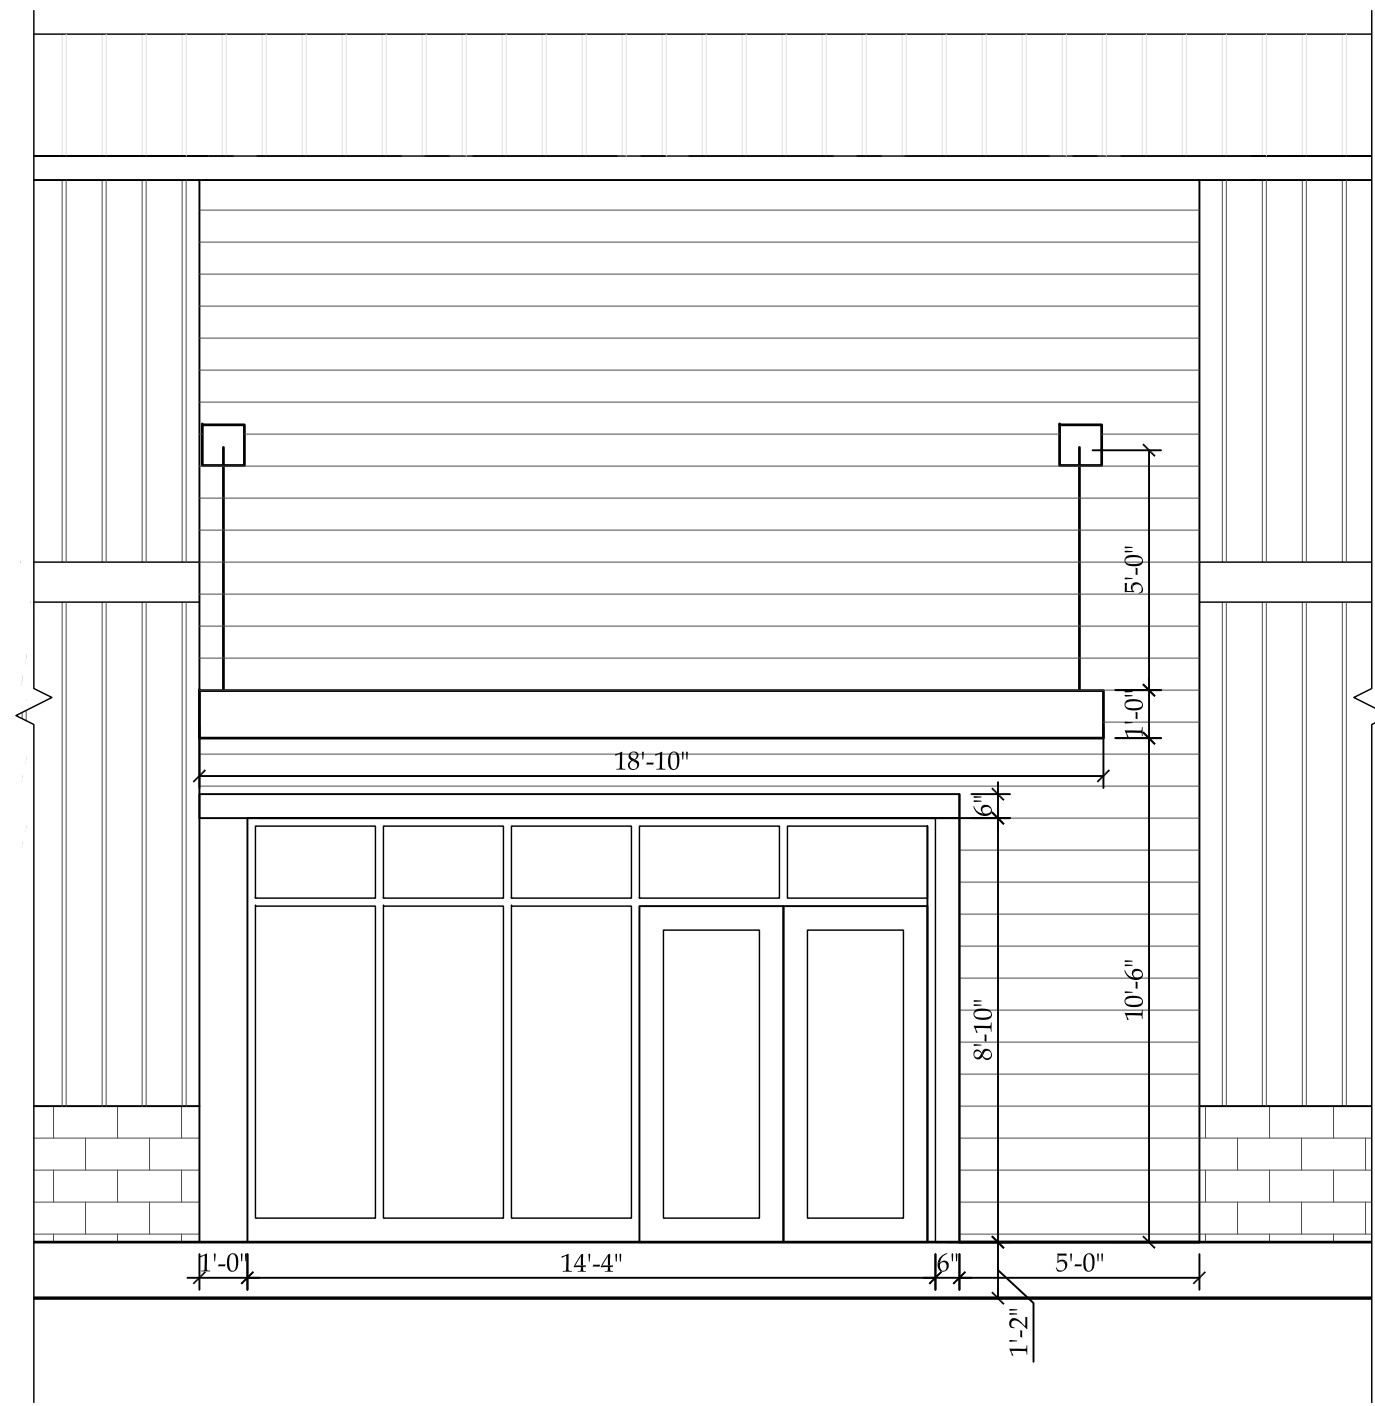


3 ENLARGED EXTERIOR ELEVATION  
SCALE: 1/4"=1'-0"

COLOR 1: SW7019 GAUNTLET GRAY  
 COLOR 2: SW9170 ACIER  
 COLOR 3: SW7015 REPOSE GRAY


PATCH & REPAIR ALL AREAS AS REQUIRED. FINISH FLUSH TO EXISTING. PREPARE SURFACES AS REQUIRED TO RECEIVE PAINT FINISH SPECIFIED.

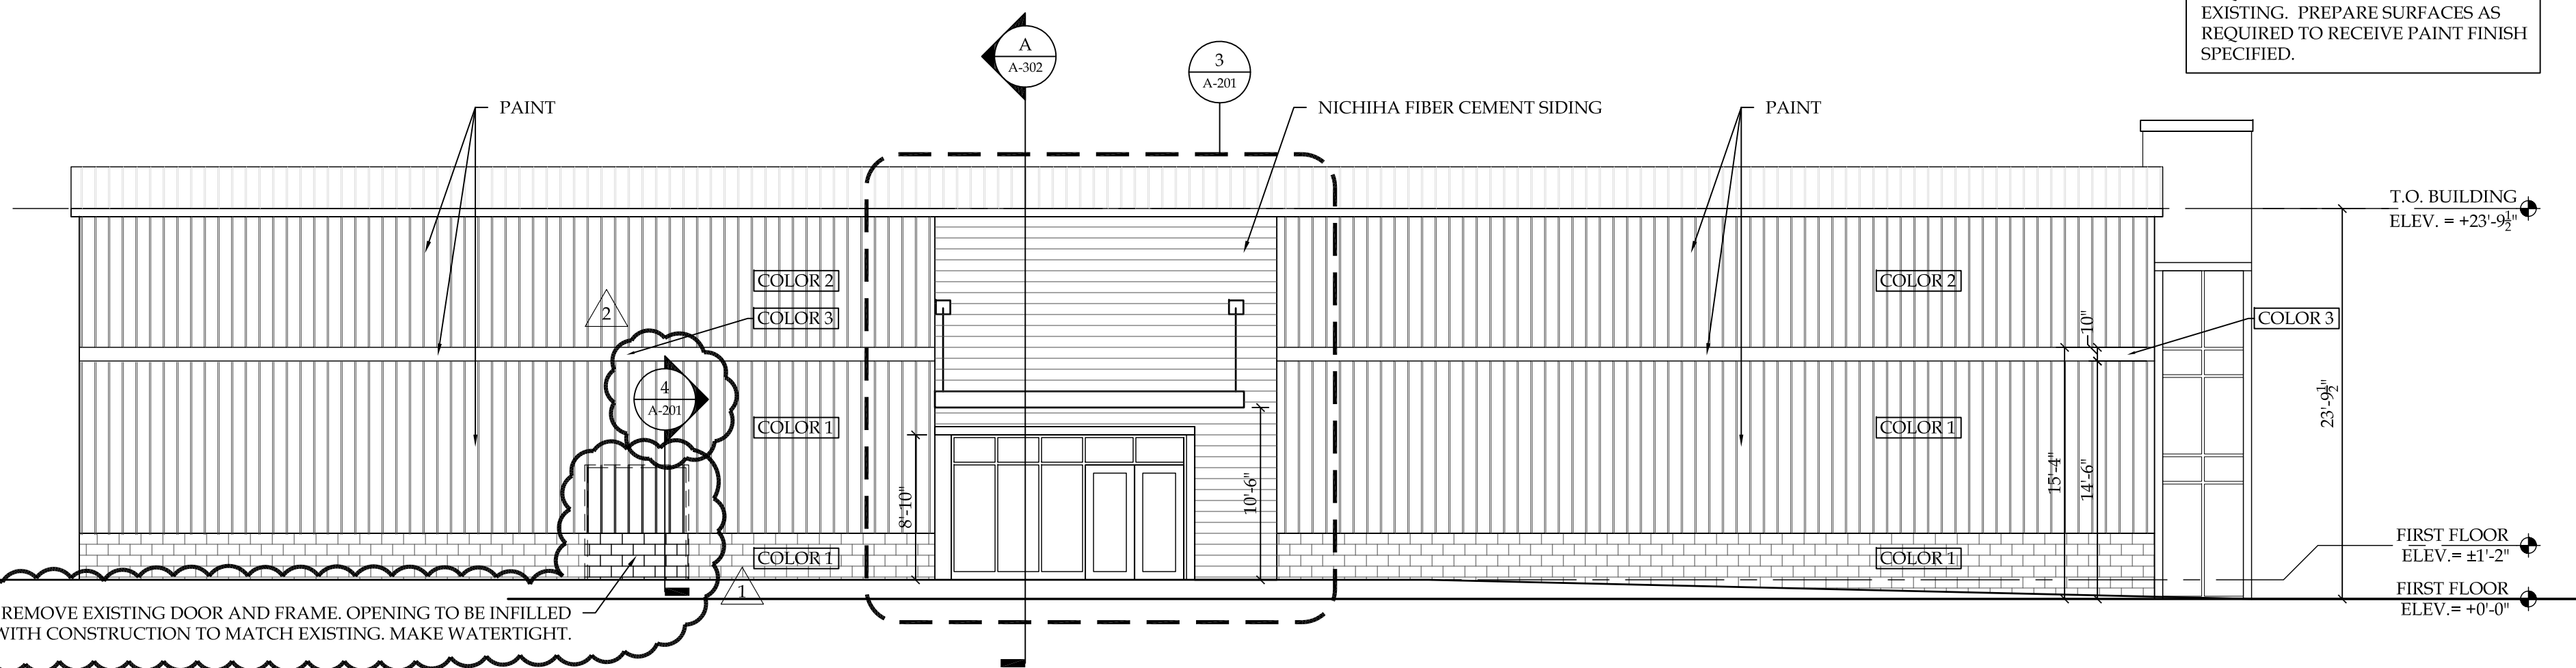


2 LEFT SIDE ELEVATION  
SCALE: 1/8"=1'-0"

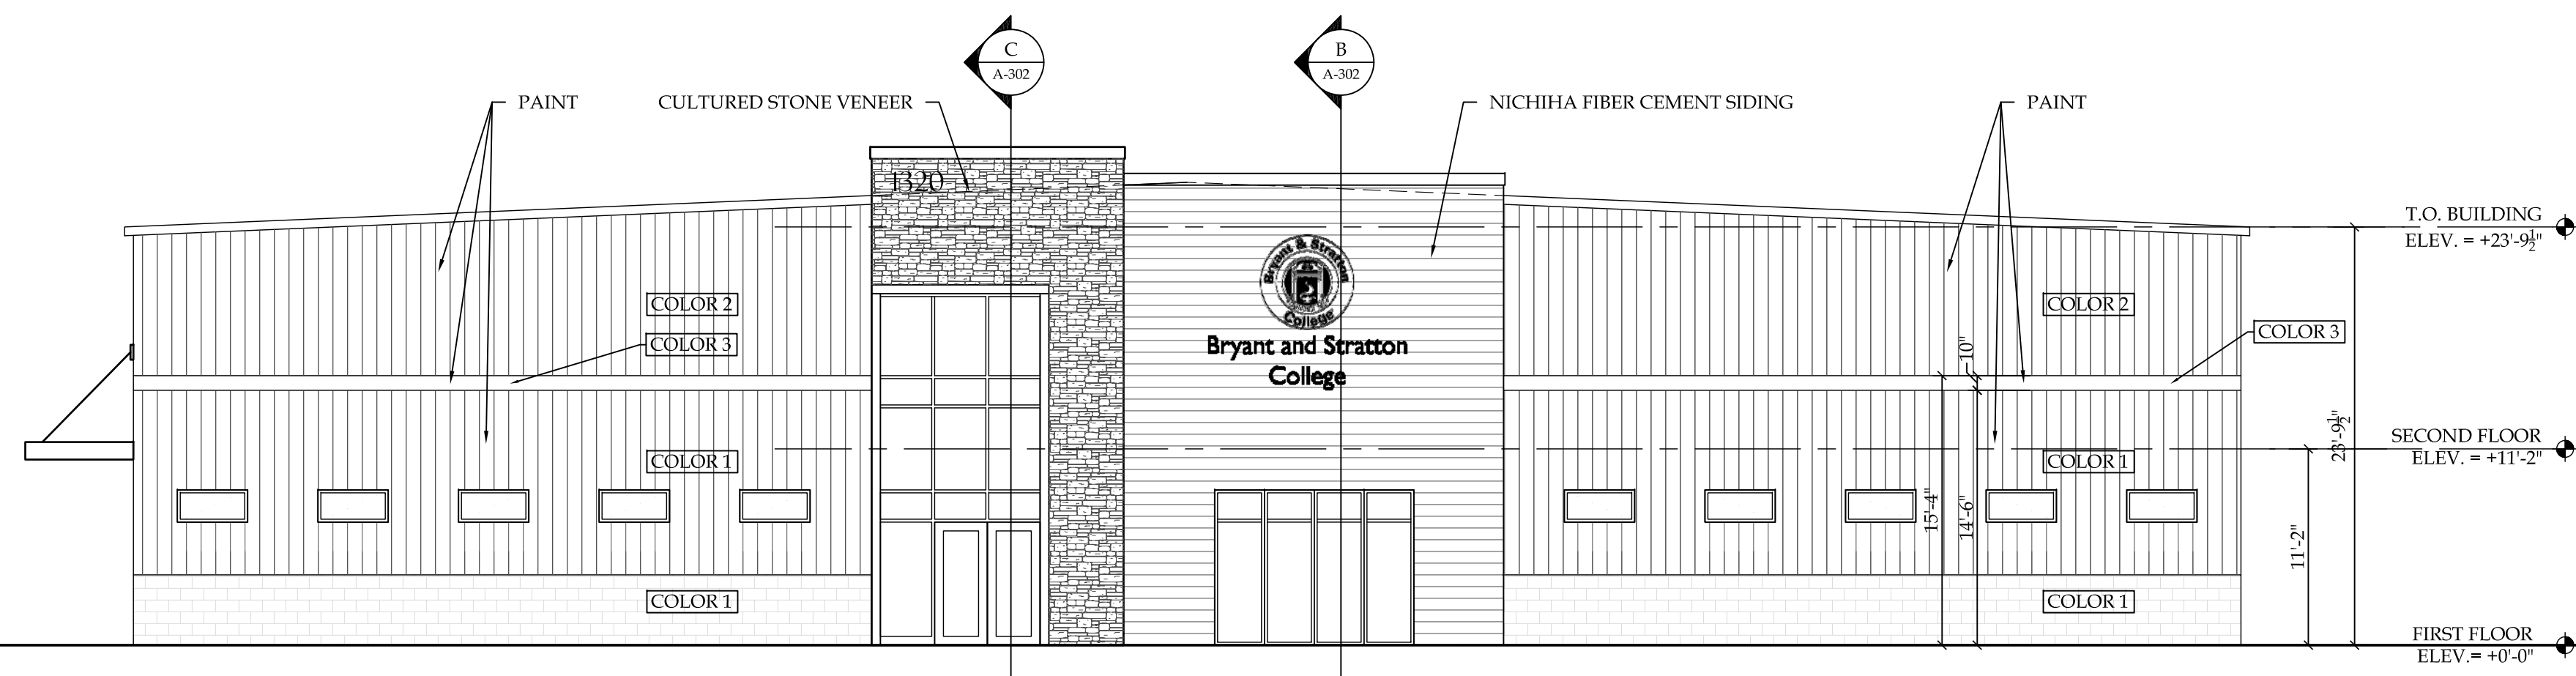


1 FRONT ELEVATION  
SCALE: 1/8"=1'-0"

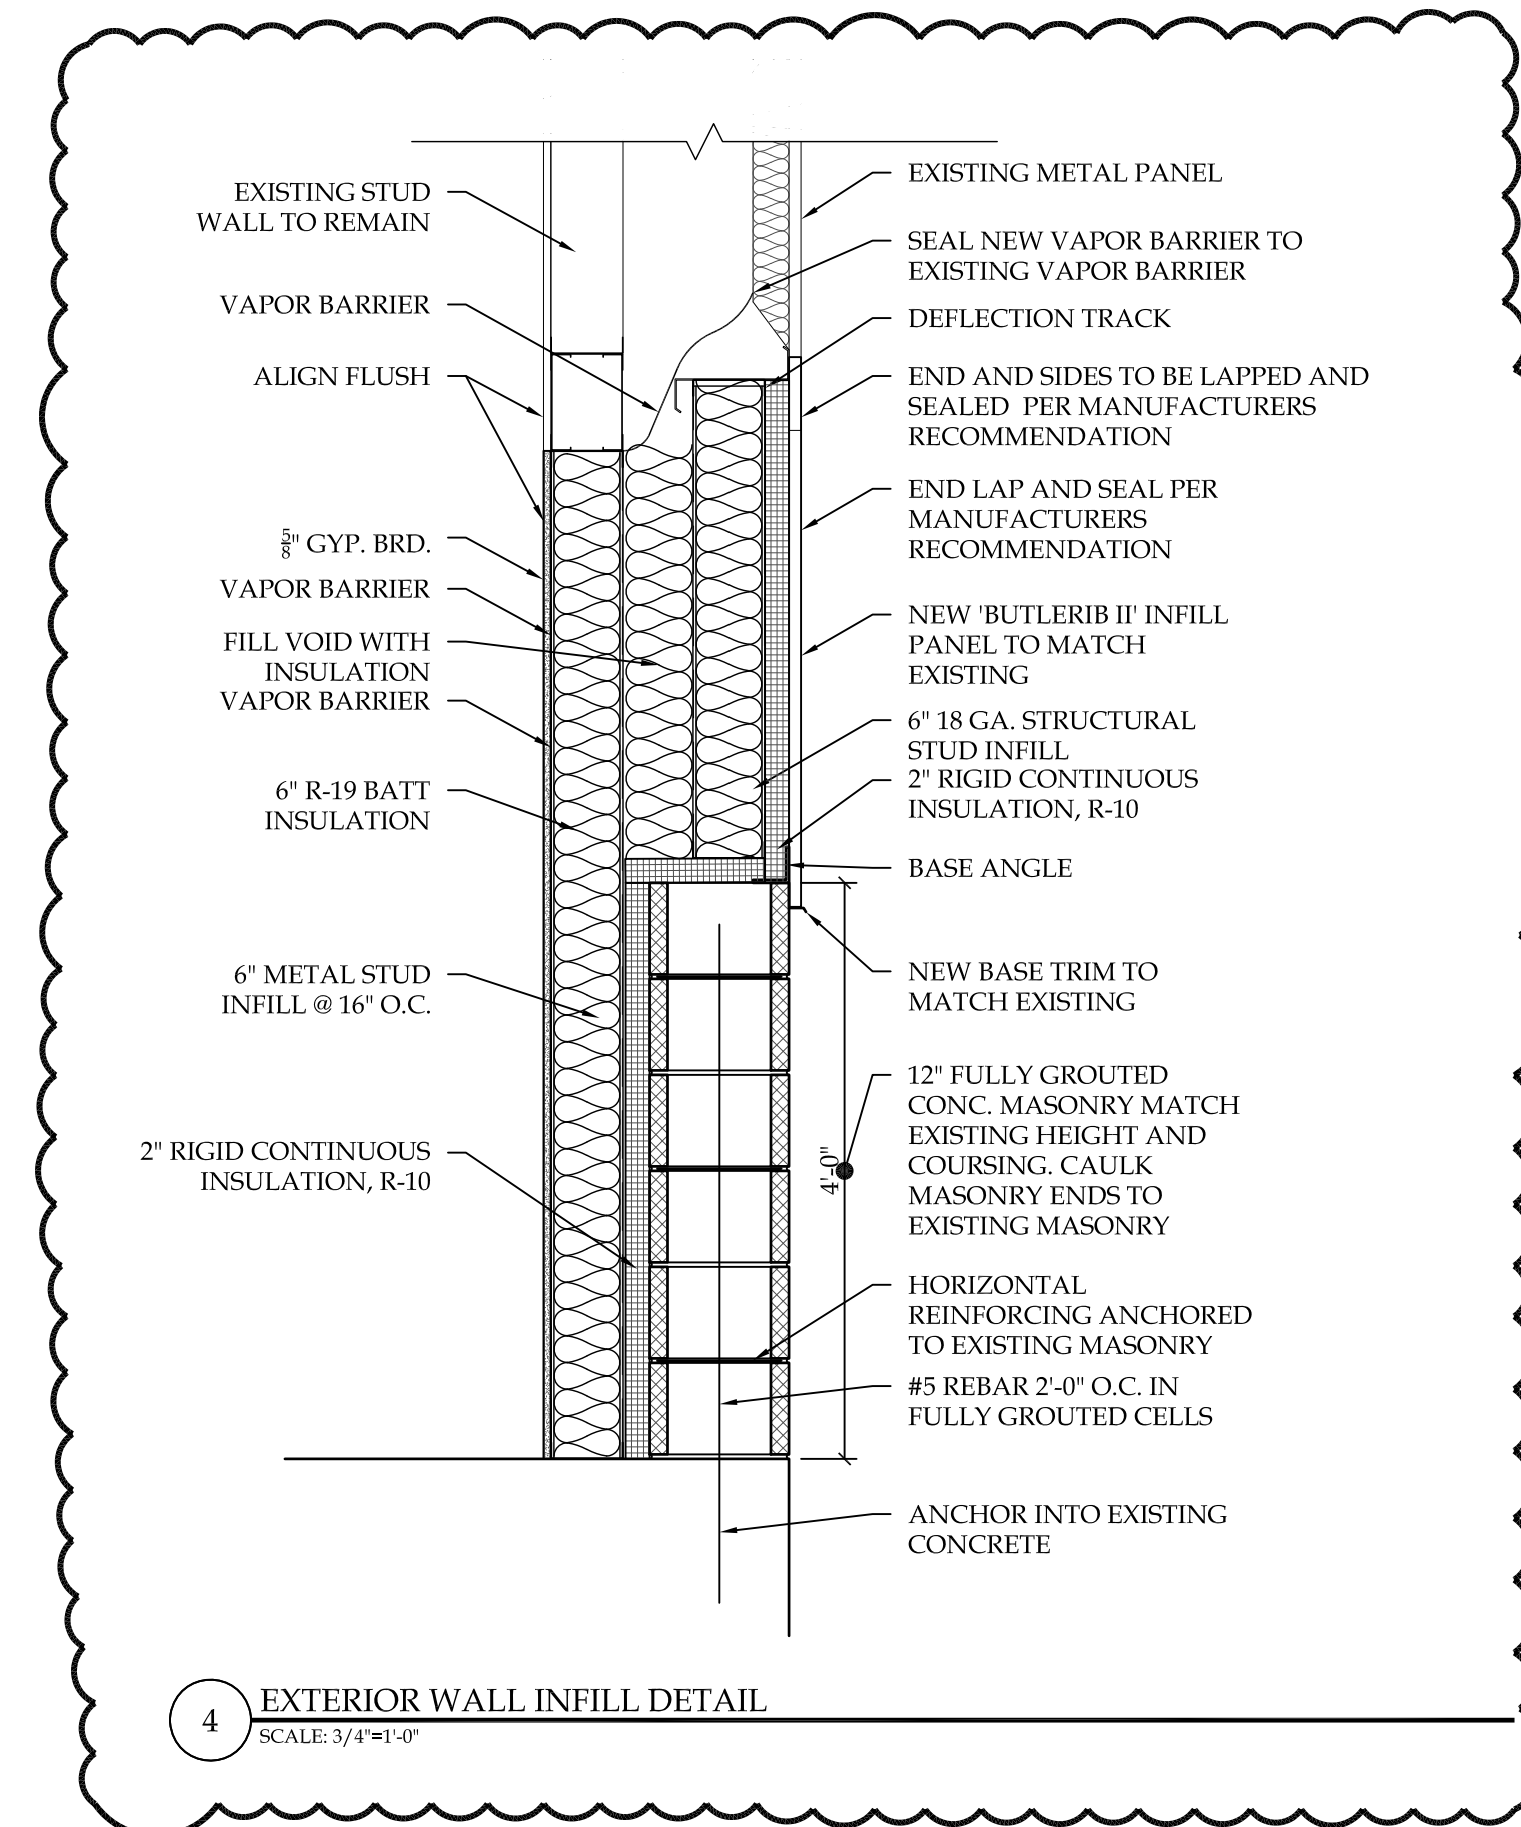

4 EXTERIOR WALL INFILL DETAIL  
SCALE: 3/4"=1'-0"

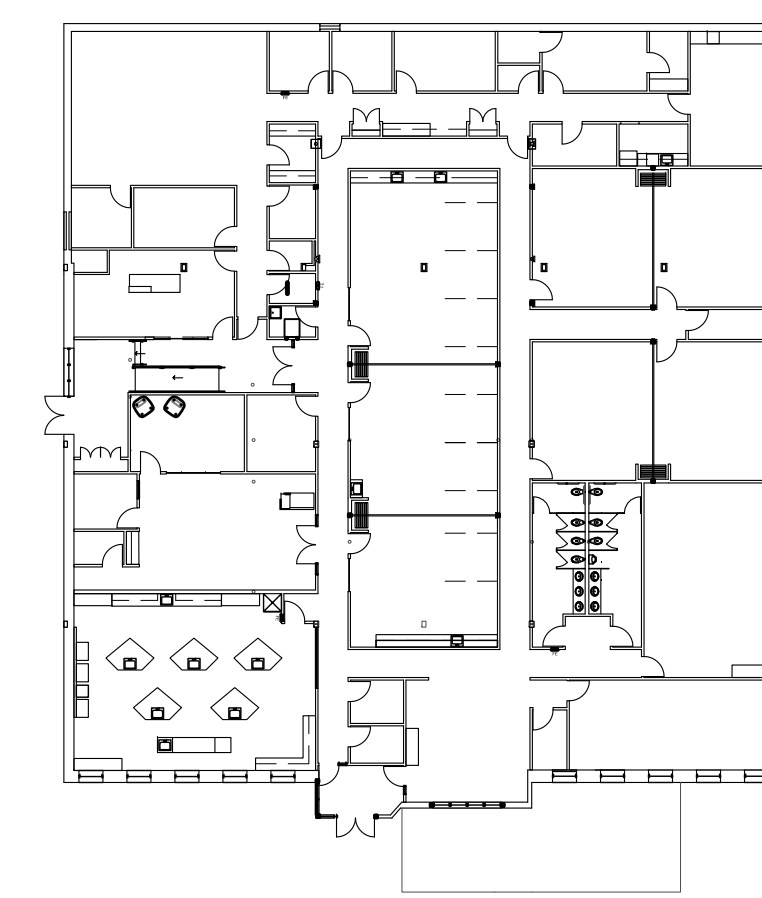

1 KEY PLAN  
SCALE: NTS

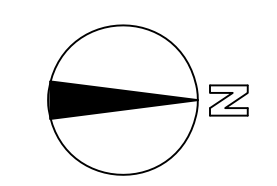


| REVISION RECORD |            |             |
|-----------------|------------|-------------|
| NO.             | DATE       | REMARKS     |
| #1              | 01.03.2018 | ADDENDUM #1 |
| #2              | 01.10.2018 | ADDENDUM #2 |

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1320 Warwick Way  
Mt. Pleasant, WI 53406



EXTERIOR ELEVATIONS

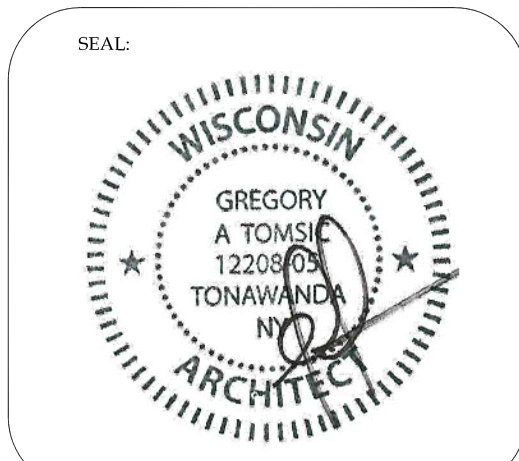GREGORY A. TOMSIC  
 REGISTERED ARCHITECT  
 145 BATHURST DR., TONAWANDA, N.Y. 14150  
 716-435-0617

|                       |                          |
|-----------------------|--------------------------|
| SCALE<br>1/8" = 1'-0" | JOB NO.                  |
| DRAWN                 | DWG. NO.<br><b>A-201</b> |
| CHECKED               | CONTRACT NO.             |
| DATE<br>12.22.2017    |                          |

| REVISION RECORD |            |             |
|-----------------|------------|-------------|
| NO.             | DATE       | REMARKS     |
| #1              | 01.03.2018 | ADDENDUM #1 |
| #2              | 01.10.2018 | ADDENDUM #2 |


IT IS A VIOLATION OF STATE LAW FOR ANY PERSON, UNLESS ACTING UNDER THE DIRECTION OF A NEW YORK STATE ARCHITECT OR ENGINEER, TO ALTER ANY ITEM ON THIS DOCUMENT IN ANY WAY. IF ANY ITEM ON THIS DOCUMENT IS ALTERED, THE ALTERING ARCHITECT OR ENGINEER SHALL AFFIX TO HIS ITEM HIS SEAL AND THE NOTATION "ALTERED BY" FOLLOWED BY HIS SIGNATURE, THE DATE OF SUCH ALTERATION AND A SPECIFIC DESCRIPTION OF SUCH ALTERATION.



**Bryant and Stratton College**

**BRYANT & STRATTON COLLEGE**


1320 Warwick Way  
Mt. Pleasant, WI 53406

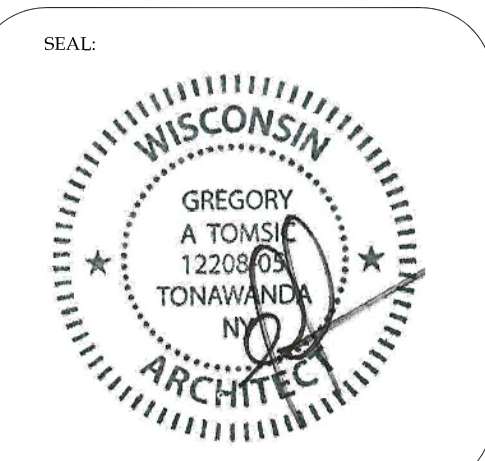


**EXTERIOR ELEVATIONS**

**GREGORY A. TOMSIC**  
REGISTERED ARCHITECT  
145 BATHURST DR., TONAWANDA, N.Y. 14150  
716-433-0617


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|-----------------------|--------------------------|
| SCALE<br>1/8" = 1'-0" | JOB NO.                  |
| DRAWN                 | DWG. NO.<br><b>A-202</b> |
| CHECKED               | CONTRACT NO.             |
| DATE<br>12.22.2017    |                          |

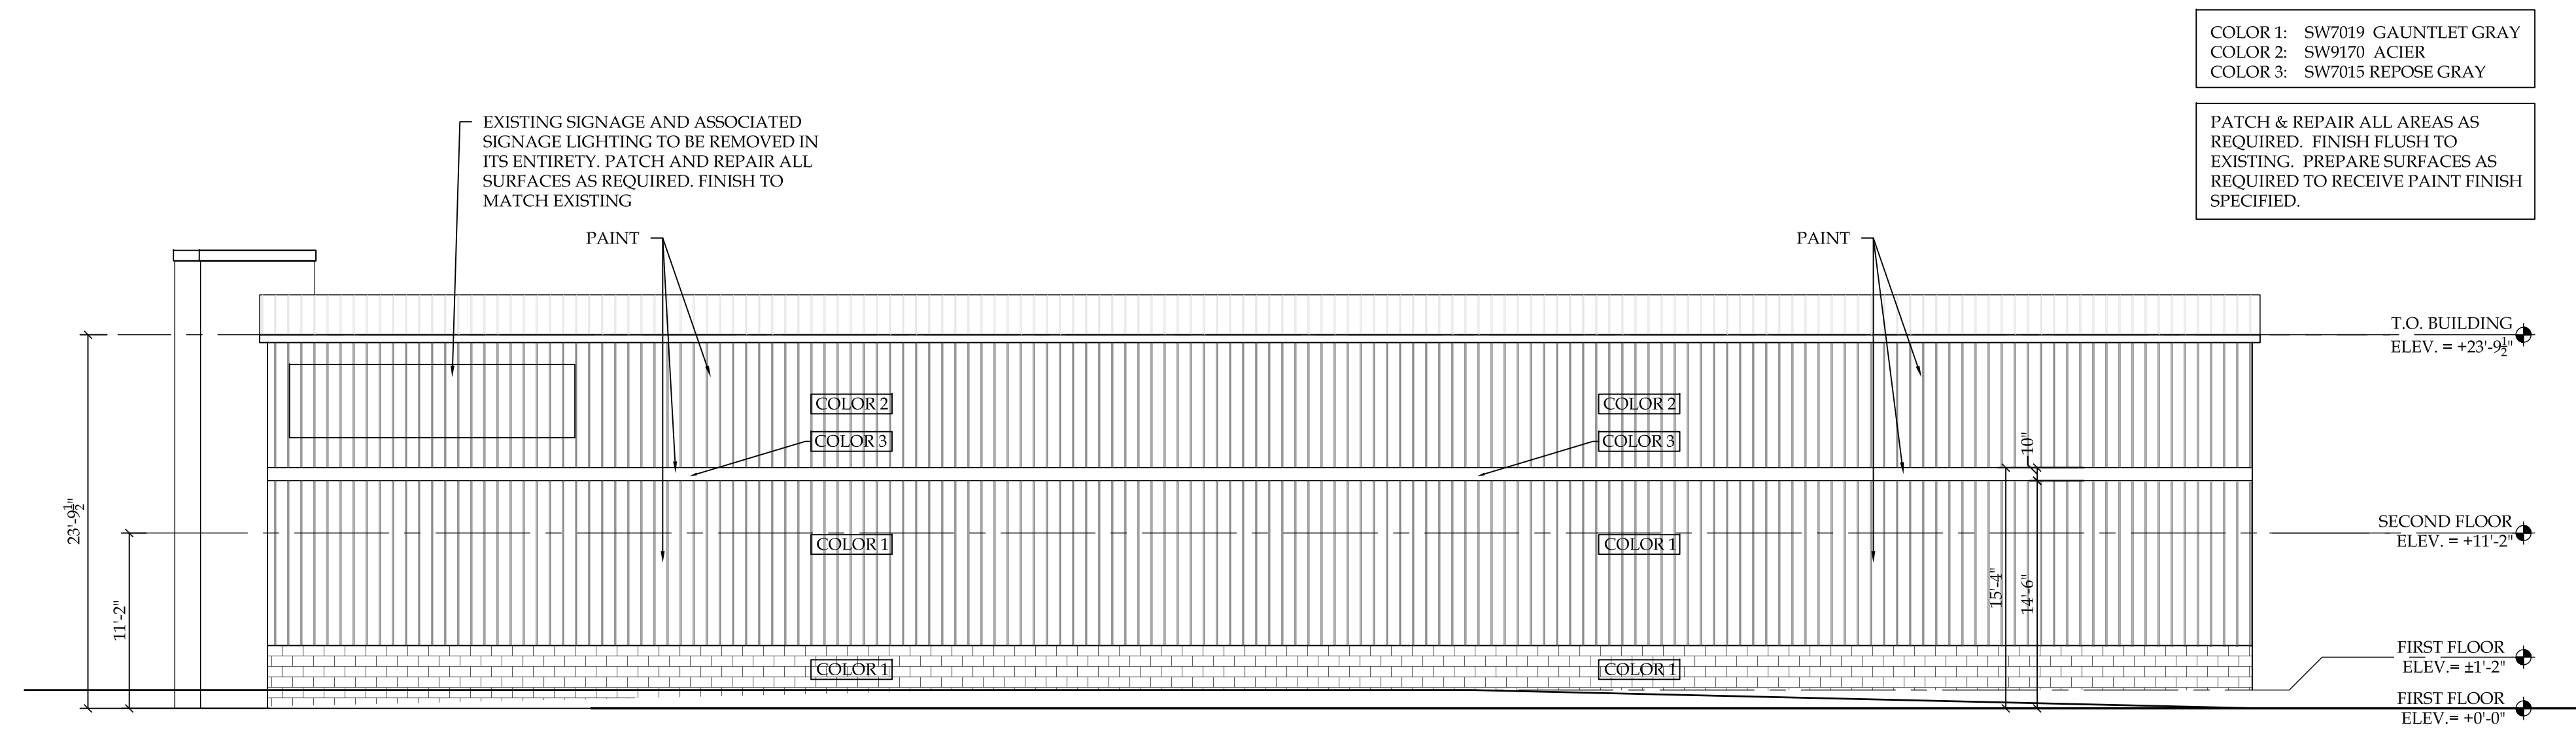

**2 RIGHT SIDE ELEVATION**  
SCALE: 1/8"=1'-0"

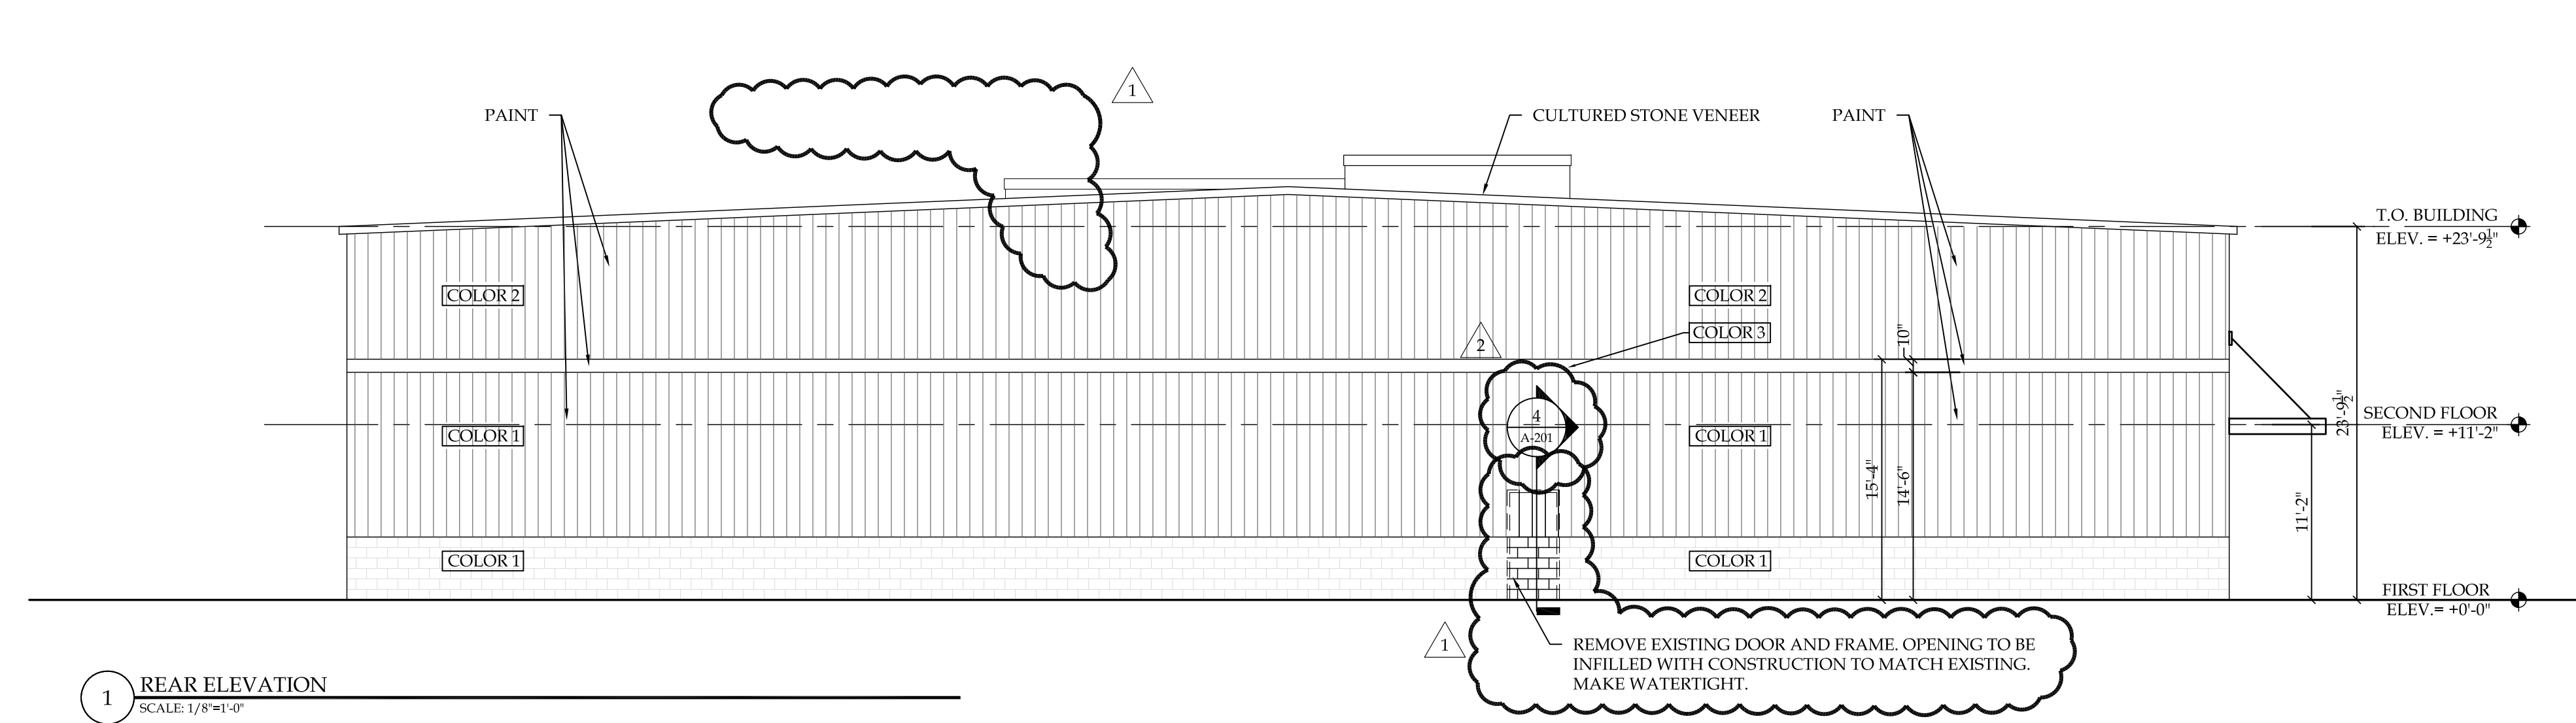


**1 REAR ELEVATION**  
SCALE: 1/8"=1'-0"

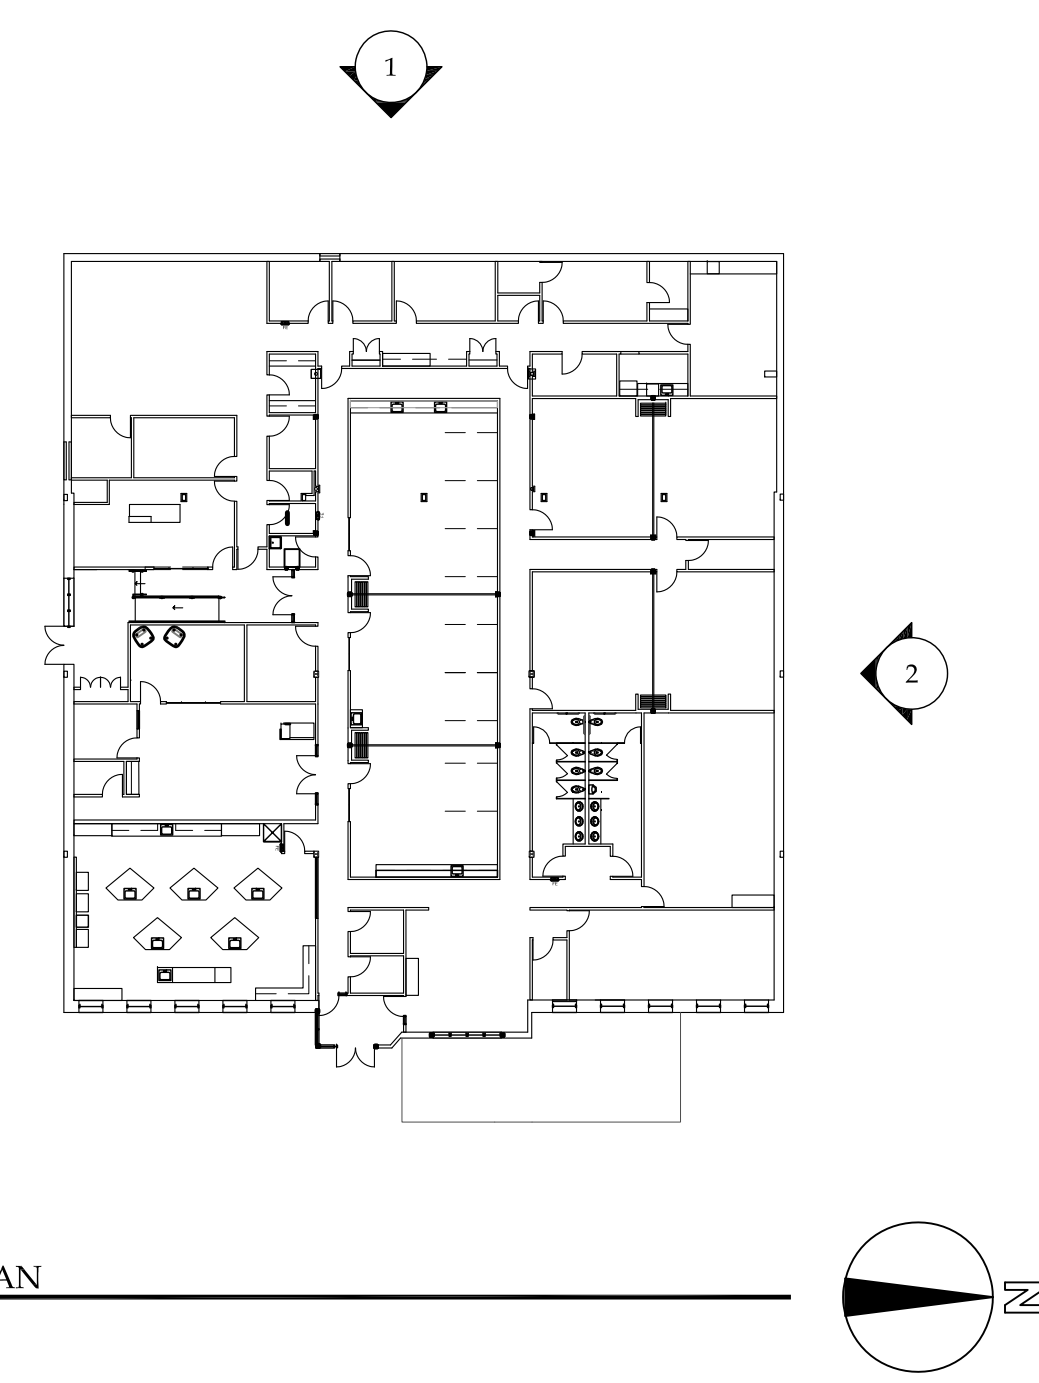


**1 KEY PLAN**  
SCALE: NTS



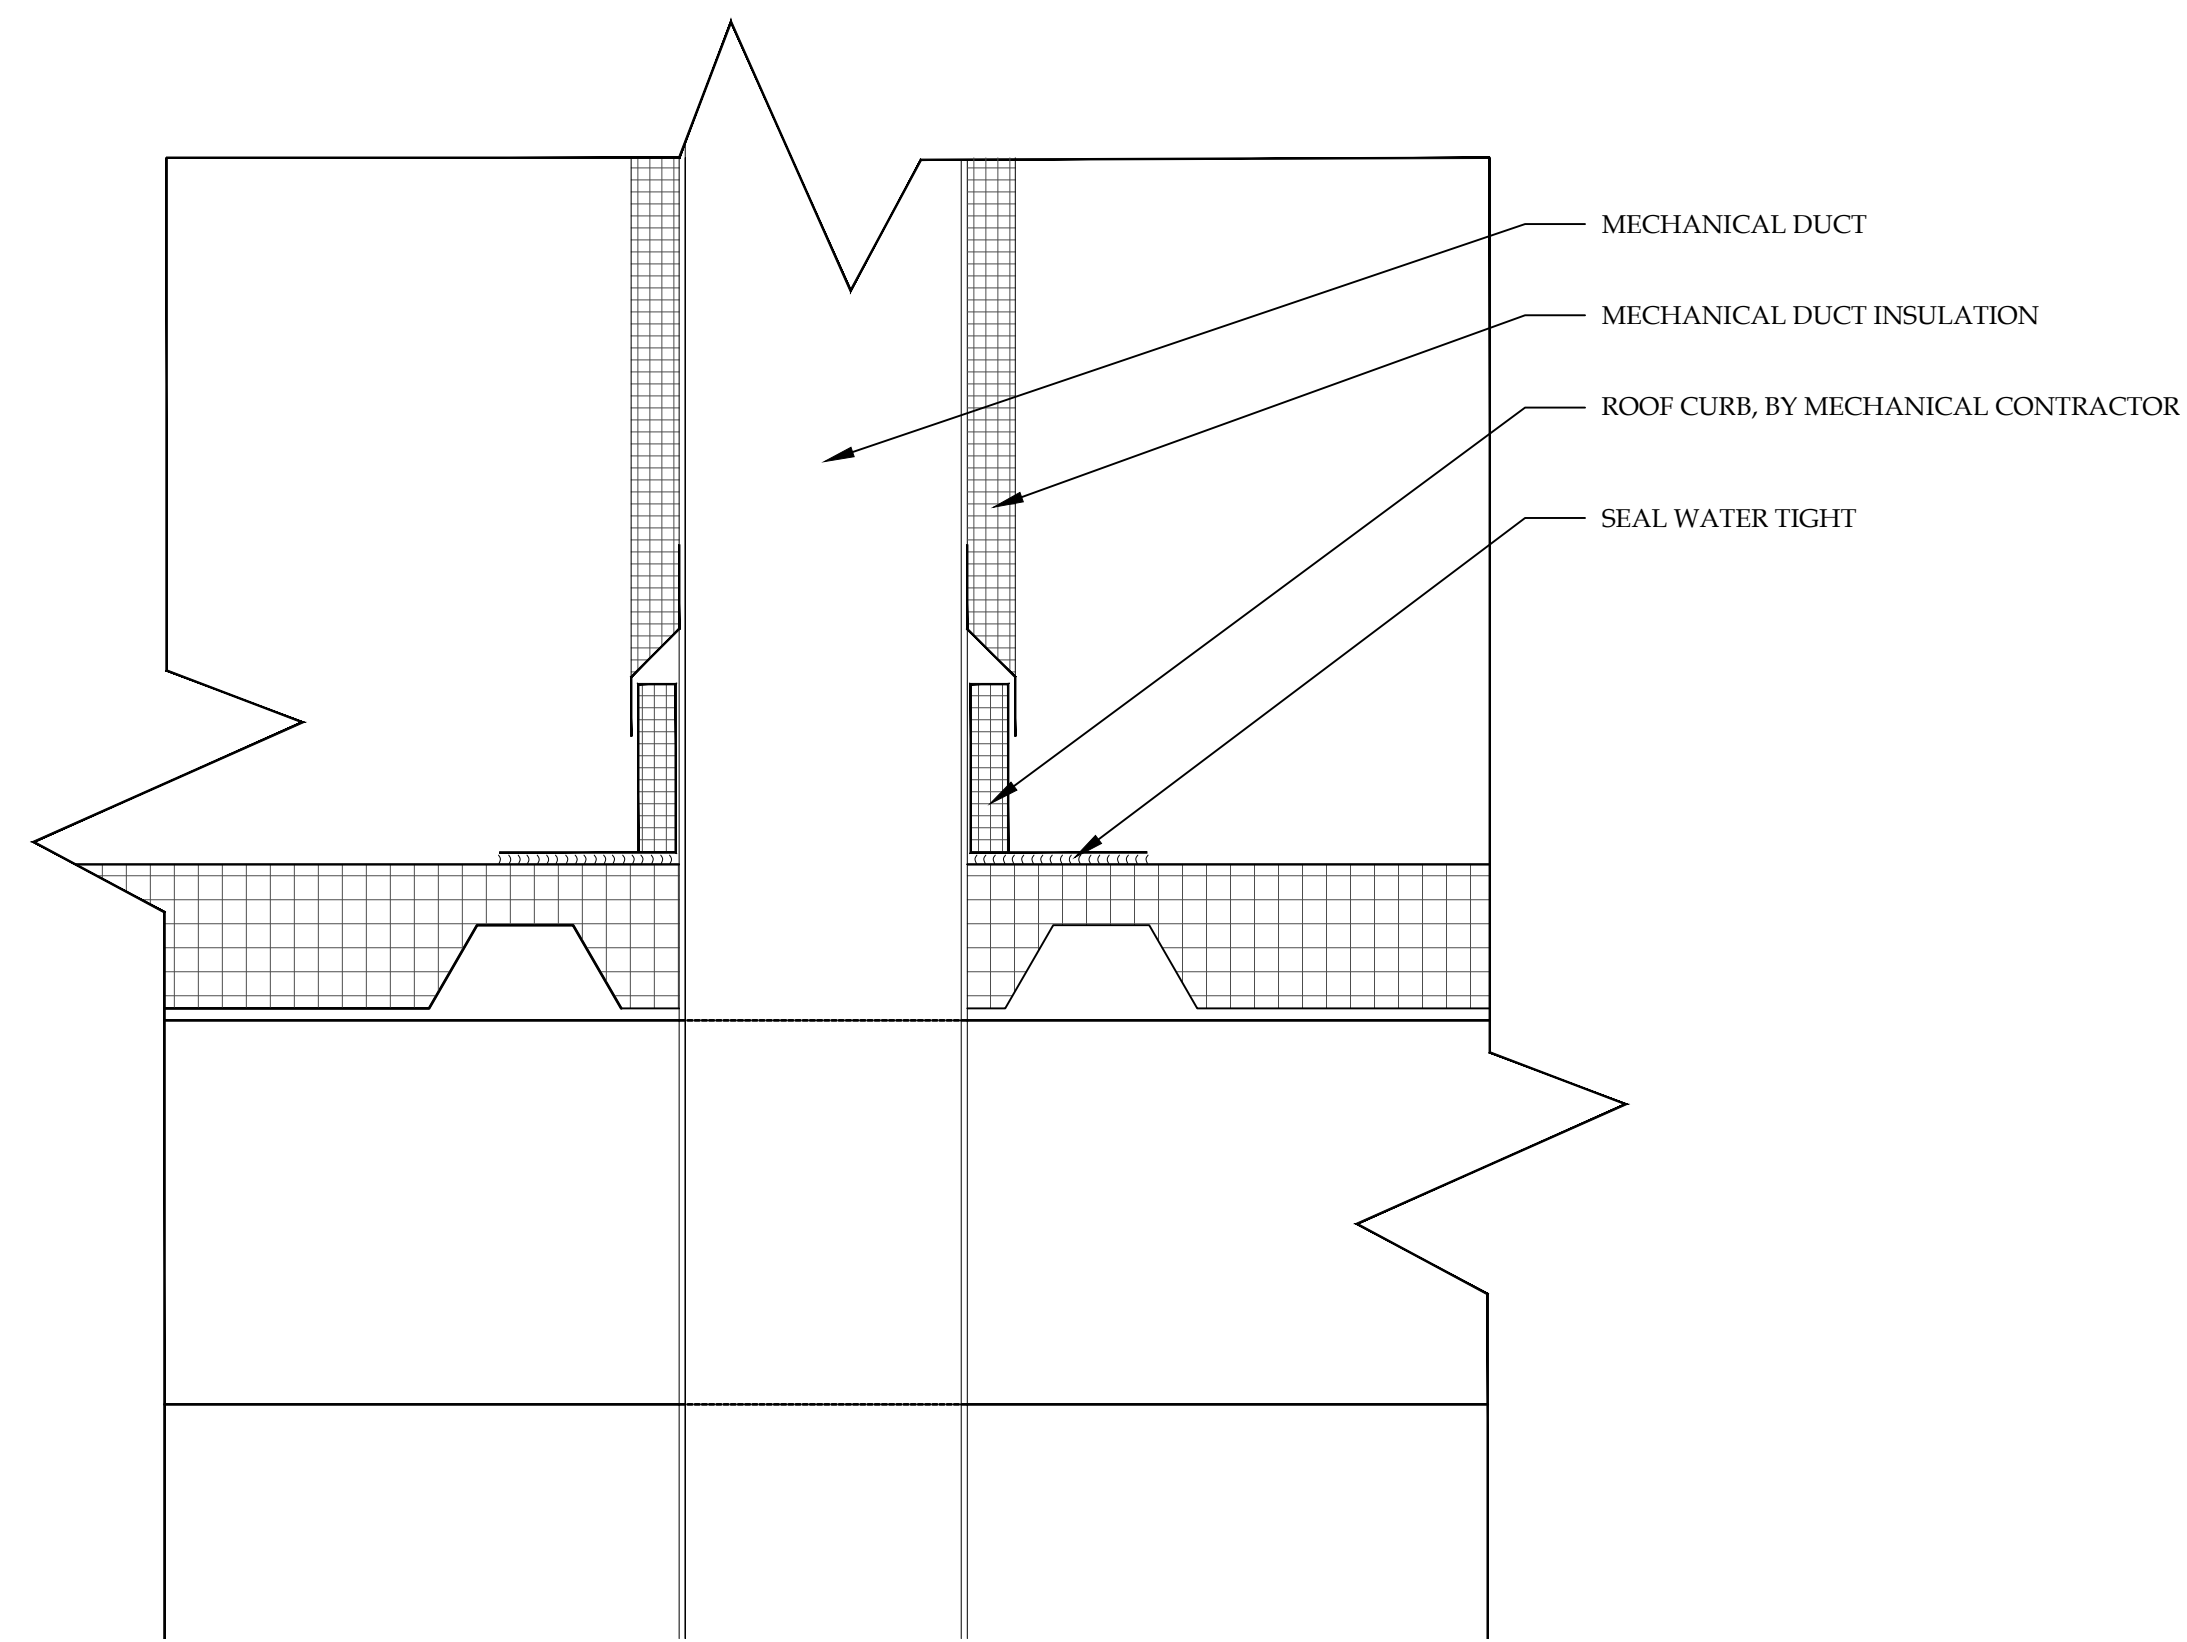

1 MECHANIAL DUCT PENETRATION DETAIL- REFER TO MECHANICAL DRAWINGS  
SCALE: 3" = 1'-0"

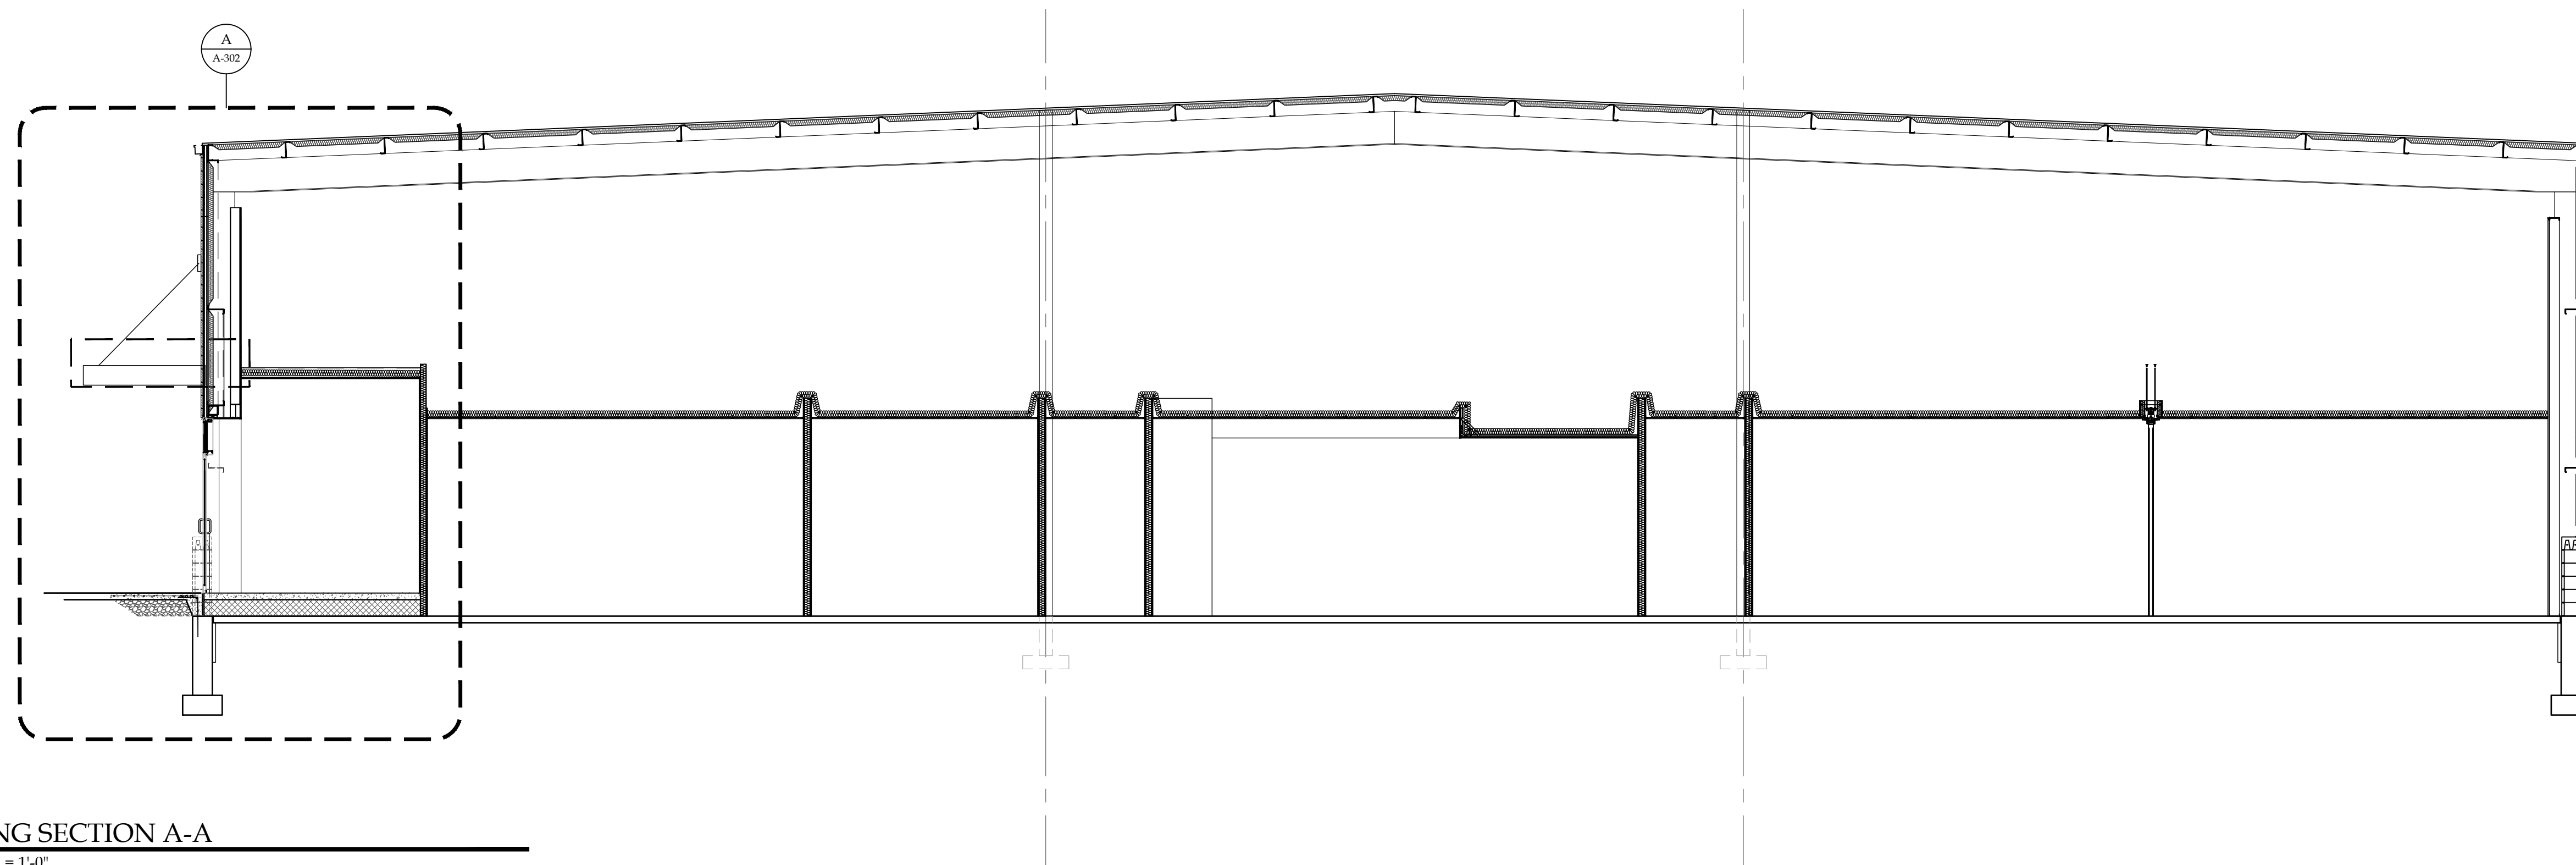

AA BUILDING SECTION A-A  
SCALE: 3/16" = 1'-0"

| REVISION RECORD |      |         |
|-----------------|------|---------|
| NO.             | DATE | REMARKS |
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Bryant and Stratton College

**BRYANT & STRATTON COLLEGE**

1320 Warwick Way  
Mt. Pleasant, WI 53406

SEAL:

**BUILDING SECTIONS**

**GREGORY A. TOMSIC**  
REGISTERED ARCHITECT  
145 BATHURST DR., TONAWANDA, N.Y. 14150  
716-433-0617

|                       |                          |
|-----------------------|--------------------------|
| SCALE<br>1/8" = 1'-0" | JOB NO.                  |
| DRAWN                 | DWG. NO.<br><b>A-301</b> |
| CHECKED               |                          |
| DATE<br>12.22.2017    | CONTRACT NO.             |

| REVISION RECORD |            |             |
|-----------------|------------|-------------|
| NO.             | DATE       | REMARKS     |
| #1              | 01.03.2018 | ADDENDUM #1 |

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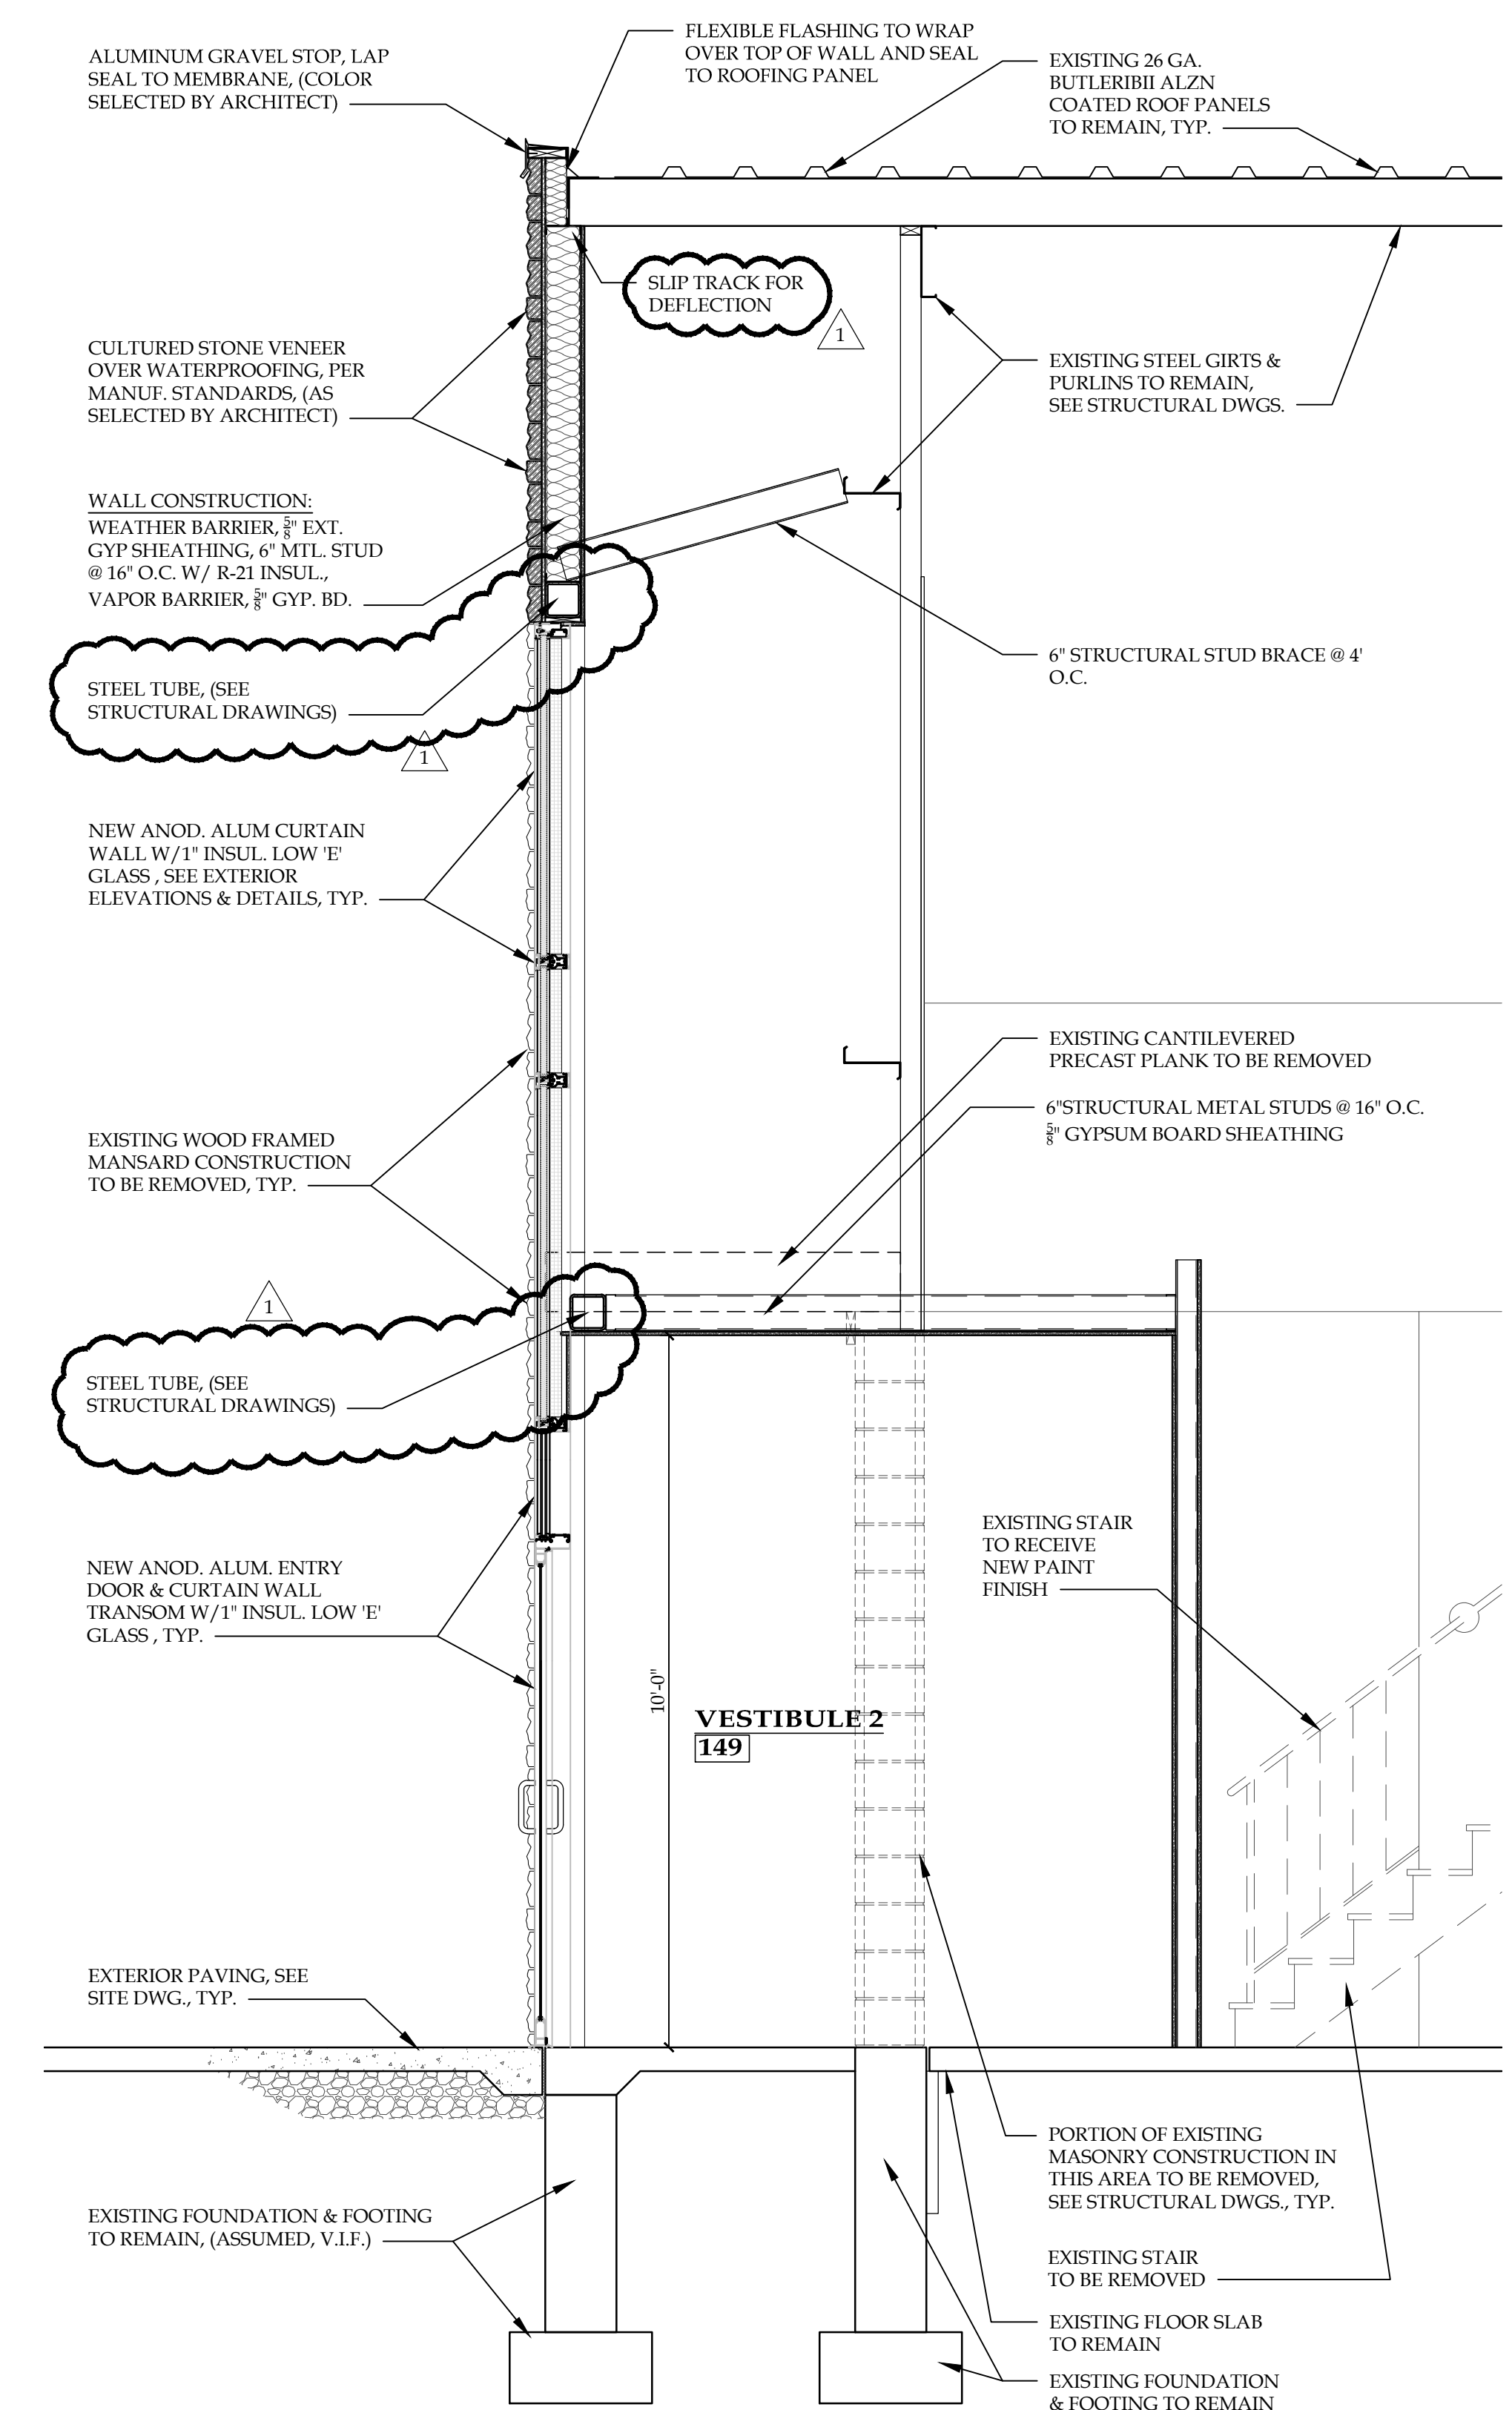
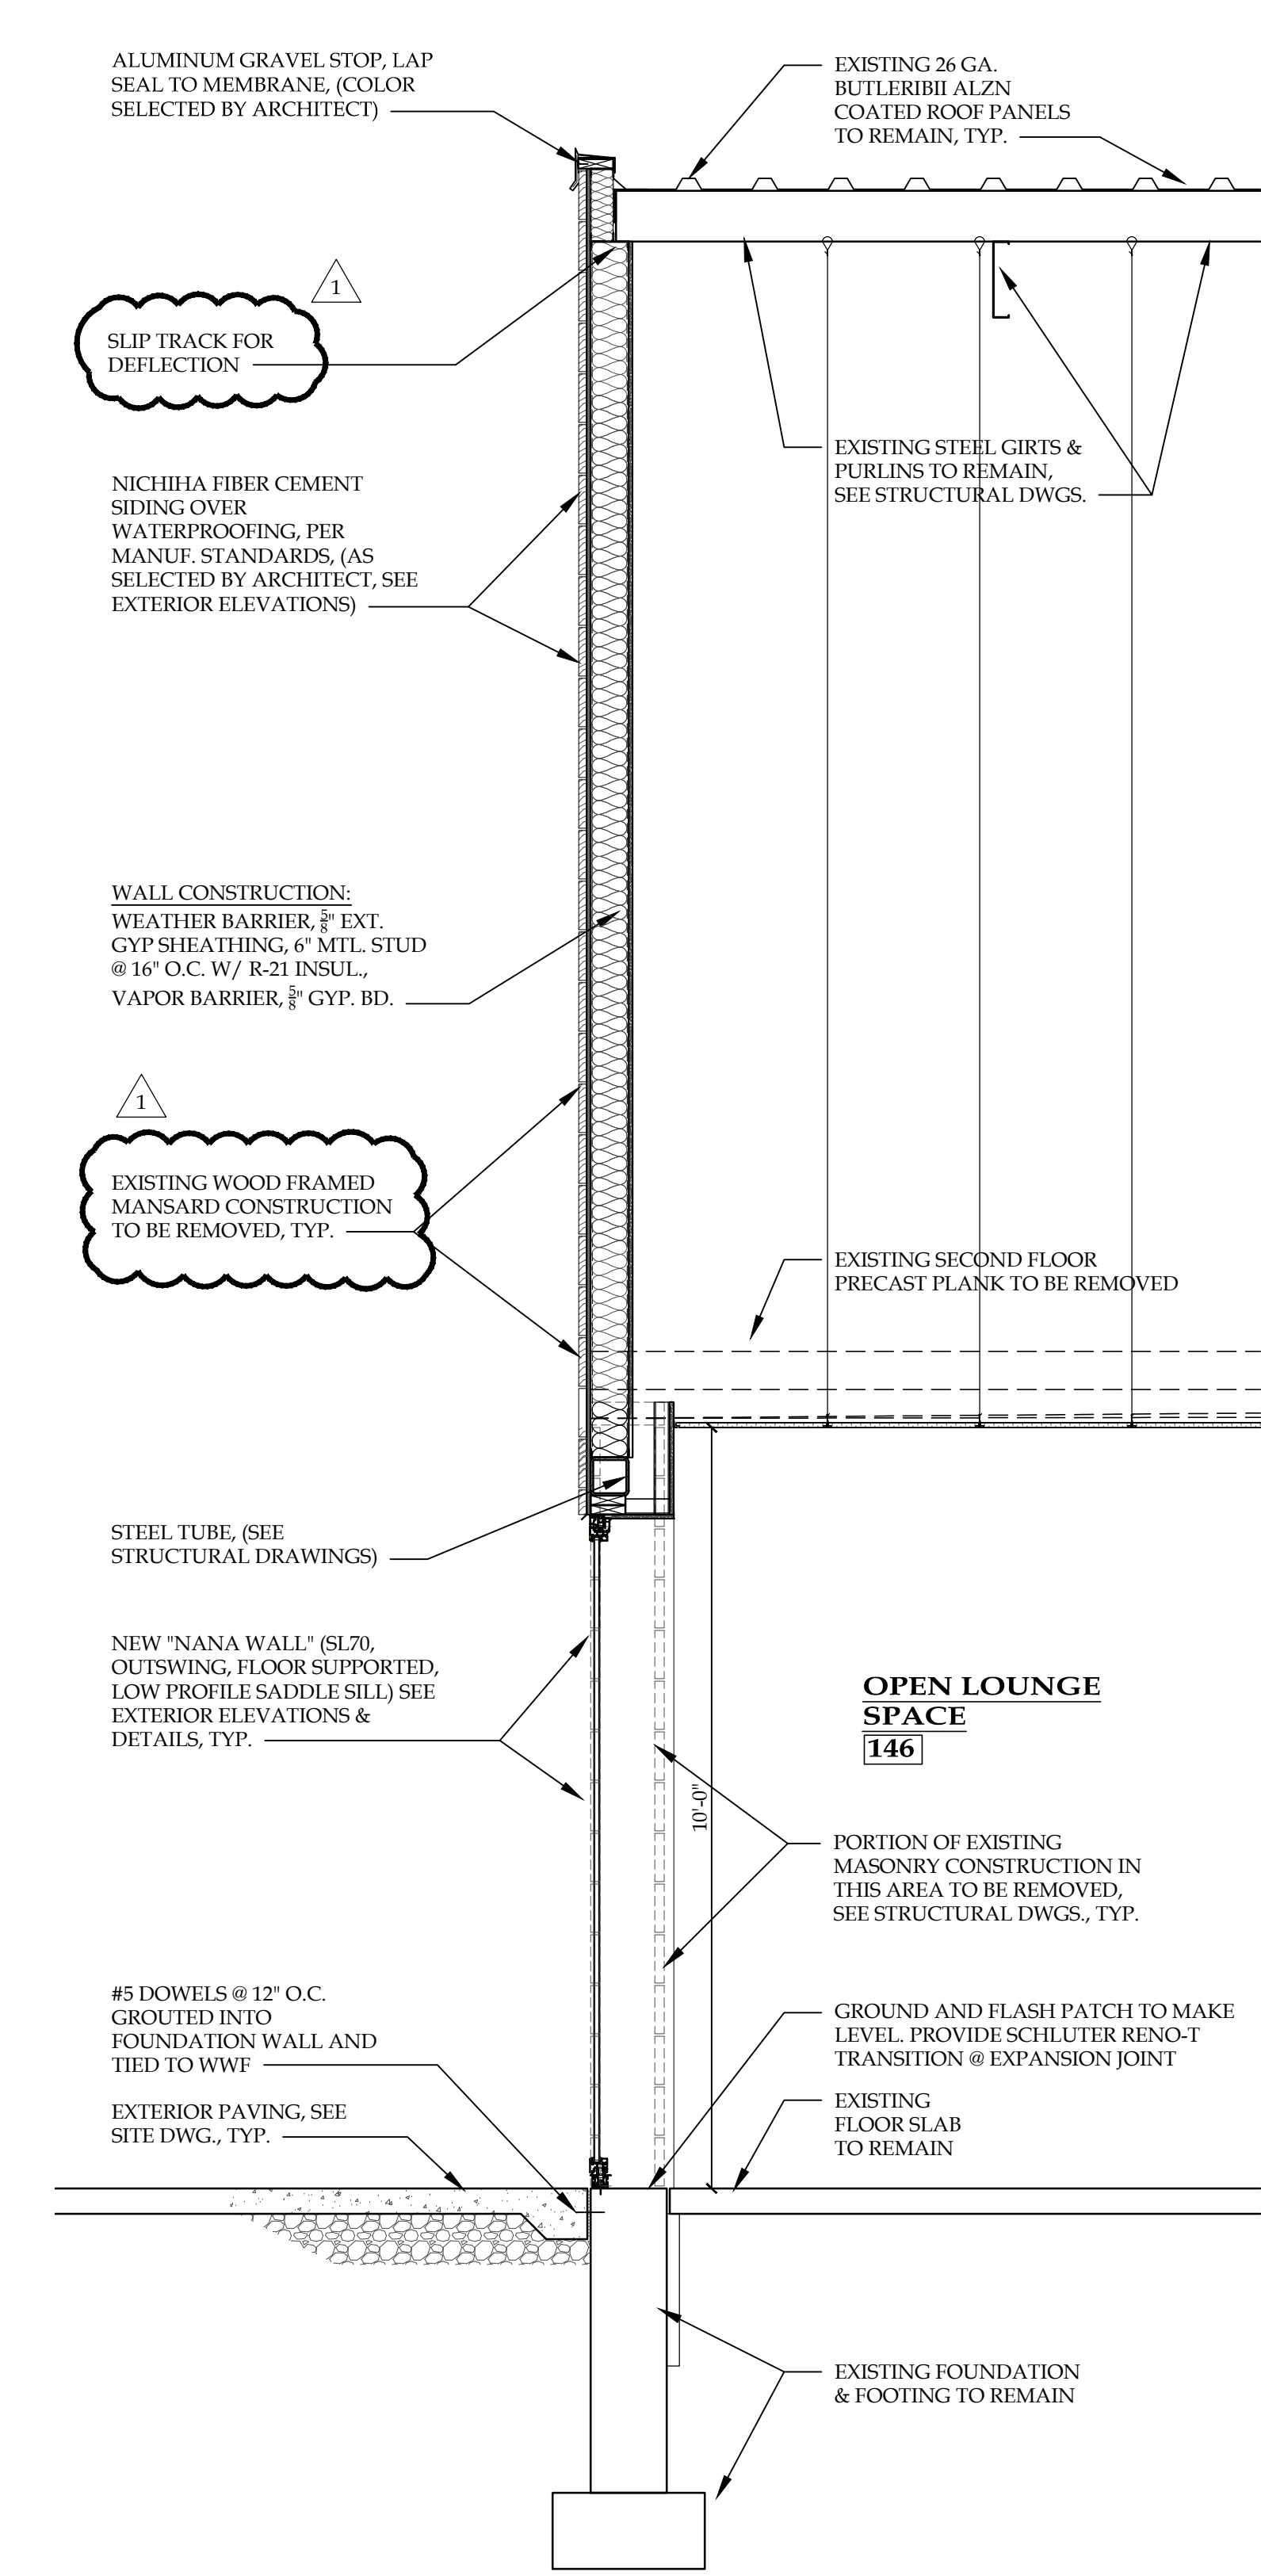
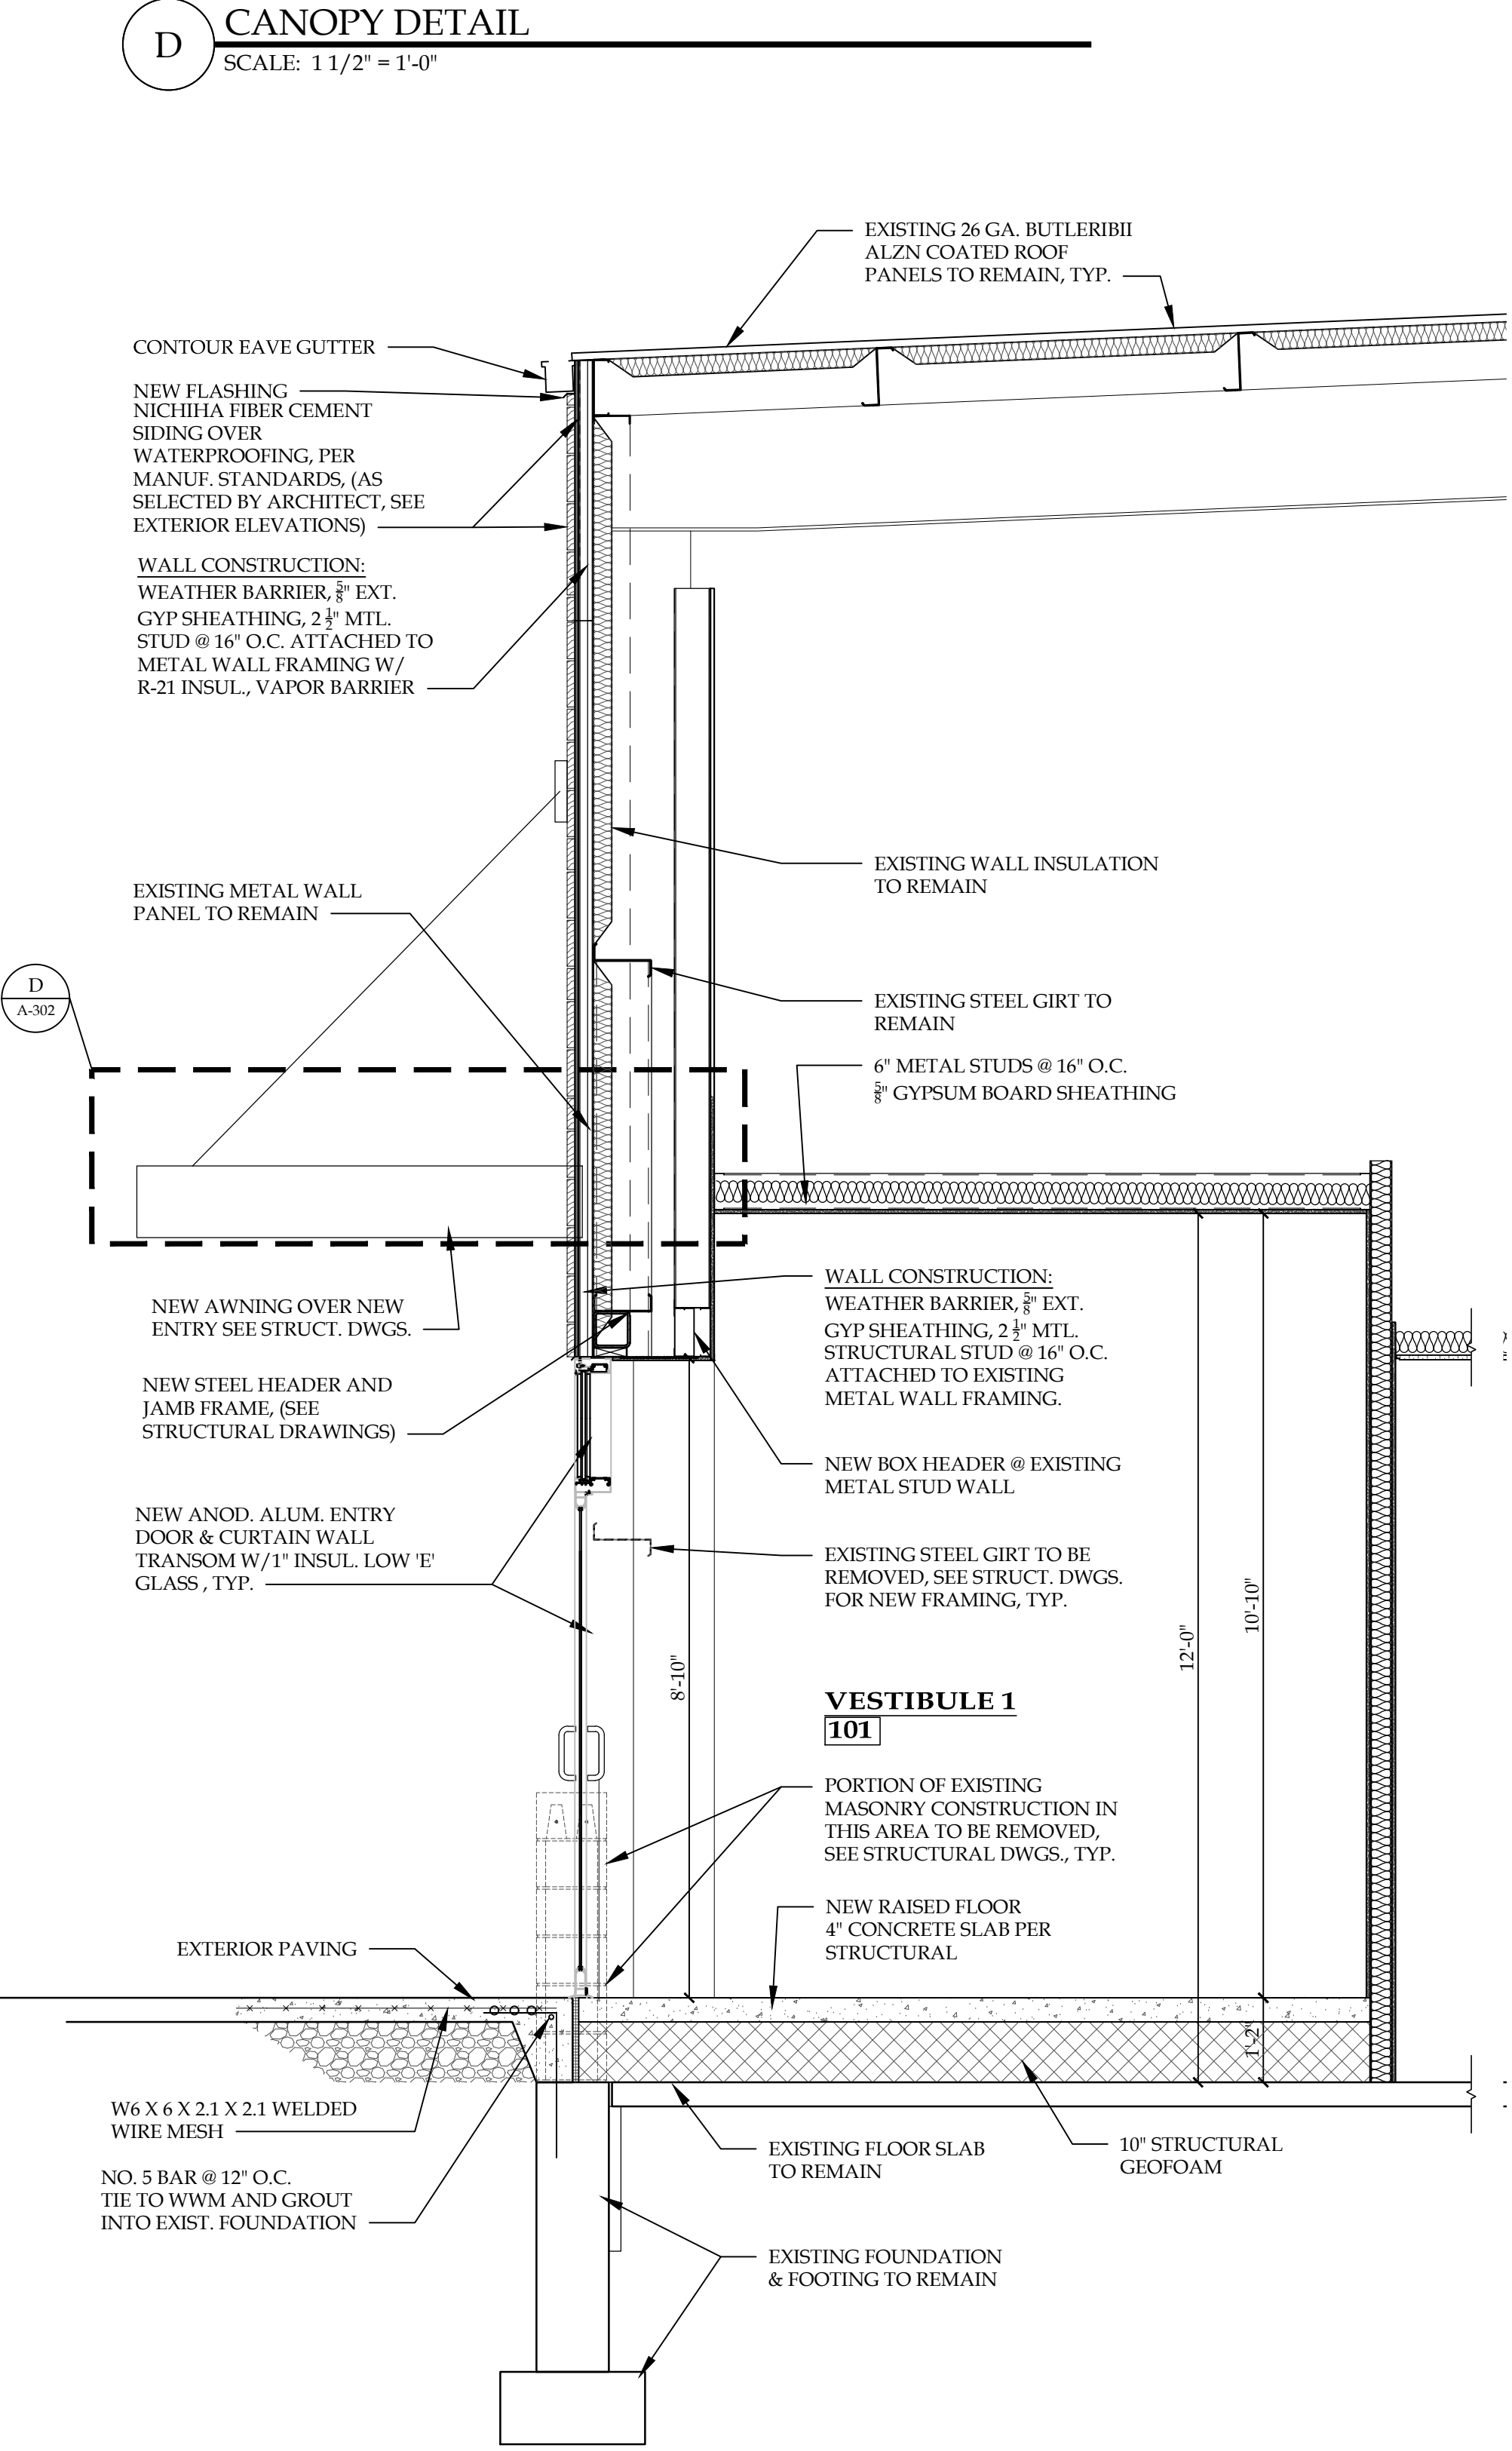
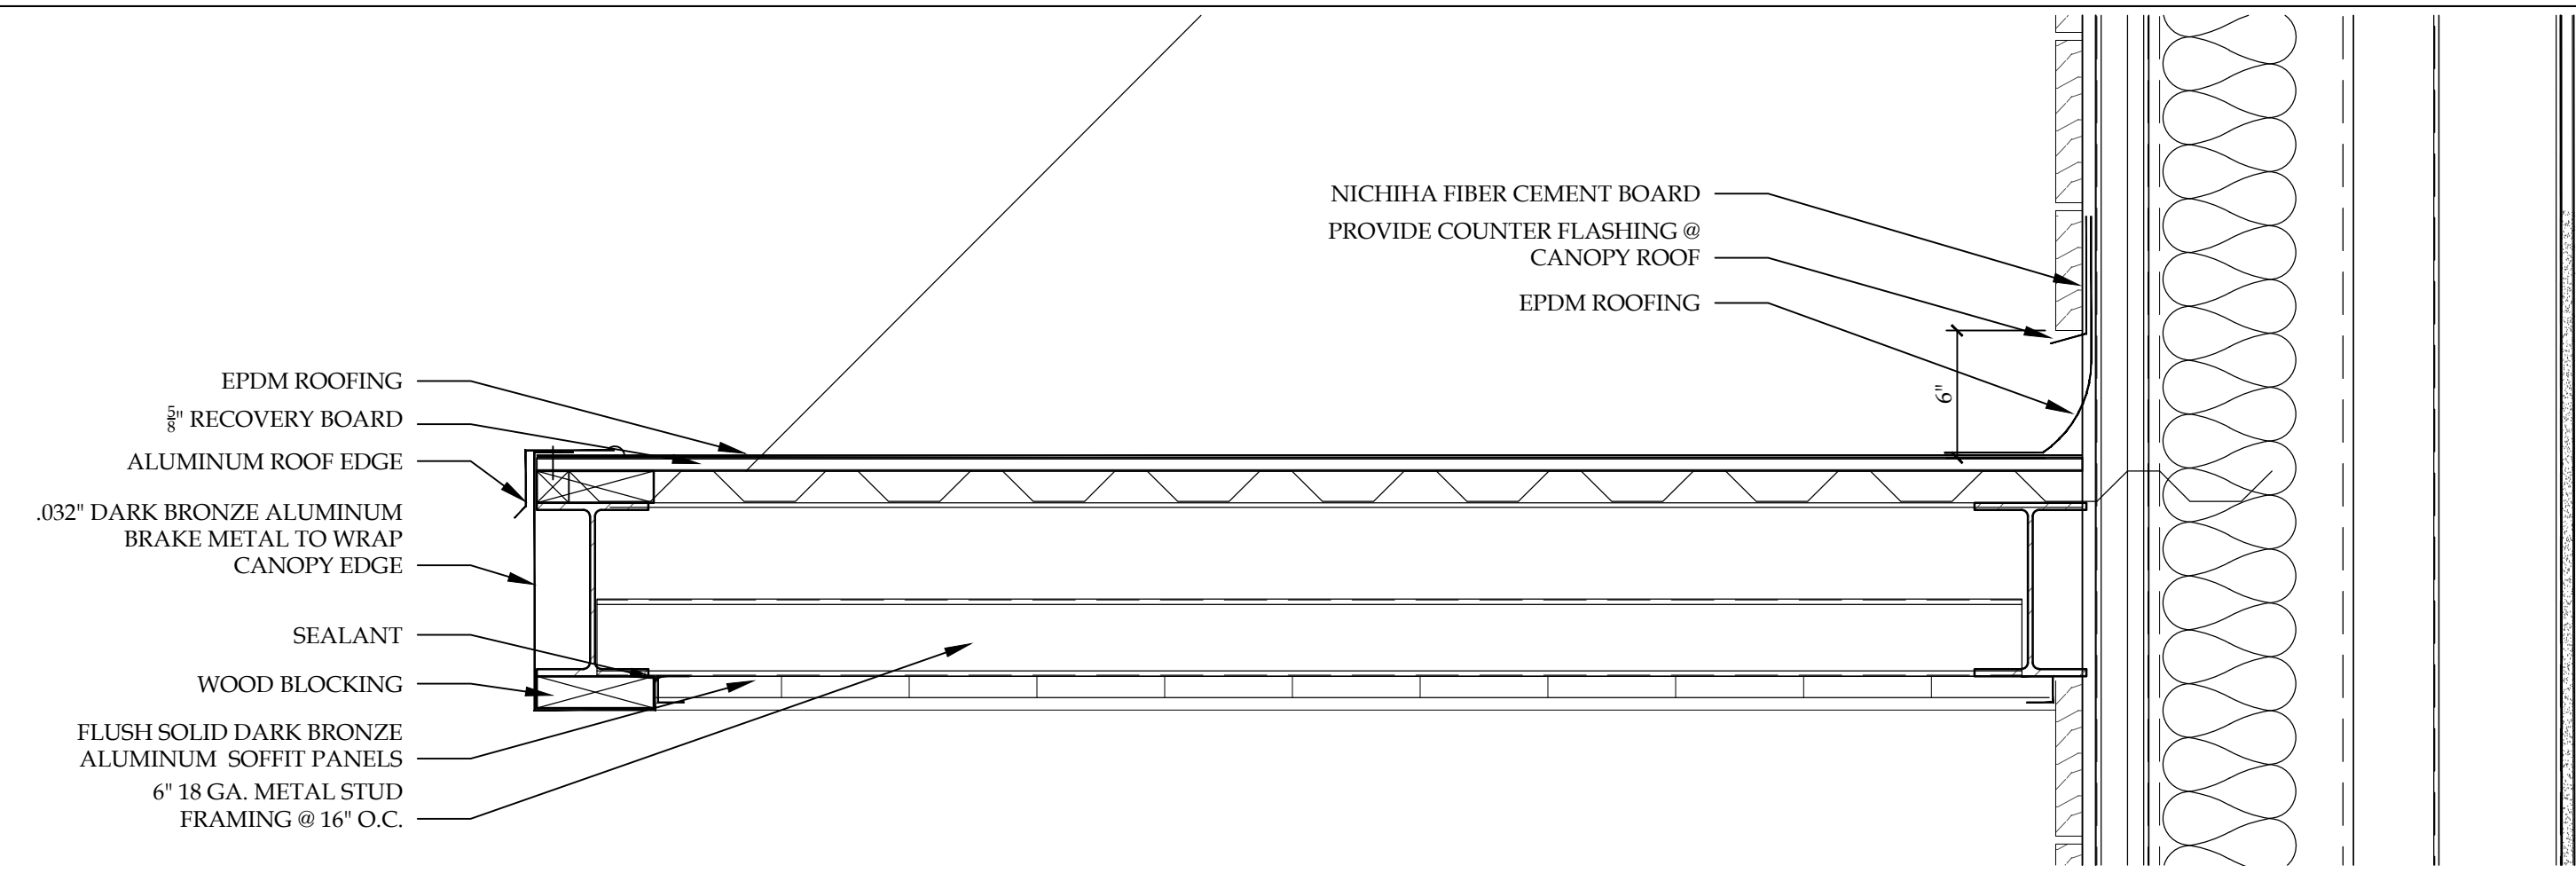
**BRYANT & STRATTON COLLEGE**  
 1320 Warwick Way  
 Mt. Pleasant, WI 53406

SEAL:

**WALL SECTIONS**

**GREGORY A. TOMSIC**  
 REGISTERED ARCHITECT  
 145 BATHURST DR., TONAWANDA, N.Y. 14150  
 716-434-0617

|                       |                          |
|-----------------------|--------------------------|
| SCALE<br>1/8" = 1'-0" | JOB NO.                  |
| DRAWN                 | DWG. NO.<br><b>A-302</b> |
| CHECKED               | CONTRACT NO.             |
| DATE<br>12.22.2017    |                          |



**A WALL SECTION A**  
 SCALE: 1/2" = 1'-0"

**B WALL SECTION B**  
 SCALE: 1/2" = 1'-0"

**C WALL SECTION C**  
 SCALE: 1/2" = 1'-0"



| REVISION RECORD |      |         |
|-----------------|------|---------|
| NO.             | DATE | REMARKS |
|                 |      |         |

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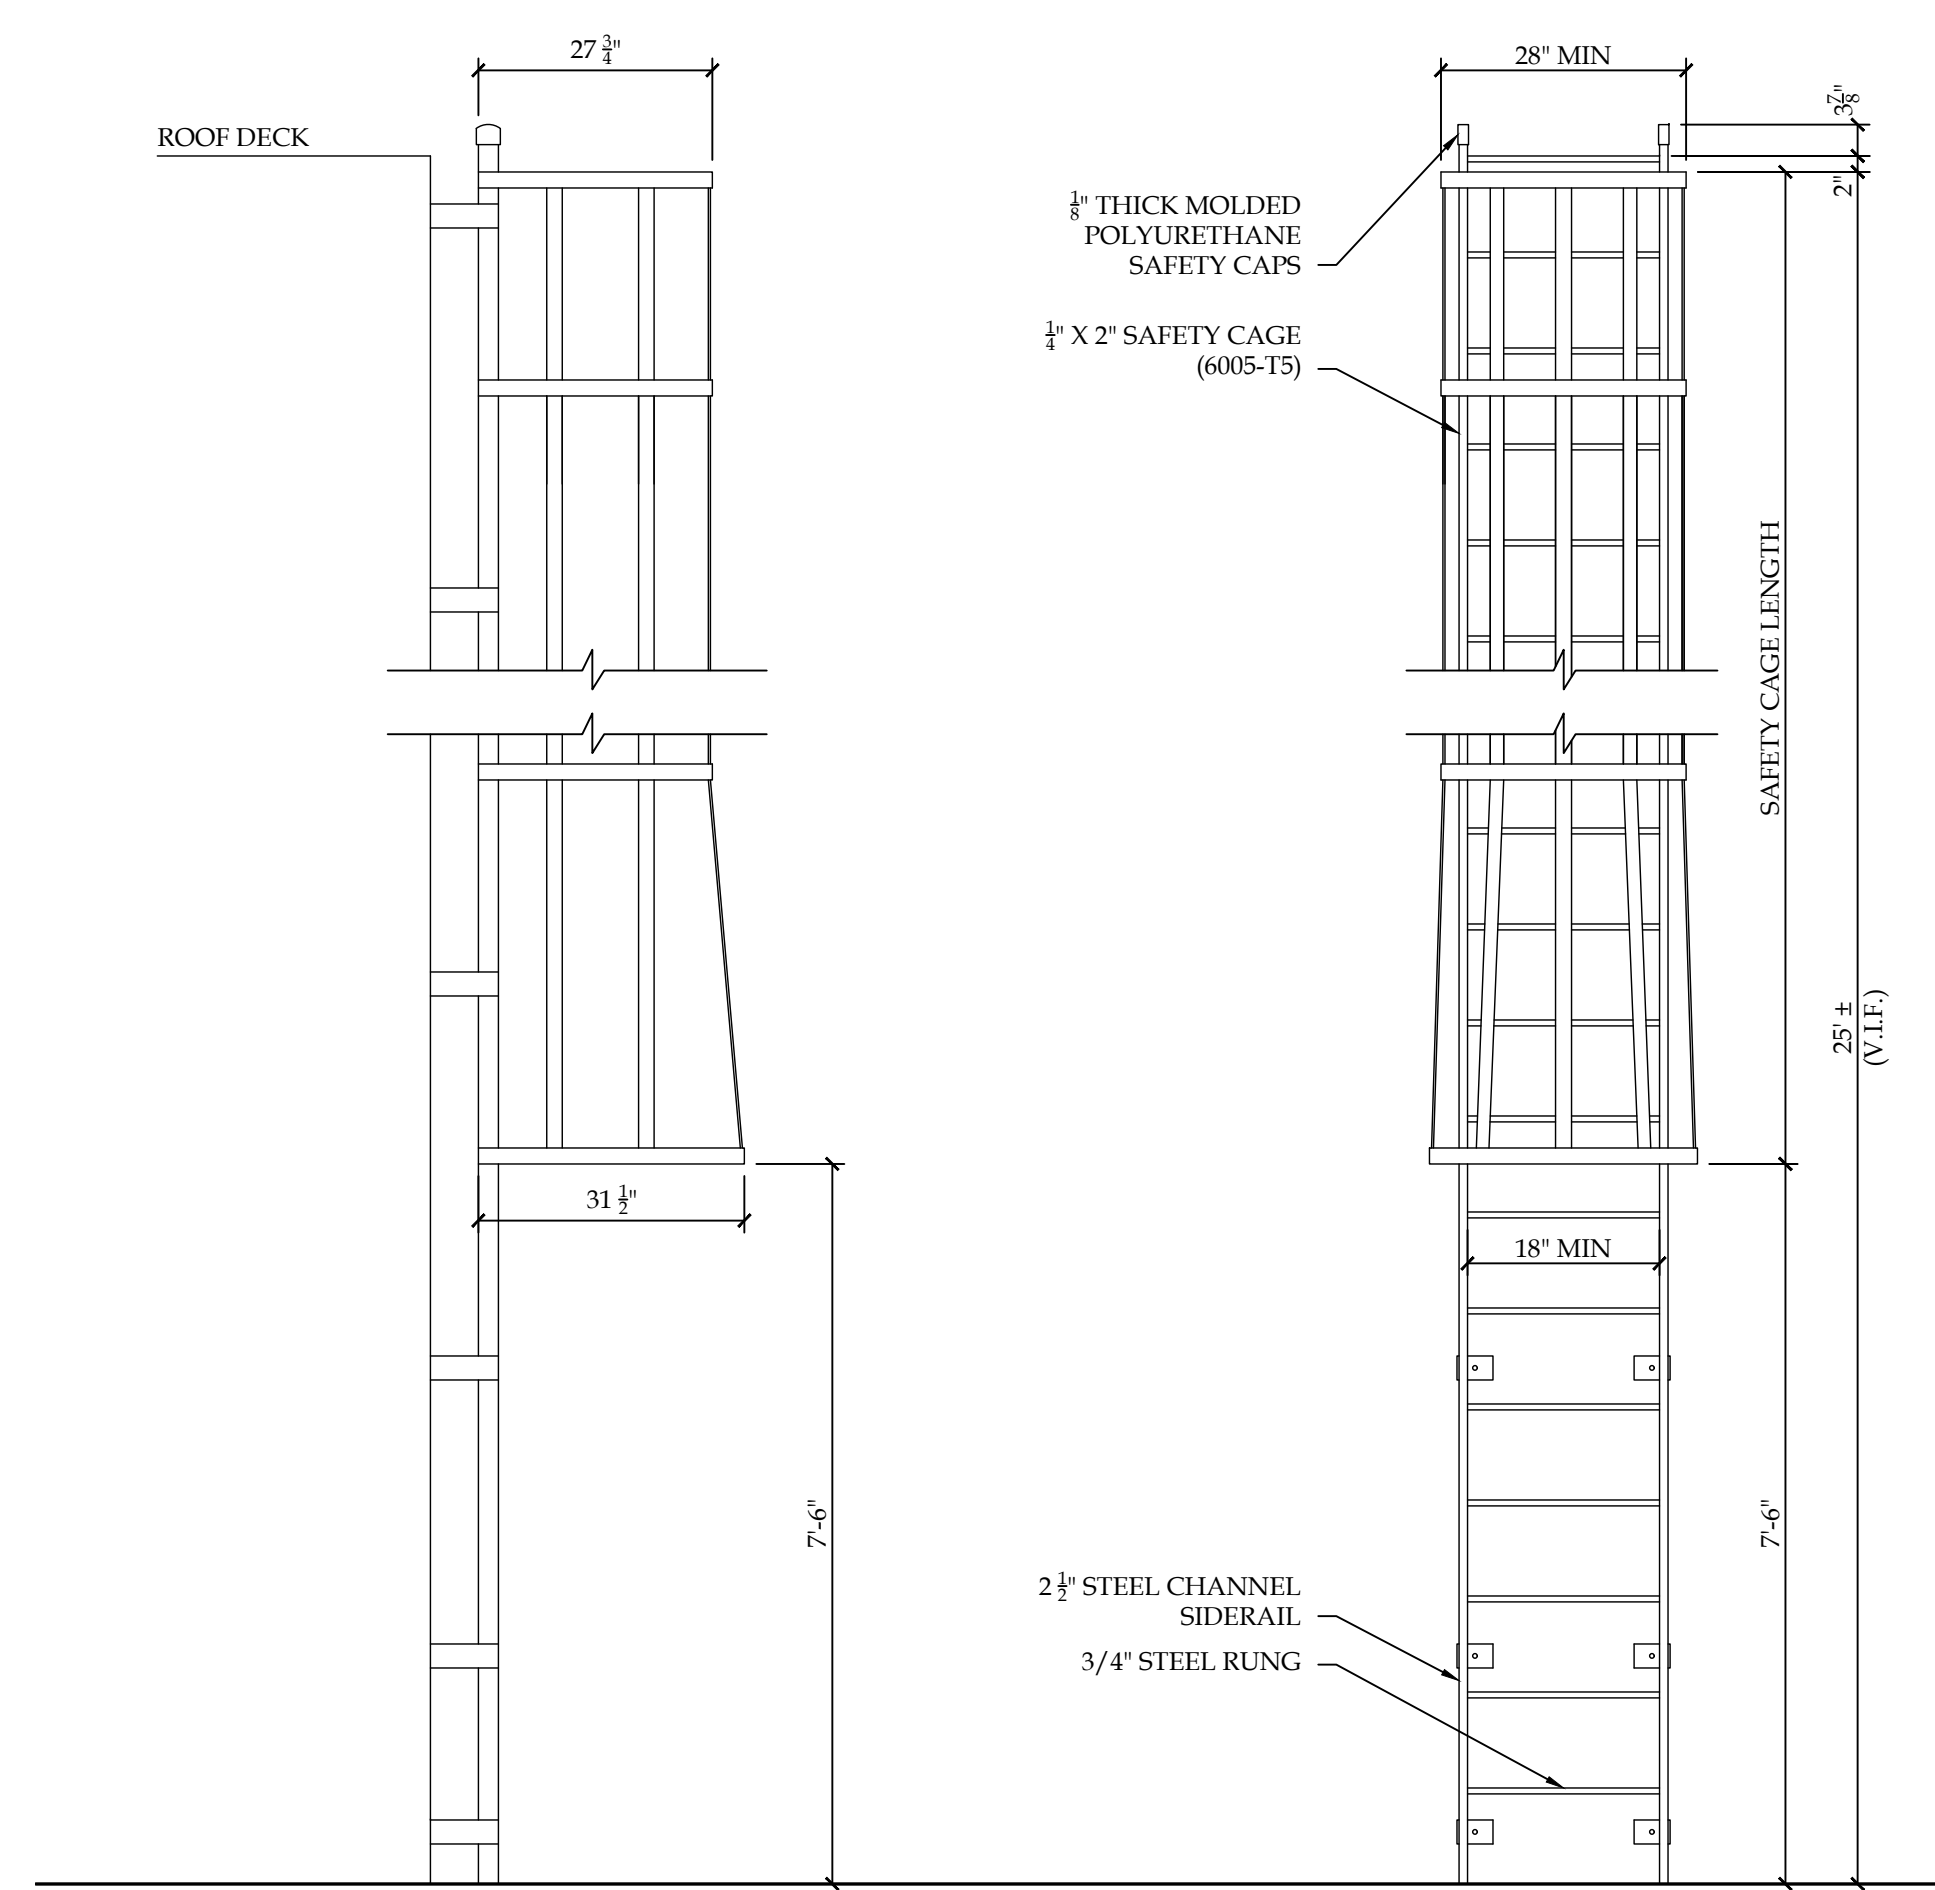
**BRYANT & STRATTON COLLEGE**  
 1320 Warwick Way  
 Mt. Pleasant, WI 53406

SEAL:


**STAIR SECTIONS & DETAILS**

**GREGORY A. TOMSIC**  
 REGISTERED ARCHITECT  
 145 BATHURST DR., TONAWANDA, N.Y. 14150  
 716-433-0617


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| SCALE<br>1/8" = 1'-0" | JOB NO.                  |
| DRAWN                 | DWG. NO.<br><b>A-304</b> |
| CHECKED               | CONTRACT NO.             |
| DATE<br>12.22.2017    |                          |




**10 LADDER & CAGE ELEVATIONS**  
 SCALE: 1/2" = 1'-0"

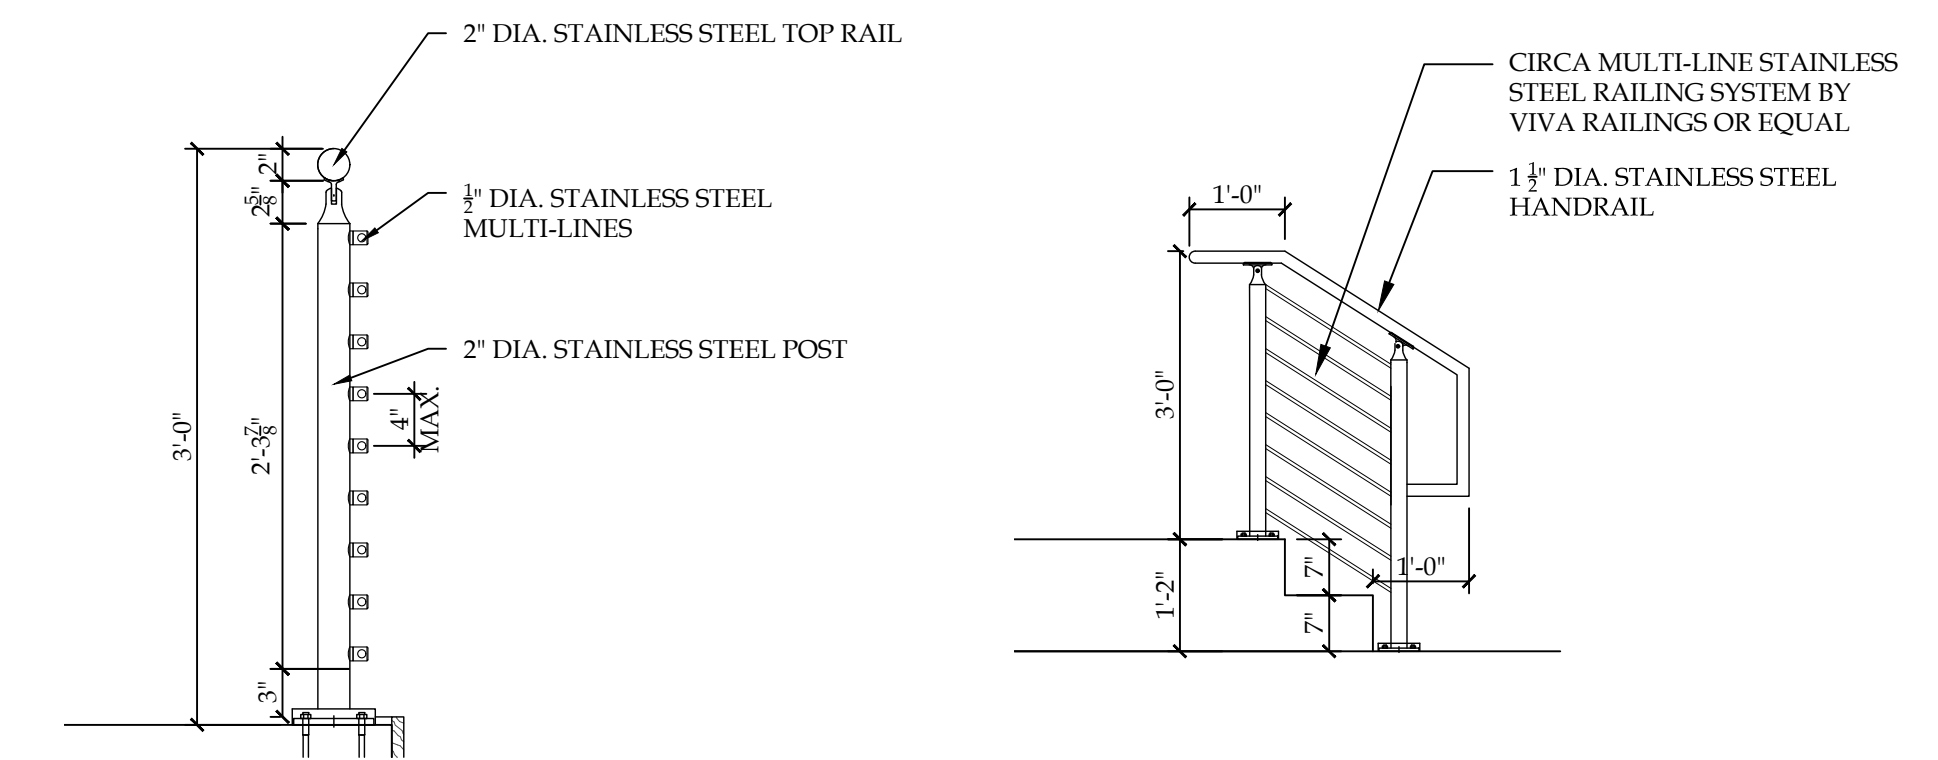


**6 RAMP GUARDRAIL SECTION**  
 SCALE: 1" = 1'-0"

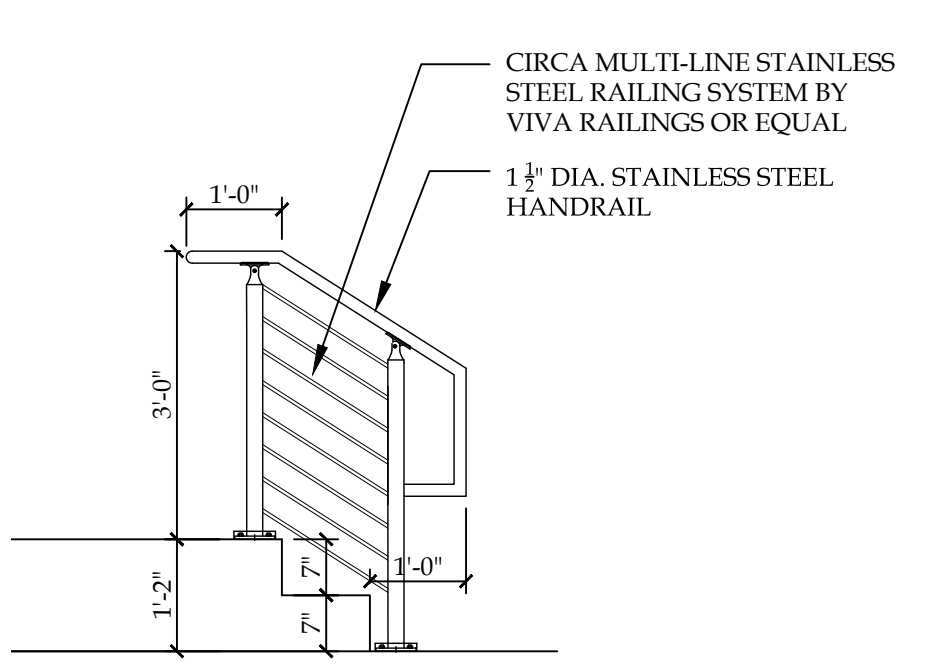


**7 STAIR SECTION**  
 SCALE: 1/2" = 1'-0"

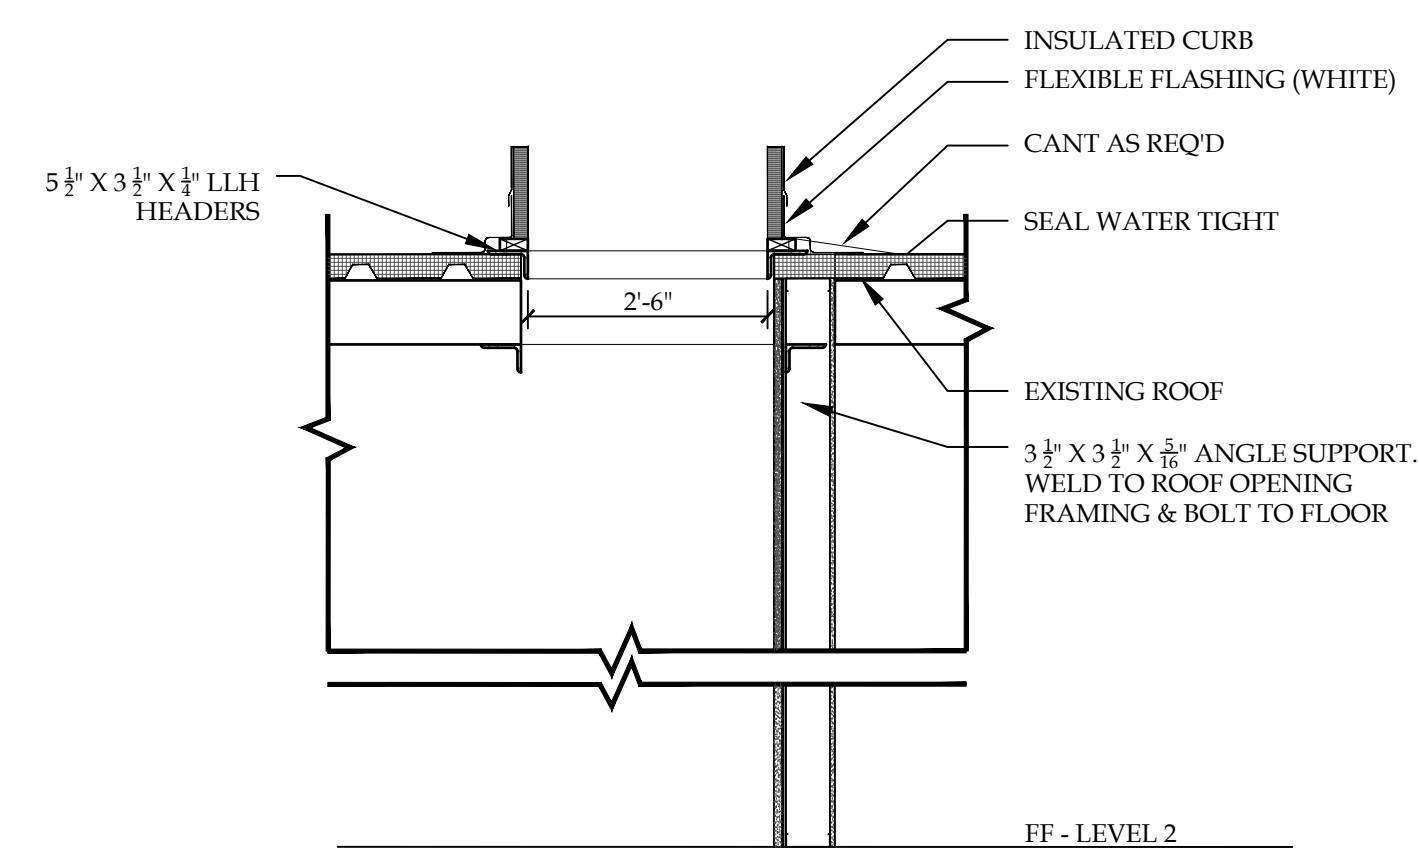


**9 ROOF HATCH SECTION**  
 SCALE: 1/2" = 1'-0"

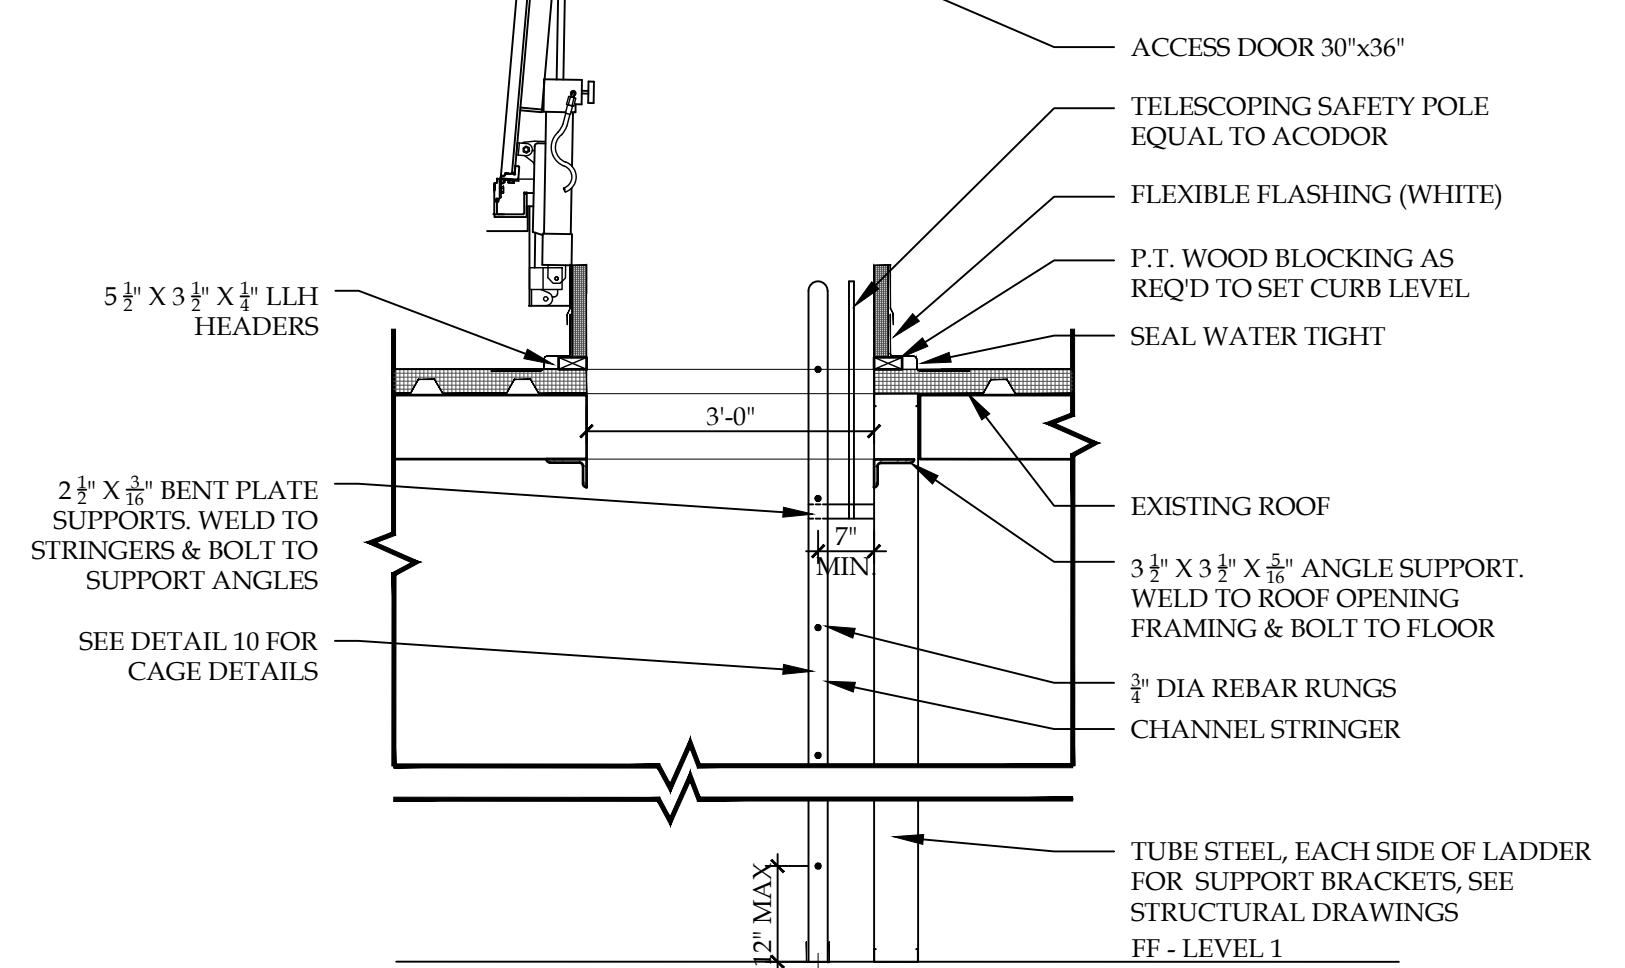

**8 ROOF HATCH SECTION**  
 SCALE: 1/2" = 1'-0"

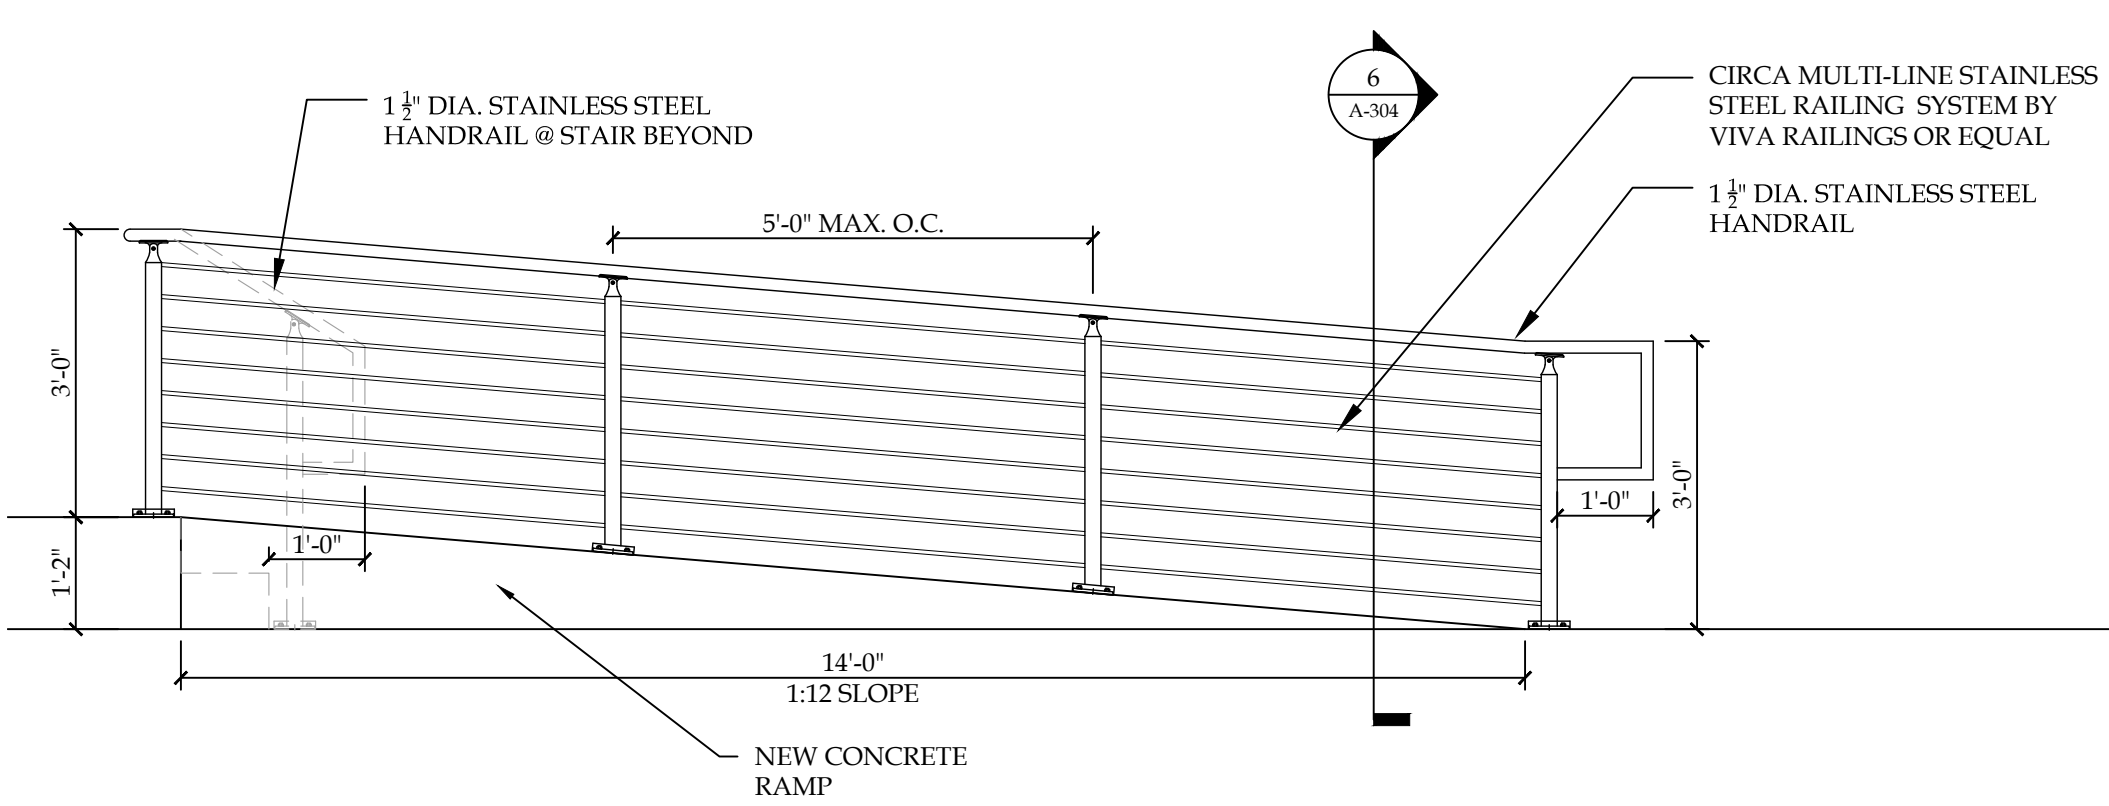

**5 RAMP SECTION**  
 SCALE: 1/2" = 1'-0"

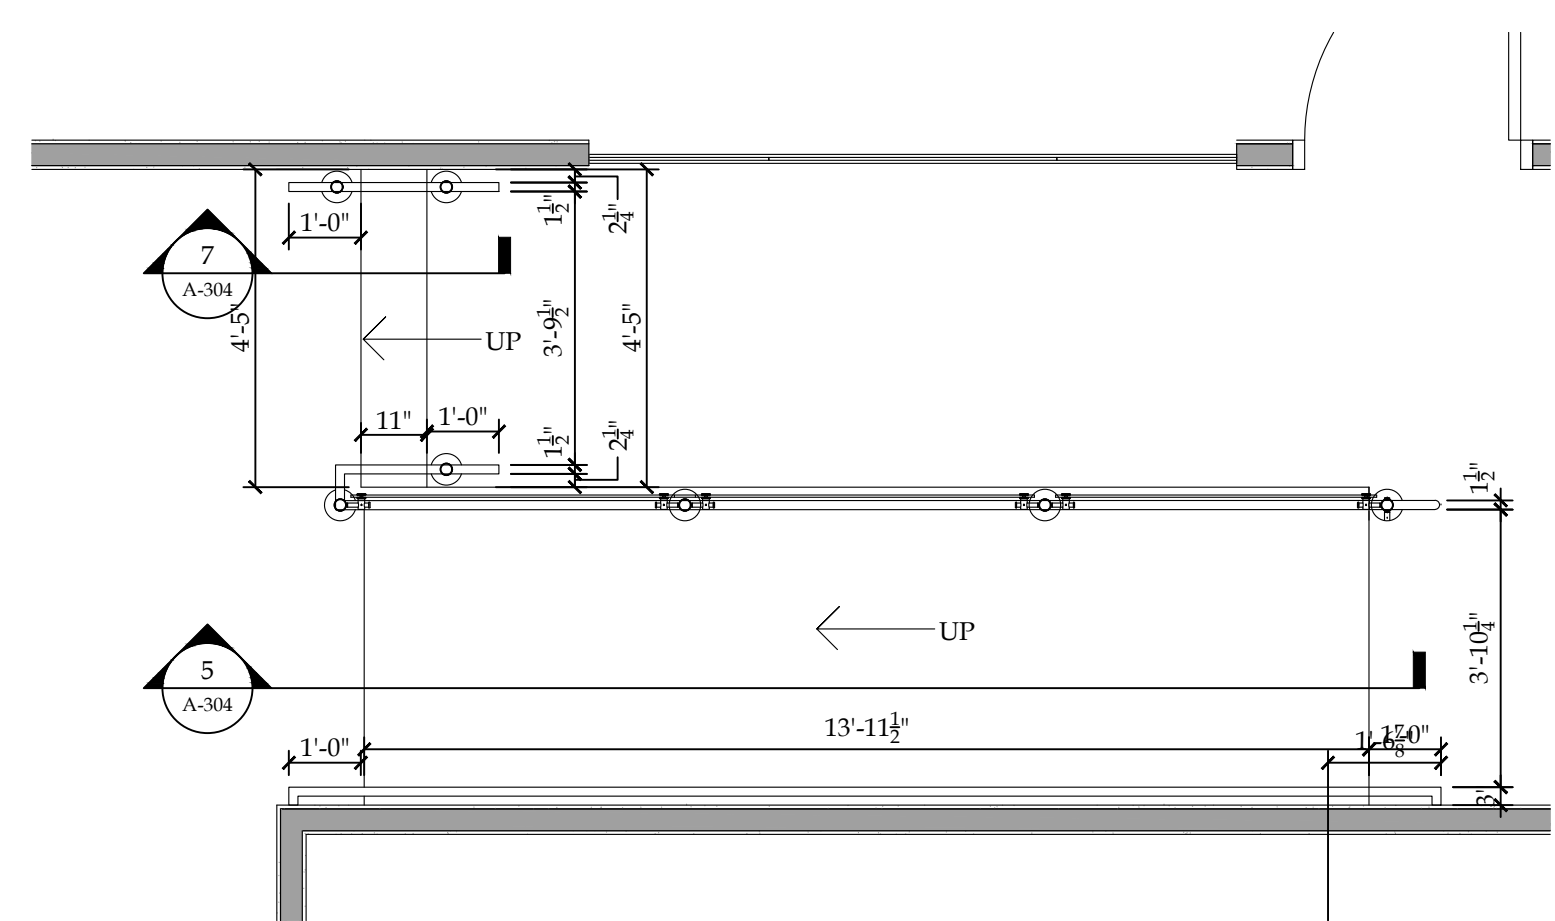

**4 ENLARGED RAMP PLAN**  
 SCALE: 3/8" = 1'-0"

| REVISION RECORD |      |         |
|-----------------|------|---------|
| NO.             | DATE | REMARKS |
|                 |      |         |

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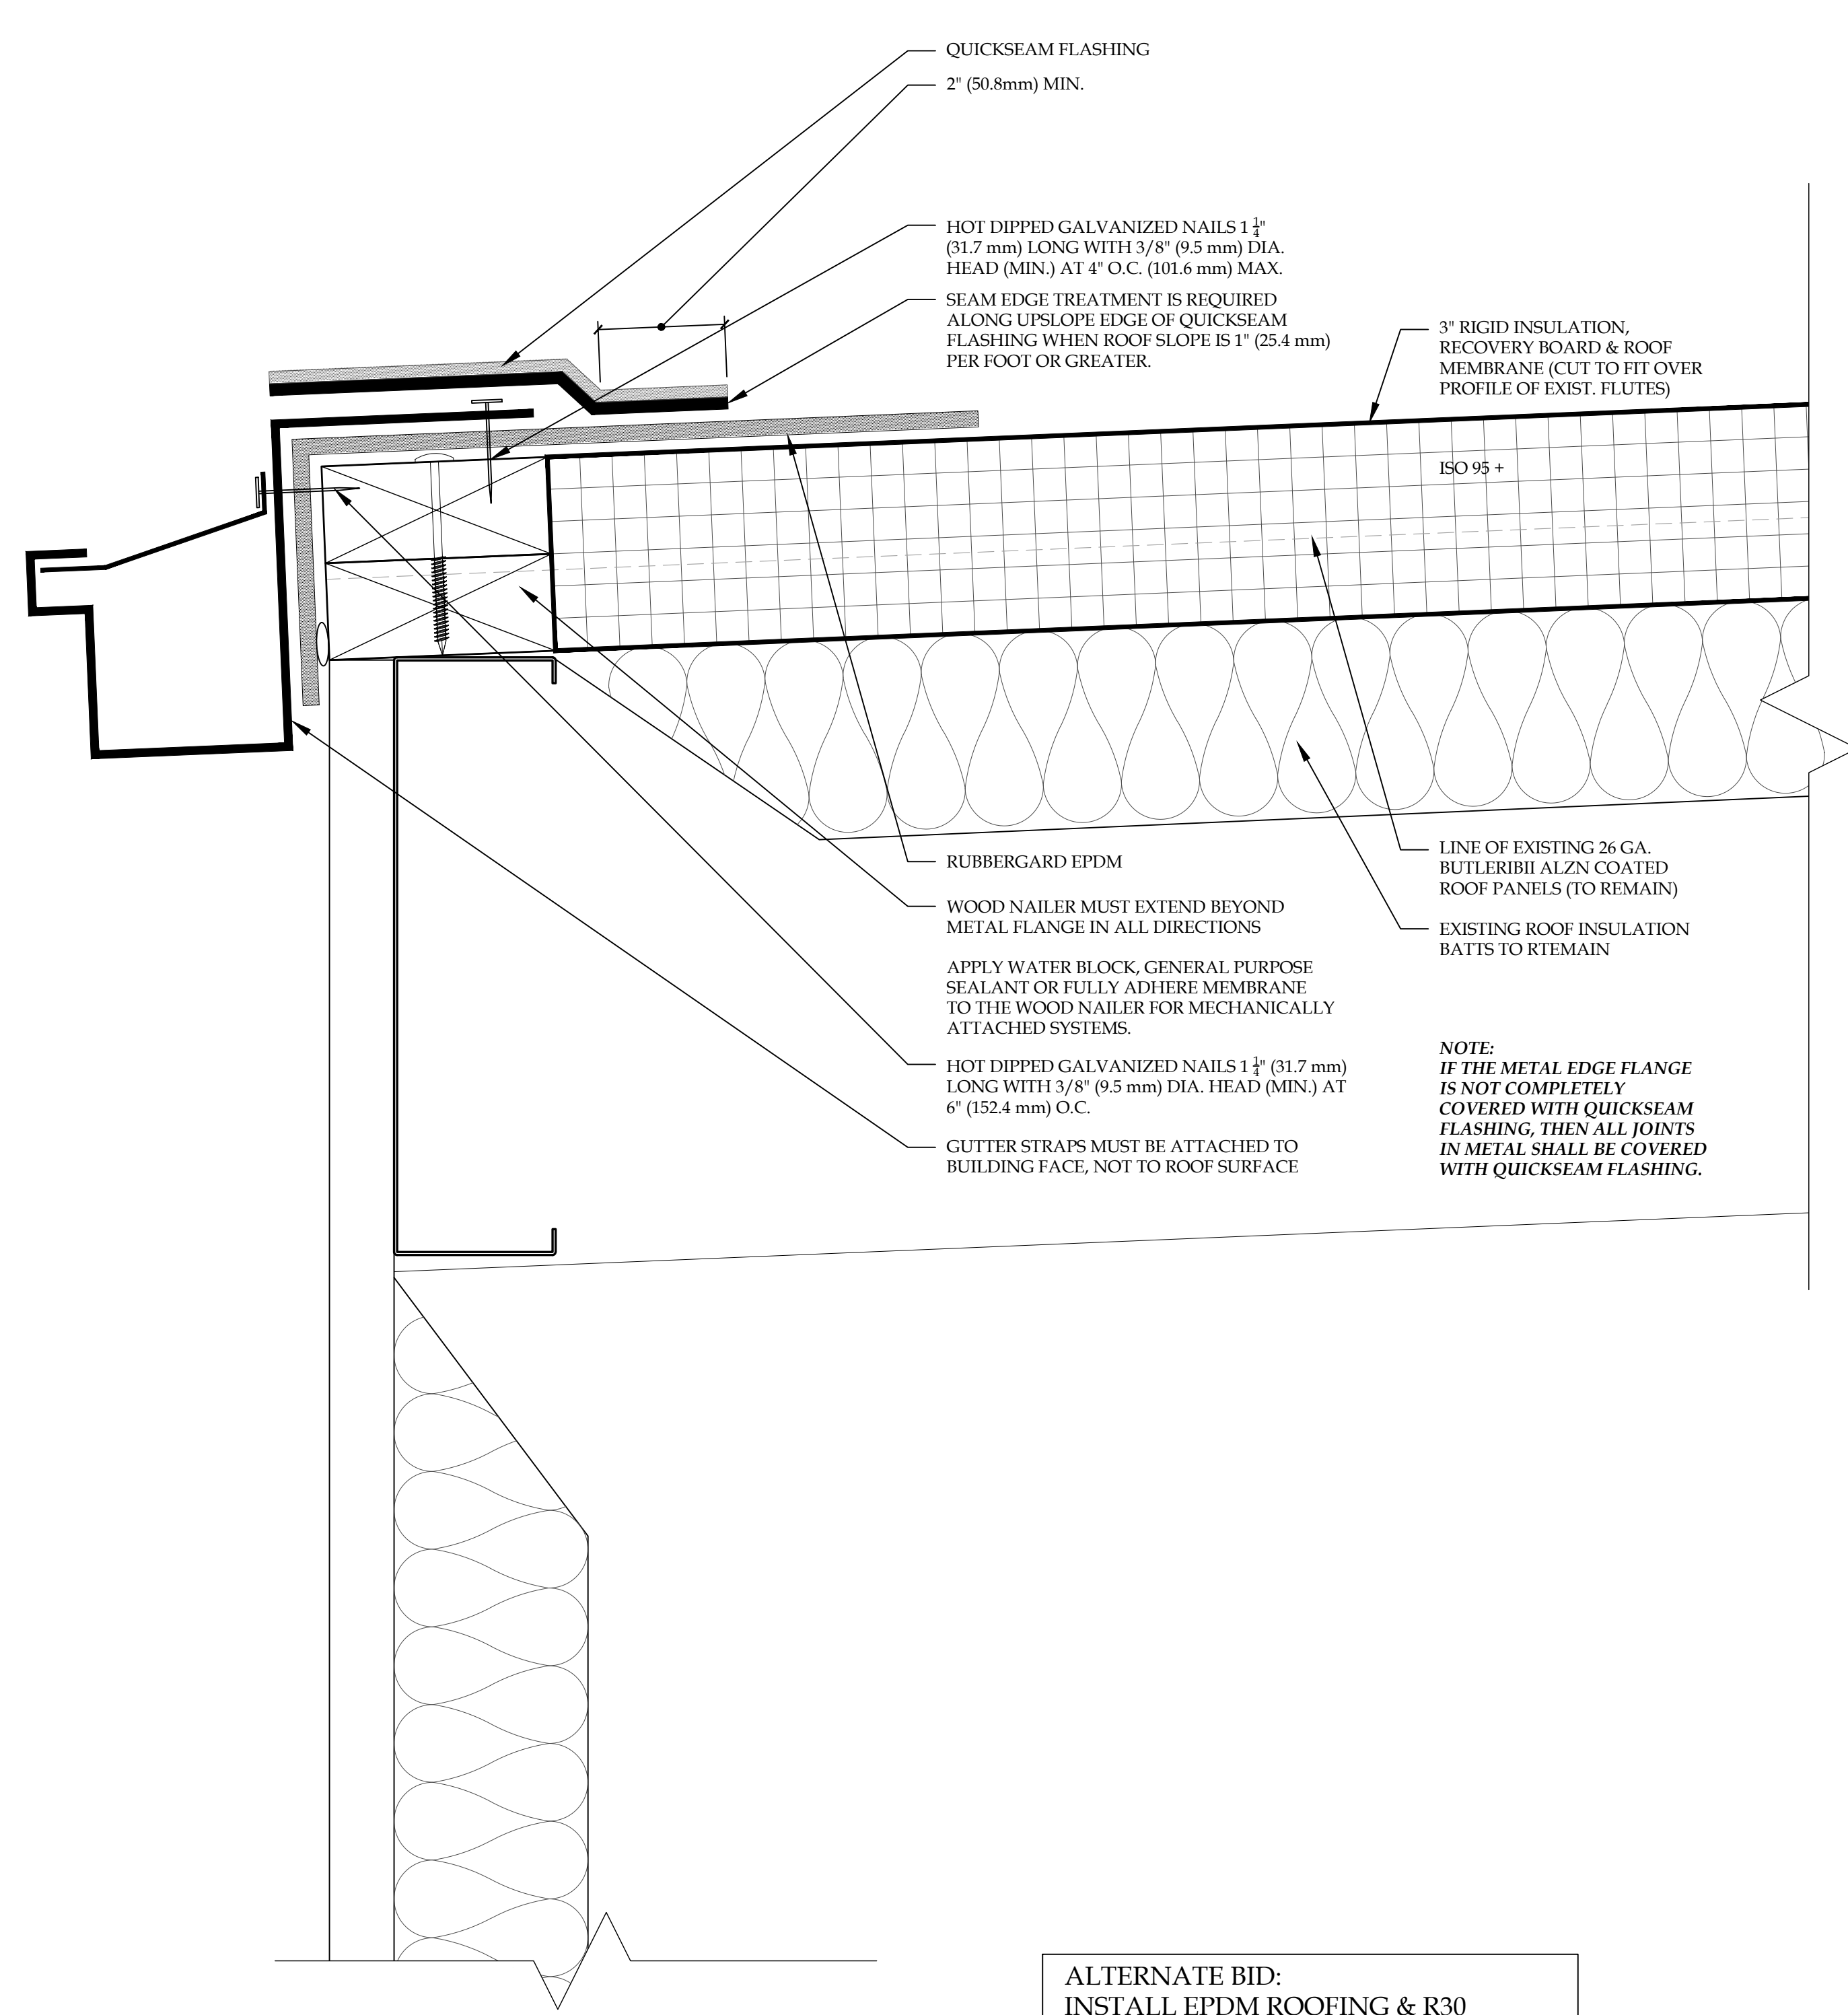
**BRYANT & STRATTON COLLEGE**  
 1320 Warwick Way  
 Mt. Pleasant, WI 53406

SEAL:

**ALTERNATE BID  
 ROOF  
 COVERING W/  
 EPDM EDGE  
 DETAILS**


**GREGORY A. TOMSIC**  
 REGISTERED ARCHITECT  
 145 BATHURST DR., TONAWANDA, N.Y. 14150  
 716-433-0617

|                       |                          |
|-----------------------|--------------------------|
| SCALE<br>1/8" = 1'-0" | JOB NO.                  |
| DRAWN                 | DWG. NO.<br><b>A-305</b> |
| CHECKED               | CONTRACT NO.             |
| DATE<br>12.22.2017    |                          |



**A ROOF GUTTER DETAIL**  
 SCALE: 3" = 1'-0"

ALTERNATE BID:  
 INSTALL EPDM ROOFING & R30 INSULATION ON EXISTING METAL ROOF. PROVIDE NEW GUTTER & EDGE FLASHING AS DETAILED HEREIN.

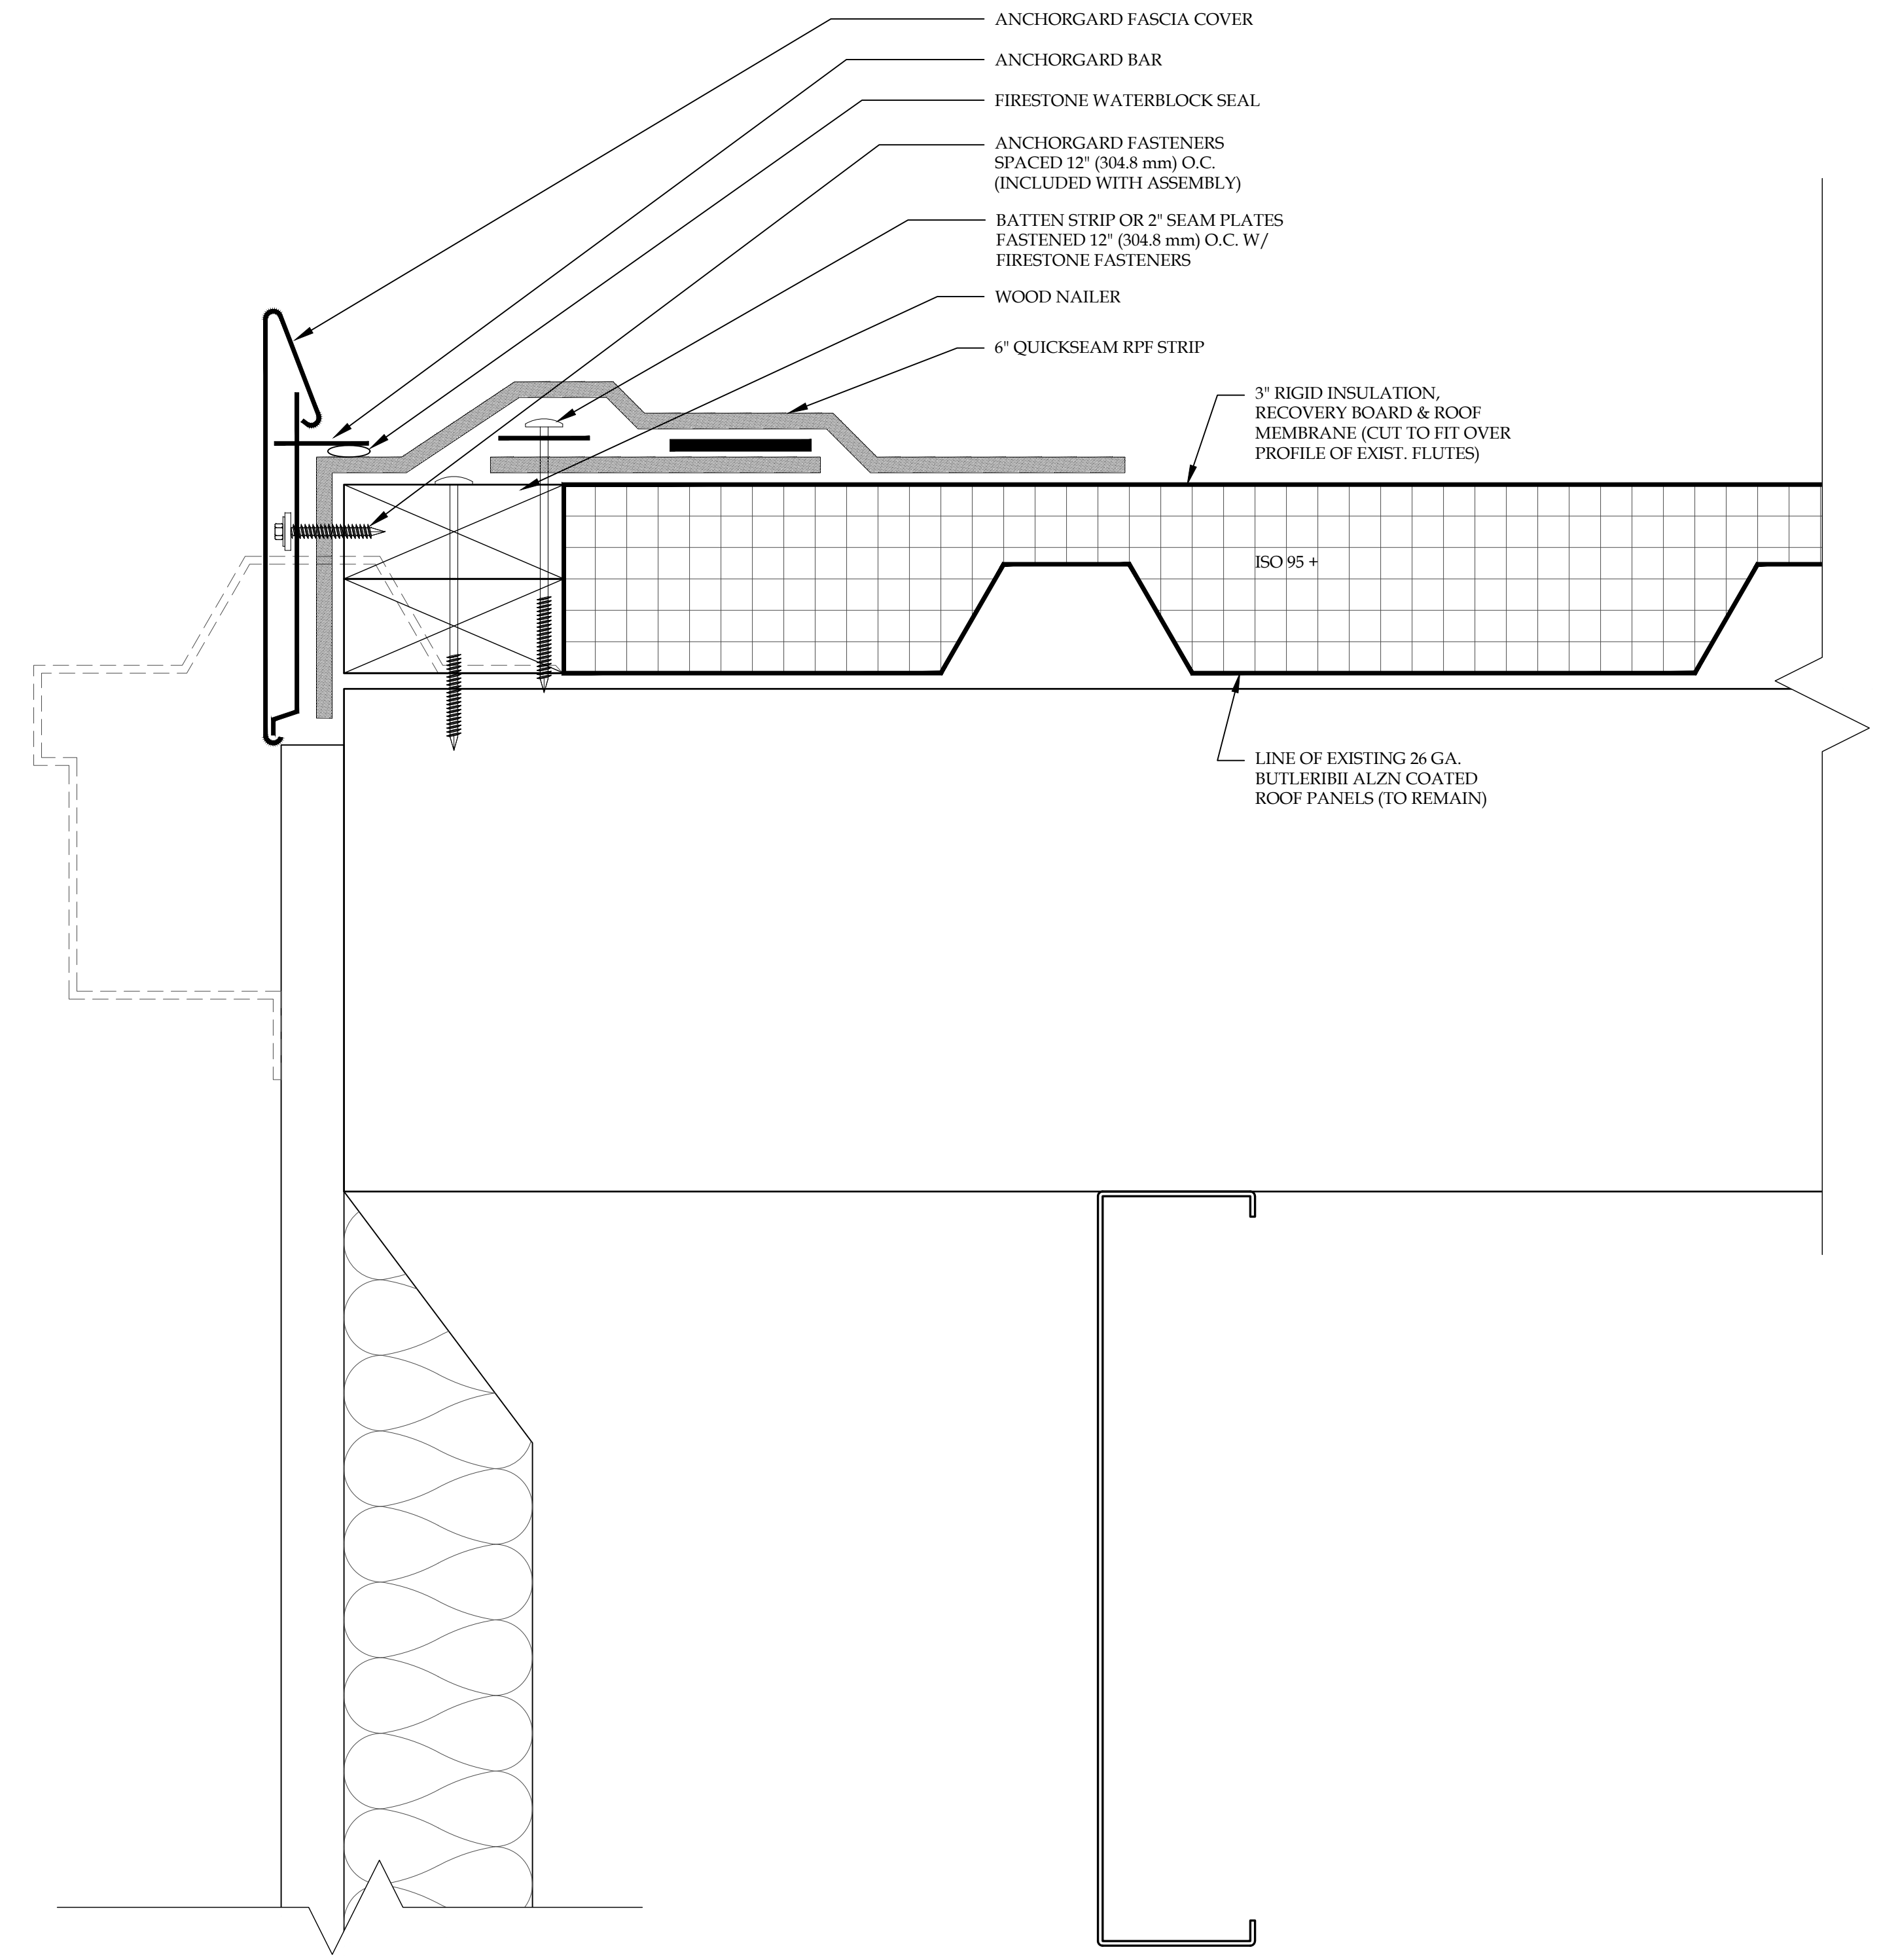

**B ROOF EDGE DETAIL**  
 SCALE: 3" = 1'-0"



| REVISION RECORD |      |         |
|-----------------|------|---------|
| NO.             | DATE | REMARKS |
|                 |      |         |
|                 |      |         |

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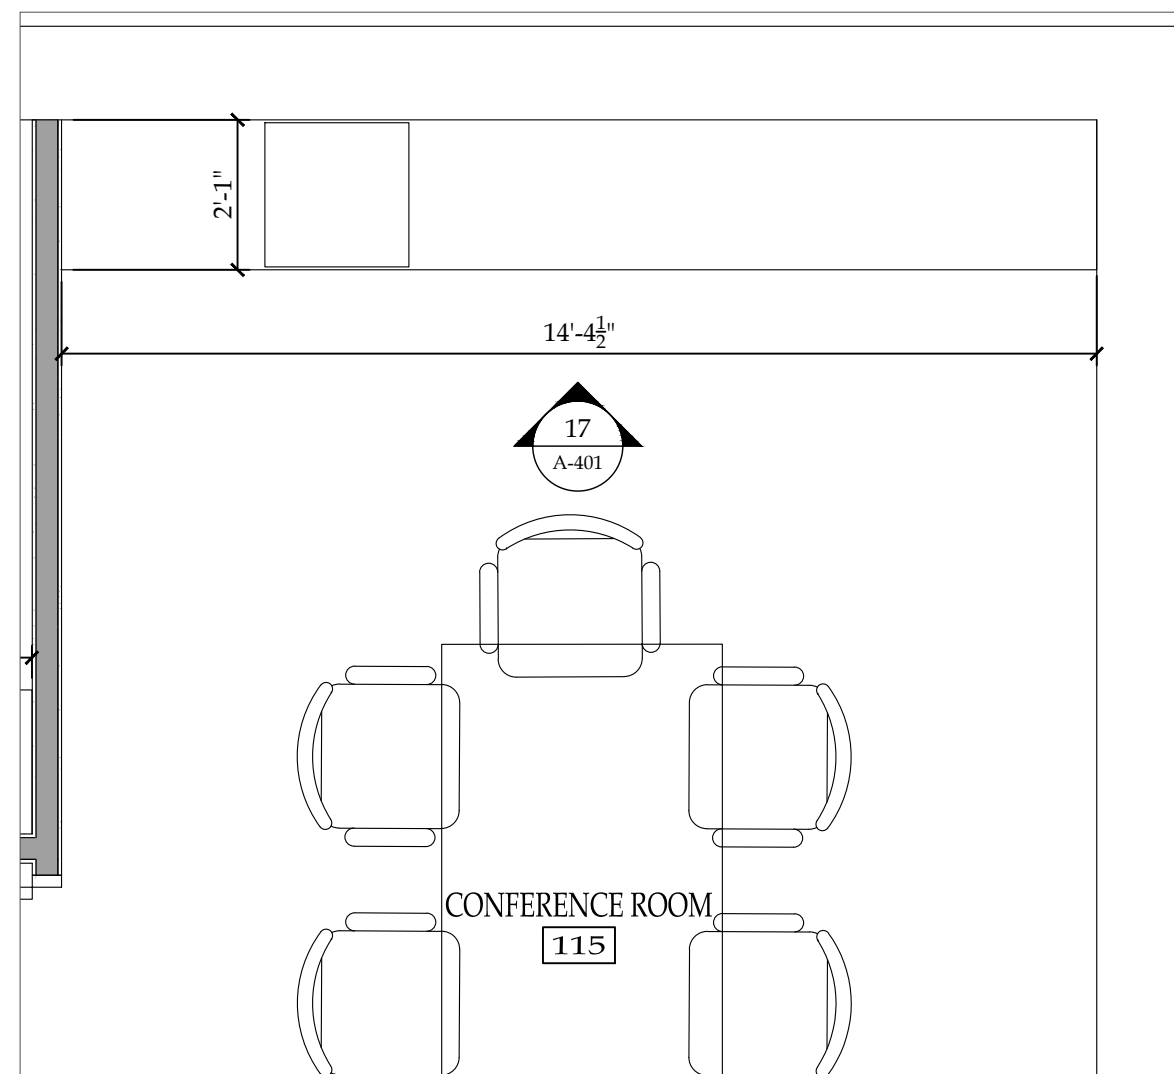
**BRYANT & STRATTON COLLEGE**  
 1320 Warwick Way  
 Mt. Pleasant, WI 53406

SEAL:


**ENLARGED FLOOR PLANS & INTERIOR ELEVATIONS**

**GREGORY A. TOMSIC**  
 REGISTERED ARCHITECT  
 145 BATHURST DR., TONAWANDA, N.Y. 14150  
 716-435-0617


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|-----------------------|--------------------------|
| SCALE<br>1/8" = 1'-0" | JOB NO.                  |
| DRAWN                 | DWG. NO.<br><b>A-401</b> |
| CHECKED               |                          |
| DATE<br>12.22.2017    | CONTRACT NO.             |




16 ENLARGED PLAN - CONFERENCE ROOM #115  
SCALE: 3/8"=1'-0"

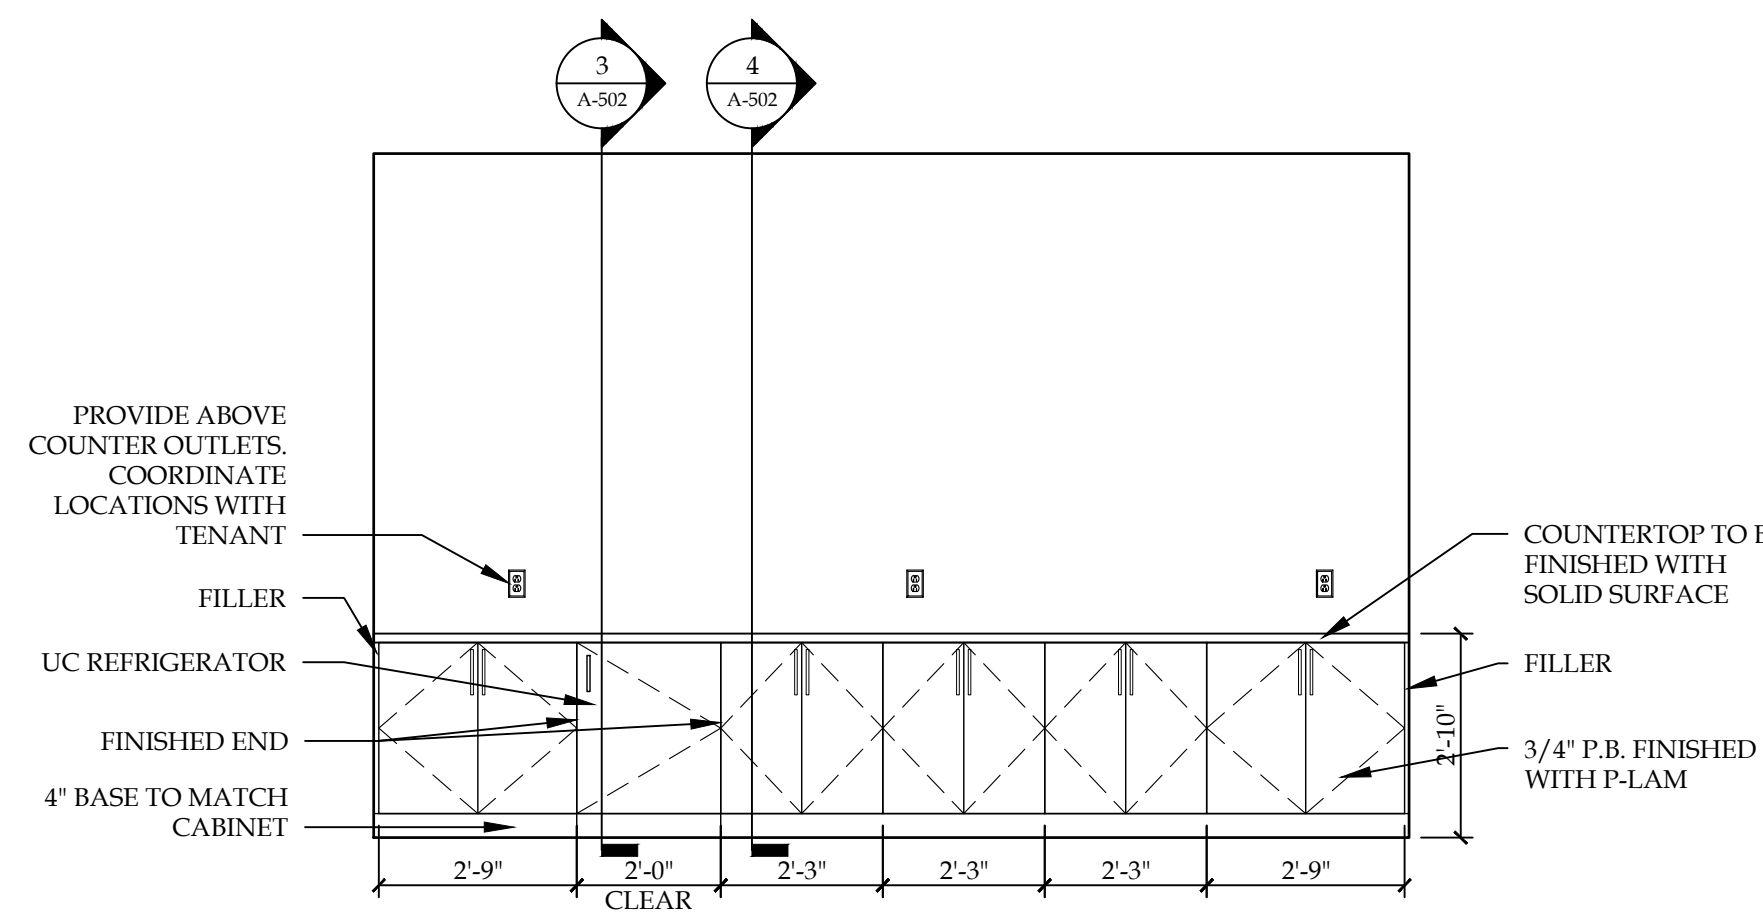


17 ELEVATION - CONFERENCE ROOM #115  
SCALE: 3/8"=1'-0"

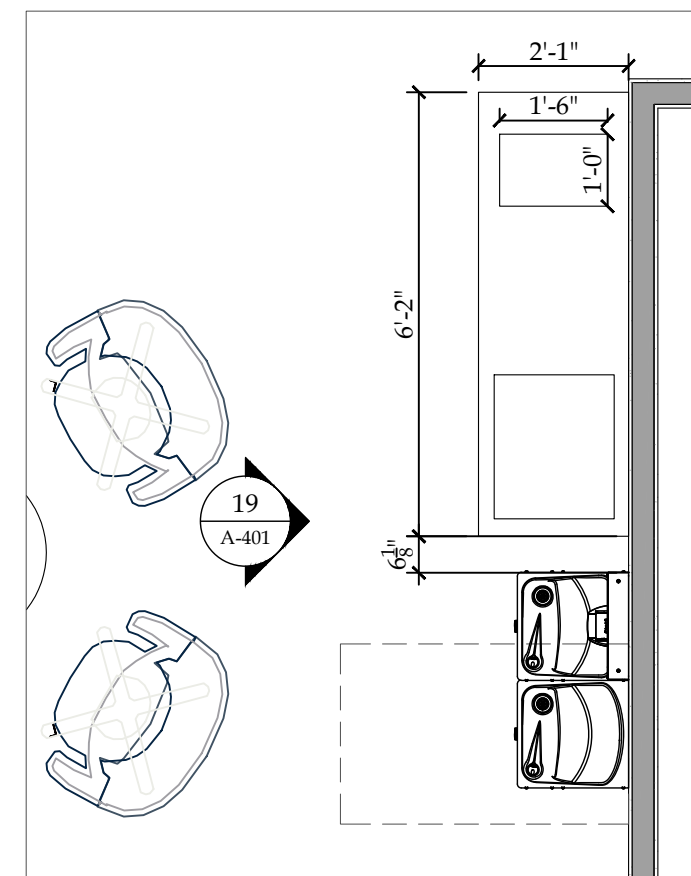


18 ENLARGED PLAN - OPEN LOUNGE SPACE #115  
SCALE: 3/8"=1'-0"

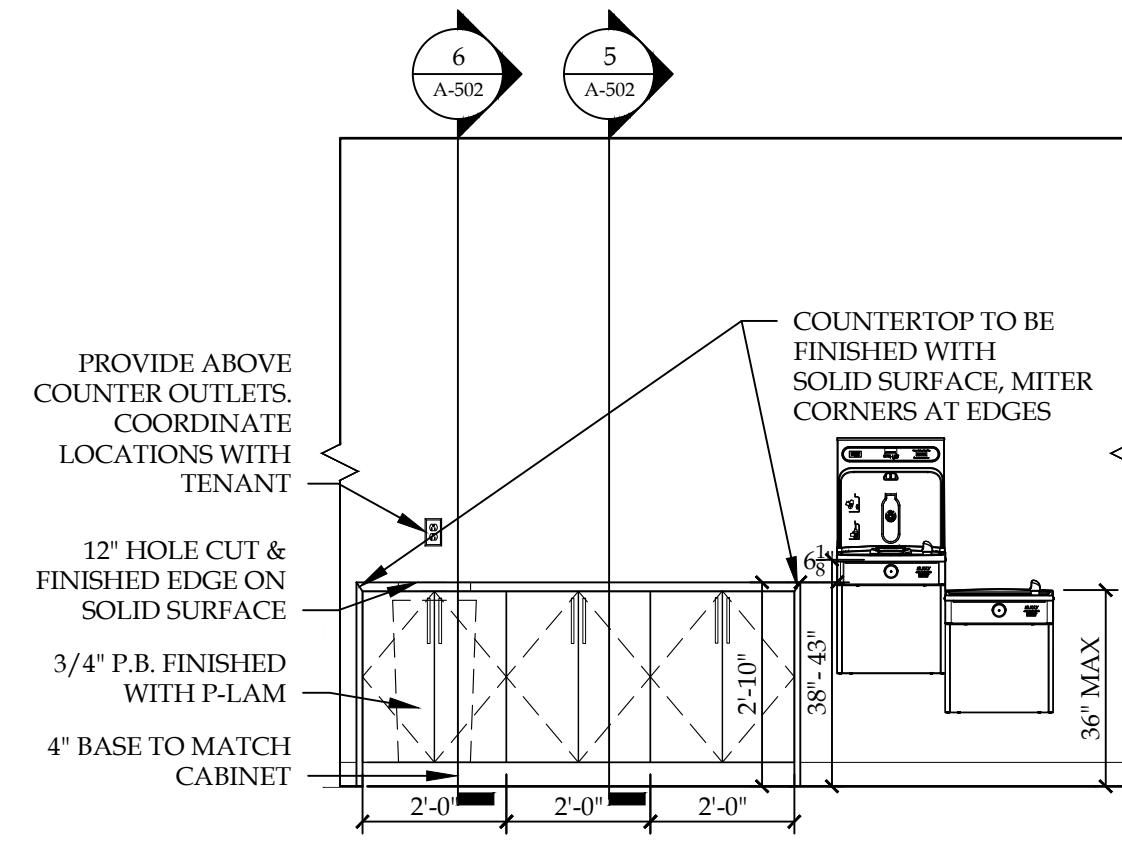


19 ELEVATION - OPEN LOUNGE SPACE #115  
SCALE: 3/8"=1'-0"

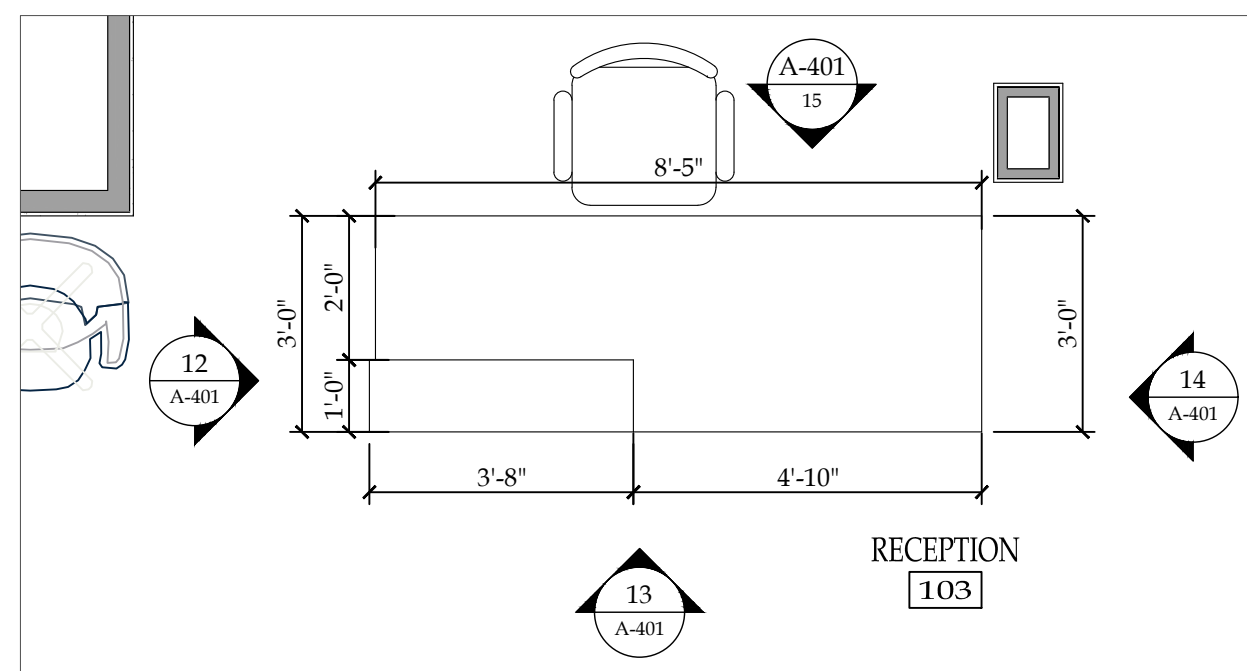


11 ENLARGED PLAN - RECEPTION #103  
SCALE: 3/8"=1'-0"

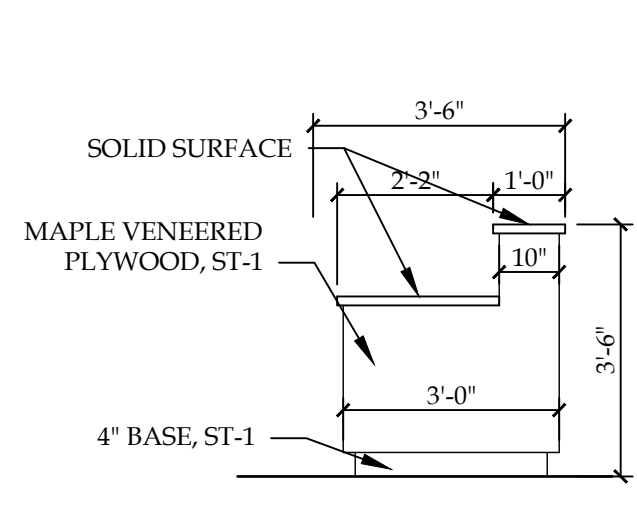


12 ELEVATION - RECEPTION #103  
SCALE: 3/8"=1'-0"

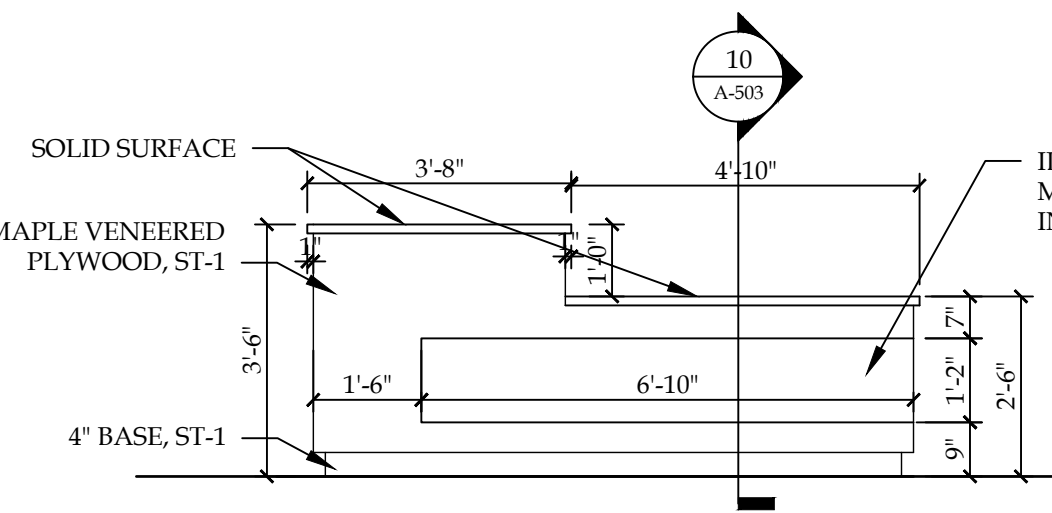


13 ELEVATION - RECEPTION #103  
SCALE: 3/8"=1'-0"

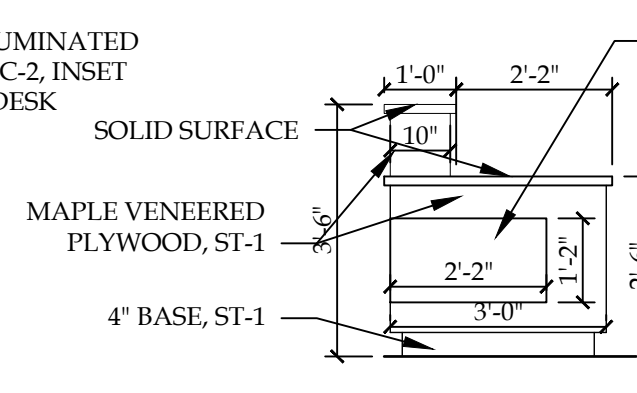


14 ELEVATION - RECEPTION #103  
SCALE: 3/8"=1'-0"

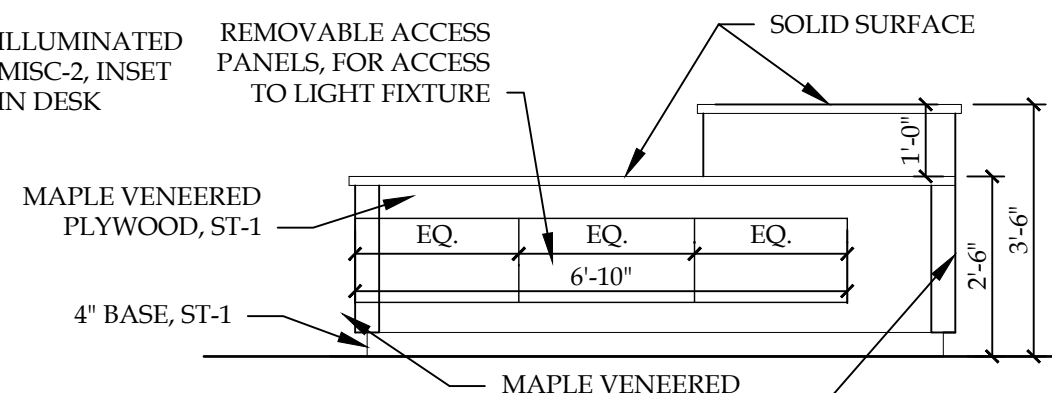


15 ELEVATION - RECEPTION #103  
SCALE: 3/8"=1'-0"

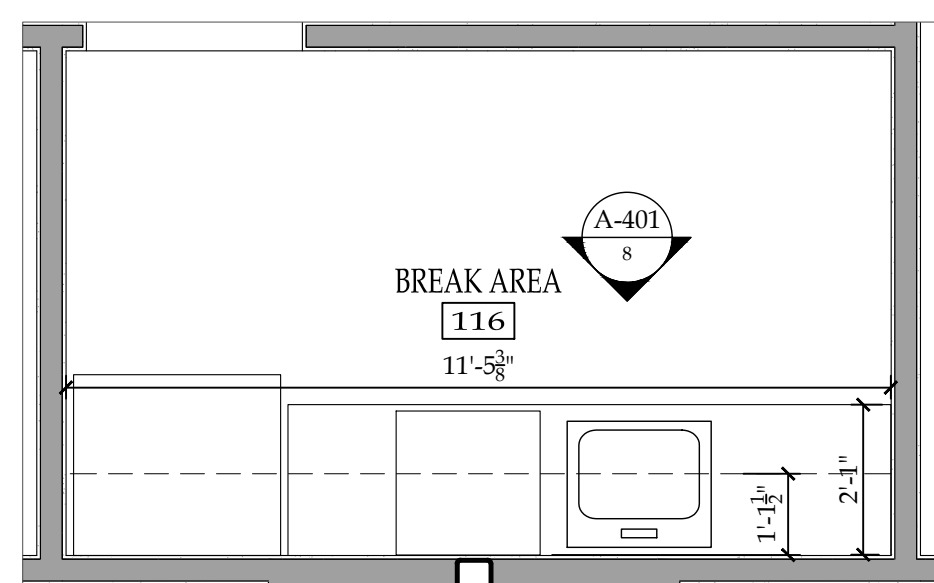


7 ENLARGED PLAN - BREAK ROOM #116  
SCALE: 3/8"=1'-0"

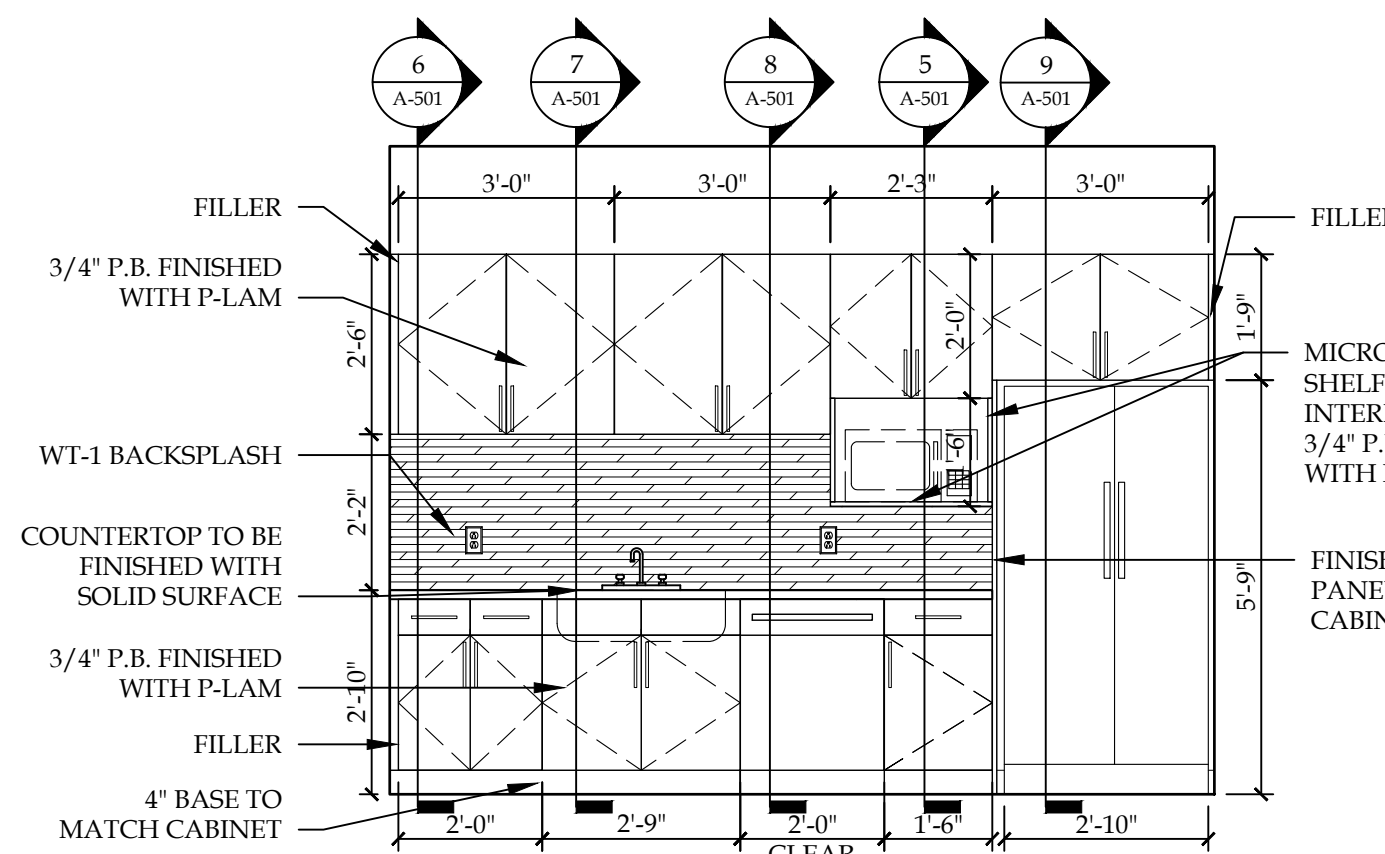


8 ELEVATION - BREAK ROOM #116  
SCALE: 3/8"=1'-0"

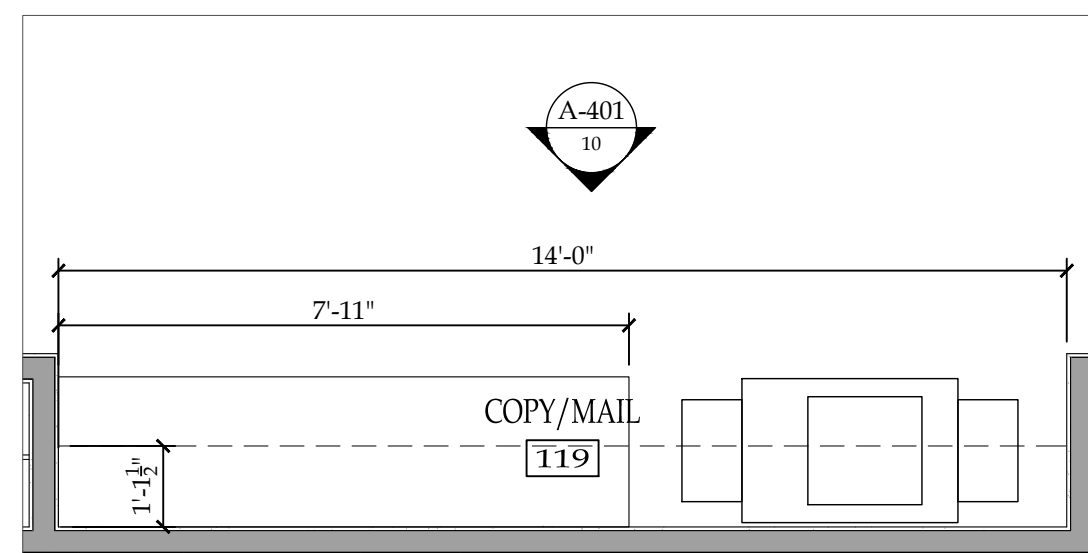


9 ENLARGED PLAN - COPY/MAIL #119  
SCALE: 3/8"=1'-0"

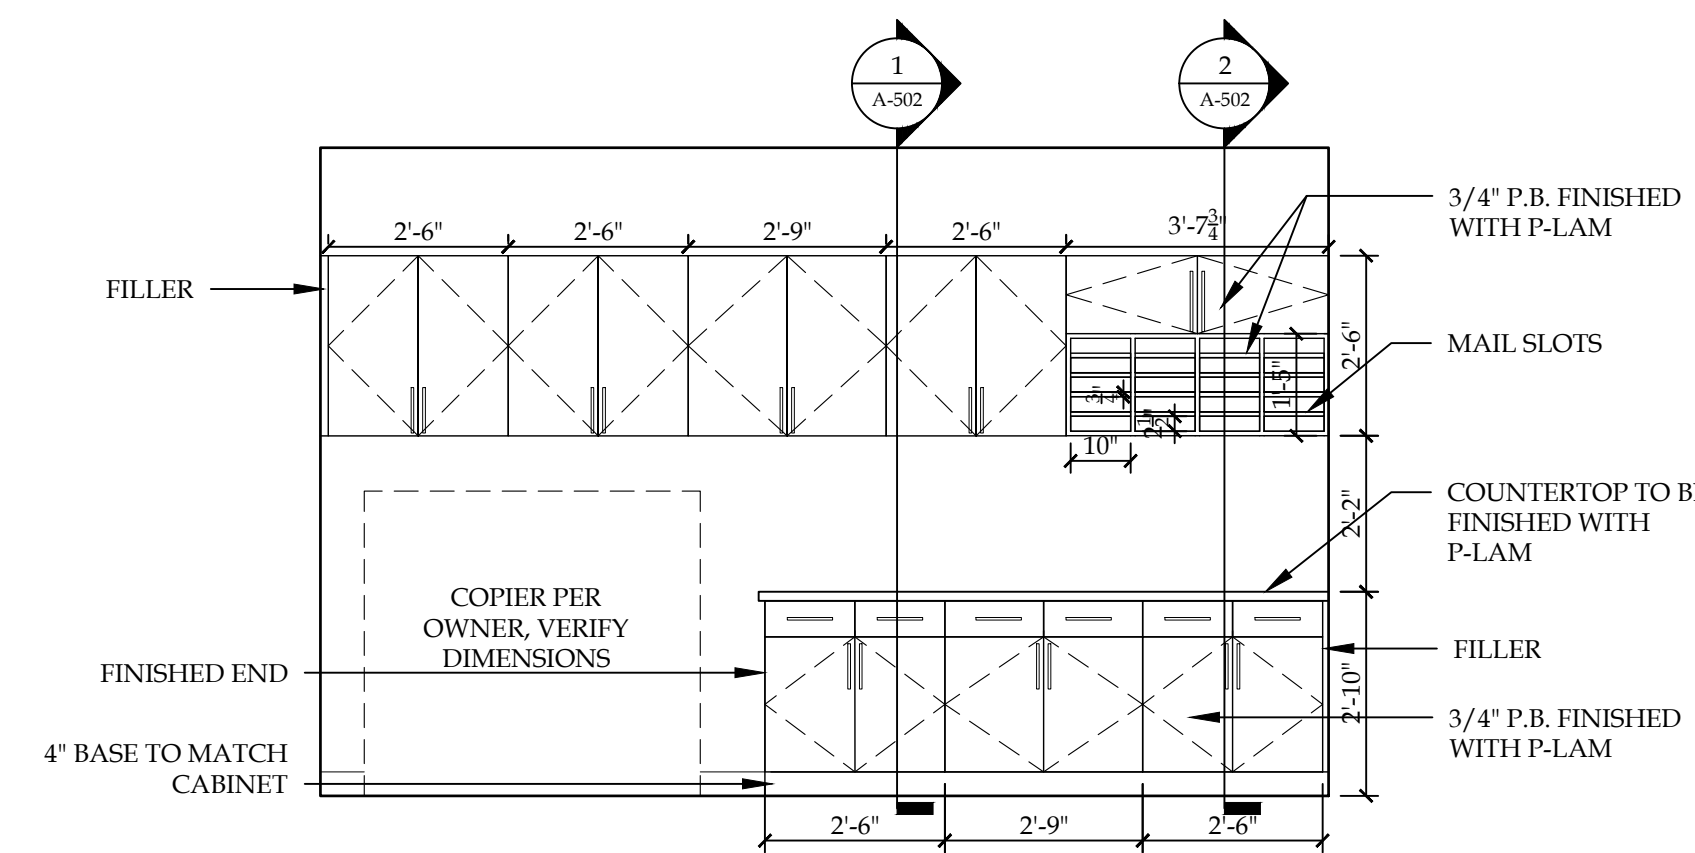


10 ELEVATION - COPY/MAIL #119  
SCALE: 3/8"=1'-0"

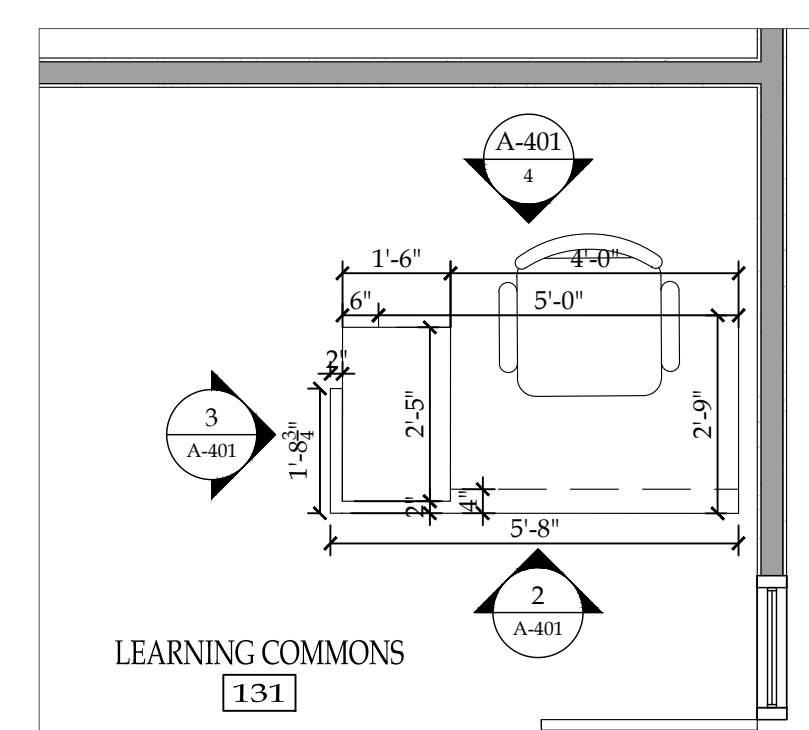


1 ENLARGED PLAN - LEARNING COMMONS #131  
SCALE: 3/8"=1'-0"

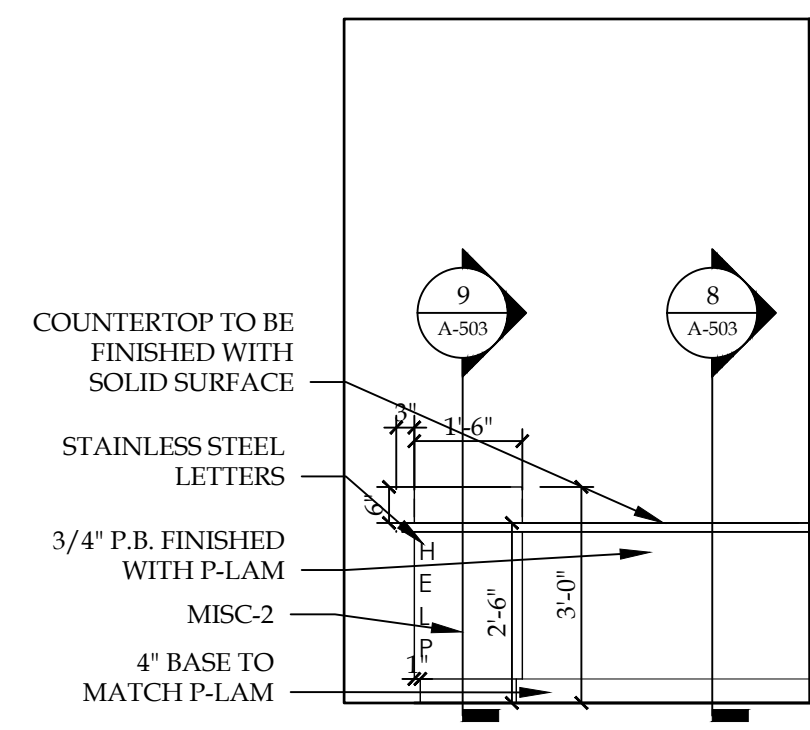


2 ELEVATION - LEARNING COMMONS #131  
SCALE: 3/8"=1'-0"

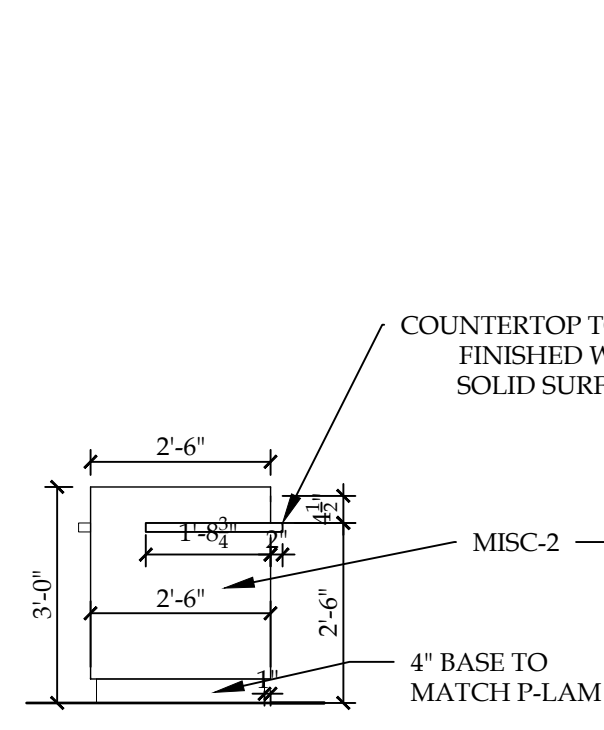


3 ELEVATION - LEARNING COMMONS #131  
SCALE: 3/8"=1'-0"

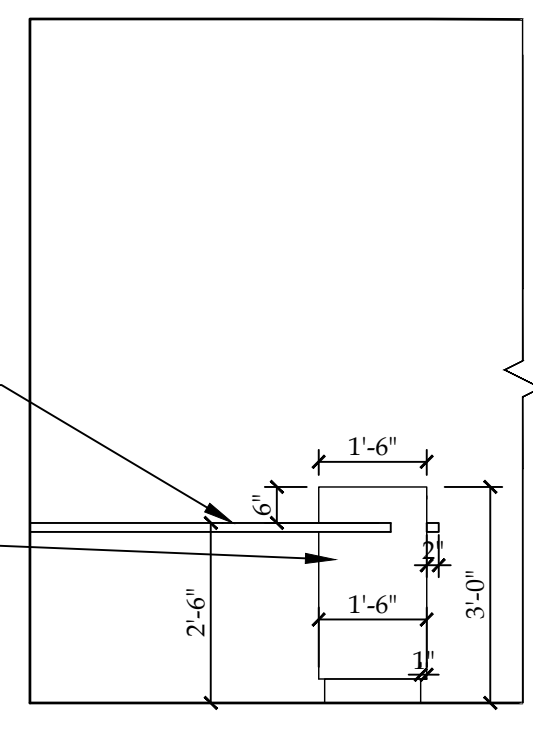

4 ELEVATION - LEARNING COMMONS #131  
SCALE: 3/8"=1'-0"

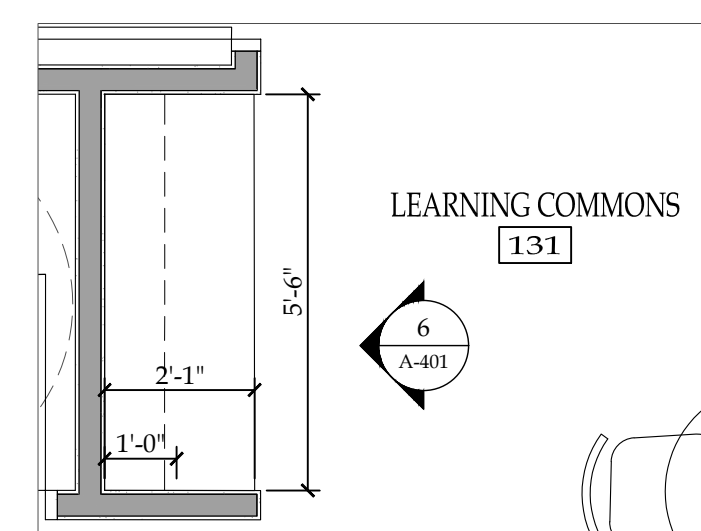

5 ENLARGED PLAN - LEARNING COMMONS #131  
SCALE: 3/8"=1'-0"

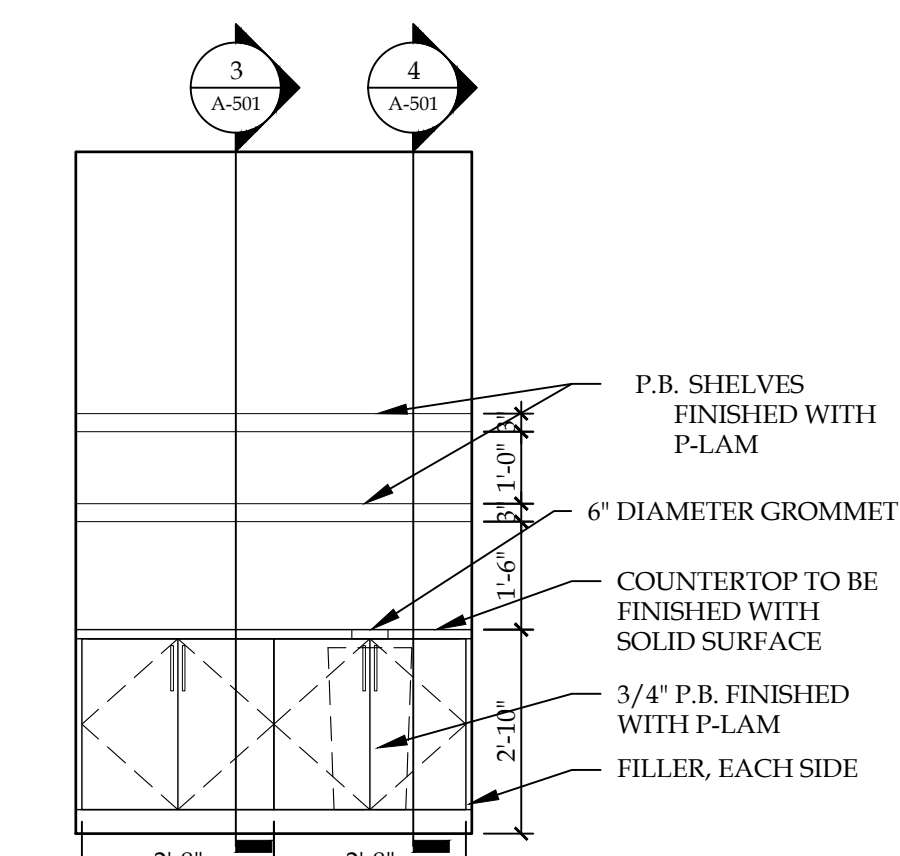

6 ELEVATION - LEARNING COMMONS #131  
SCALE: 3/8"=1'-0"







SEE A-606 TO FIND  
ACCESSORY SCHEDULE.

| REVISION RECORD |      |         |
|-----------------|------|---------|
| NO.             | DATE | REMARKS |
|                 |      |         |

IT IS A VIOLATION OF STATE LAW FOR ANY PERSON, UNLESS ACTING UNDER THE DIRECTION OF A NEW YORK STATE ARCHITECT OR ENGINEER, TO ALTER ANY ITEM ON THIS DOCUMENT IN ANY WAY. IF ANY ITEM ON THIS DOCUMENT IS ALTERED, THE ALTERING ARCHITECT OR ENGINEER SHALL AFFIX HIS/HER SEAL AND THE NOTATION "ALTERED BY" FOLLOWED BY HIS SIGNATURE, THE DATE OF SUCH ALTERATION AND A SPECIFIC DESCRIPTION OF SUCH ALTERATION.





**BRYANT & STRATTON  
COLLEGE**  
1320 Warwick Way  
Mt. Pleasant, WI 53406

SEAL:


**ENLARGED  
FLOOR PLANS  
& INTERIOR  
ELEVATIONS**

**GREGORY A. TOMSIC**  
REGISTERED ARCHITECT  
145 BATHURST DR., TONAWANDA, N.Y. 14150  
716-435-0617


|                       |                          |
|-----------------------|--------------------------|
| SCALE<br>1/8" = 1'-0" | JOB NO.                  |
| DRAWN                 | DWG. NO.<br><b>A-404</b> |
| CHECKED               |                          |
| DATE<br>12.22.2017    | CONTRACT NO.             |

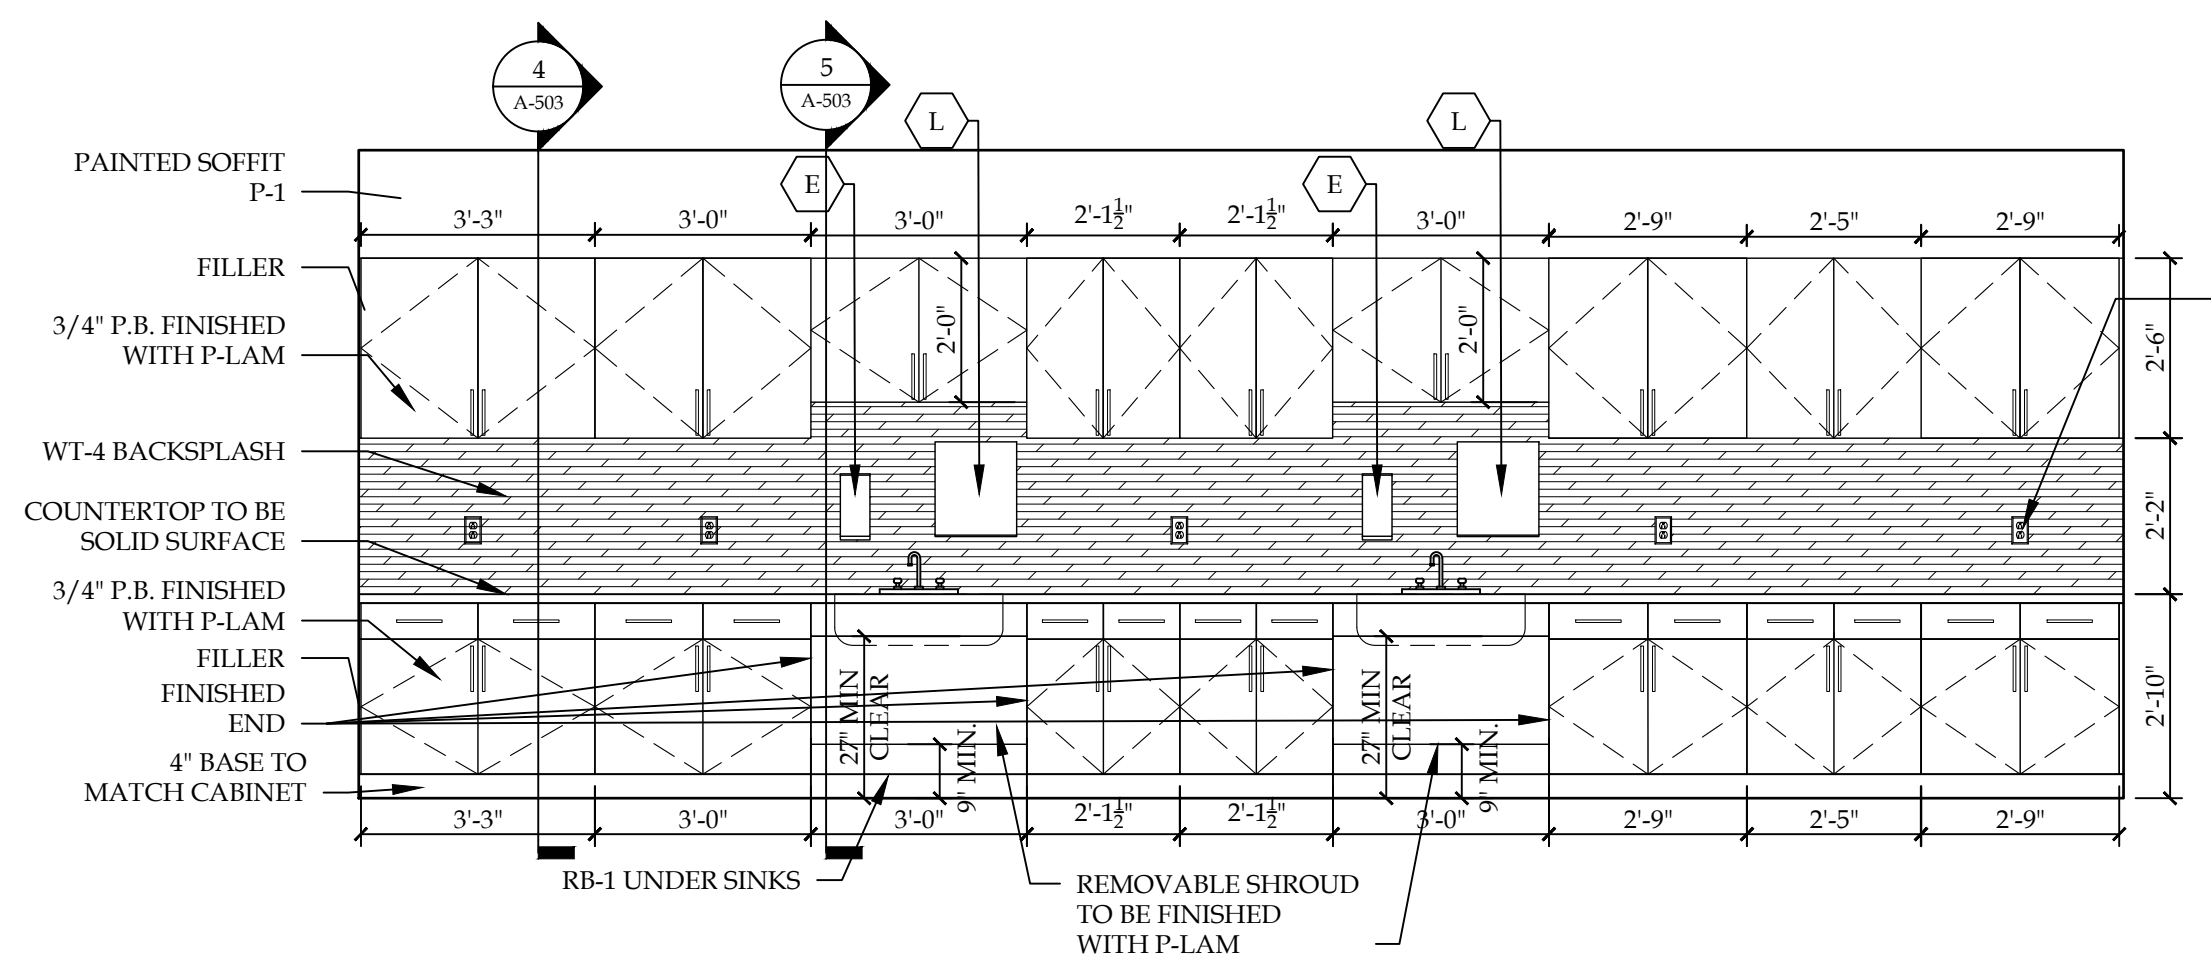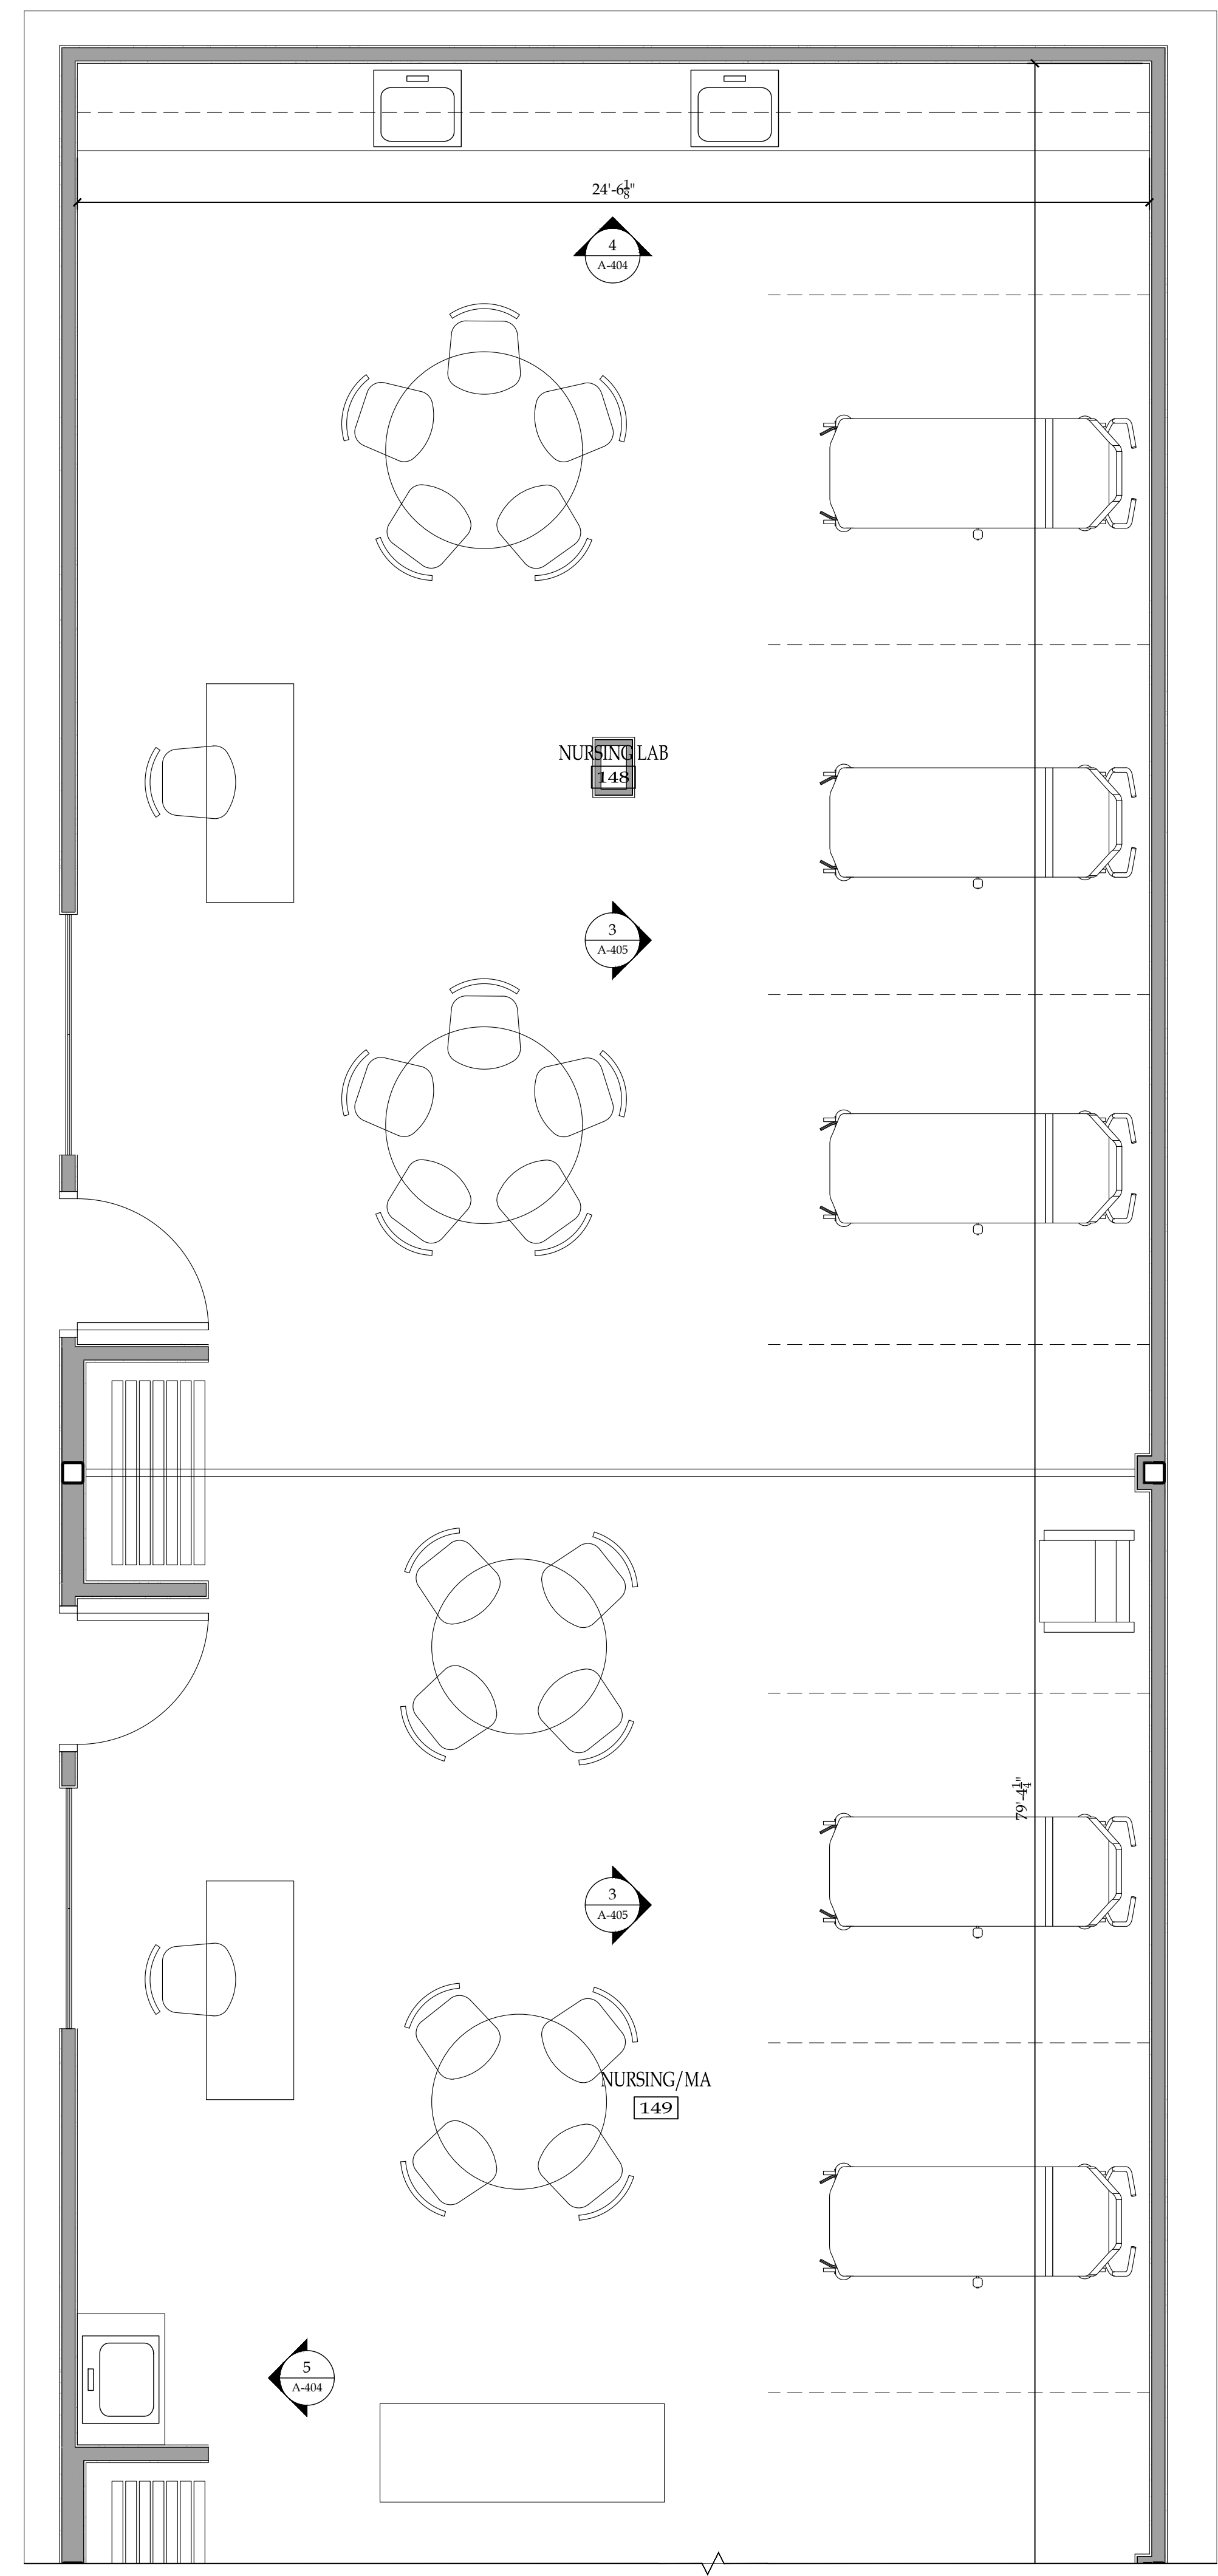


4 ELEVATION - NURSING LAB #148  
SCALE: 3/8"=1'-0"

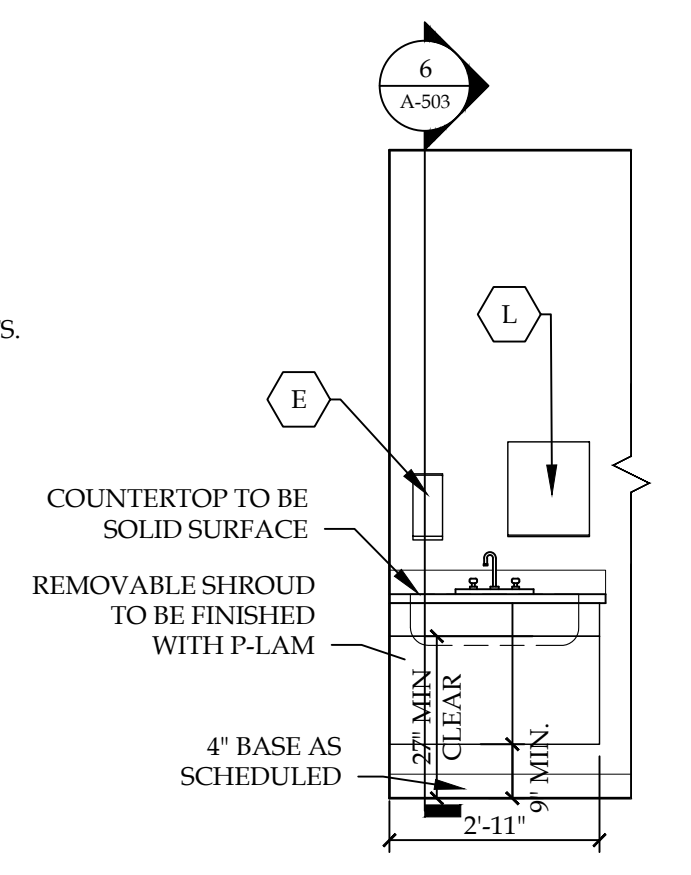

5 ELEVATION - NURSING/MA #149  
SCALE: 3/8"=1'-0"

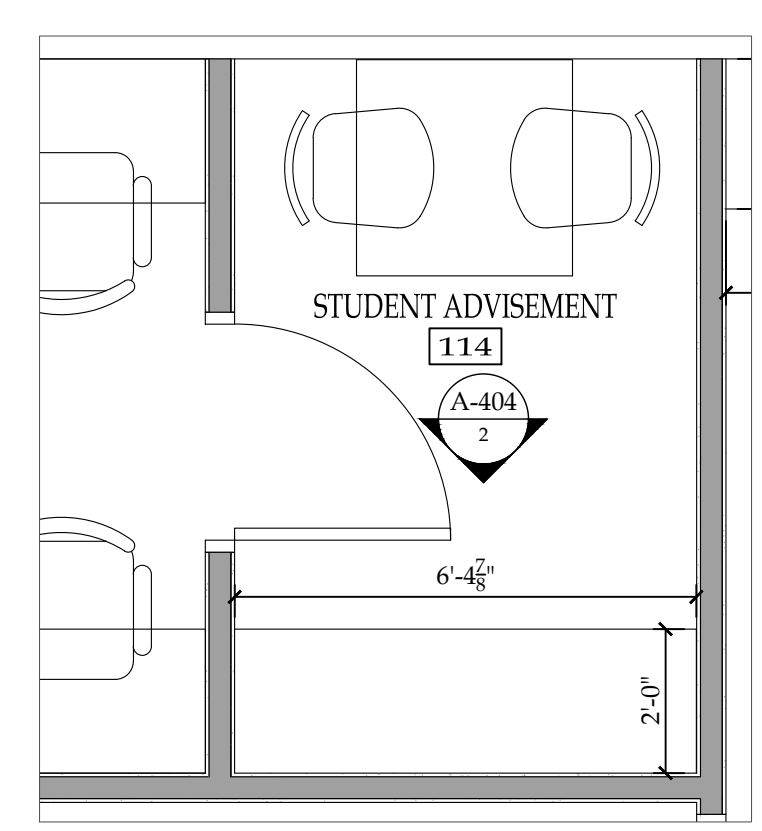

1 ENLARGED PLAN - STUDENT ADVISEMENT #114  
SCALE: 3/8"=1'-0"

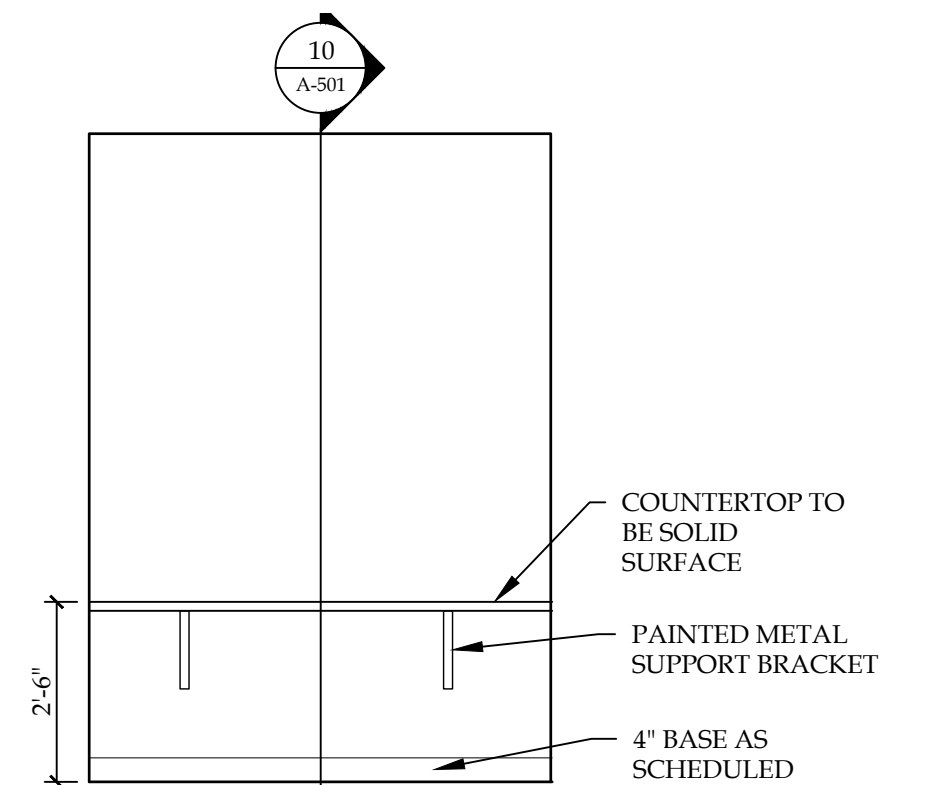

2 ELEVATION - STUDENT ADVISEMENT #114  
SCALE: 3/8"=1'-0"

PROVIDE ABOVE  
COUNTER OUTLETS.  
COORDINATE  
LOCATIONS WITH  
TENANT

COUNTERTOP TO BE  
SOLID SURFACE  
REMOVABLE SHROUD  
TO BE FINISHED  
WITH P-LAM  
4" BASE AS  
SCHEDULED

COUNTERTOP TO  
BE SOLID  
SURFACE  
PAINTED METAL  
SUPPORT BRACKET  
4" BASE AS  
SCHEDULED

3 ENLARGED PLAN - NURSING #207/NURSING/MA #208  
SCALE: 3/8"=1'-0"



SEE A-606 TO FIND  
ACCESSORY SCHEDULE.

| REVISION RECORD |            |             |
|-----------------|------------|-------------|
| NO.             | DATE       | REMARKS     |
| #1              | 09.06.2017 | ADDENDUM #1 |

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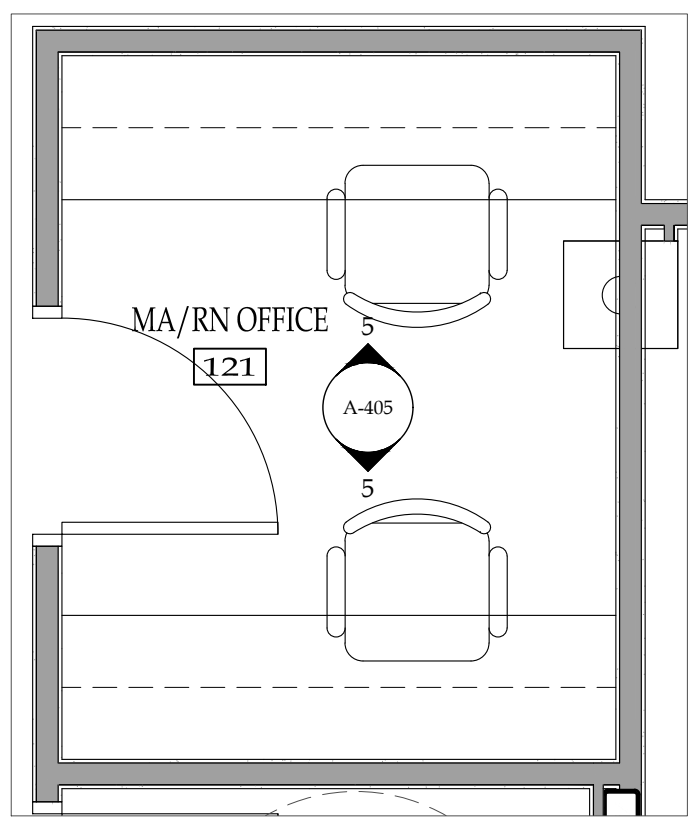
**BRYANT & STRATTON COLLEGE**  
1320 Warwick Way  
Mt. Pleasant, WI 53406

SEAL:


ENLARGED FLOOR PLANS & INTERIOR ELEVATIONS

**GREGORY A. TOMSIC**  
REGISTERED ARCHITECT  
145 BATHURST DR., TONAWANDA, N.Y. 14150  
716-435-0617


|                       |                          |
|-----------------------|--------------------------|
| SCALE<br>1/8" = 1'-0" | JOB NO.                  |
| DRAWN                 | DWG. NO.<br><b>A-405</b> |
| CHECKED               | DATE<br>12.22.2017       |
| DATE<br>12.22.2017    | CONTRACT NO.             |




4 ENLARGED PLAN - MA/RN OFFICE #121  
SCALE: 3/8"=1'-0"

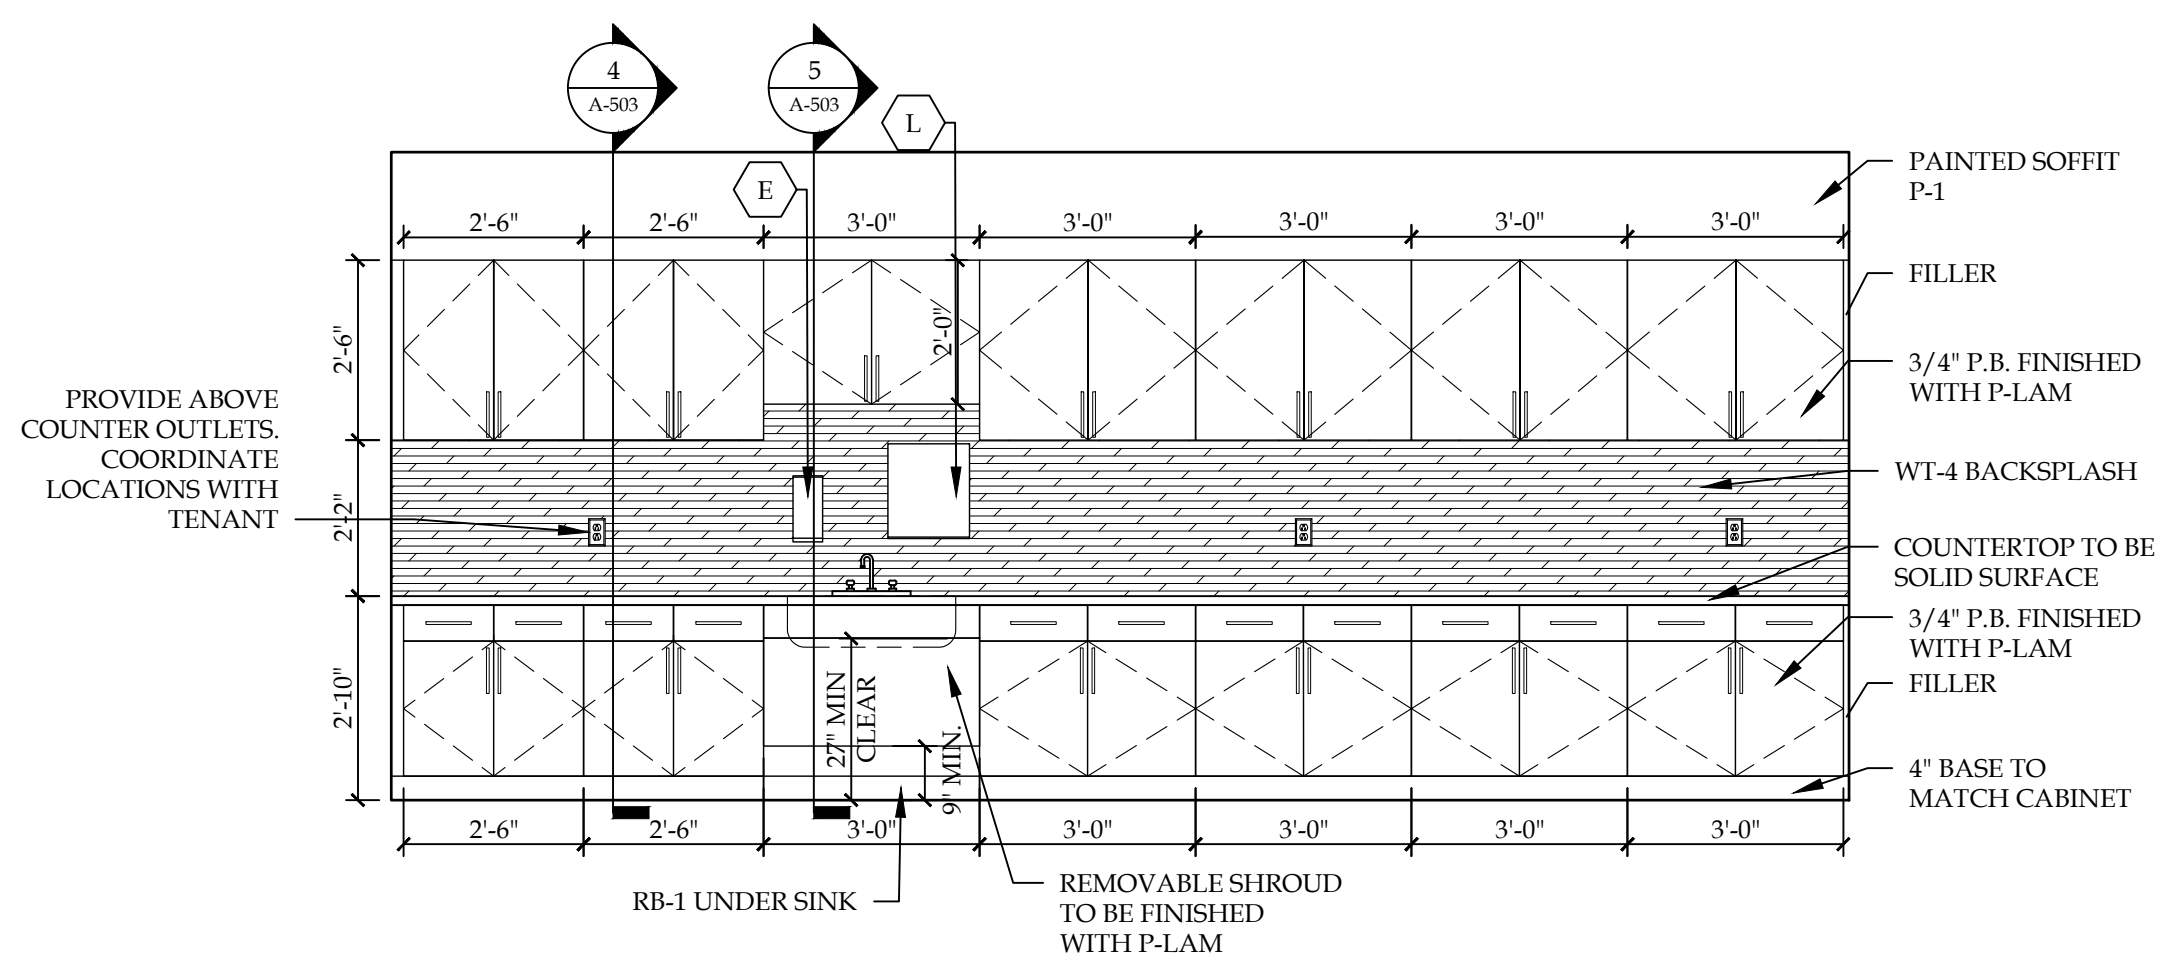


5 ELEVATION - MA/RN OFFICE #121  
SCALE: 3/8"=1'-0"

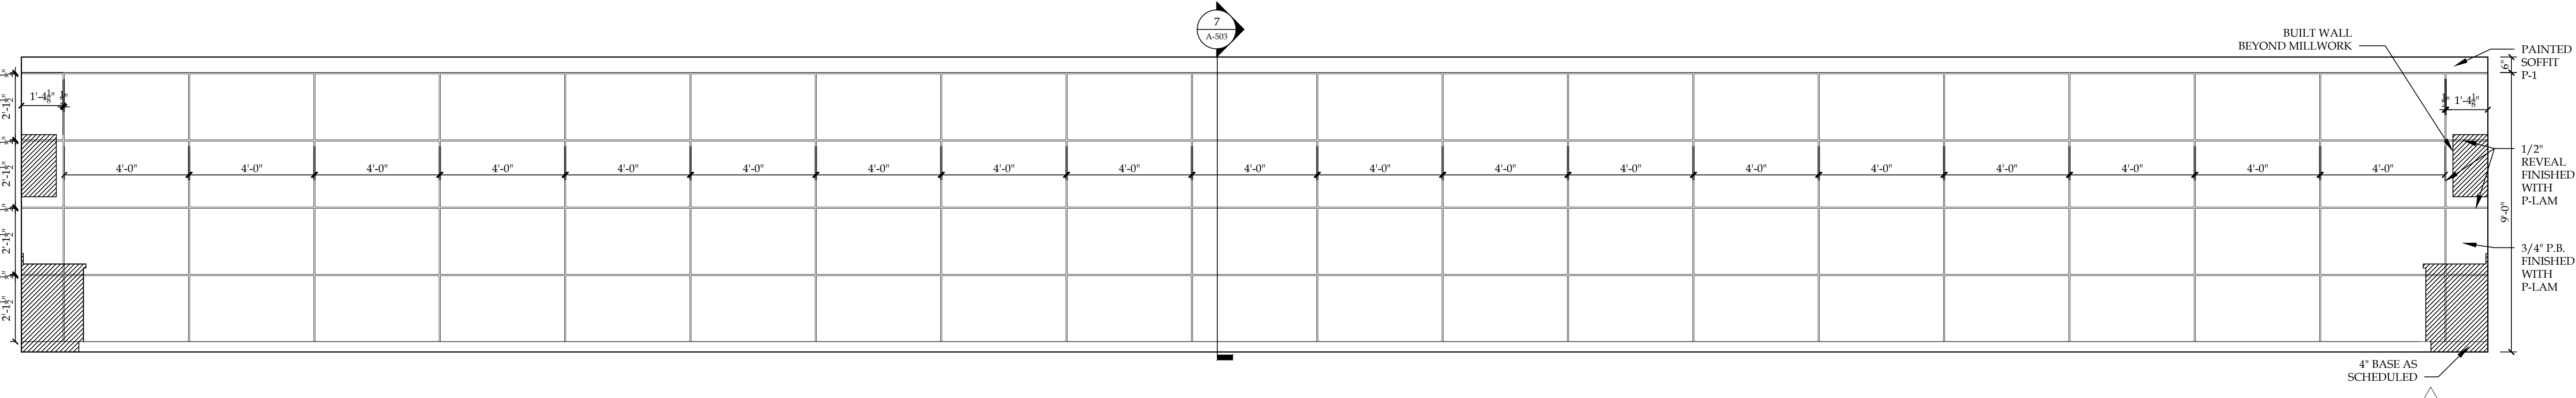

3 ELEVATION - NURSING LAB #148, NURSING/MA #149, & MA LAB #150  
SCALE: 3/8"=1'-0"

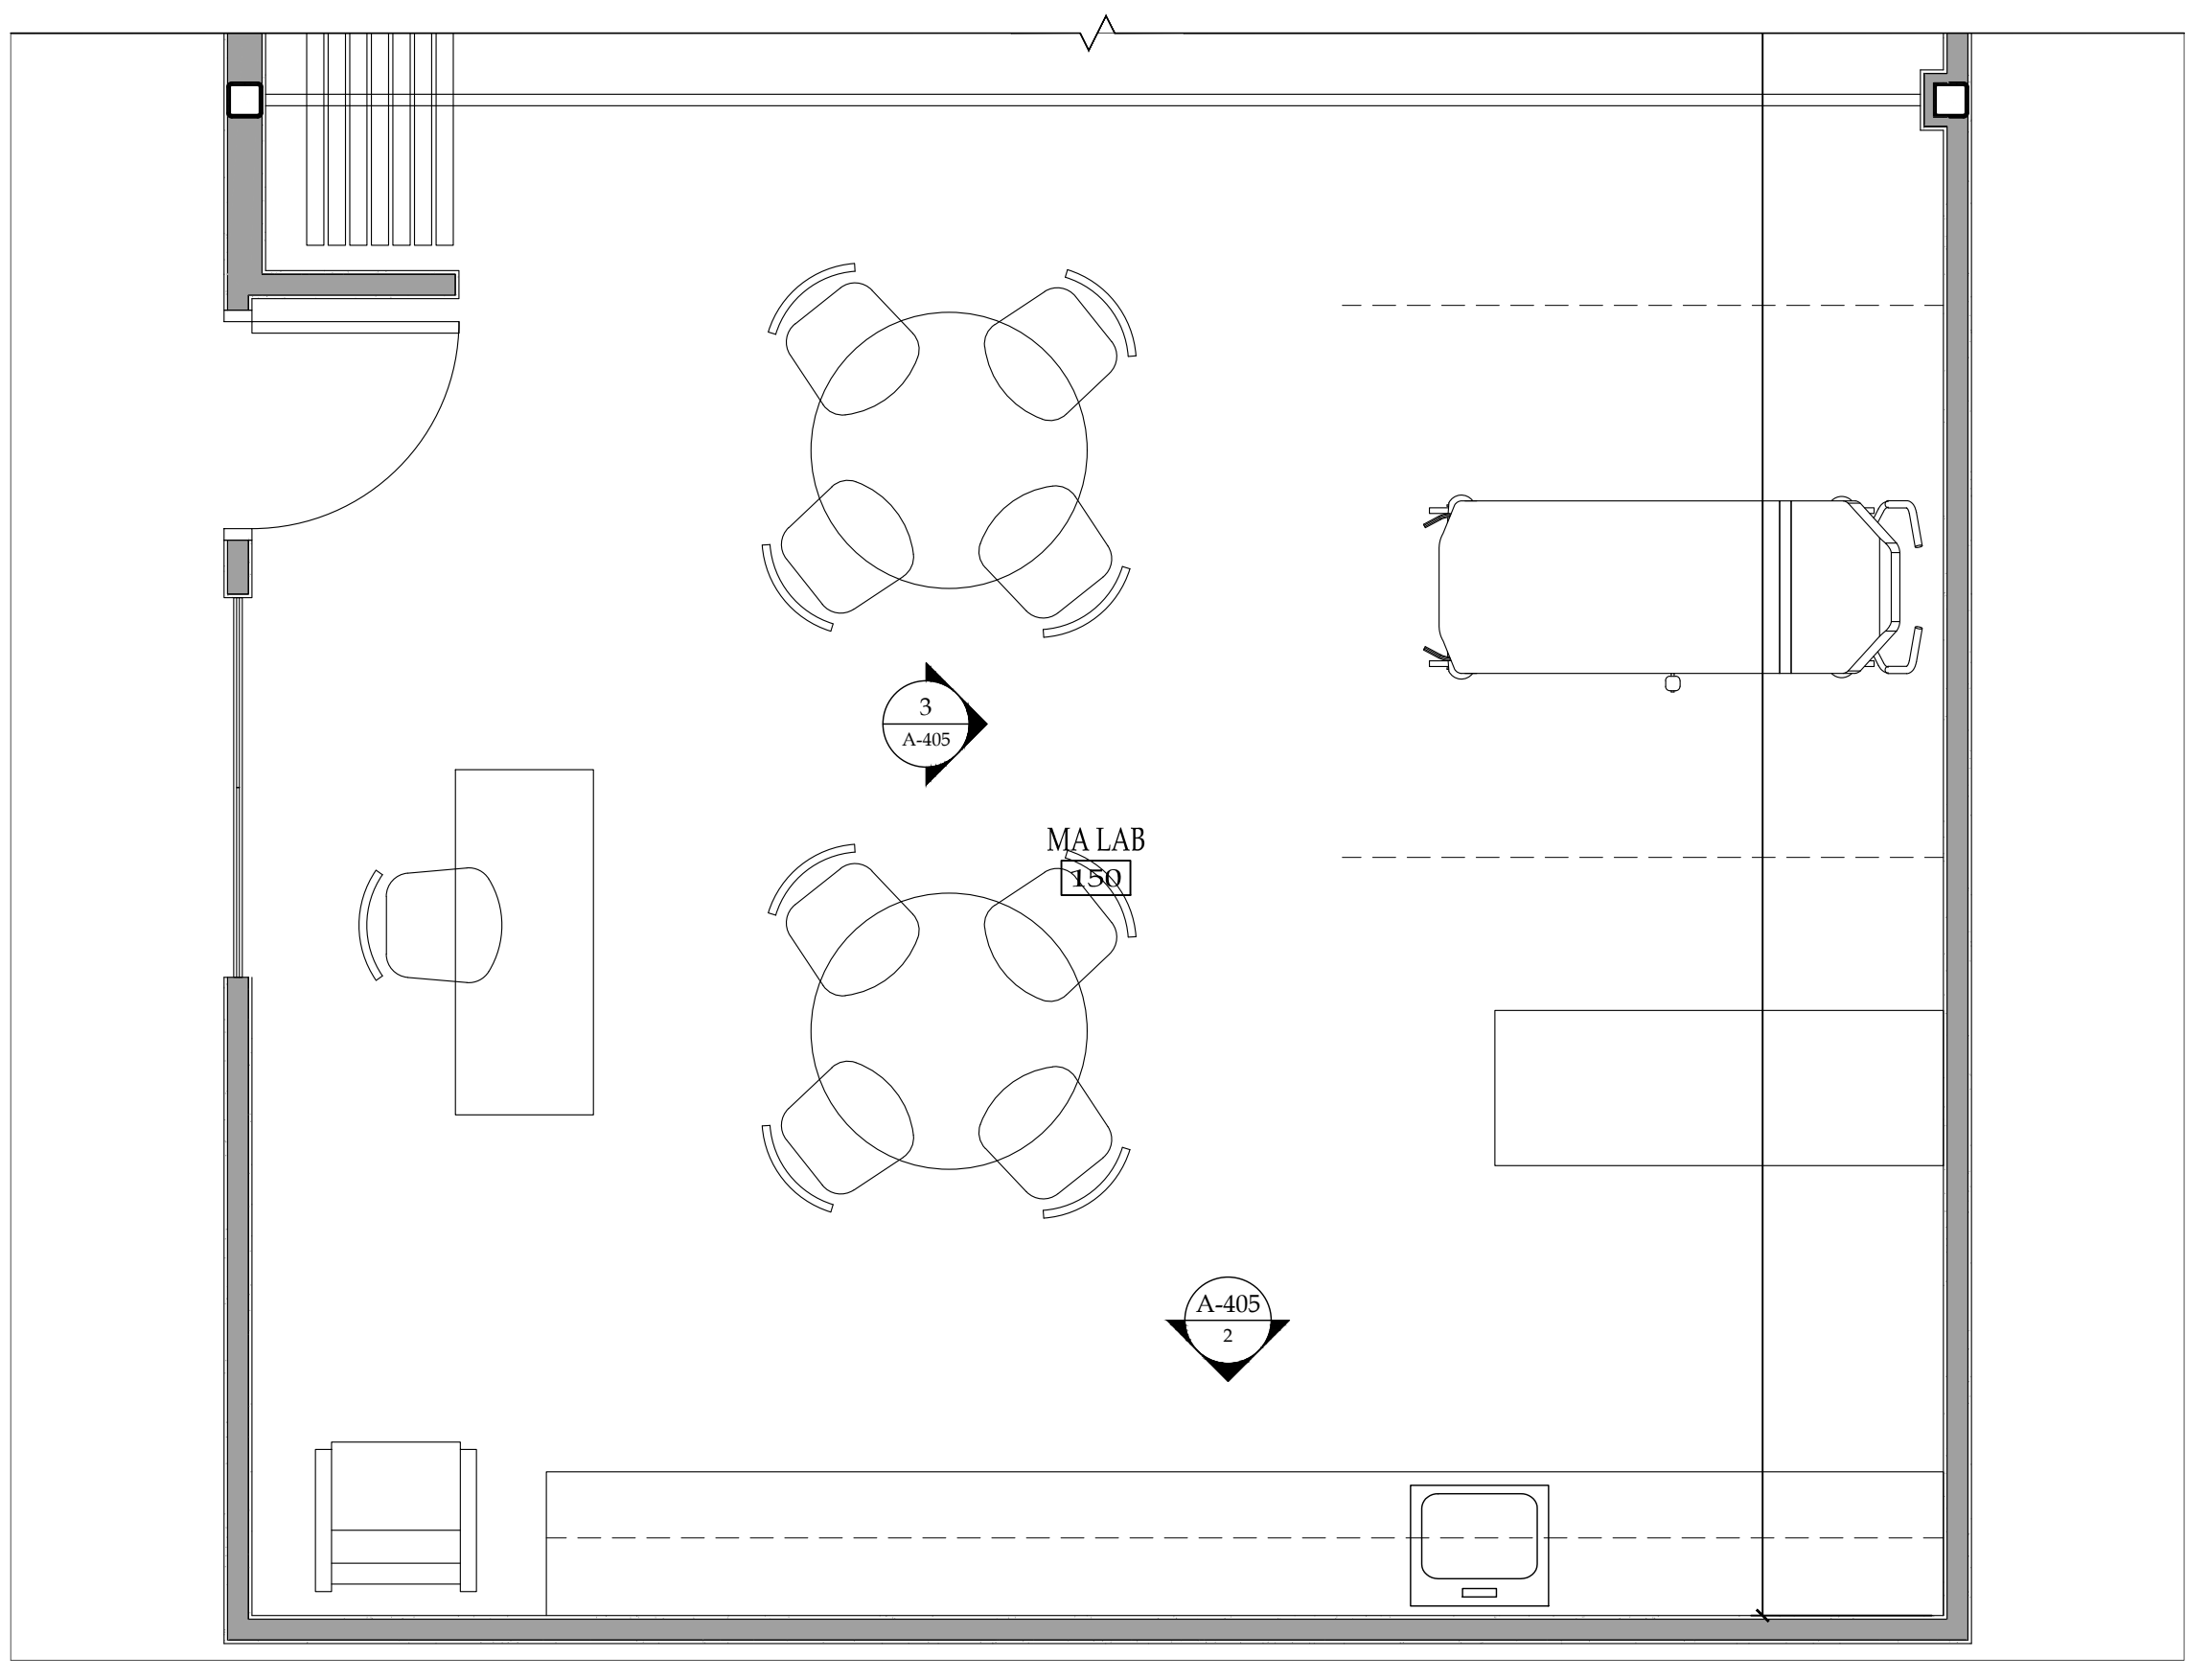

1 ENLARGED PLAN - MA LAB #150  
SCALE: 3/8"=1'-0"

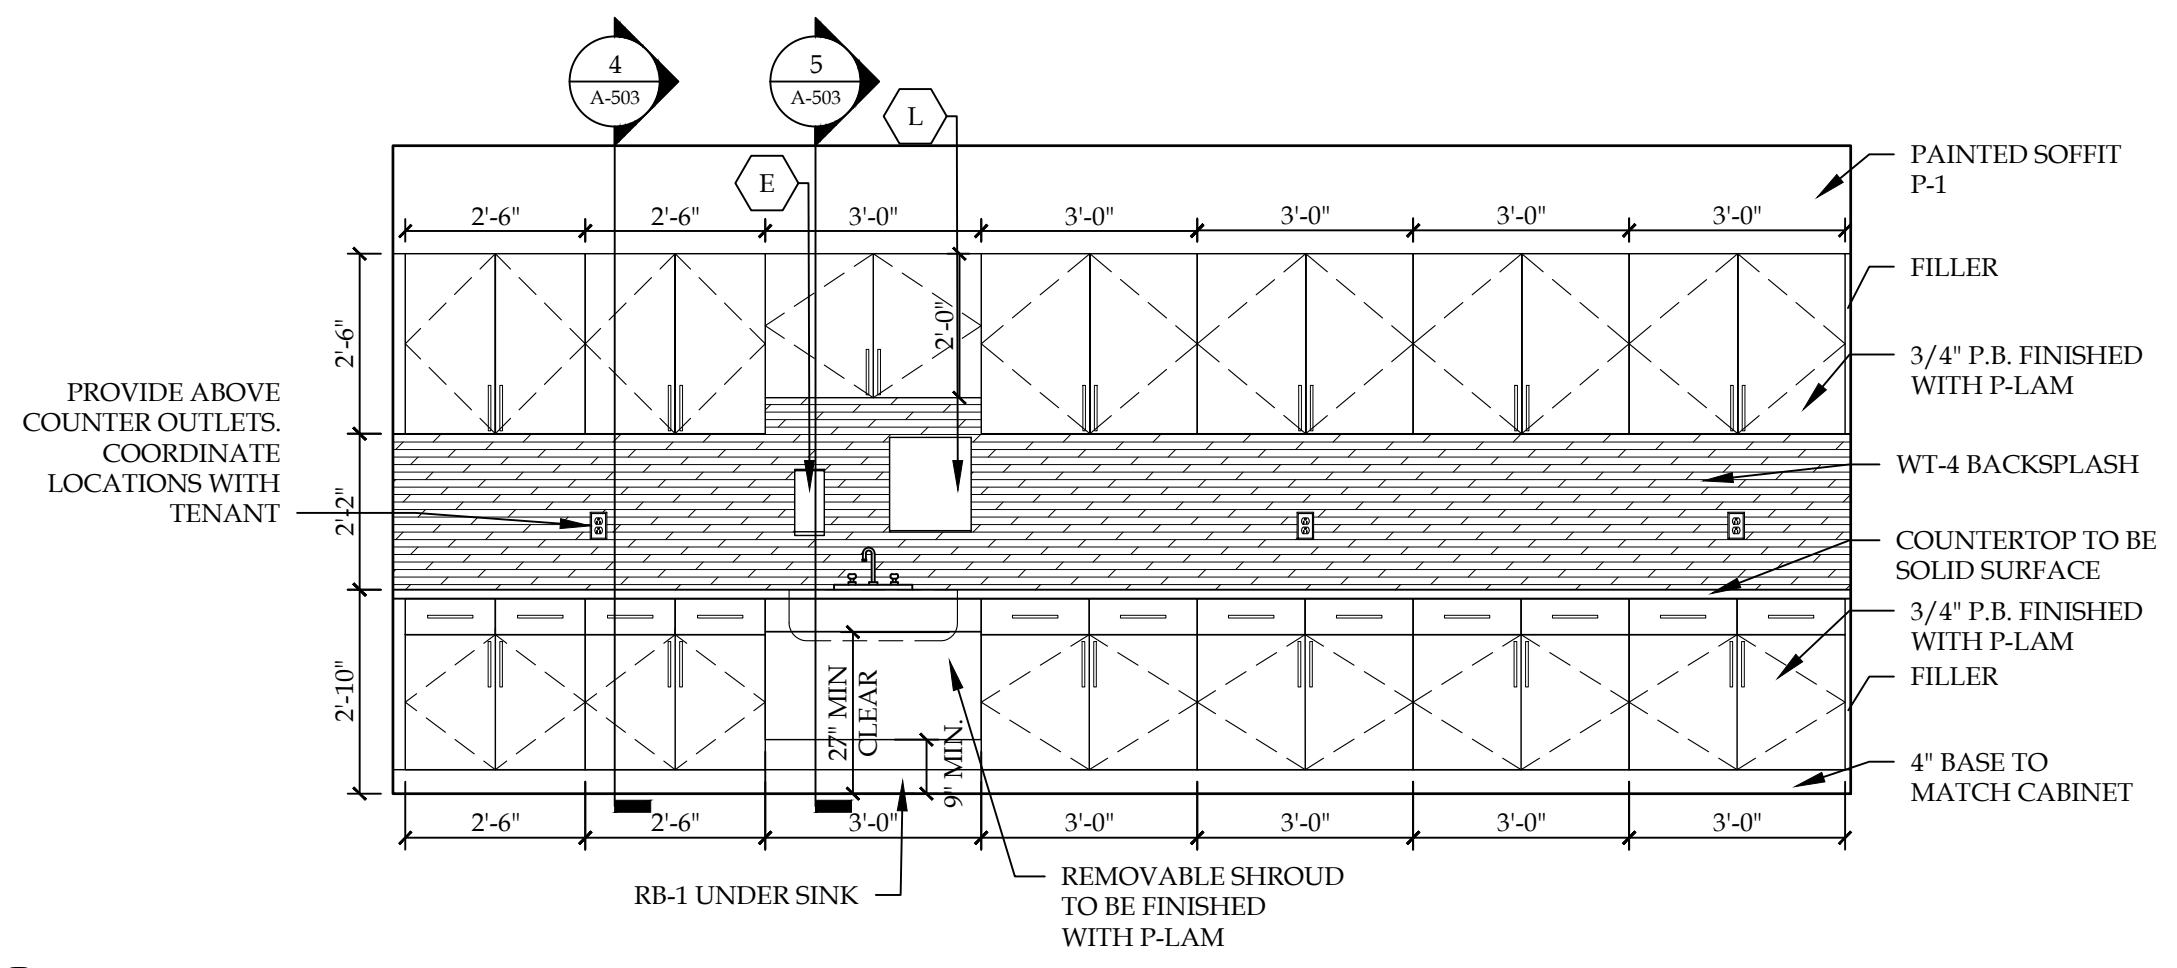


2 ELEVATION - MA #209  
SCALE: 3/8"=1'-0"

| REVISION RECORD |      |         |
|-----------------|------|---------|
| NO.             | DATE | REMARKS |
|                 |      |         |

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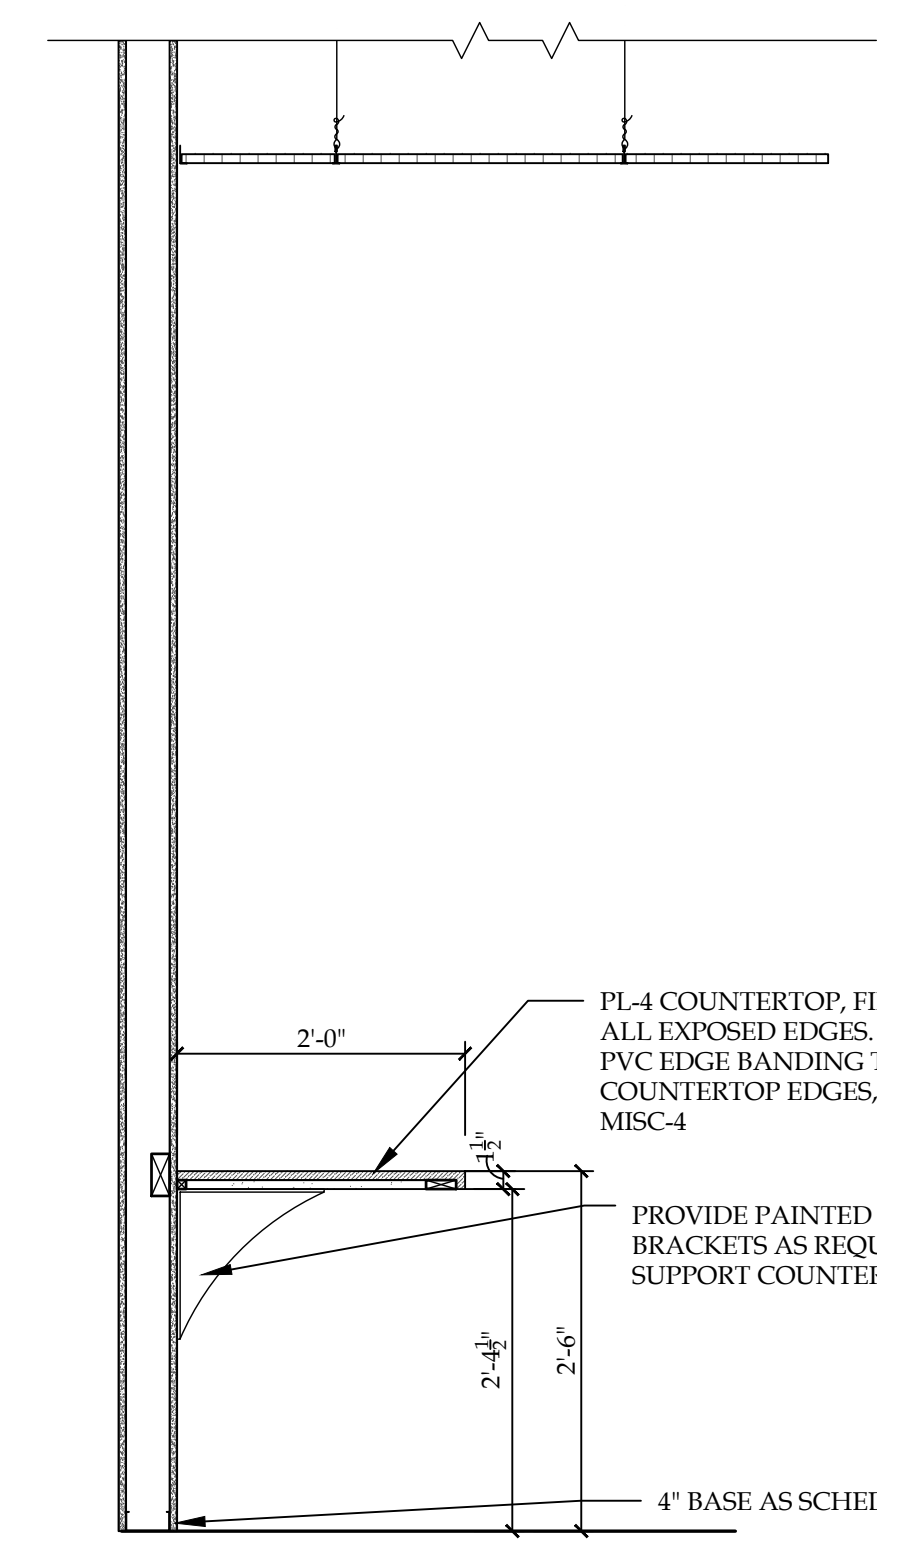
**BRYANT & STRATTON COLLEGE**  
 1320 Warwick Way  
 Mt. Pleasant, WI 53406




**MILLWORK SECTIONS**

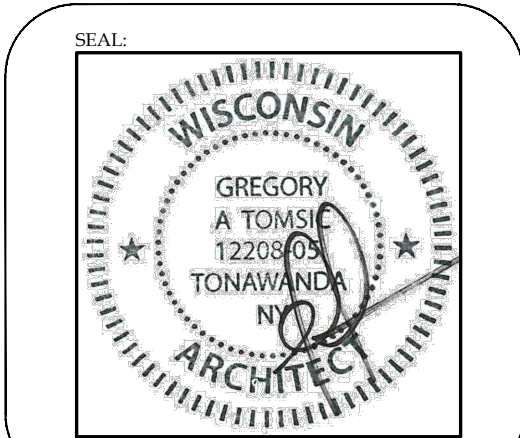**GREGORY A. TOMSIC**  
 REGISTERED ARCHITECT  
 145 BATHURST DR., TONAWANDA, N.Y. 14150  
 716-435-0617


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|-----------------------|--------------------------|
| SCALE<br>1/8" = 1'-0" | JOB NO.                  |
| DRAWN                 | DWG. NO.<br><b>A-501</b> |
| CHECKED               | CONTRACT NO.             |
| DATE<br>09.06.2017    |                          |




10 SECTION - STUDENT EVALUATION ROOM  
SCALE: 3/4"=1'-0"

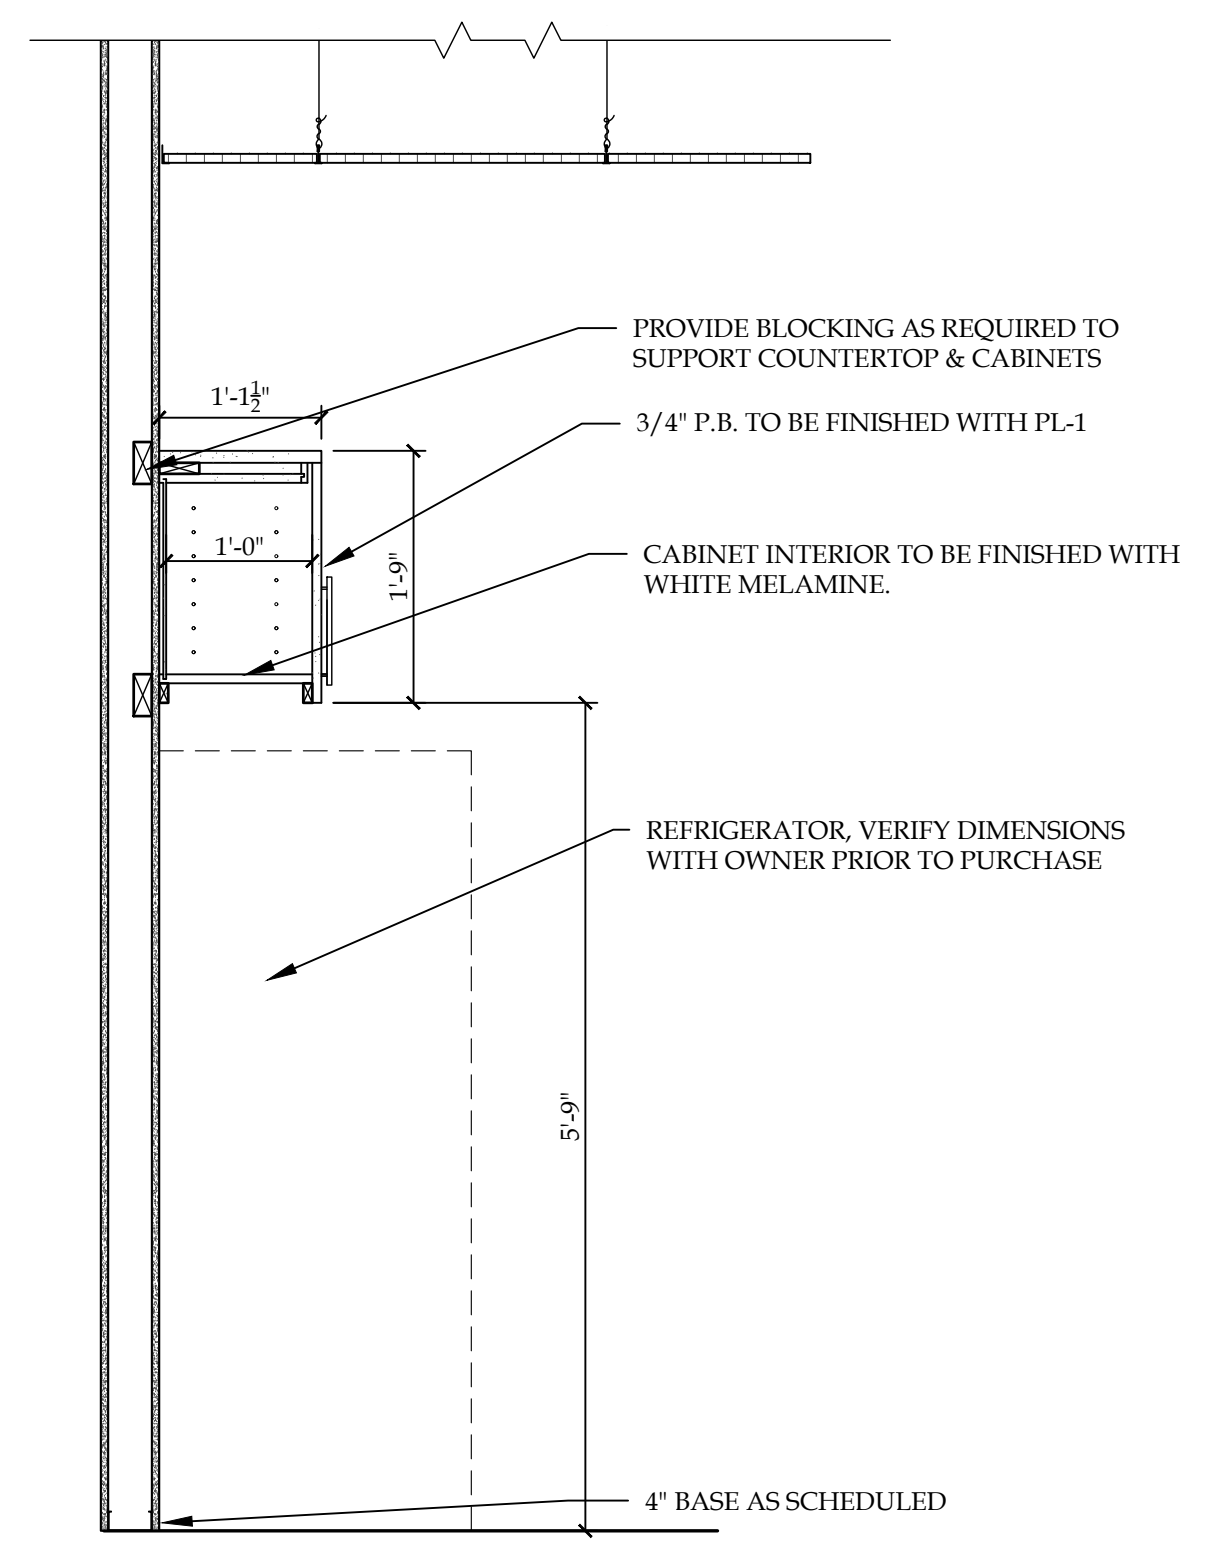


9 SECTION - BREAK ROOM  
SCALE: 3/4"=1'-0"

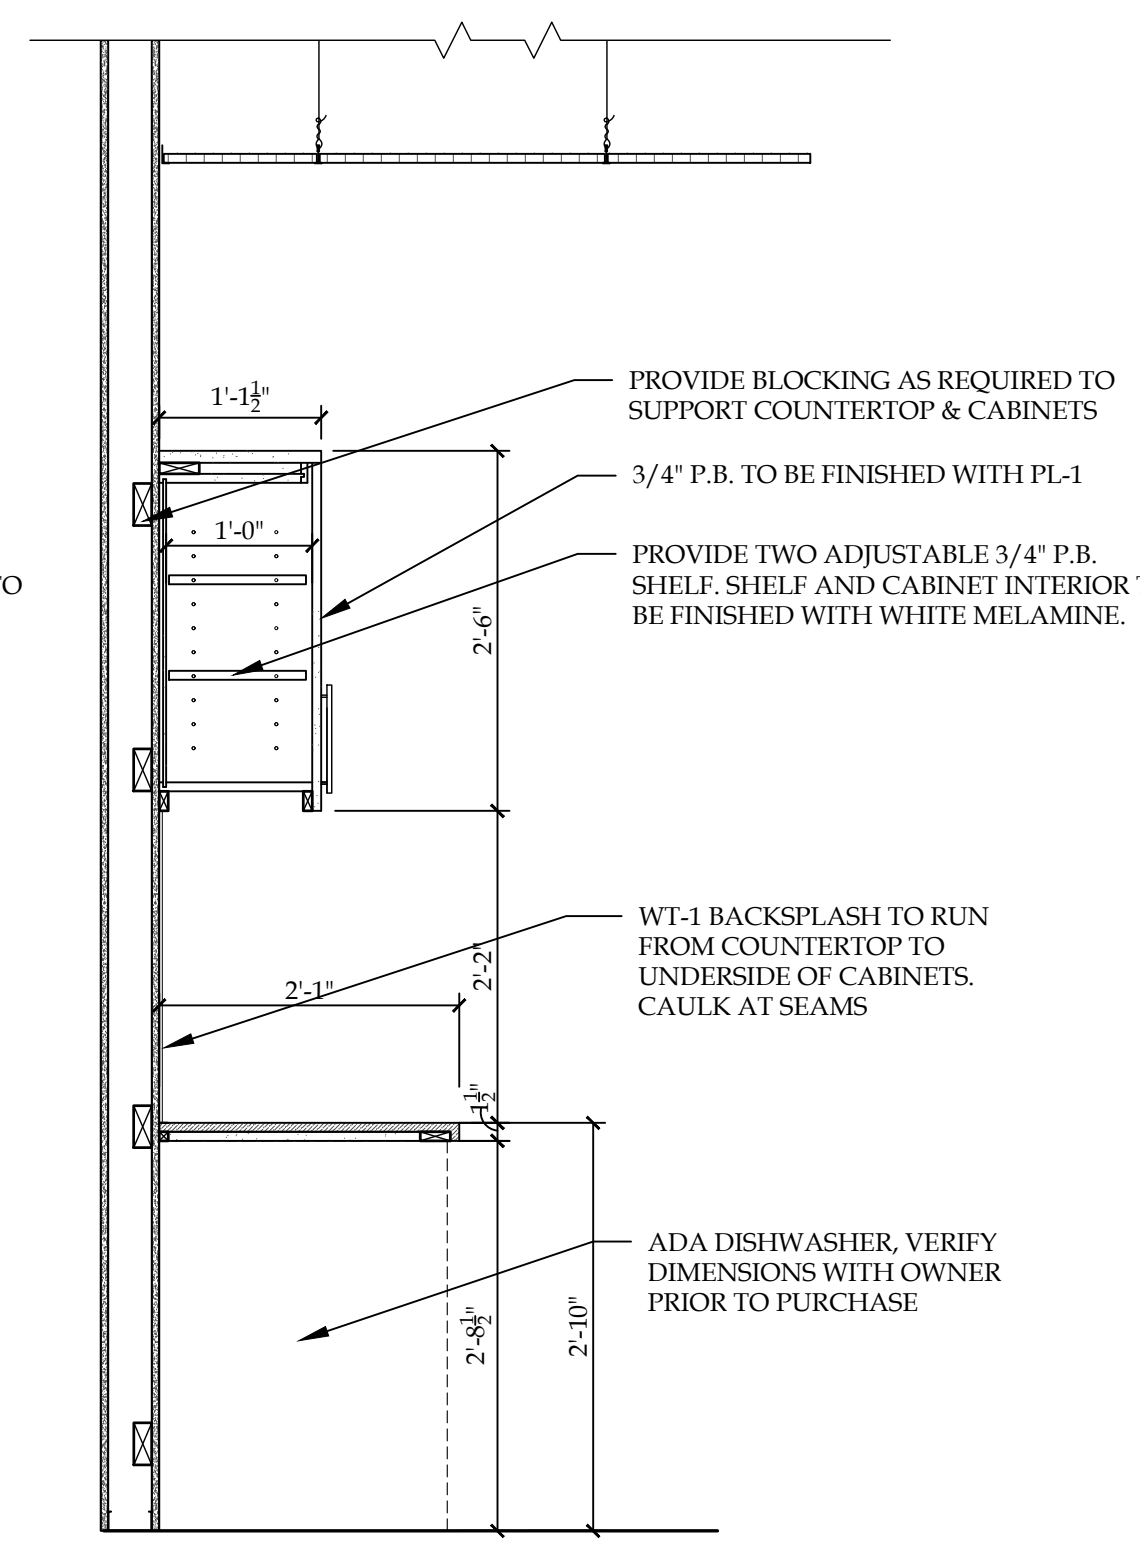


8 SECTION - BREAK ROOM  
SCALE: 3/4"=1'-0"

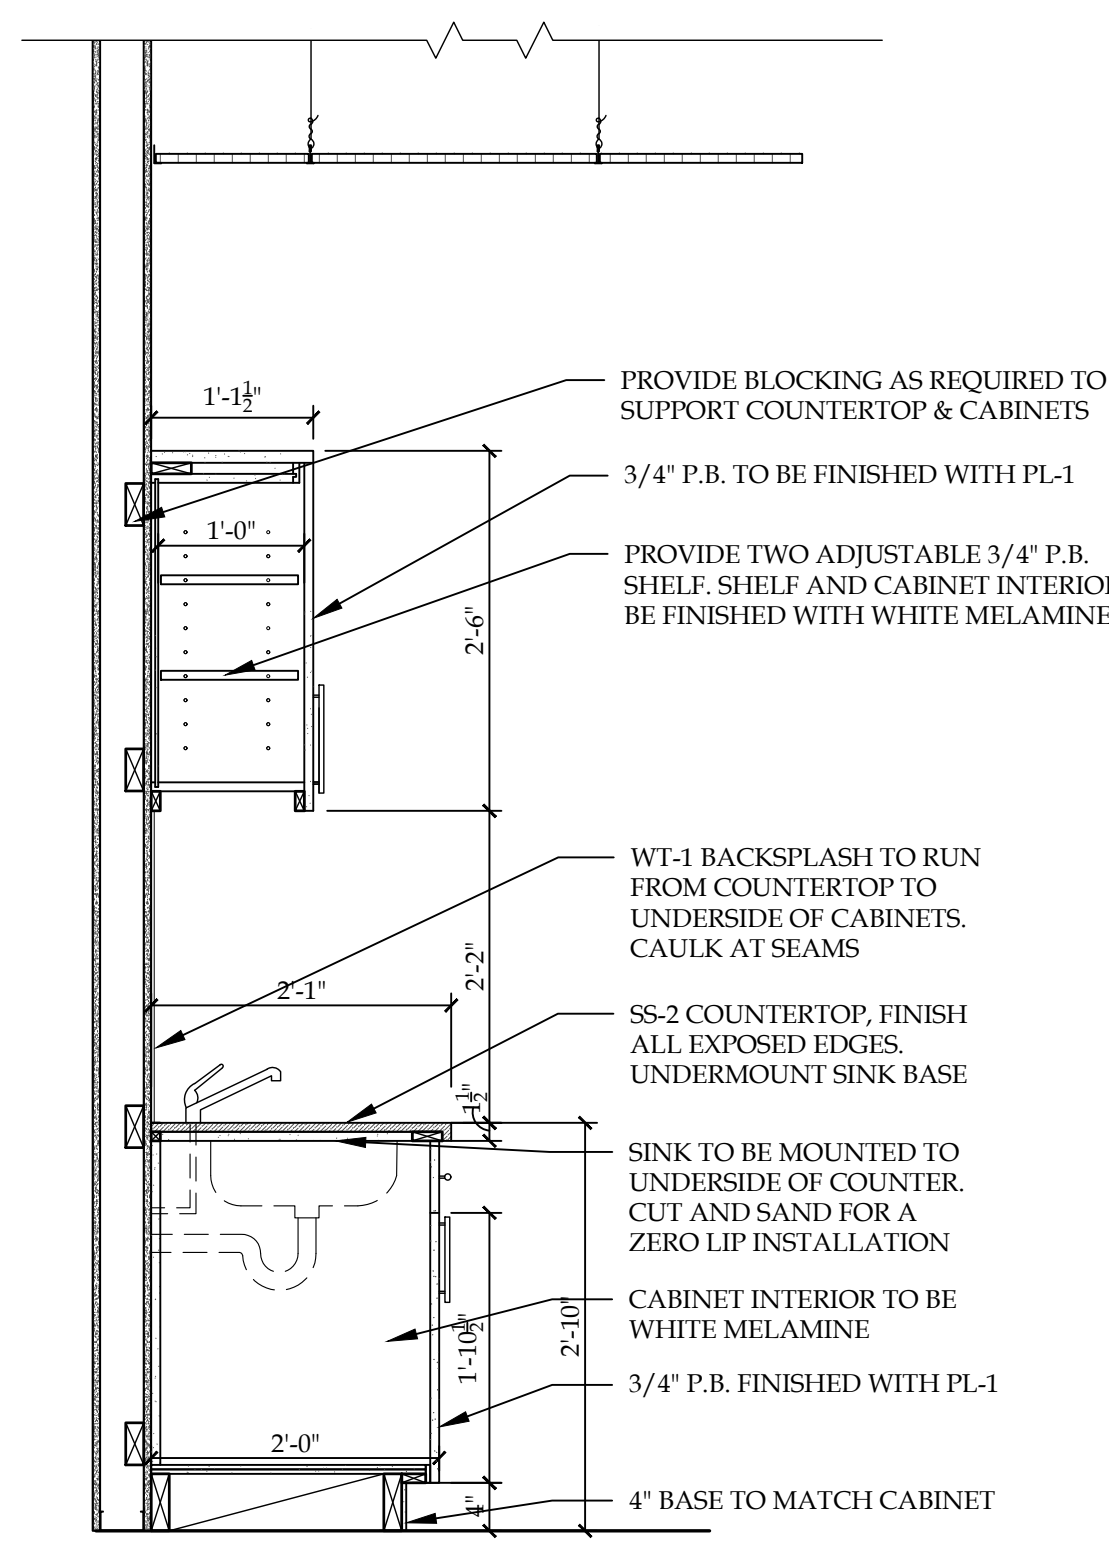


7 SECTION - BREAK ROOM  
SCALE: 3/4"=1'-0"

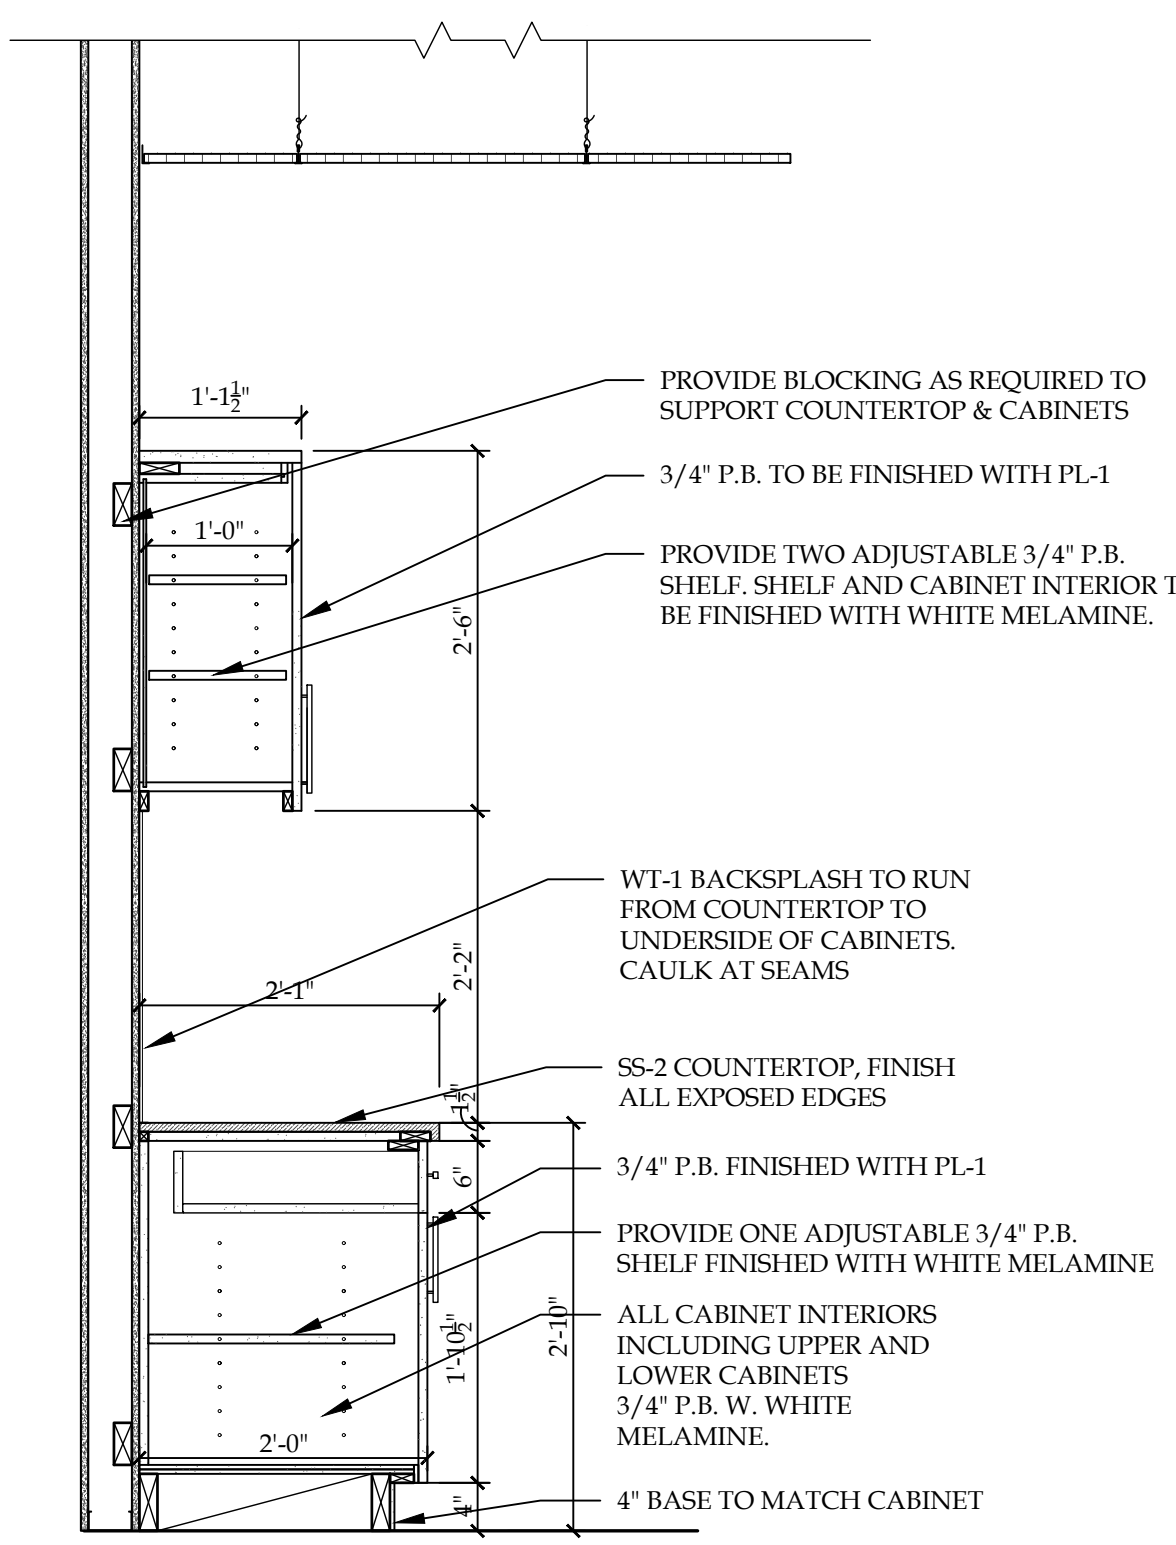


6 SECTION - BREAK ROOM  
SCALE: 3/4"=1'-0"

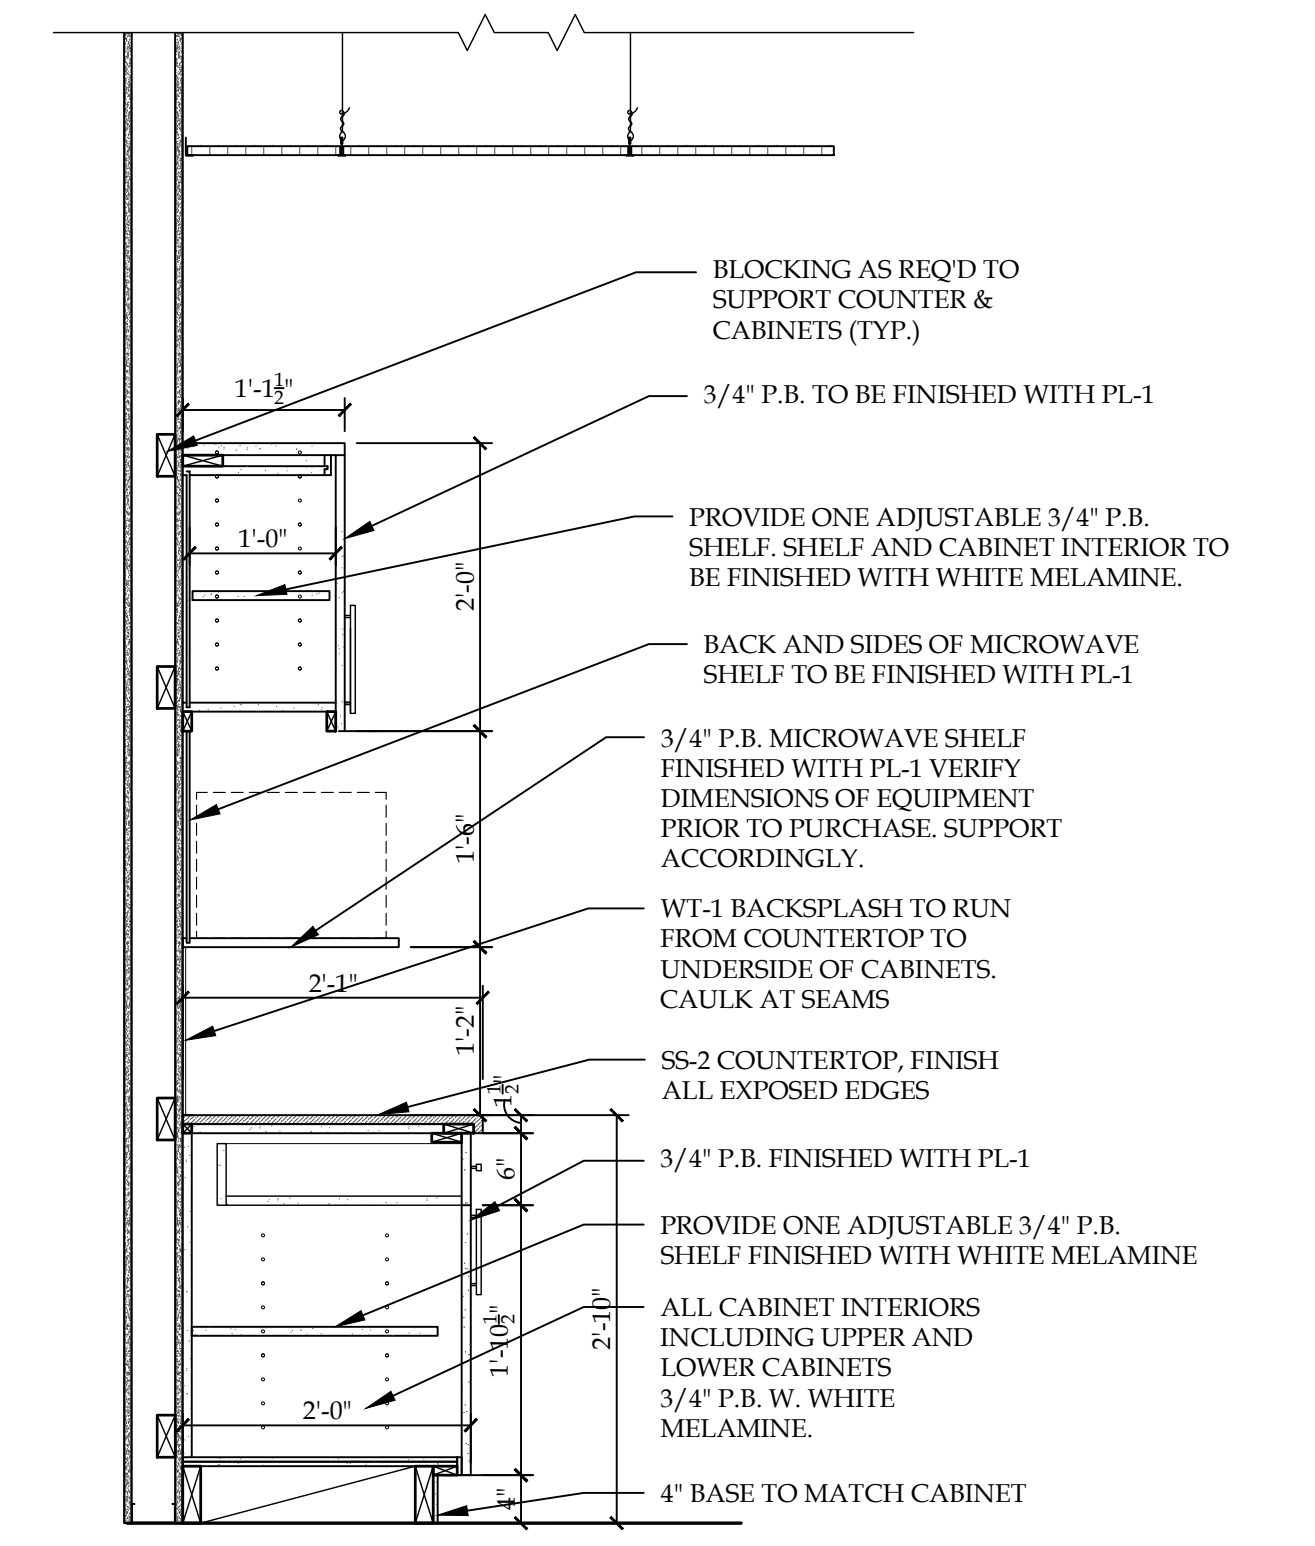


5 SECTION - BREAK ROOM  
SCALE: 3/4"=1'-0"

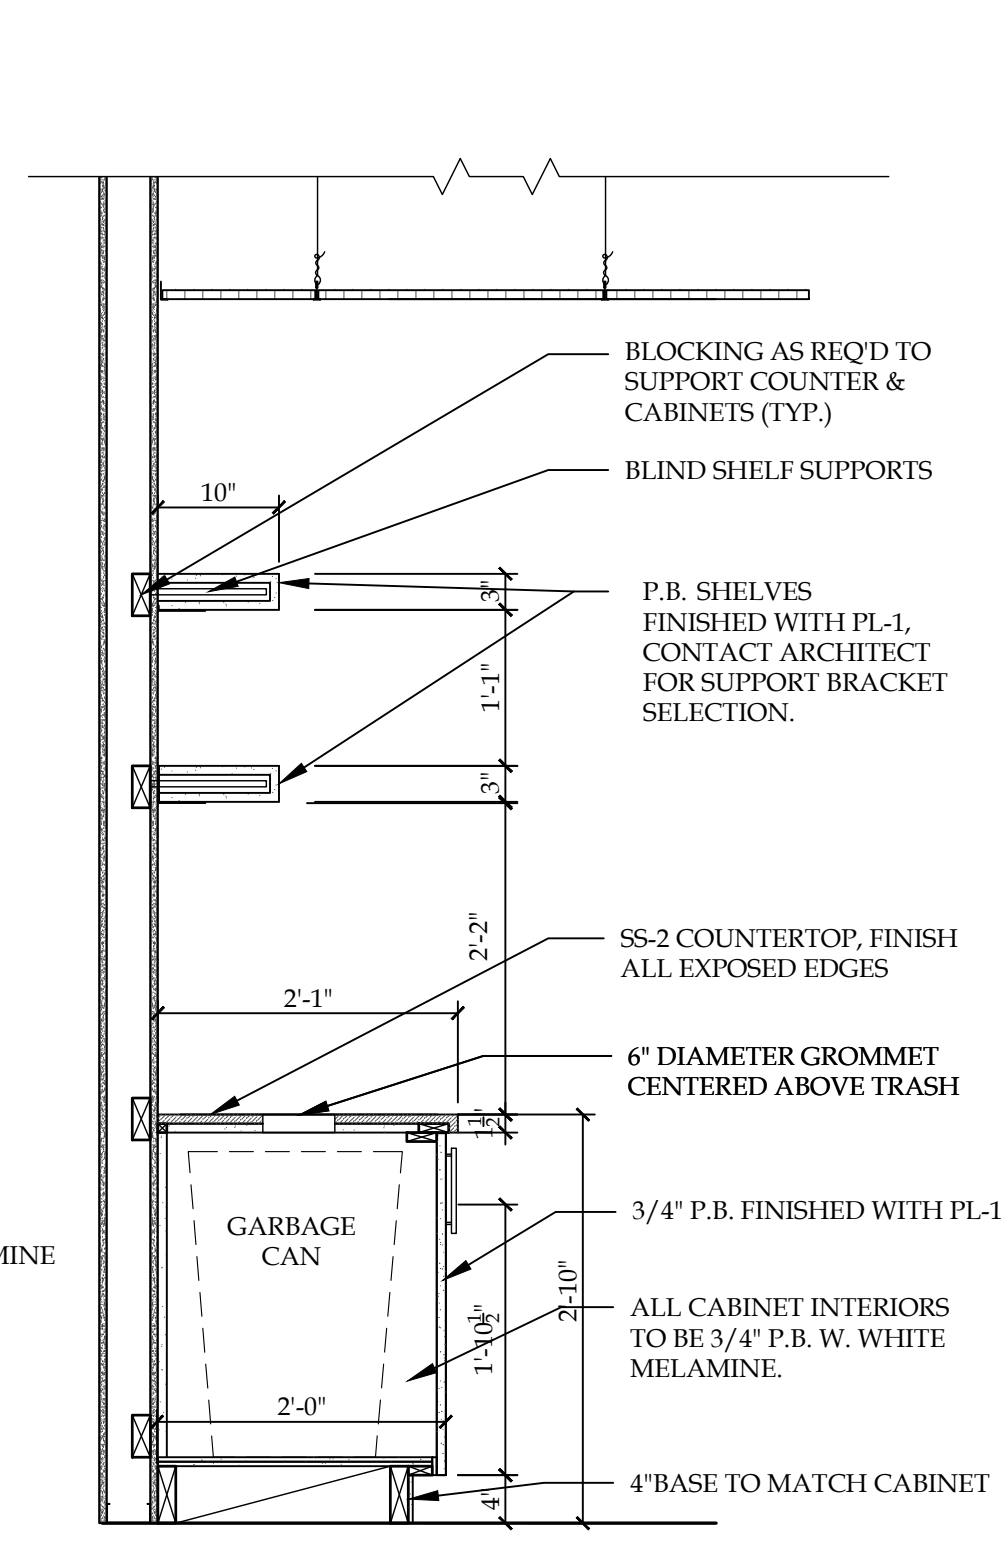


4 SECTION - LEARNING COMMONS COFFEE BAR  
SCALE: 3/4"=1'-0"

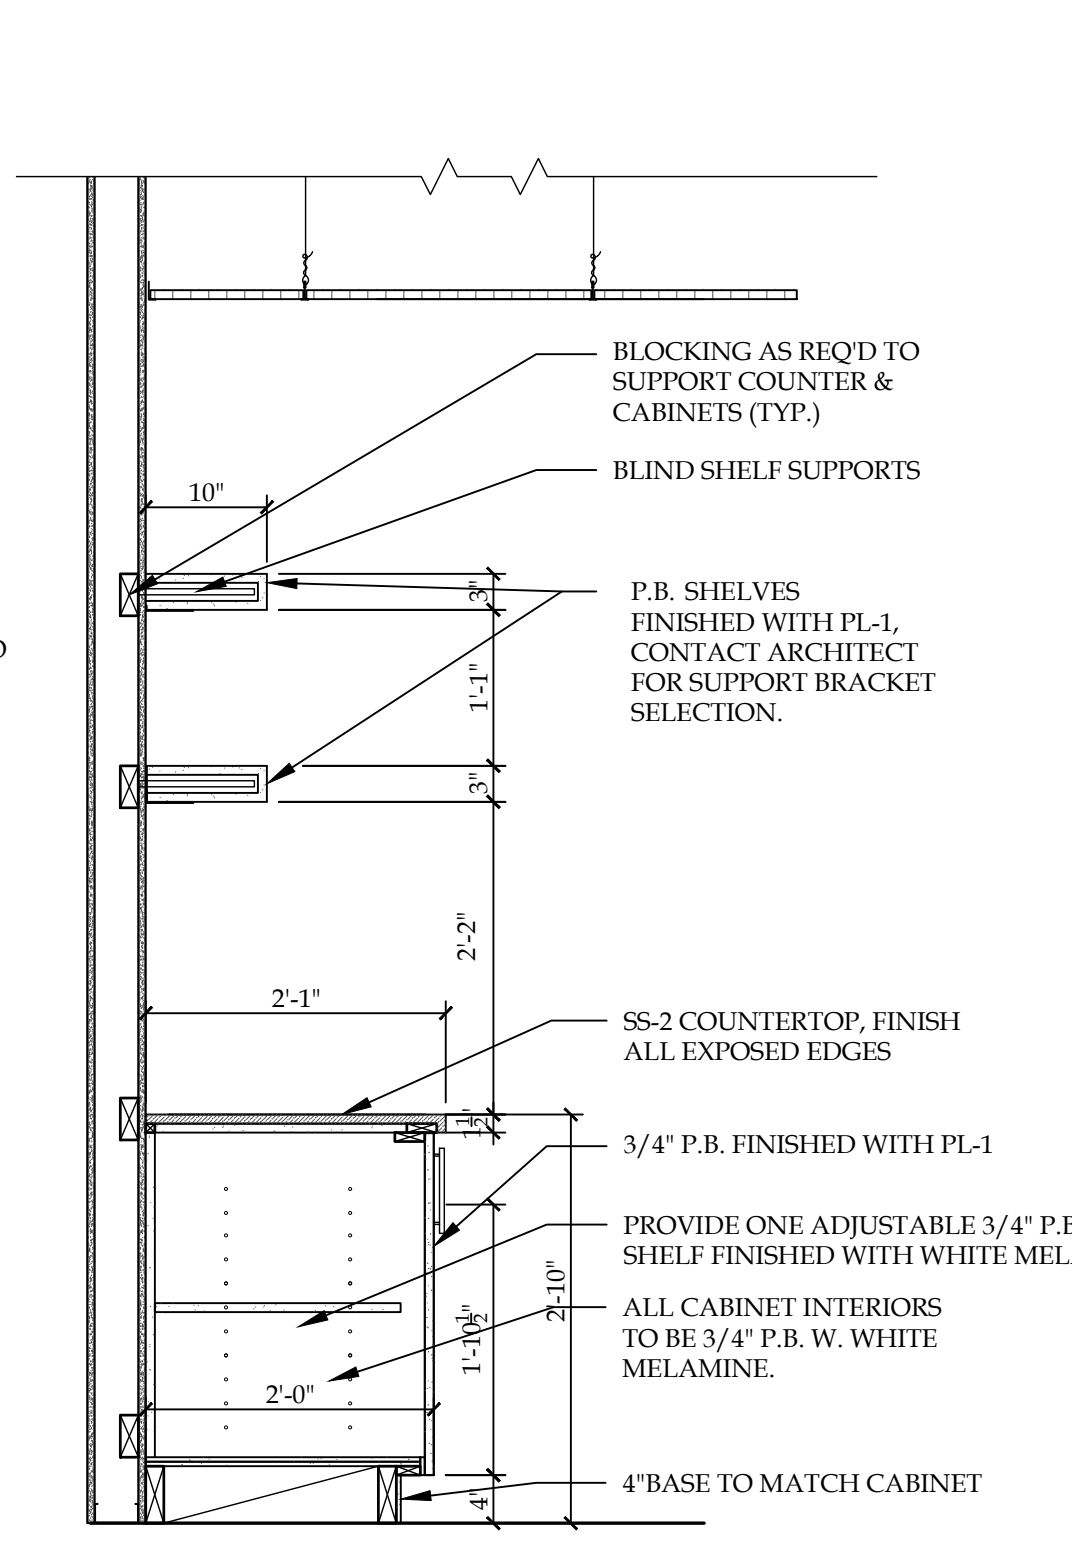

3 SECTION - LEARNING COMMONS COFFEE BAR  
SCALE: 3/4"=1'-0"

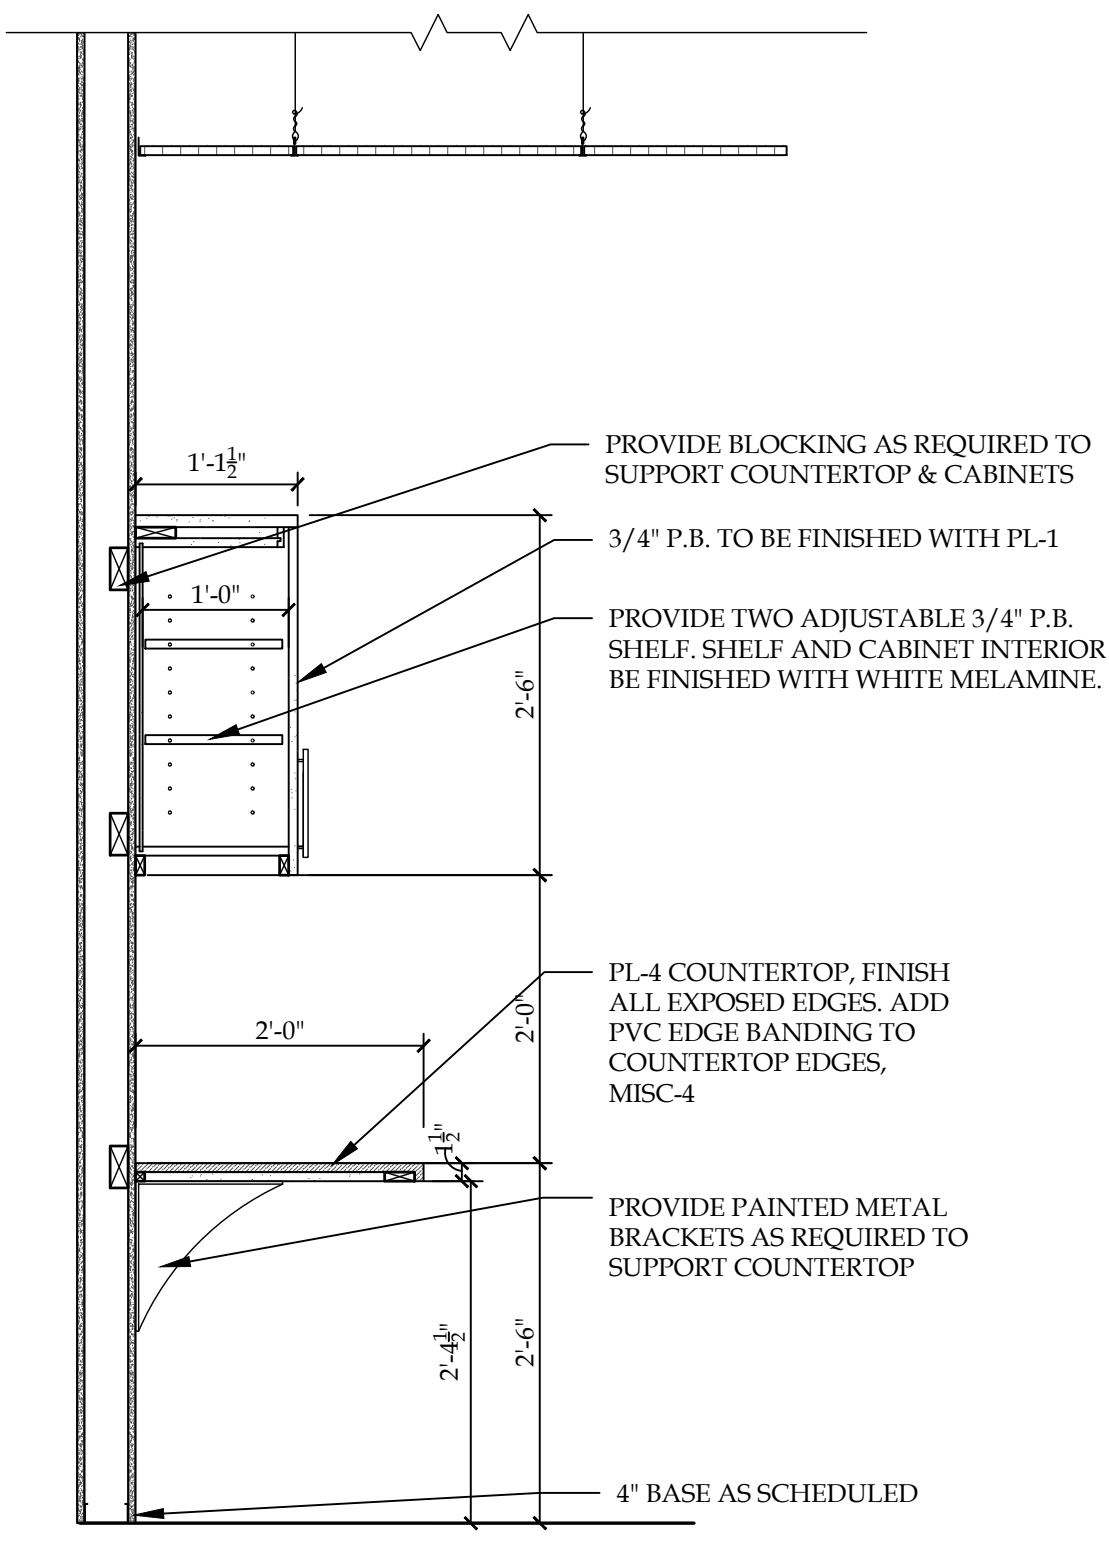

2 SECTION - MA/RN OFFICE  
SCALE: 3/4"=1'-0"

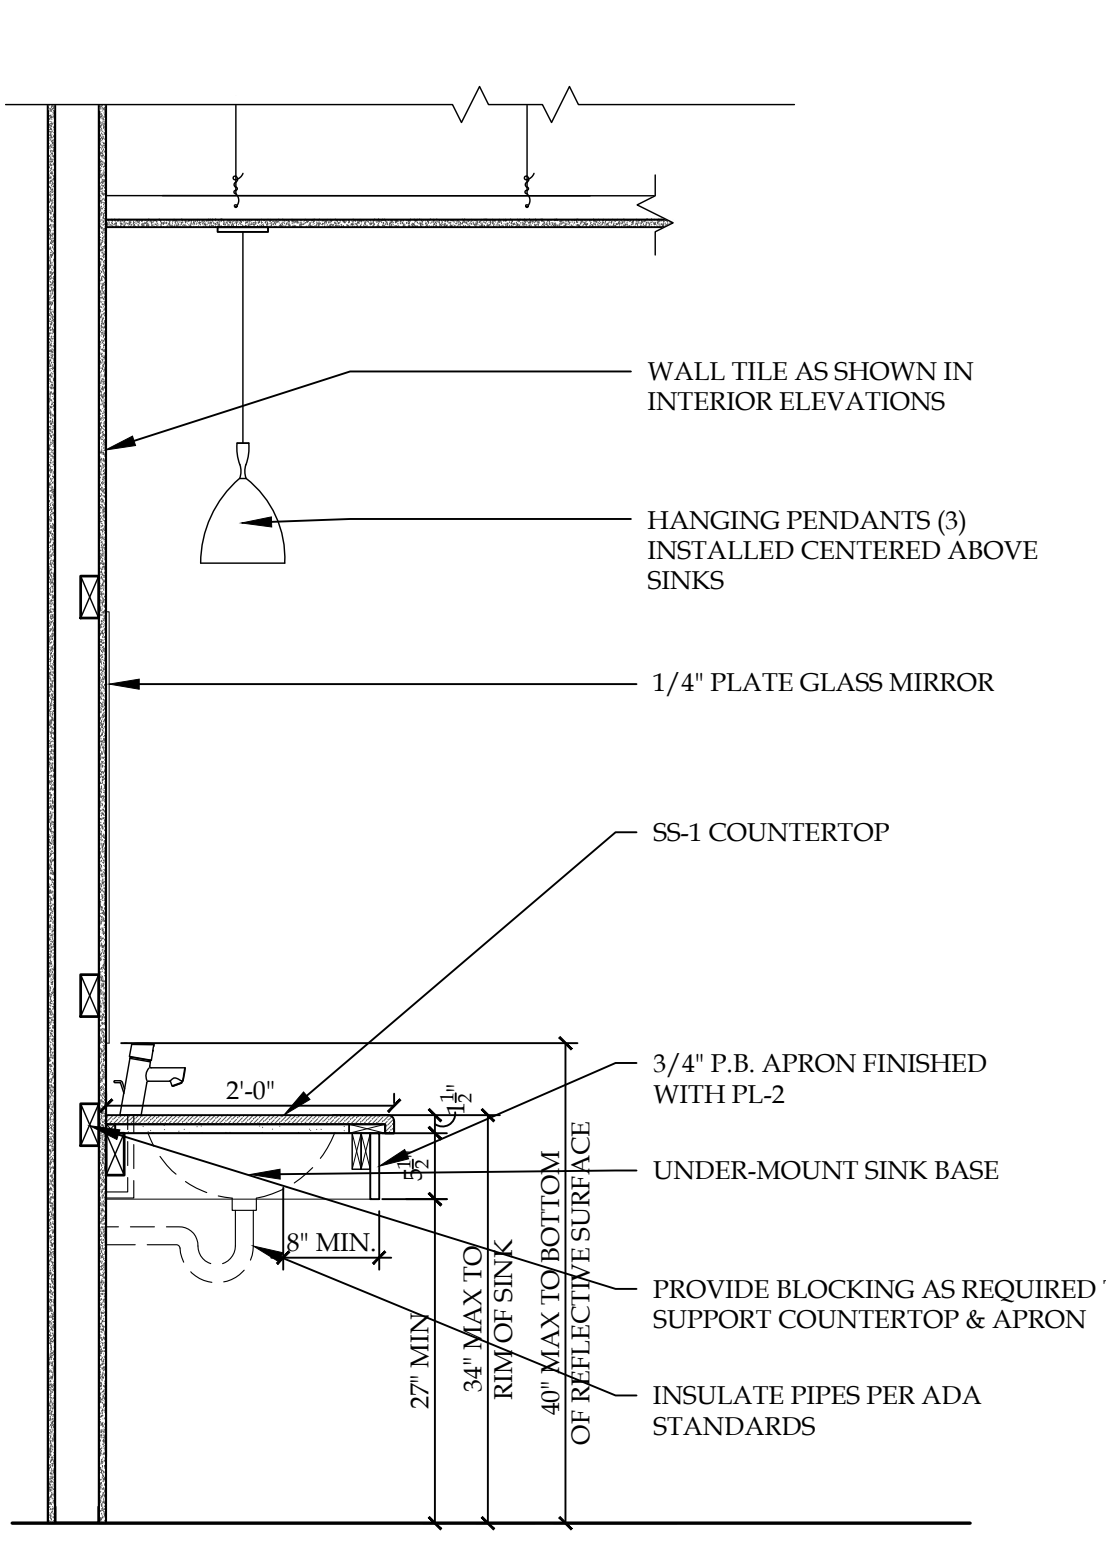

1 SECTION - RESTROOMS  
SCALE: 3/4"=1'-0"




| REVISION RECORD |      |         |
|-----------------|------|---------|
| NO.             | DATE | REMARKS |
|                 |      |         |

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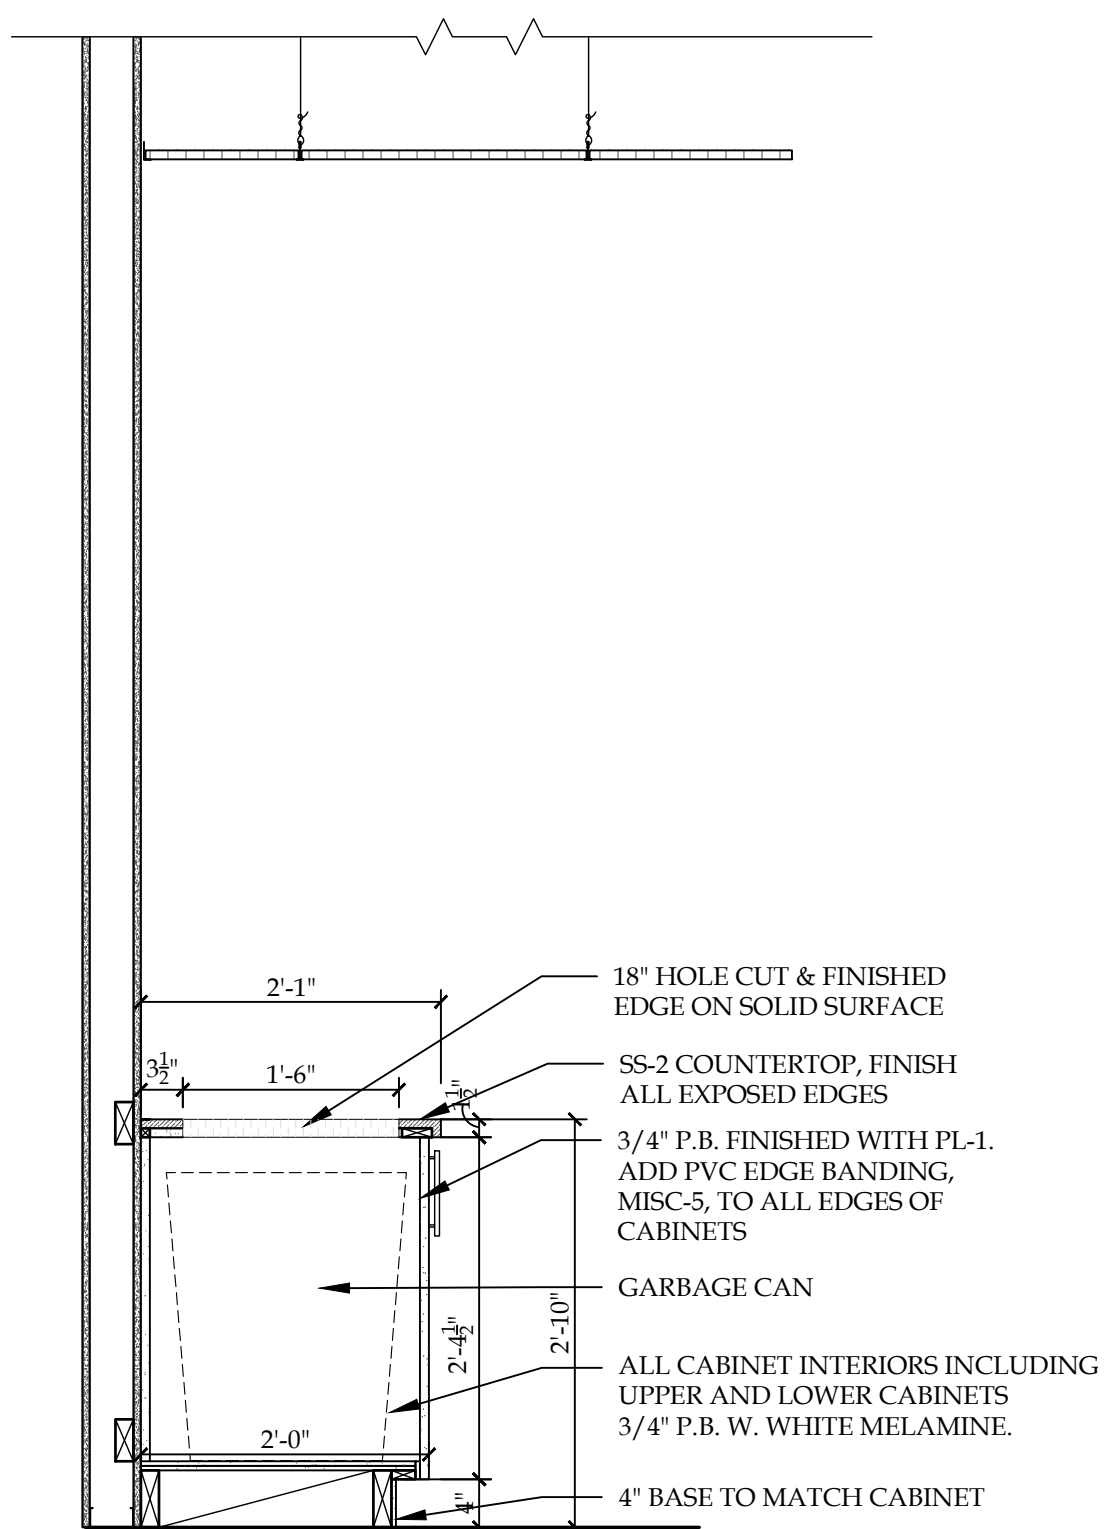
**BRYANT & STRATTON COLLEGE**  
 1320 Warwick Way  
 Mt. Pleasant, WI 53406




**MILLWORK SECTIONS**

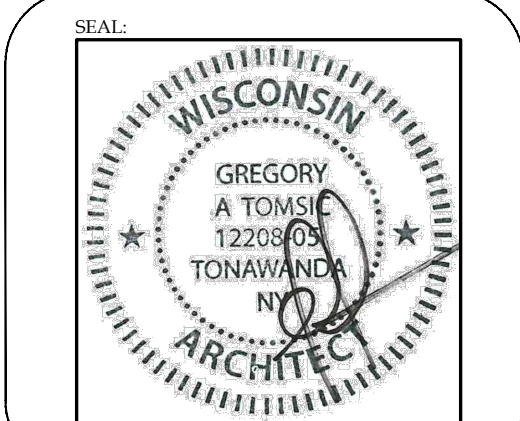**GREGORY A. TOMSIC**  
 REGISTERED ARCHITECT  
 145 BATHURST DR., TONAWANDA, N.Y. 14150  
 716-435-0617


|                       |                          |
|-----------------------|--------------------------|
| SCALE<br>1/8" = 1'-0" | JOB NO.                  |
| DRAWN                 | DWG. NO.<br><b>A-502</b> |
| CHECKED               | CONTRACT NO.             |
| DATE<br>09.06.2017    |                          |




6 SECTION - OPEN LOUNGE #146  
 SCALE: 3/4"=1'-0"

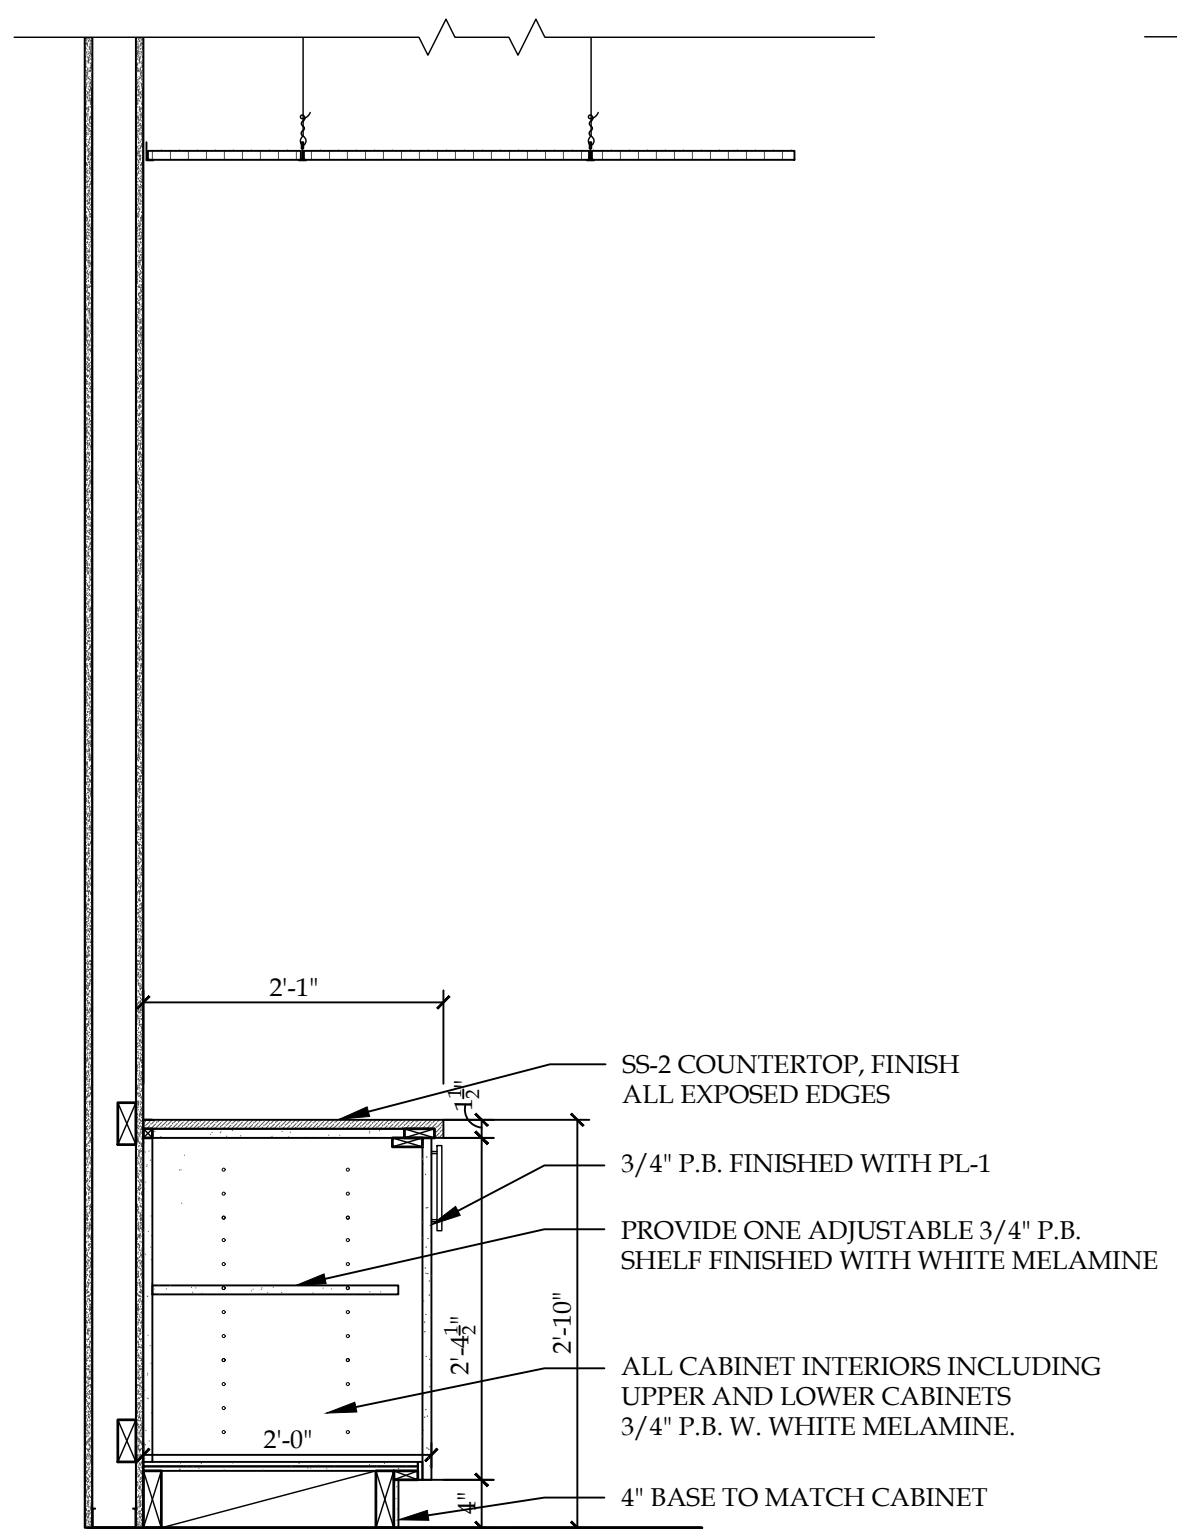


7 SECTION - PC LAB #144  
 SCALE: 3/4"=1'-0"

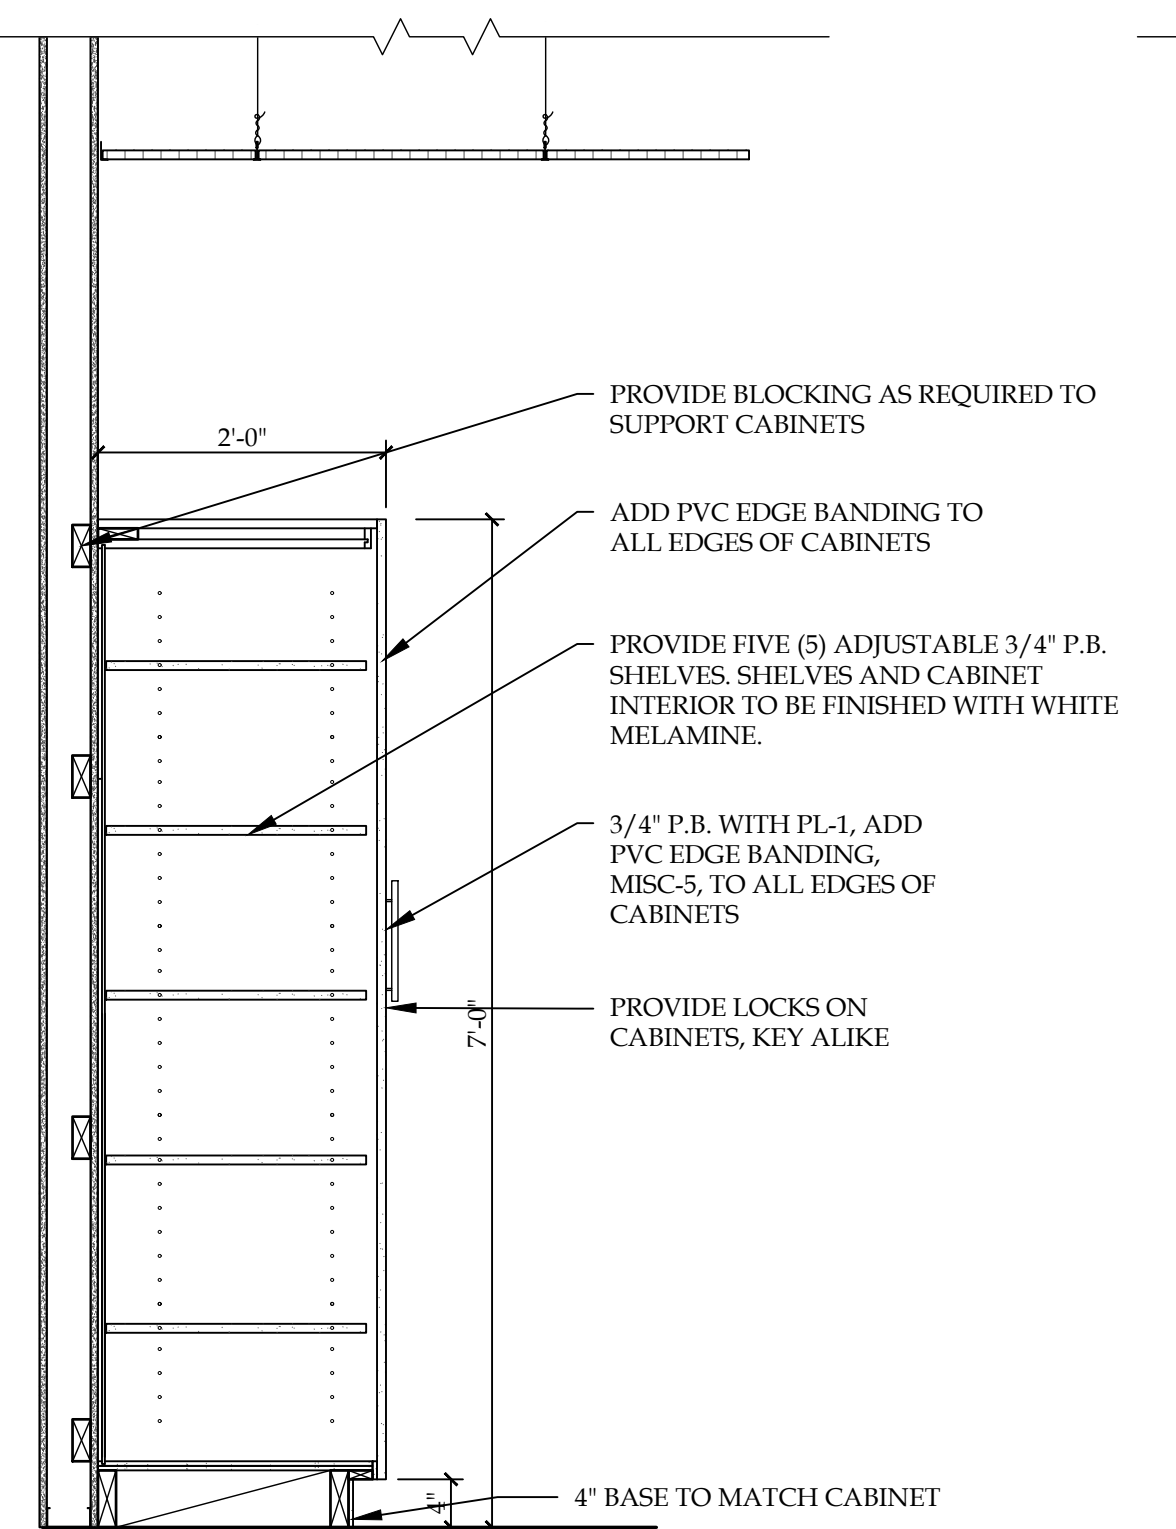


8 SECTION - CHEM/BIO LAB  
 SCALE: 3/4"=1'-0"

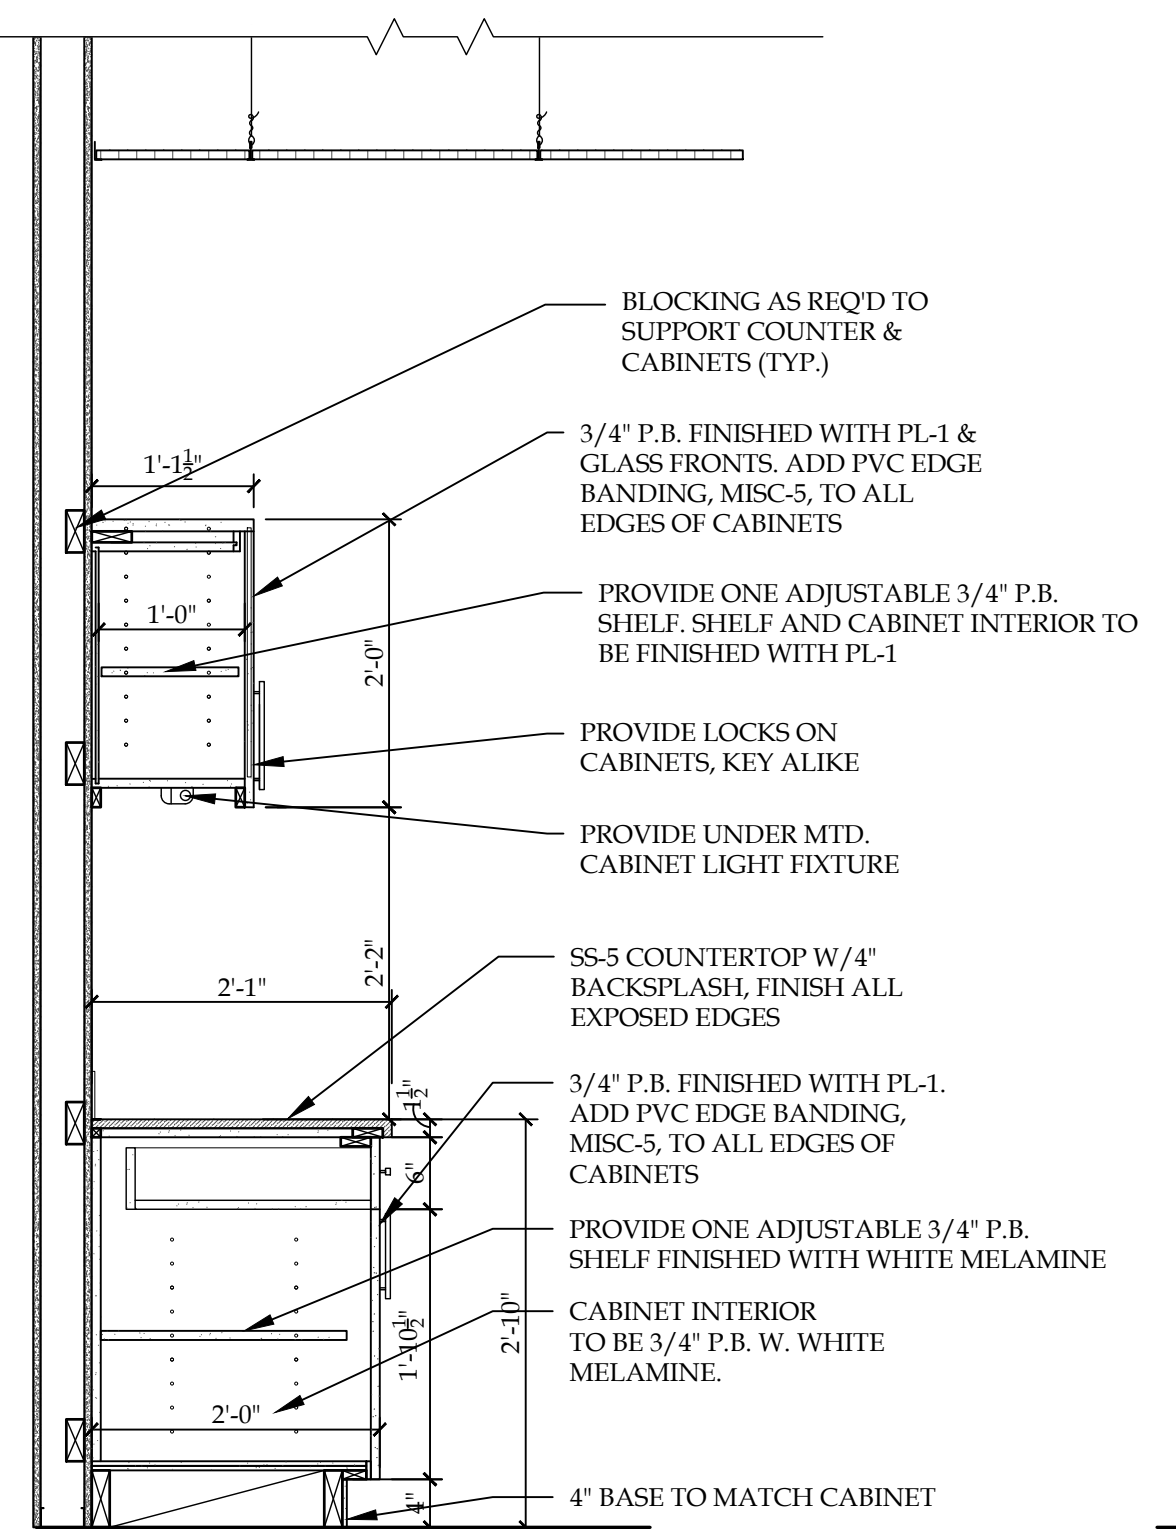


9 SECTION - CHEM/BIO LAB  
 SCALE: 3/4"=1'-0"

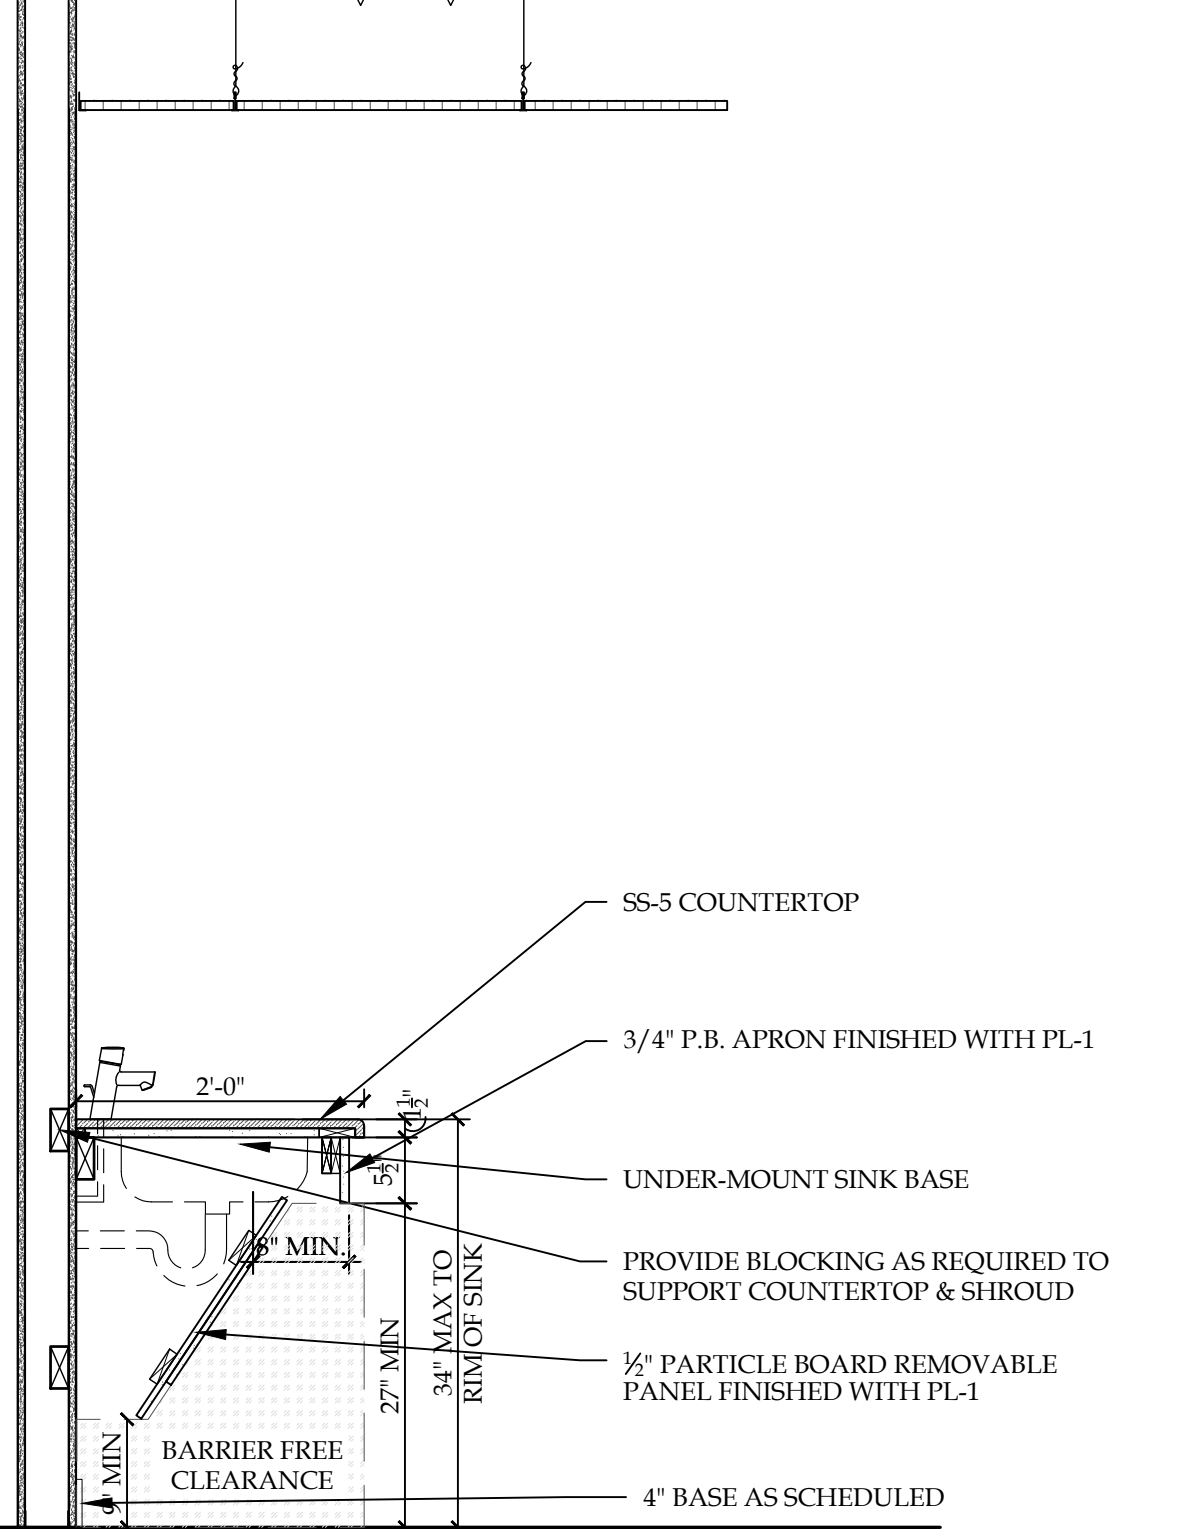


10 SECTION - CHEM/BIO LAB  
 SCALE: 3/4"=1'-0"

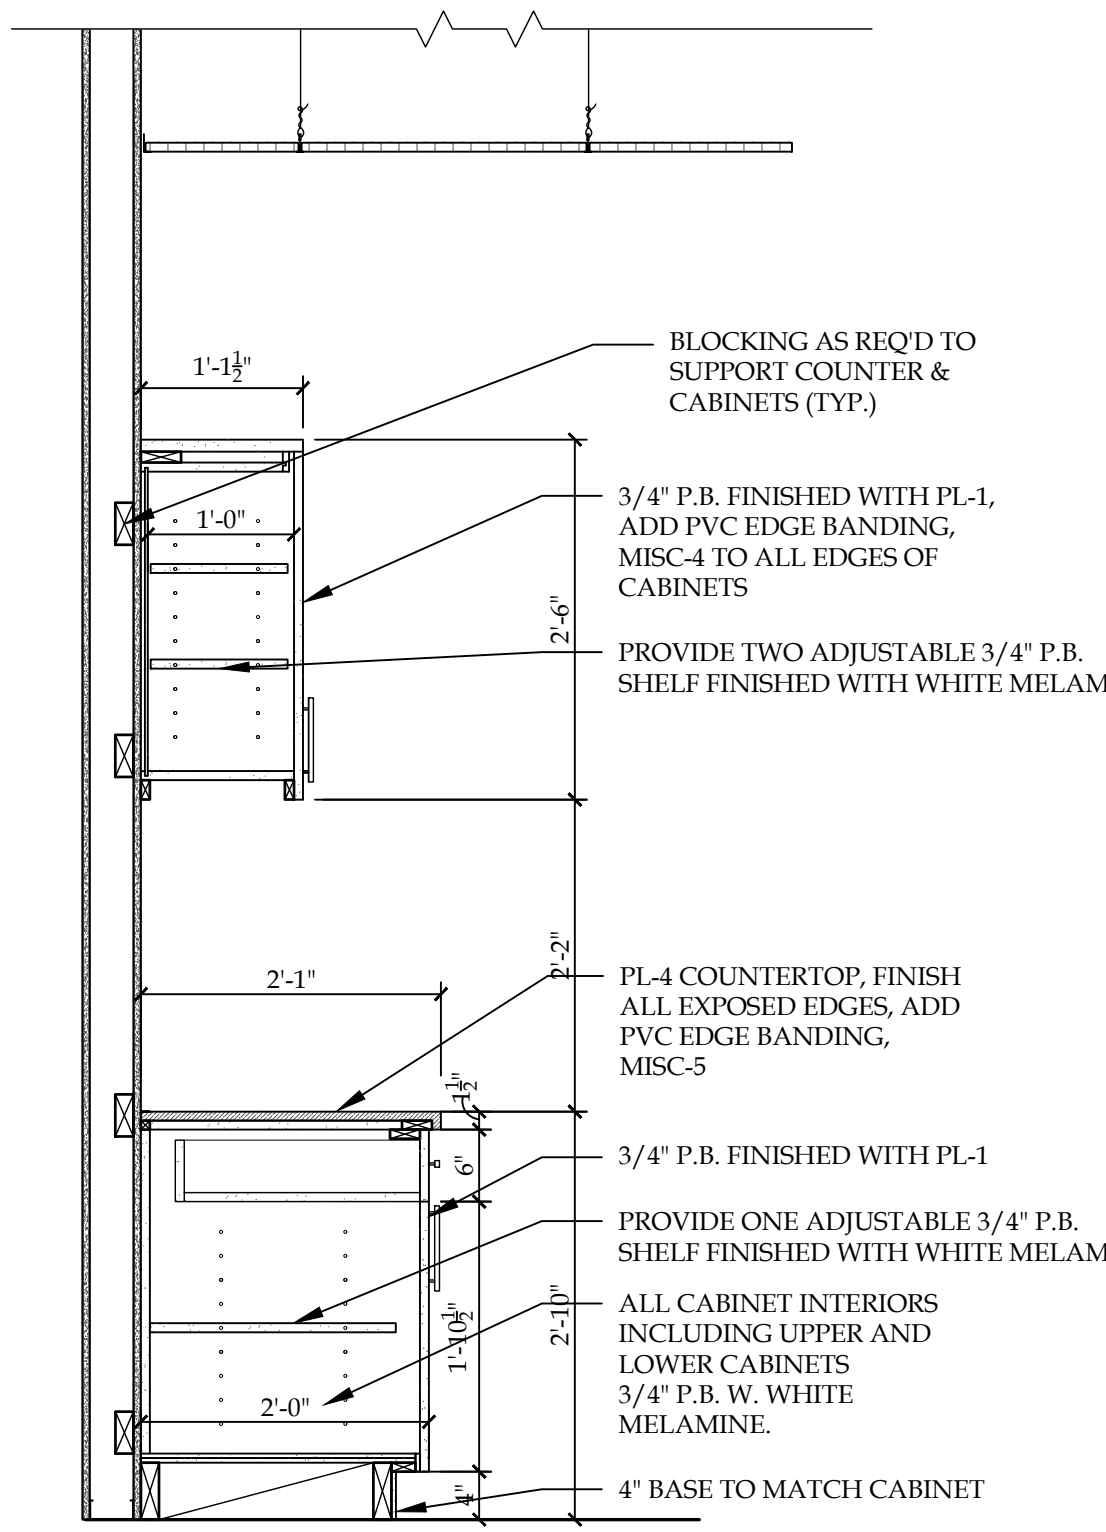


1 SECTION - COPY/MAIL  
 SCALE: 3/4"=1'-0"

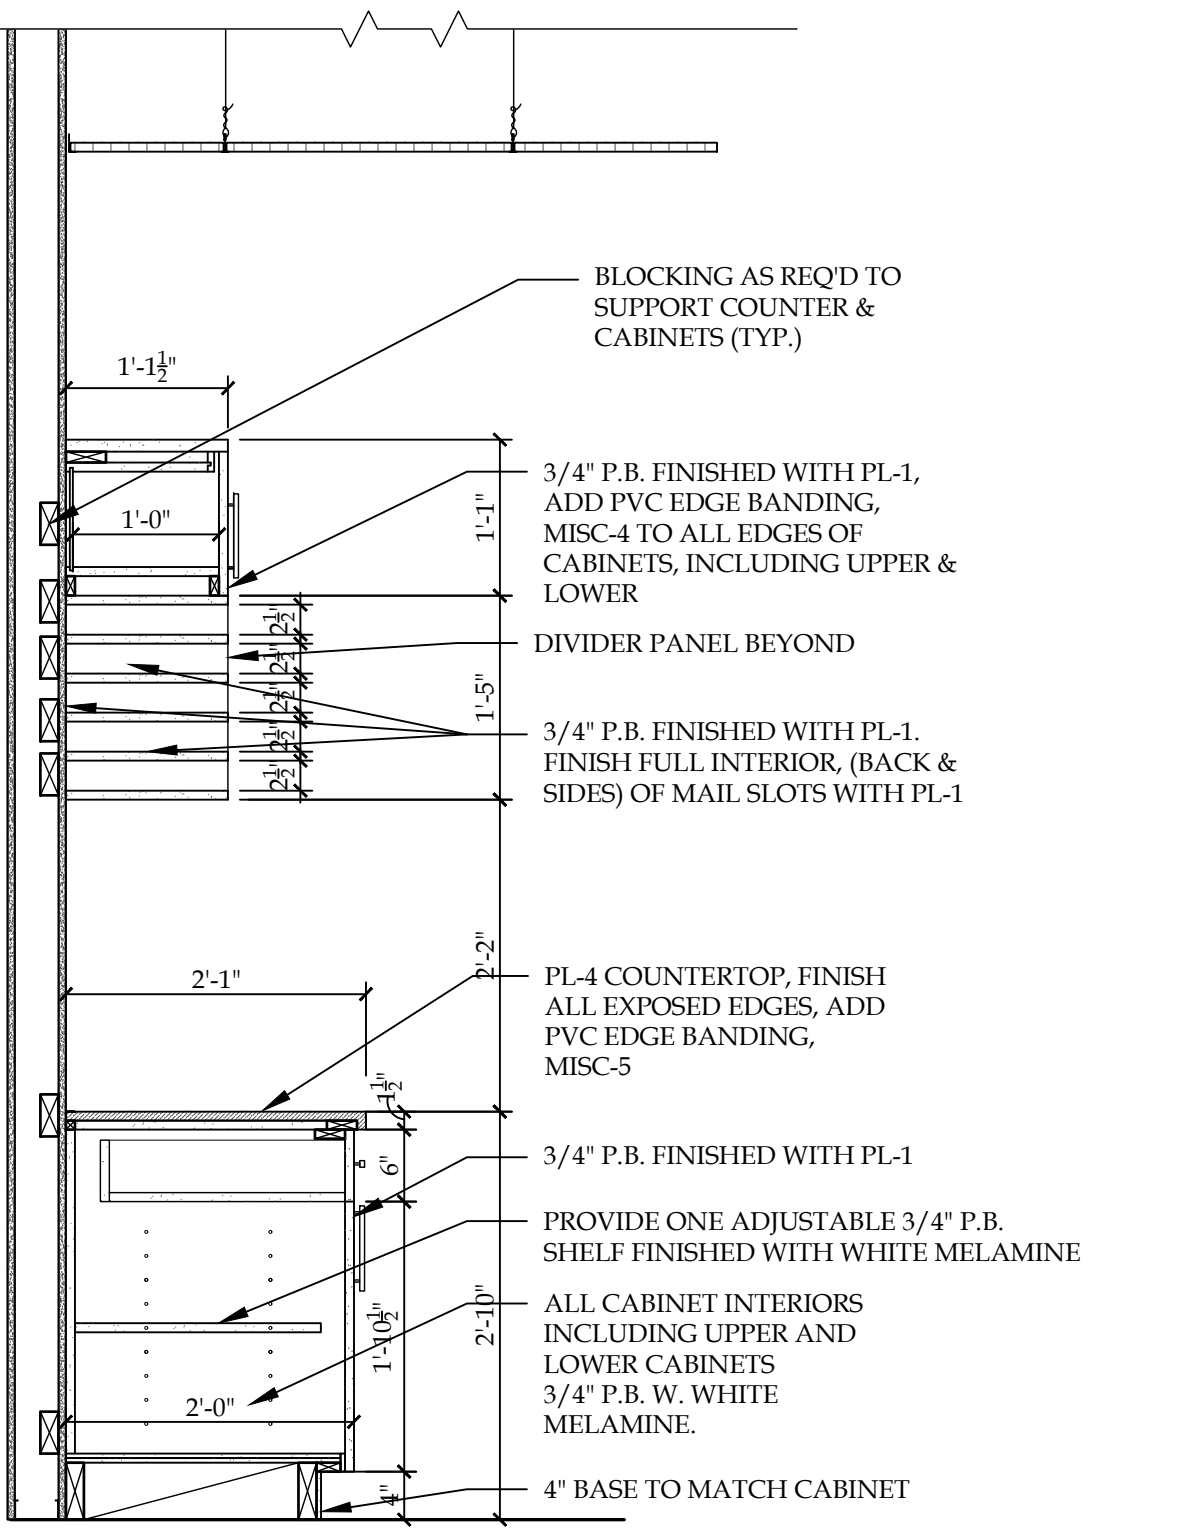


2 SECTION - COPY/MAIL  
 SCALE: 3/4"=1'-0"

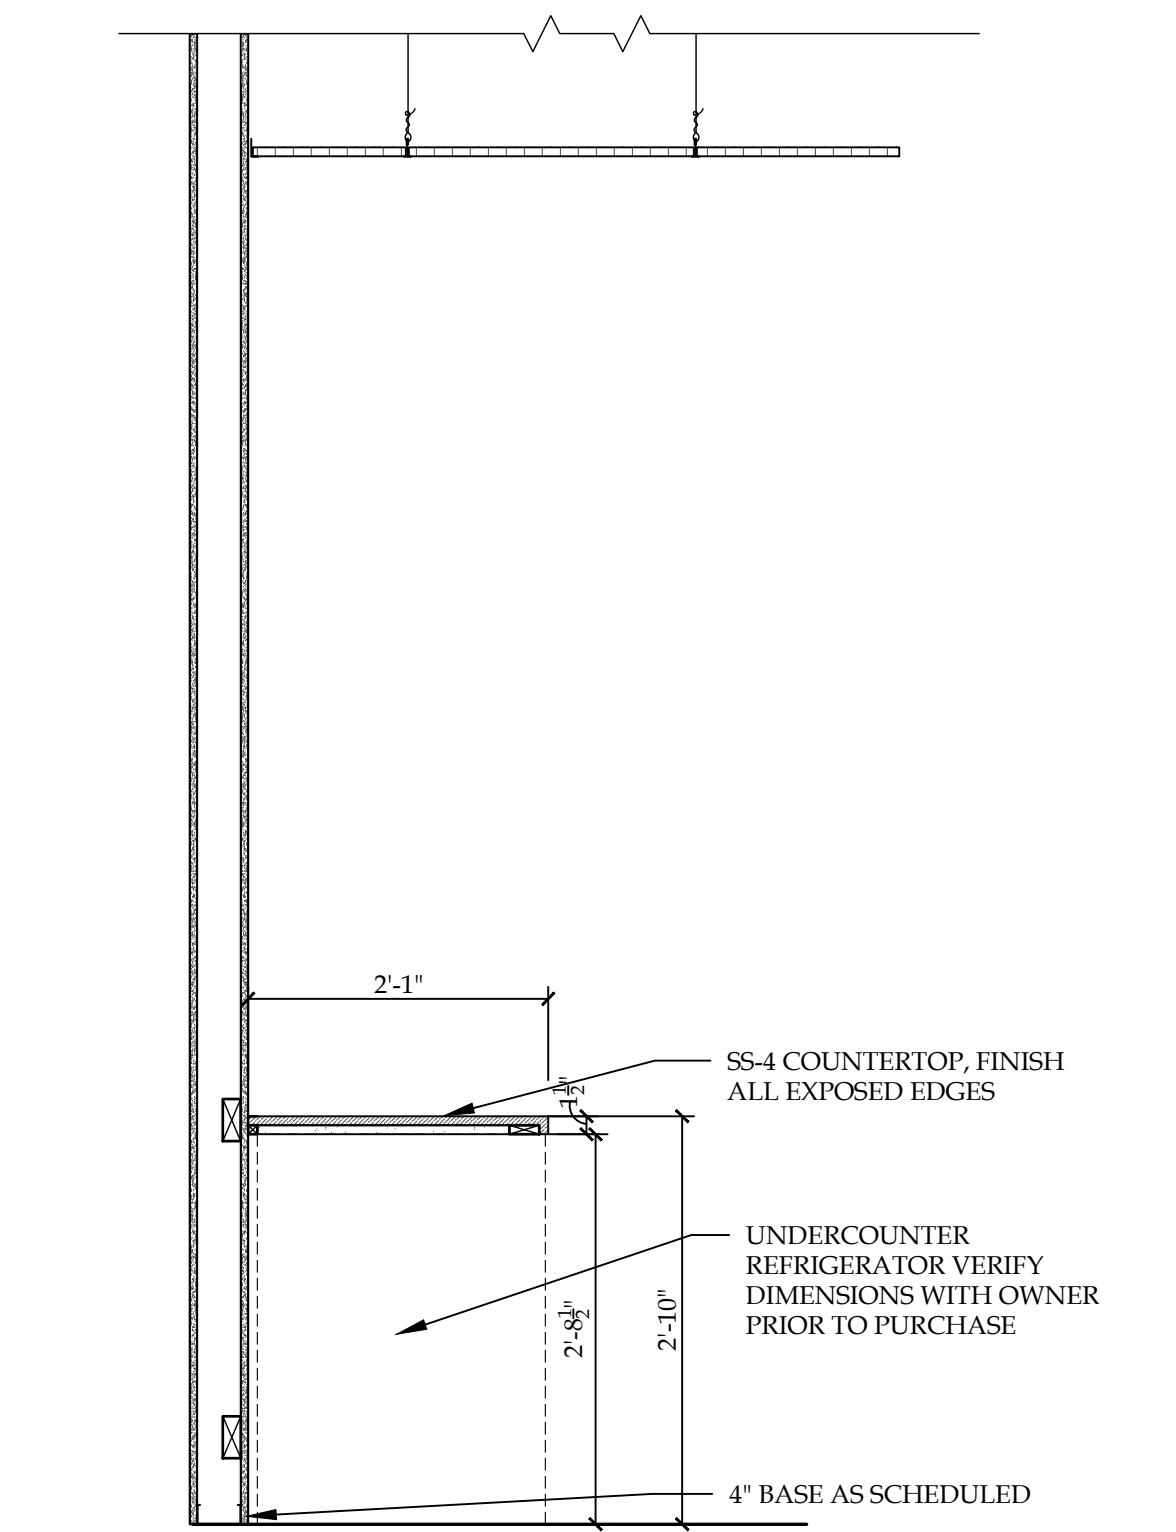

3 SECTION - CONFERENCE ROOM  
 SCALE: 3/4"=1'-0"

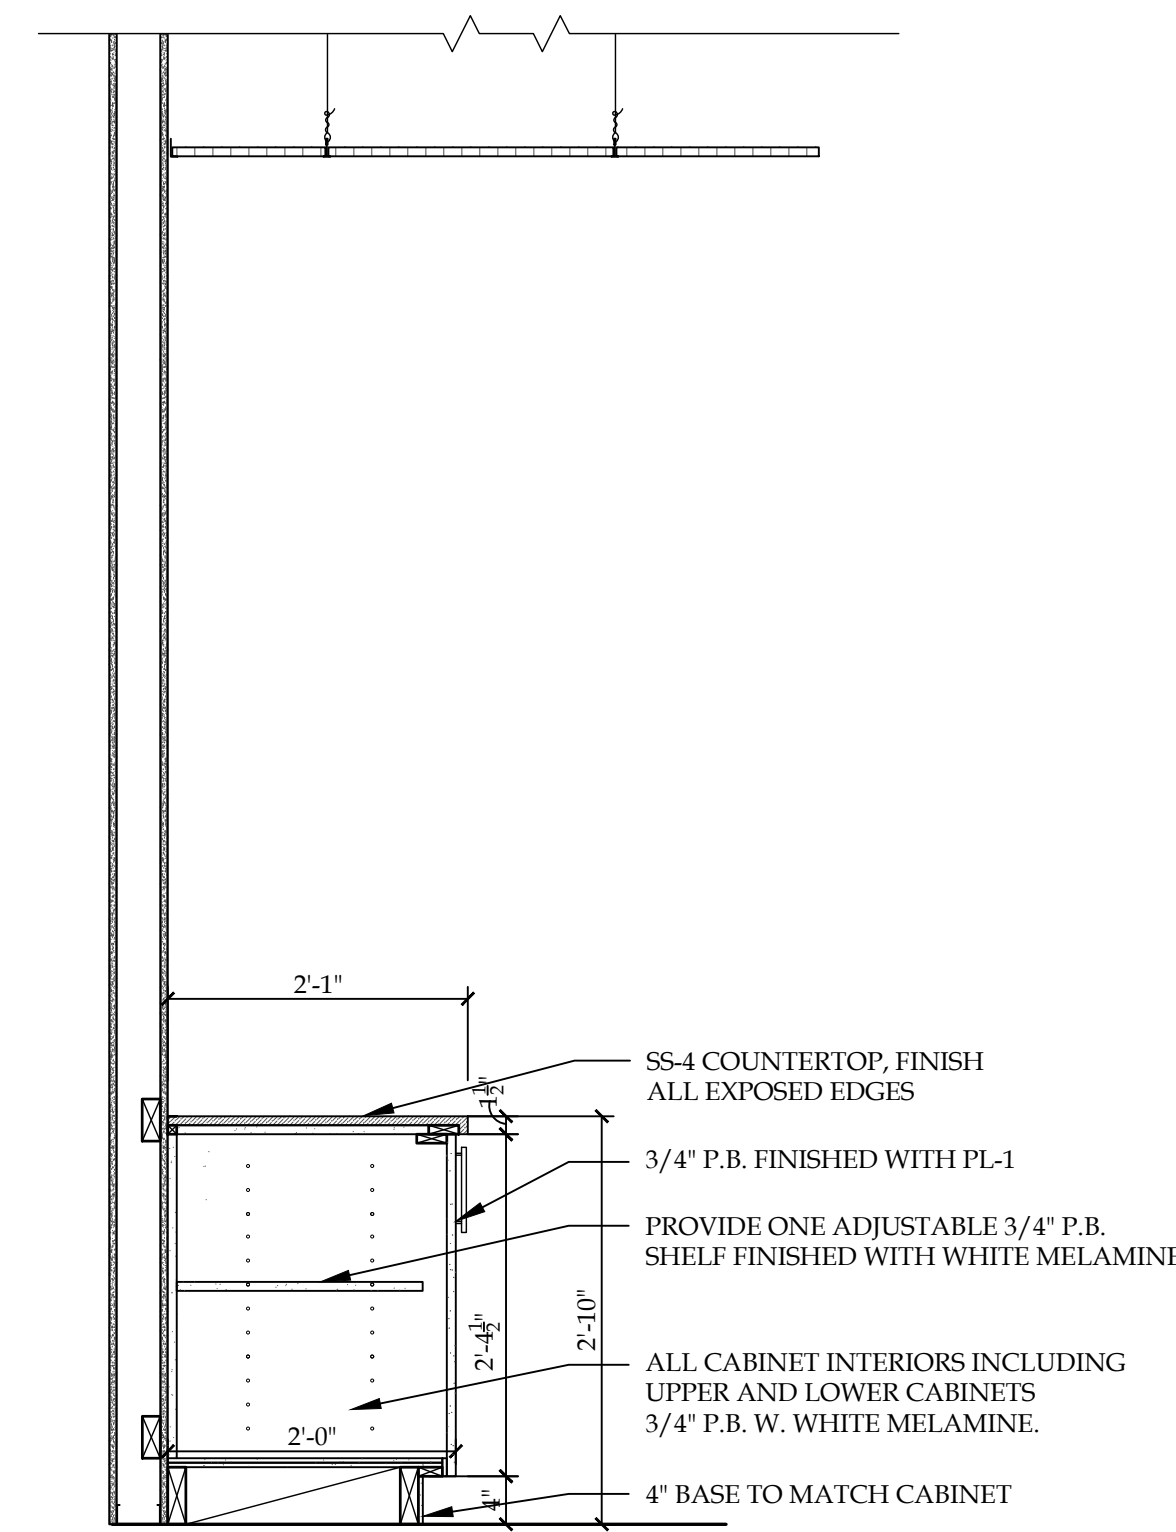

4 SECTION - CONFERENCE ROOM  
 SCALE: 3/4"=1'-0"

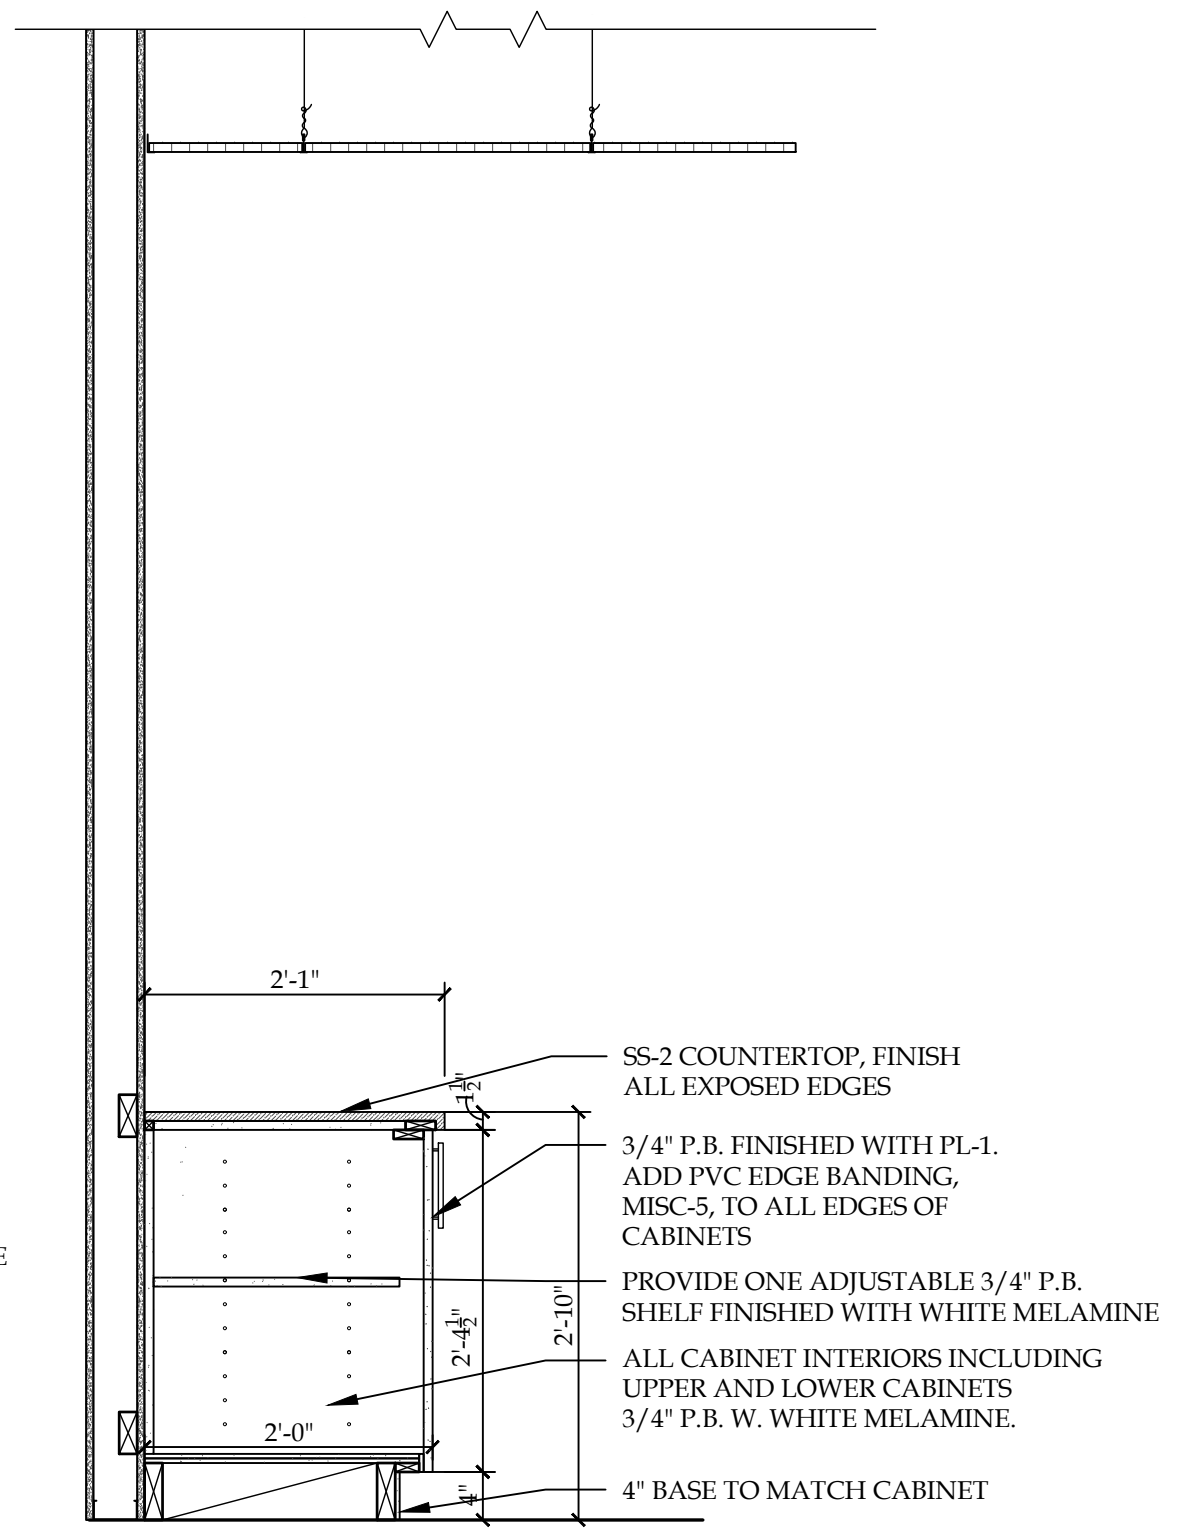

5 SECTION - OPEN LOUNGE  
 SCALE: 3/4"=1'-0"



| REVISION RECORD |      |         |
|-----------------|------|---------|
| NO.             | DATE | REMARKS |
|                 |      |         |


IT IS A VIOLATION OF STATE LAW FOR ANY PERSON, UNLESS ACTING UNDER THE DIRECTION OF A NEW YORK STATE ARCHITECT OR ENGINEER, TO ALTER ANY ITEM ON THIS DOCUMENT IN ANY WAY. IF ANY ITEM ON THIS DOCUMENT IS ALTERED, THE ALTERING ARCHITECT OR ENGINEER SHALL AFFIX TO HIS ITEM HIS SEAL AND THE NOTATION "ALTERED" FOLLOWED BY HIS SIGNATURE, THE DATE OF SUCH ALTERATION AND A SPECIFIC DESCRIPTION OF SUCH ALTERATION.



**Bryant and Stratton College**

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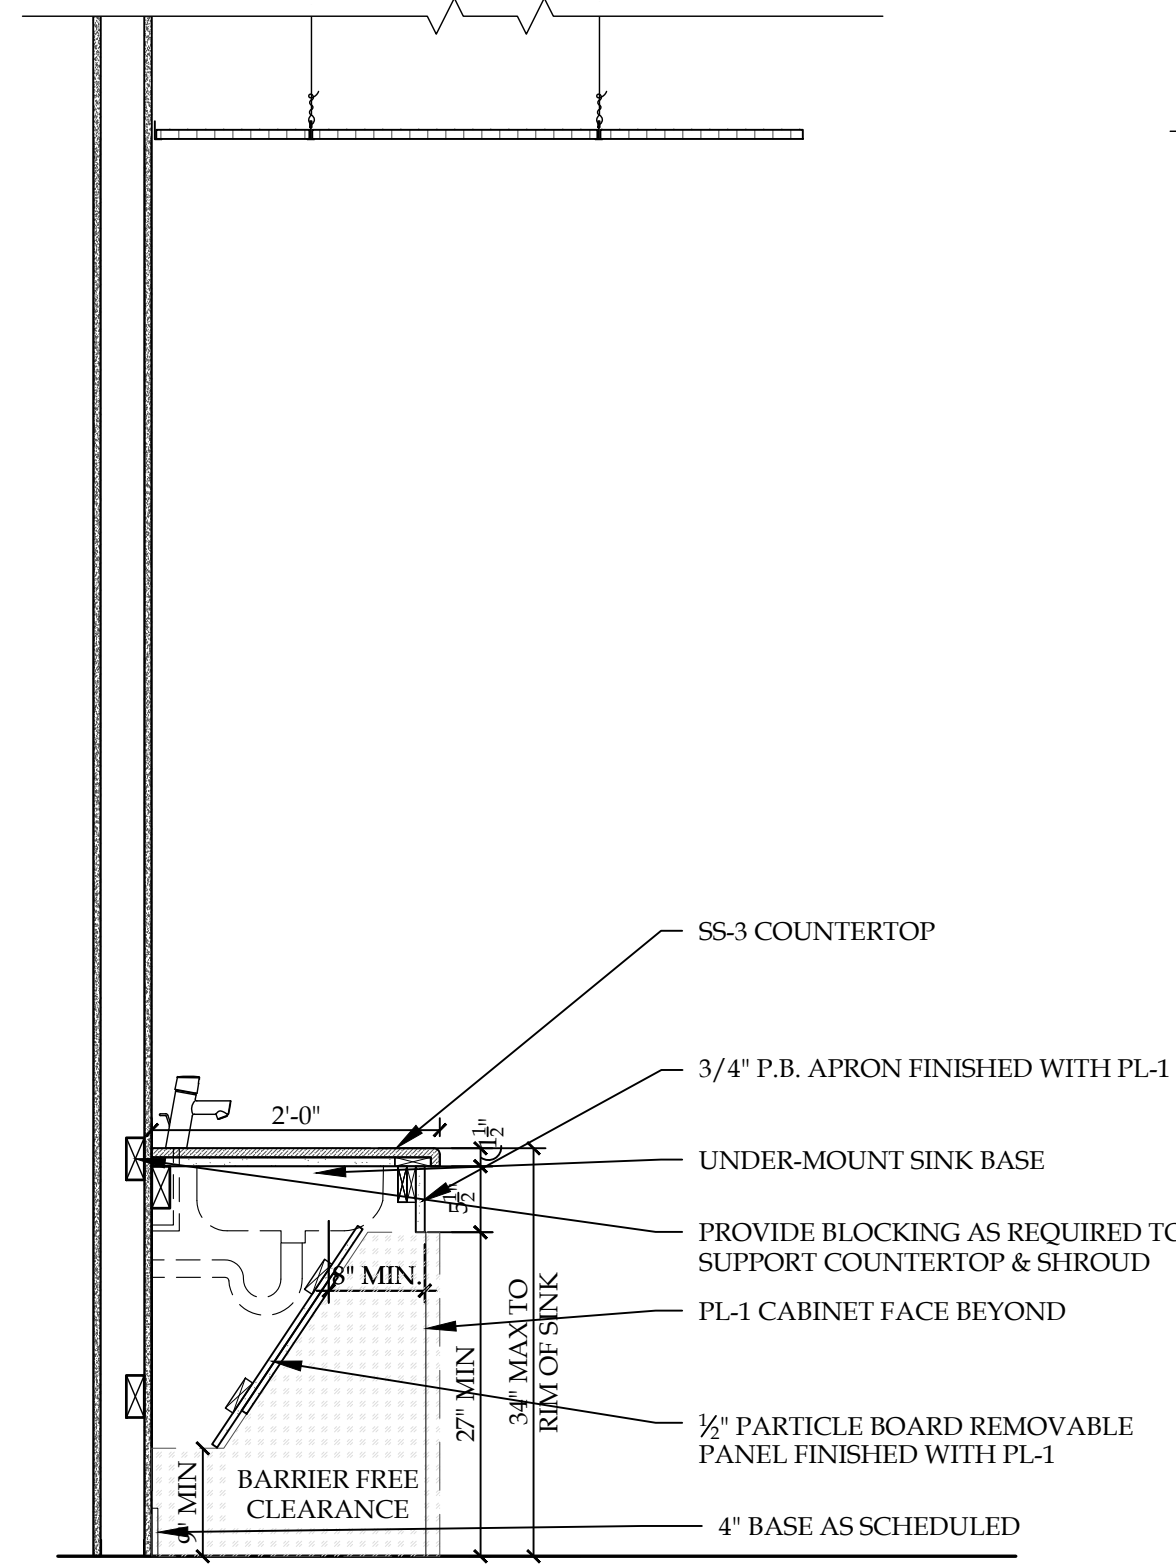
1320 Warwick Way  
Mt. Pleasant, WI 53406

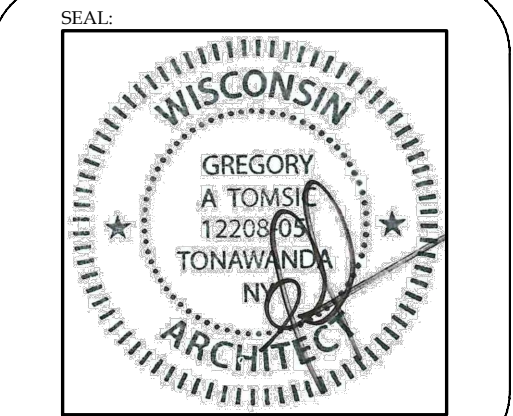


**MILLWORK SECTIONS**

**GREGORY A. TOMSIC**  
REGISTERED ARCHITECT  
145 BATHURST DR., TONAWANDA, N.Y. 14150  
716-435-0617


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| DRAWN                 | DWG. NO.<br><b>A-503</b> |
| CHECKED               | DATE                     |
| DATE<br>09.06.2017    | CONTRACT NO.             |




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SCALE: 3/4"=1'-0"

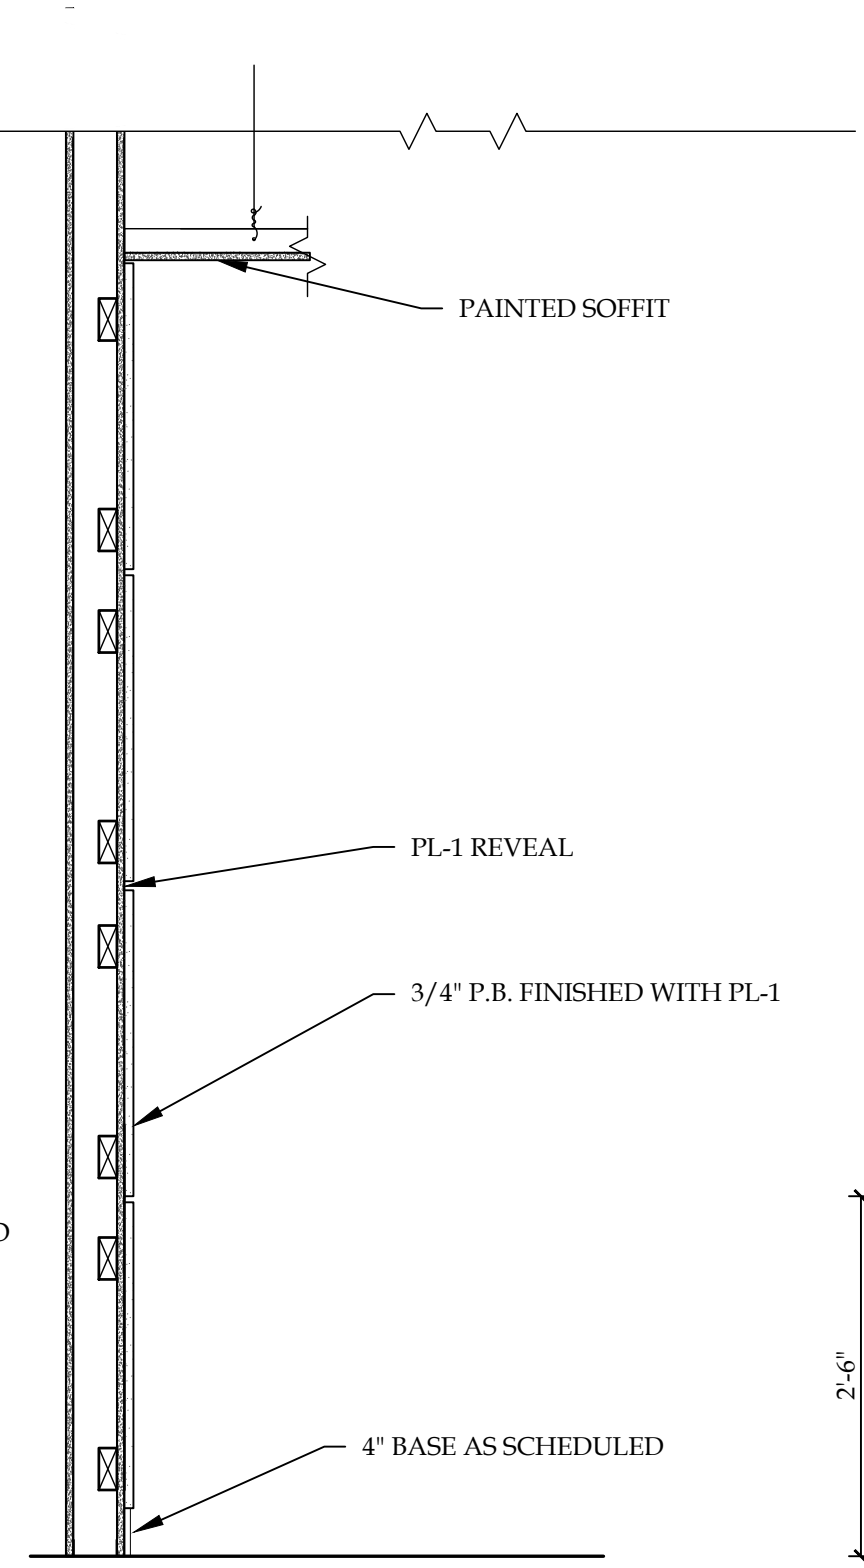


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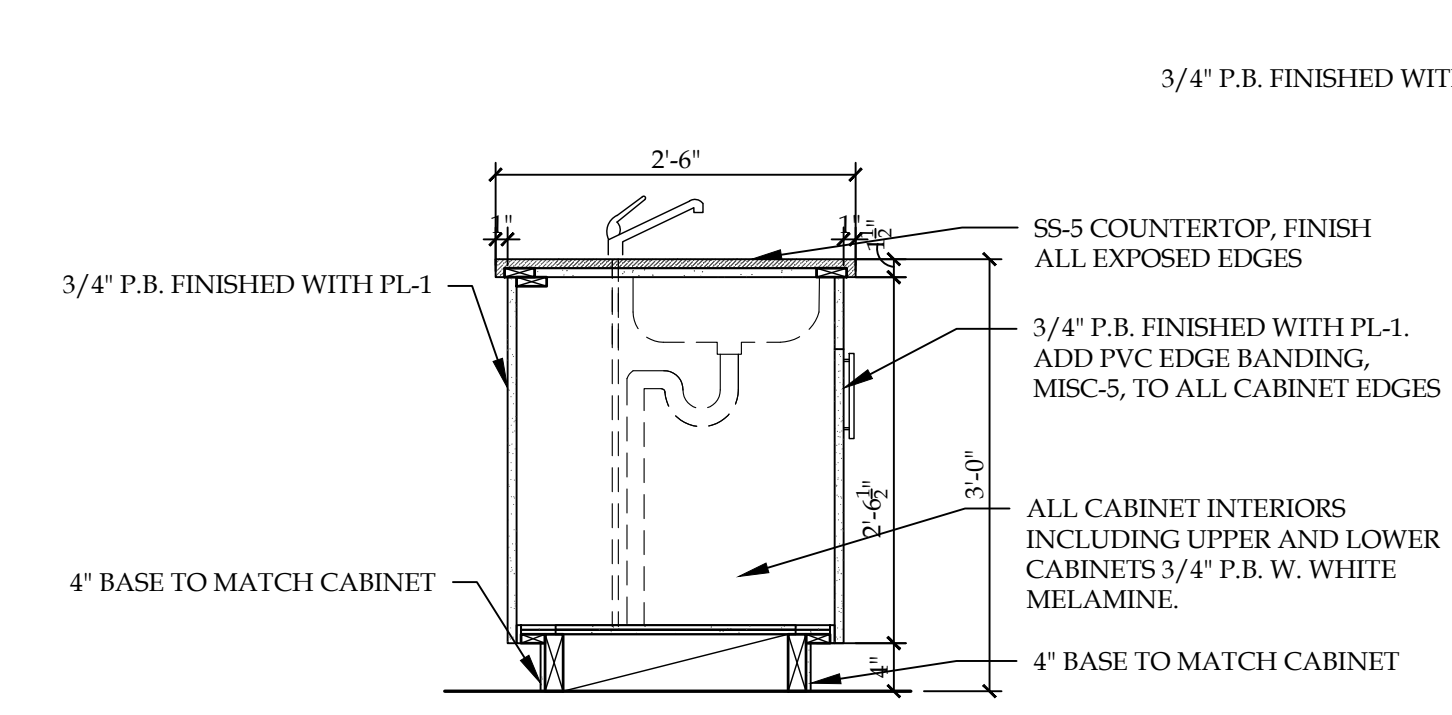
8 SECTION - LIBRARY  
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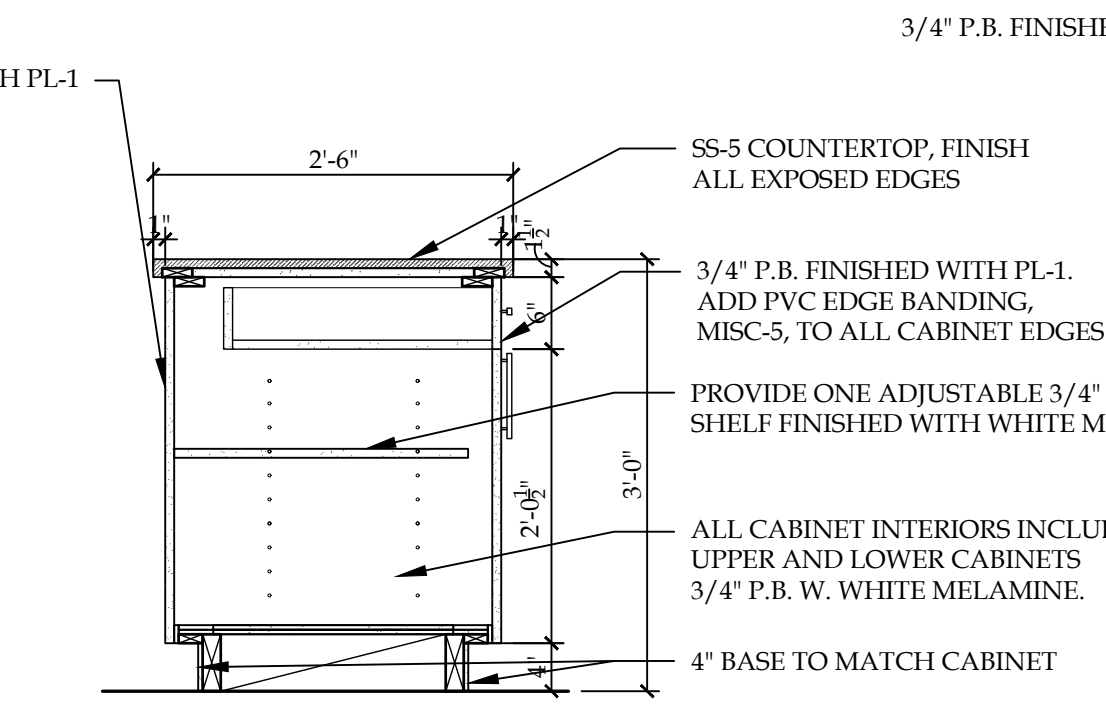
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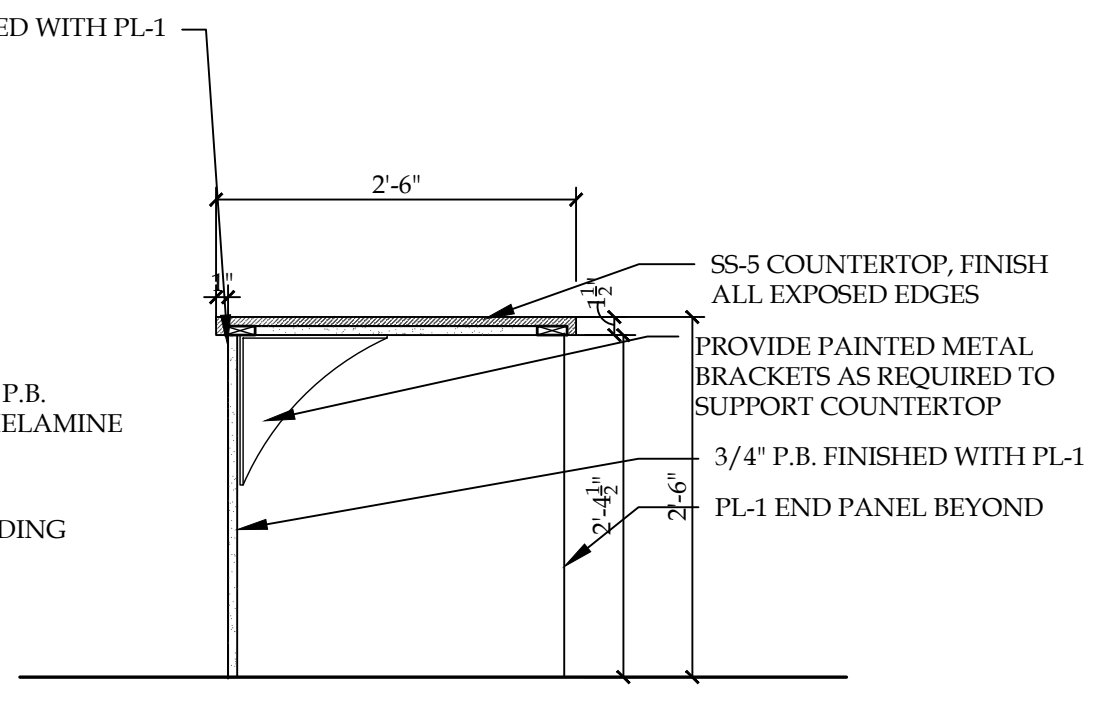
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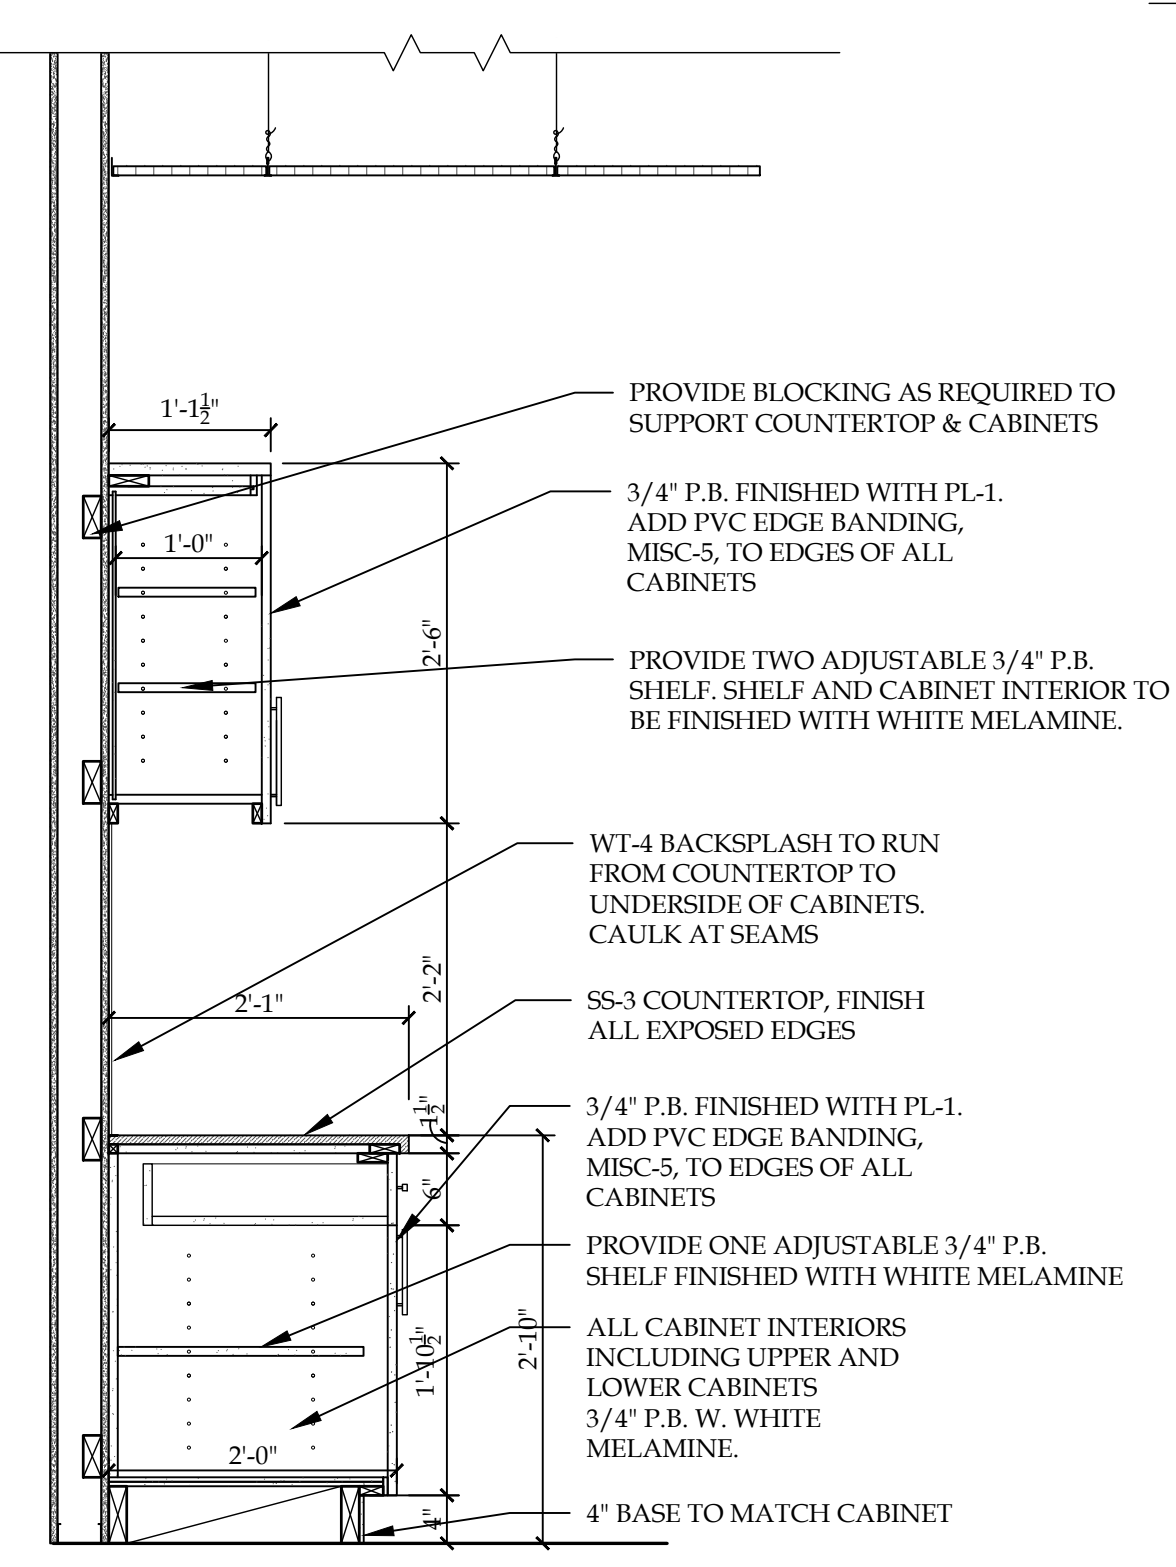
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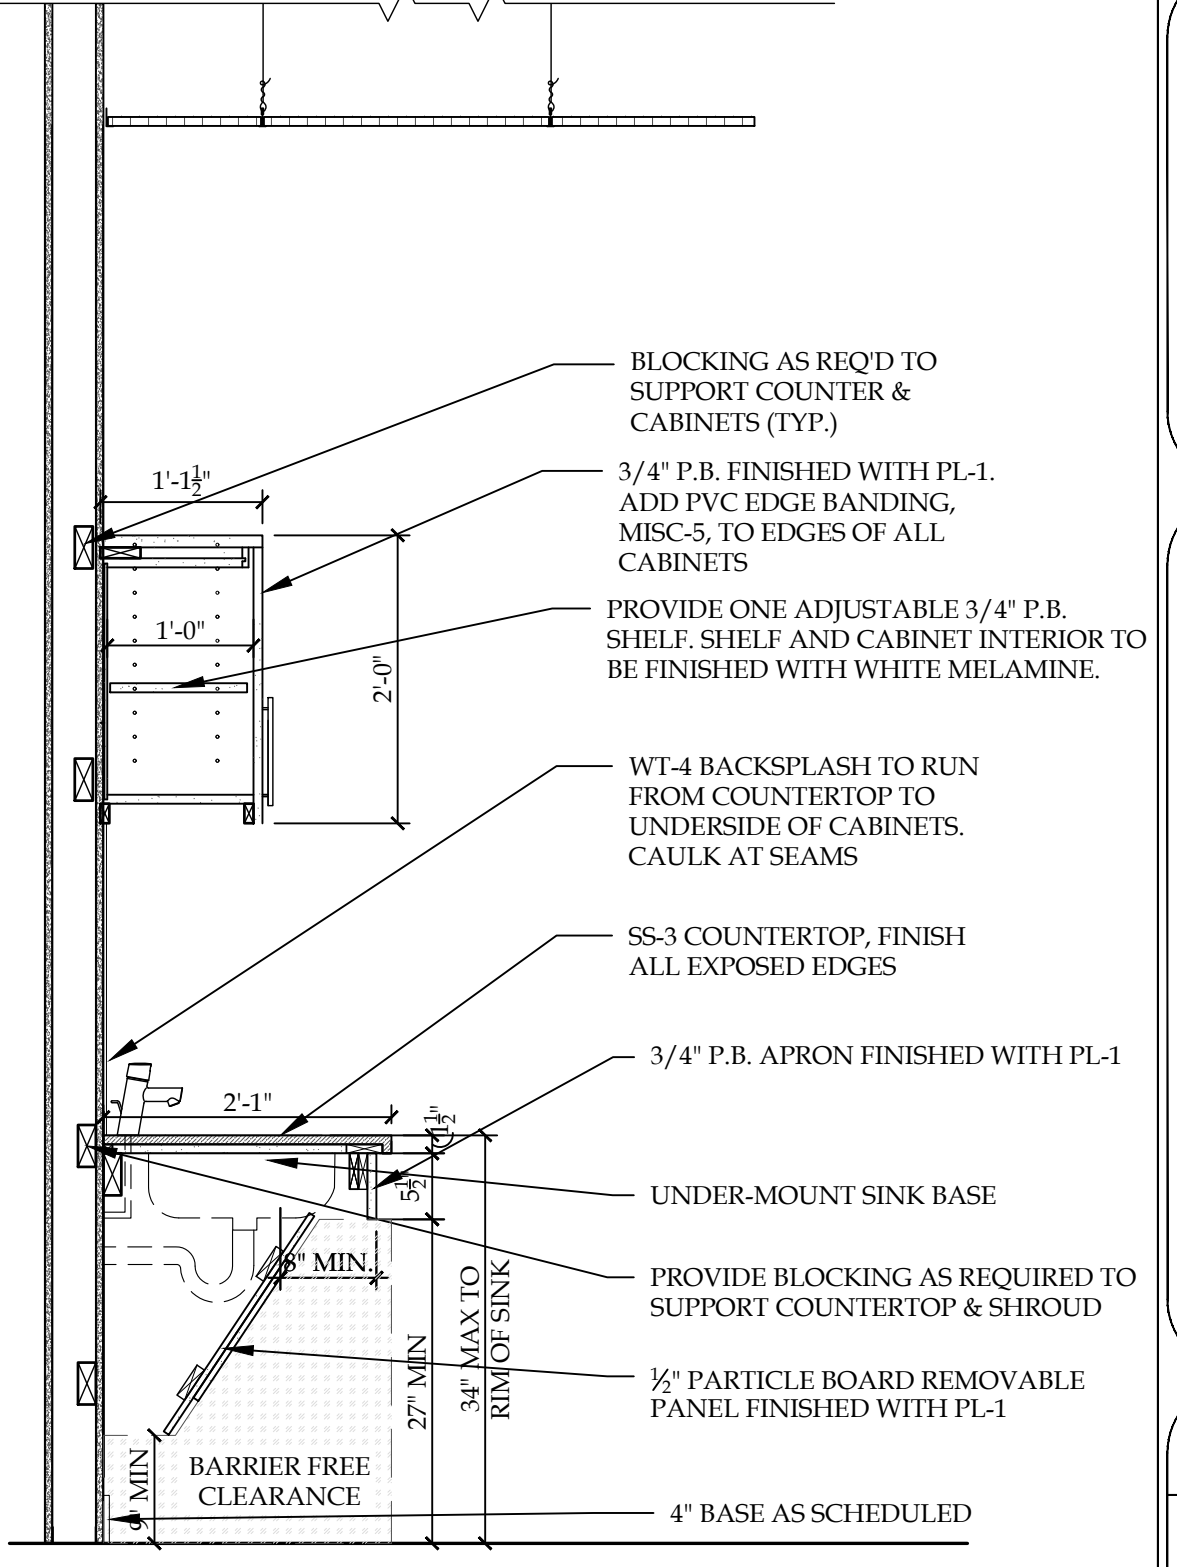
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3 SECTION - CHEM/BIO LAB  
SCALE: 3/4"=1'-0"

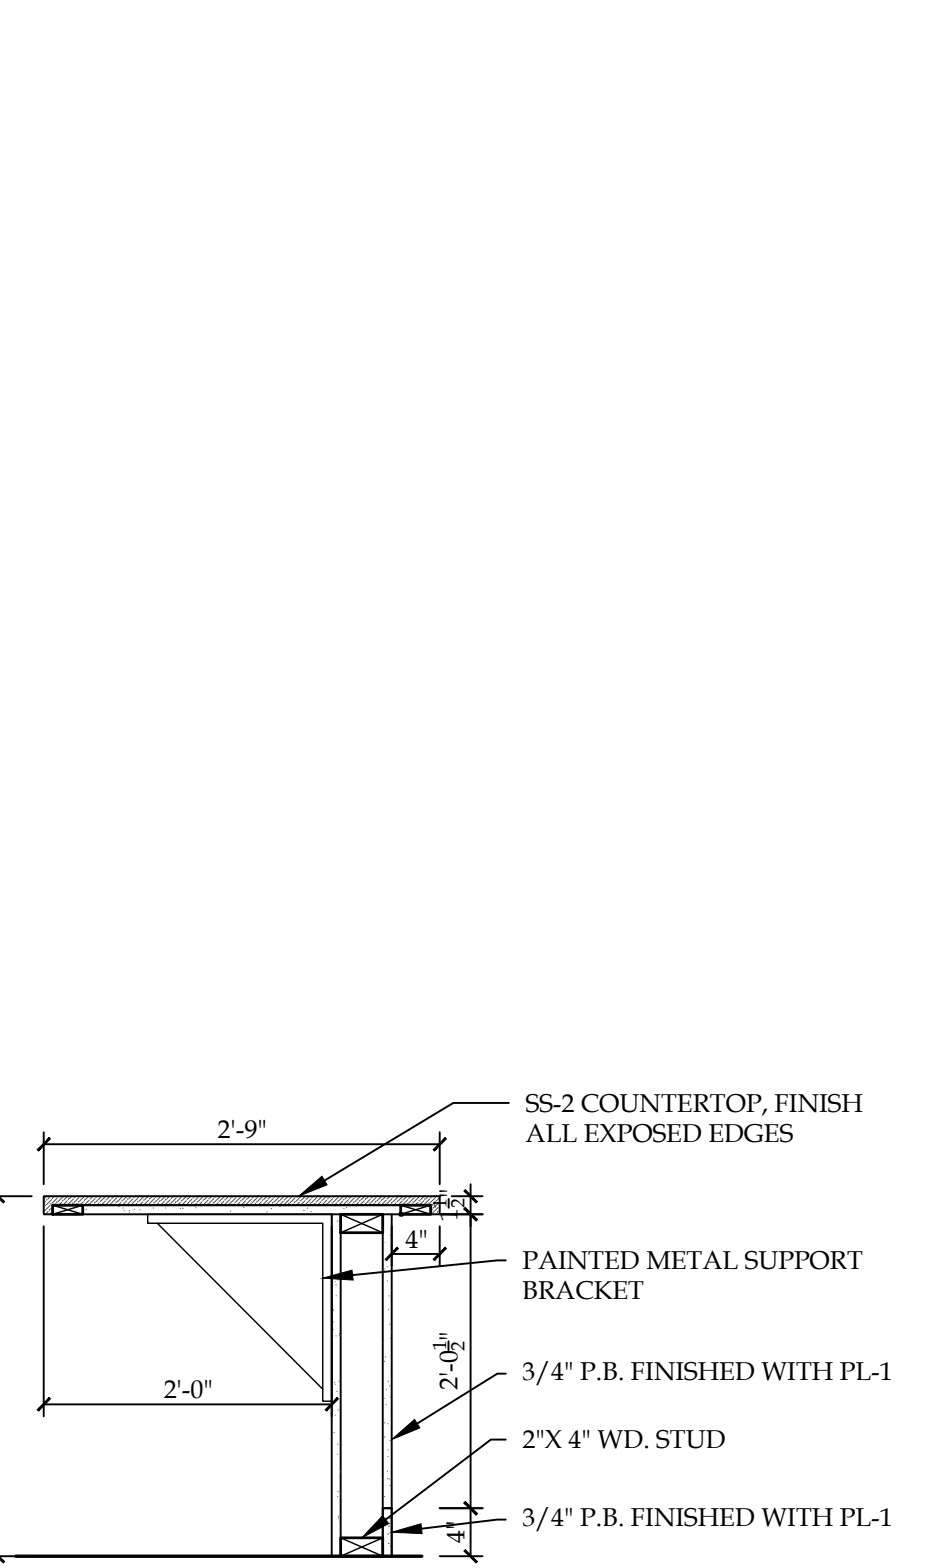

4 SECTION - NURSING  
SCALE: 3/4"=1'-0"

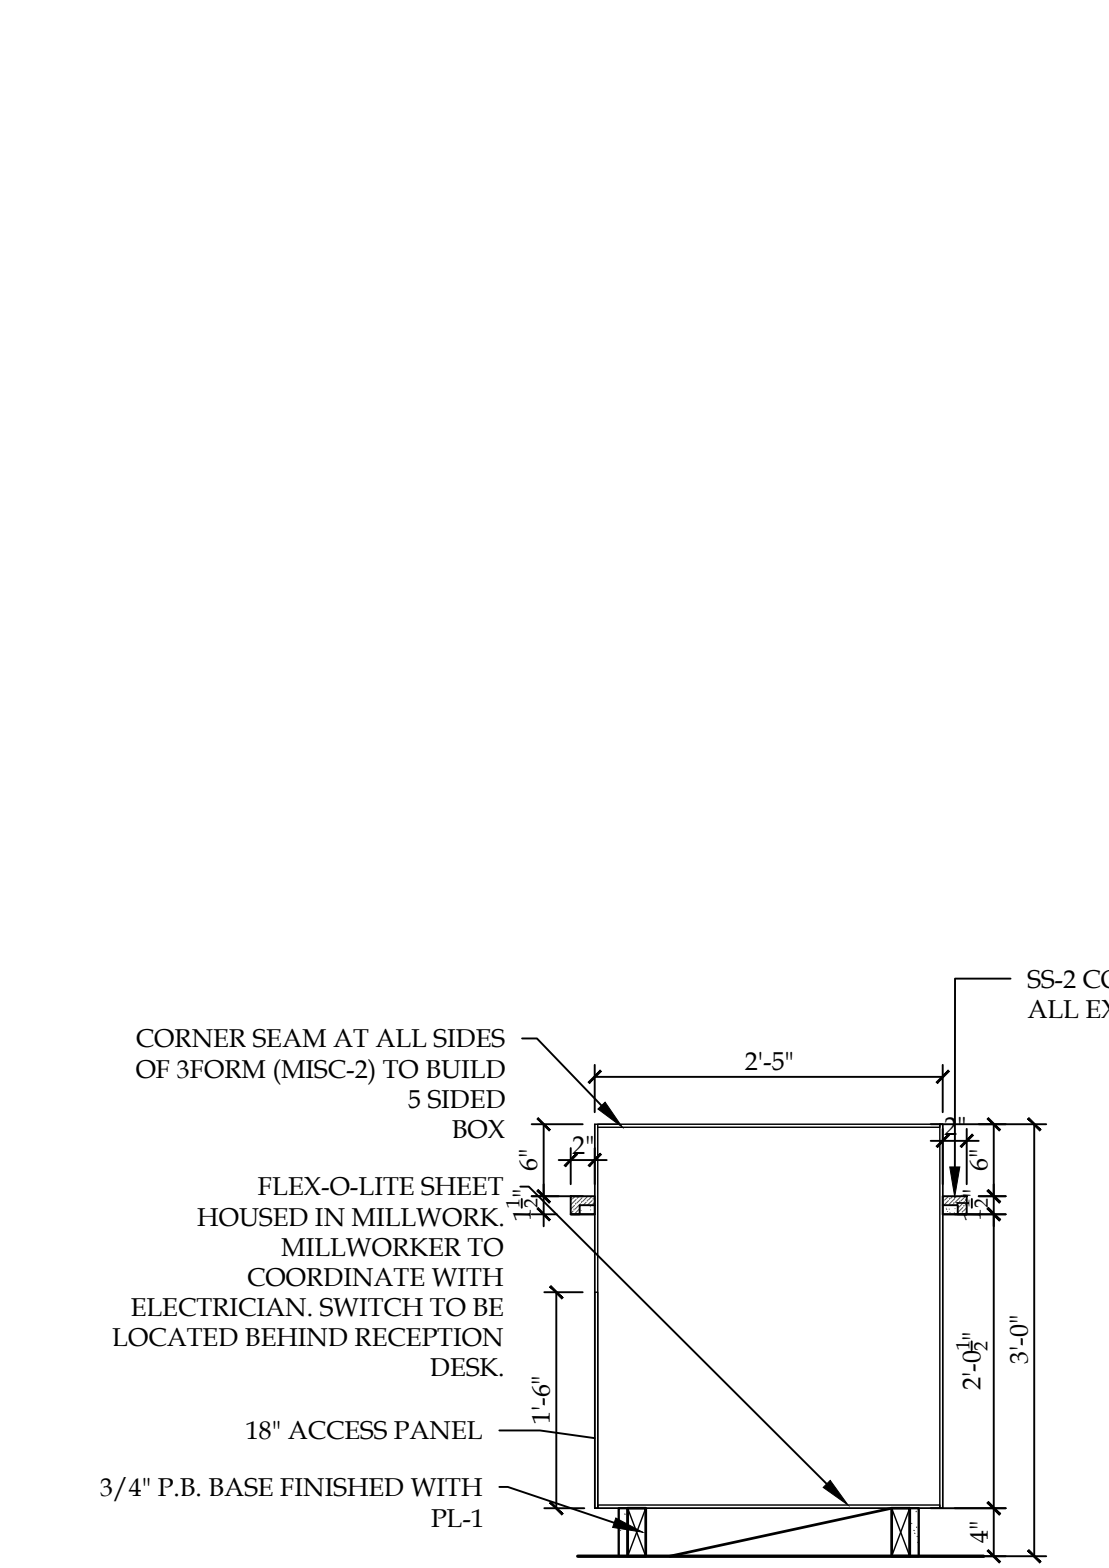

5 SECTION - NURSING  
SCALE: 3/4"=1'-0"

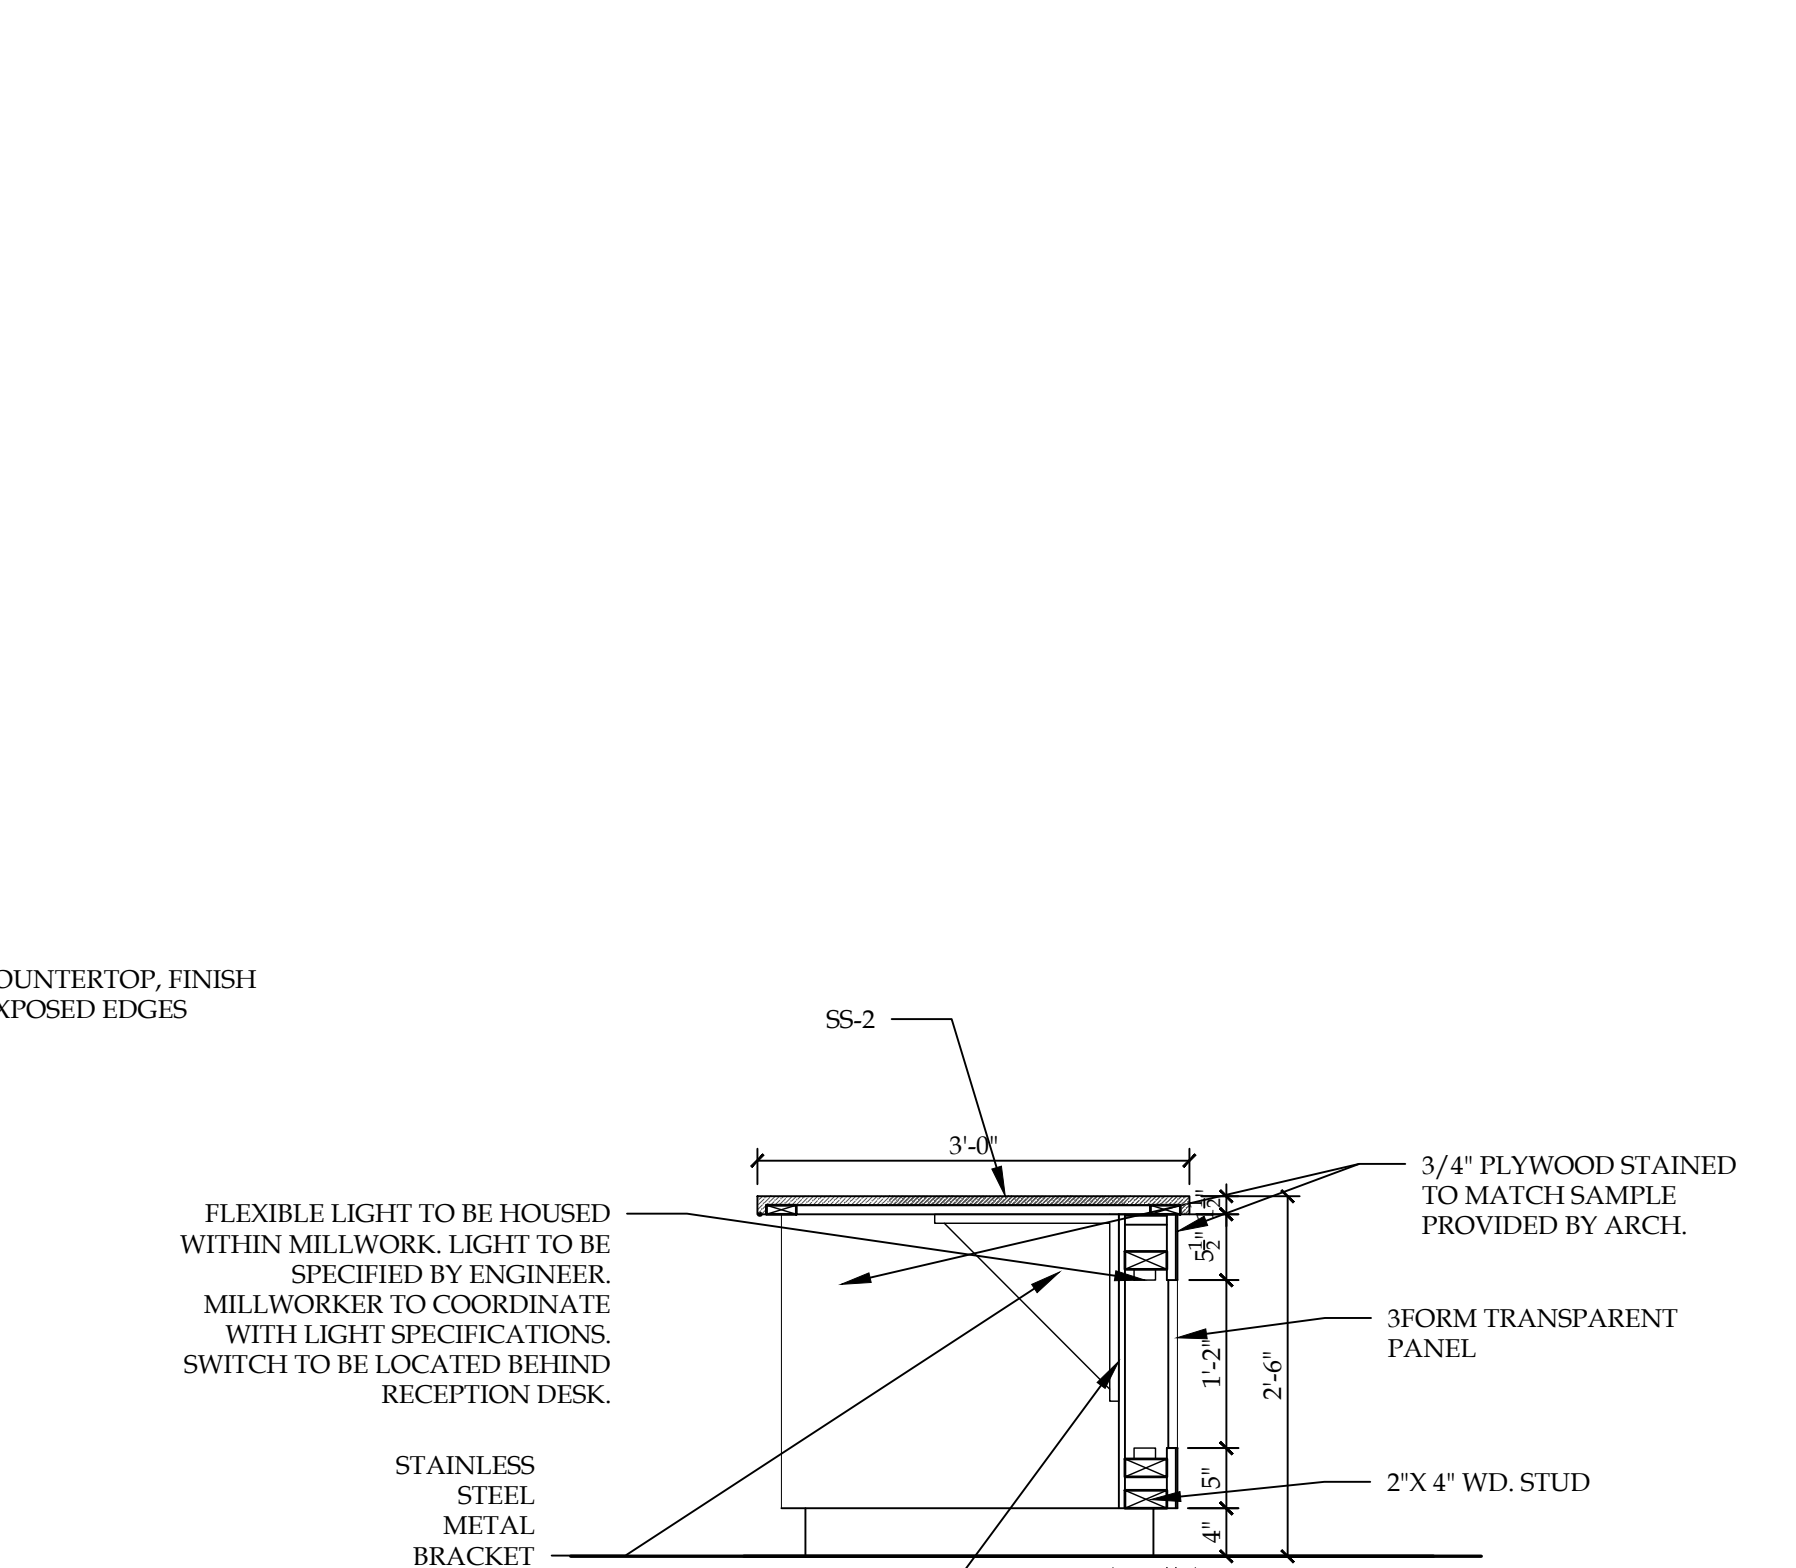

## DOOR AND FRAME SCHEDULE

| DOOR NUM. | ROOM NAME                           | DOORS |           |        |        |       |         |       | FRAMES |      |         |      | FIRE RATING | HARD WARE SET NO. | REMARKS  |
|-----------|-------------------------------------|-------|-----------|--------|--------|-------|---------|-------|--------|------|---------|------|-------------|-------------------|----------|
|           |                                     | TYPE  | DOOR SIZE |        |        | MAT'L | FIN.    | GLASS | MAT'L  | TYPE | DETAILS |      |             |                   |          |
|           |                                     |       | WIDTH     | HEIGHT | THK    |       |         |       |        |      | HEAD    | JAMB |             |                   |          |
| E1        | VESTIBULE 2                         | FG    | PR. 3'-0" | 7'-0"  | 1 1/4" | ALUM. | PREFIN. | IT    | ALUM.  |      | -       | -    | -           | 1.0               | C1/ A602 |
| E2        | VESTIBULE 1                         | FG    | PR. 3'-0" | 7'-0"  | 1 1/4" | ALUM. | PREFIN. | IT    | ALUM.  |      | -       | -    | -           | 1.0               | C1/ A602 |
| 101       | CORRIDOR 1                          | FG    | 3'-0"     | 7'-0"  | 1 1/4" | ALUM. | PREFIN. | T     | ALUM.  | D    | H2      | J2   | -           | 2.0               |          |
| 102       | SKYPE 5                             | NL    | 3'-0"     | 7'-0"  | 1 1/4" | SCWD  | ST.     | T     | H.M.   | A    | H1      | J1   | -           | 3.0               |          |
| 103       | CHEM/BIO LAB                        | NL    | 3'-0"     | 7'-0"  | 1 1/4" | SCWD  | ST.     | T     | H.M.   | A    | H1      | J1   | -           | 4.1               |          |
| 104       | 24 LECTURE, (145)                   | NL    | 3'-0"     | 7'-0"  | 1 1/4" | SCWD  | ST.     | T     | H.M.   | A    | H1      | J1   | -           | 4.0               |          |
| 105       | STORAGE                             | F     | 3'-0"     | 7'-0"  | 1 1/4" | SCWD  | ST.     | -     | H.M.   | A    | H1      | J1   | -           | 5.0               |          |
| 106       | LEARNING COMMONS, (131)             | FG    | PR. 3'-0" | 7'-0"  | 1 1/4" | SCWD  | ST.     | T     | H.M.   | B    | H1      | J1   | -           | 12.1              |          |
| 107       | VESTIBULE                           | FG    | PR. 3'-0" | 7'-0"  | 1 1/4" | ALUM  | PREFIN  | T     | ALUM   | C    | H2      | J2   | -           | 7.0               |          |
| 109       | RECEPTION, (103)                    | FG    | 3'-0"     | 7'-0"  | 1 1/4" | SCWD  | ST.     | T     | H.M.   | A    | H1      | J1   | -           | 8.1               |          |
| 110       | CORRIDOR 2, (104)                   | NL    | 3'-0"     | 7'-0"  | 1 1/4" | SCWD  | ST.     | T     | H.M.   | A    | H1      | J1   | -           | 9.0               |          |
| 111       | SKYPE 4, (124)                      | NL    | 3'-0"     | 7'-0"  | 1 1/4" | SCWD  | ST.     | T     | H.M.   | A    | H1      | J1   | -           | 3.0               |          |
| 112       | SKYPE 3, (123)                      | NL    | 3'-0"     | 7'-0"  | 1 1/4" | SCWD  | ST.     | T     | H.M.   | A    | H1      | J1   | -           | 3.0               |          |
| 113       | RECEPTION, (103)                    | NL    | 3'-0"     | 7'-0"  | 1 1/4" | SCWD  | ST.     | T     | H.M.   | A    | H1      | J1   | -           | 8.0               |          |
| 114       | TESTING, (105)                      | NL    | 3'-0"     | 7'-0"  | 1 1/4" | SCWD  | ST.     | T     | H.M.   | A    | H1      | J1   | -           | 3.0               |          |
| 115       | SKYPE 2, (122)                      | NL    | 3'-0"     | 7'-0"  | 1 1/4" | SCWD  | ST.     | T     | H.M.   | A    | H1      | J1   | -           | 3.0               |          |
| 116       | 24 LECTURE                          | NL    | 3'-0"     | 7'-0"  | 1 1/4" | SCWD  | ST.     | T     | H.M.   | A    | H1      | J1   | -           | 4.0               |          |
| 117       | MANAGER SHARED, (109)               | NL    | 3'-0"     | 7'-0"  | 1 1/4" | SCWD  | ST.     | T     | H.M.   | A    | H1      | J1   | -           | 8.2               |          |
| 118       | DIRECTOR OF ADMISSIONS, (115)       | NL    | 3'-0"     | 7'-0"  | 1 1/4" | SCWD  | ST.     | T     | H.M.   | A    | H1      | J1   | -           | 8.2               |          |
| 119       | MANAGER SHARED, (109)               | NL    | 3'-0"     | 7'-0"  | 1 1/4" | SCWD  | ST.     | T     | H.M.   | A    | H1      | J1   | -           | 8.2               |          |
| 120       | MARKET MANAGER SHARED OFFICE, (110) | NL    | 3'-0"     | 7'-0"  | 1 1/4" | SCWD  | ST.     | T     | H.M.   | A    | H1      | J1   | -           | 8.2               |          |
| 122       | MA DIRECTOR, (121)                  | NL    | 3'-0"     | 7'-0"  | 1 1/4" | SCWD  | ST.     | T     | H.M.   | A    | H1      | J1   | -           | 8.2               |          |
| 124       | FILES, (117)                        | F     | 3'-0"     | 7'-0"  | 1 1/4" | SCWD  | ST.     | -     | H.M.   | A    | H1      | J1   | -           | 5.0               |          |
| 125       | COATS, (120)                        | F     | PR. 2'-0" | 7'-0"  | 1 1/4" | SCWD  | ST.     | -     | H.M.   | A    | H1      | J1   | -           | 10.0              |          |
| 126       | SUPPLIES, (118)                     | F     | PR. 2'-0" | 7'-0"  | 1 1/4" | SCWD  | ST.     | -     | H.M.   | A    | H1      | J1   | -           | 10.0              |          |
| 127       | CORRIDOR 4, (147)                   | NL    | 3'-0"     | 7'-0"  | 1 1/4" | SCWD  | ST.     | T     | H.M.   | A    | H1      | J1   | -           | 9.0               |          |
| 128       | PRIVATE TESTING, (130)              | NL    | 3'-0"     | 7'-0"  | 1 1/4" | SCWD  | ST.     | T     | H.M.   | A    | H1      | J1   | -           | 3.0               |          |
| 129       | OFFICE, (129)                       | NL    | 3'-0"     | 7'-0"  | 1 1/4" | SCWD  | ST.     | T     | H.M.   | A    | H1      | J1   | -           | 8.2               |          |
| 131       | LEARNING COMMONS LOUNGE, (128)      | FG    | 3'-0"     | 7'-0"  | 1 1/4" | SCWD  | ST.     | T     | H.M.   | A    | H1      | J1   | -           | 12.0              |          |
| 132       | UTILITY, (135)                      | F     | 3'-0"     | 7'-0"  | 1 1/4" | SCWD  | ST.     | -     | H.M.   | A    | H1      | J1   | -           | 5.0               |          |

### GENERAL NOTES

1. ALL DOORS & FRAMES TO INCLUDE ALL NECESSARY HARDWARE & ACCESSORIES FOR INSTALLATION & OPERATION. REFER TO MANUFACTURER'S WRITTEN INSTRUCTIONS.
2. HOLLOW METAL DOOR FRAMES TO MATCH DEPTH OF EXISTING WALL, (V.I.F.).
3. ALL FRAMES AT EXTERIOR DOORS TO BE FULLY CAULKED BOTH SIDES AT INTERFACE WITH DISSIMILAR MATERIALS.
4. ALL ALUMINUM STOREFRONT DOORS TO BE INSULATED NARROW STYLE. PROVIDE CYLINDERS PER HARDWARE SCHEDULE. ALL GLASS TO BE TEMPERED GLASS.
5. ALL DOORS 1-3/4" THICK UNLESS OTHERWISE NOTED.
6. ALL DOOR FRAME ANCHORS TO BE OF MANUFACTURER'S STANDARD WITH TYPE PER FRAME AND OPENING CONDITIONS UNLESS NOTED OTHERWISE.
7. ALL EXIT DOORS SHALL BE EQUIPPED WITH PANIC HARDWARE
8. HEIGHT OF DOOR THRESHOLDS SHALL NOT EXCEED 1/2" ABOVE FINISHED FLOOR.
9. ALL GLAZING SCHEDULED TO BE INSTALLED IN FIRE RATED DOORS SHALL BE WIRE GLASS UNLESS NOTED OTHERWISE.
10. ALL DOOR HARDWARE MATERIAL & FUNCTION TO BE COORDINATED WITH ARCHITECT.
11. KEYING SCHEDULE TO BE DIRECTLY COORDINATED WITH OWNER. HARDWARE SUPPLIER TO PROVIDE KEY CABINET WITH CAPACITY TO STORE ONE SPARE KEY FOR EACH LOCKING DEVICE AND MASTER KEYS.
12. COORDINATE AND FIELD VERIFY ALL ROUGH OPENINGS & FRAMING PRIOR TO UNIT FABRICATION OR INSTALLATION.
13. MANUFACTURER SHALL ENGINEER ALL FRAME AND GLAZING ASSEMBLIES FOR ALL LOADS ACCORDING TO REQUIREMENTS OF ALL BUILDING CODES.
14. ALL FRAME ANCHORS TO BE OF MANUFACTURER'S STANDARD WITH TYPE PER FRAME AND OPENING CONDITIONS UNLESS NOTED OTHERWISE.

### ABBREVIATIONS:

ALUM- ALUMINUM  
 FAC- FACTORY FINISH  
 GL- GLASS  
 HM- HOLLOW METAL  
 SCWD- SOLID CORE WOOD  
 ST - STAIN & CLEAR FIN.  
 PT - PAINT  
 PREFIN- PRE-FINISHED  
 I- 1" INSUL. GLAZING  
 IT - 1" INSUL. TEMPERED GLAZING  
 T- 1/2" TEMPERED GLAZING  
 T2 - 3/4" TEMPERED GLAZING  
 W- WIRE GLASS

W.O.D. - WIDTH OF DOOR  
 H.O.D. - HEIGHT OF DOOR

### \* NOTE:

G.C. SHALL COORDINATE WITH OWNER - THE SALVAGE & RE-USE OF ALL EXISTING DOORS, FRAMES & DOOR HARDWARE TO THE EXTENT POSSIBLE FOR NEW LAYOUT. CONFIRM EXISTING FIRE RATINGS AS REQUIRED PER APPLICATION.

### DOOR SCHEDULE NOTES:

1. PROVIDE SOLID BLOCKING AT ALL DOORS FOR WALL BUMPERS.
2. COORDINATE KEYING SYSTEM WITH OWNER.
3. ANY HARDWARE ITEM NOT SPECIFICALLY CALLED OUT, BUT REQUIRED TO MAKE ANY ASSEMBLY OPERATIONAL, SHALL BE INCLUDED BY THE HARDWARE SUPPLIER AND CONSTRUCTION MANAGER.
4. ALL HOLLOW METAL DOORS AND FRAMES SHALL BE SUPPLIED SHOP PRIMED AND FIELD PAINTED PER FINISH SCHEDULE.
5. PROVIDE SILENCERS AND BUMPERS ON ALL OPENINGS.
6. CONTRACTOR SHALL COORDINATE ANY SPECIALTY DOORS, FRAMES AND/OR HARDWARE REQUIREMENTS WITH OWNER IN FIELD PRIOR TO CONSTRUCTION.

|     |                                |    |           |       |        |      |     |   |      |   |    |    |   |      |  |
|-----|--------------------------------|----|-----------|-------|--------|------|-----|---|------|---|----|----|---|------|--|
| 133 | 20 LECTURE, (138)              | NL | 3'-0"     | 7'-0" | 1 1/4" | SCWD | ST. | T | H.M. | A | H1 | J1 | - | 4.0  |  |
| 134 | 24 PC LAB, (139)               | NL | 3'-0"     | 7'-0" | 1 1/4" | SCWD | ST. | T | H.M. | A | H1 | J1 | - | 4.0  |  |
| 135 | WOMEN'S RESTROOM, (142)        | F  | 3'-0"     | 7'-0" | 1 1/4" | SCWD | ST. | - | H.M. | A | H1 | J1 | - | 12.0 |  |
| 136 | MEN'S RESTROOM, (141)          | F  | 3'-0"     | 7'-0" | 1 1/4" | SCWD | ST. | - | H.M. | A | H1 | J1 | - | 12.0 |  |
| 137 | JANITOR CL., (125)             | F  | 3'-0"     | 7'-0" | 1 1/4" | SCWD | ST. | - | H.M. | A | H1 | J1 | - | 5.0  |  |
| 138 | 24 PC LAB/LECTURE, (145)       | NL | 3'-0"     | 7'-0" | 1 1/4" | SCWD | ST. | T | H.M. | A | H1 | J1 | - | 4.0  |  |
| 139 | 24 PC LAB/LECTURE, (145)       | NL | 3'-0"     | 7'-0" | 1 1/4" | SCWD | ST. | T | H.M. | A | H1 | J1 | - | 4.0  |  |
| 140 | ELECTRICAL                     | F  | 3'-0"     | 7'-0" | 1 1/4" | SCWD | ST. | - | H.M. | A | H1 | J1 | - | 5.0  |  |
| 141 | CORRIDOR 5, (147)              | NL | 3'-0"     | 7'-0" | 1 1/4" | SCWD | ST. | T | H.M. | A | H1 | J1 | - | 9.0  |  |
| 145 | FACULTY SKYPE, (111)           | NL | 3'-0"     | 7'-0" | 1 1/4" | SCWD | ST. | T | H.M. | A | H1 | J1 | - | 3.0  |  |
| 146 | FACULTY ROOM, (113)            | NL | 3'-0"     | 7'-0" | 1 1/4" | SCWD | ST. | T | H.M. | A | H1 | J1 | - | 8.1  |  |
| 147 | STUDENT EVALUATION ROOM, (114) | NL | 3'-0"     | 7'-0" | 1 1/4" | SCWD | ST. | T | H.M. | A | H1 | J1 | - | 3.0  |  |
| 148 | CONFERENCE ROOM, (115)         | NL | 3'-0"     | 7'-0" | 1 1/4" | SCWD | ST. | T | H.M. | A | H1 | J1 | - | 11.0 |  |
| 149 | STORAGE                        | F  | PR. 1'-6" | 7'-0" | 1 1/4" | SCWD | ST. | - | H.M. | A | H1 | J1 | - | 10.0 |  |
| 150 | STORAGE                        | F  | PR. 1'-6" | 7'-0" | 1 1/4" | SCWD | ST. | - | H.M. | A | H1 | J1 | - | 10.0 |  |
| 151 | STORAGE, (112)                 | F  | 3'-0"     | 7'-0" | 1 1/4" | SCWD | ST. | - | H.M. | A | H1 | J1 | - | 5.0  |  |
| 152 | OPEN LOUNGE SPACE, (136)       | NL | 3'-0"     | 7'-0" | 1 1/4" | SCWD | ST. | T | H.M. | D | H1 | J1 | - | 2.1  |  |
| 153 | RPZ                            | F  | 3'-0"     | 7'-0" | 1 1/4" | SCWD | ST. | - | H.M. | A | H1 | J1 | - | 5.0  |  |
| 154 | MA                             | NL | 3'-0"     | 7'-0" | 1 1/4" | SCWD | ST. | T | H.M. | A | H1 | J1 | - | 9.1  |  |
| 155 | NURSING/MA                     | F  | 3'-0"     | 7'-0" | 1 1/4" | SCWD | ST. | T | H.M. | A | H1 | J1 | - | 9.1  |  |
| 156 | NURSING                        | NL | 3'-0"     | 7'-0" | 1 1/4" | SCWD | ST. | T | H.M. | A | H1 | J1 | - | 9.1  |  |
| 157 | STORAGE                        | F  | 3'-0"     | 7'-0" | 1 1/4" | SCWD | ST. | - | H.M. | A | H1 | J1 | - | 5.0  |  |

### REVISION RECORD

| NO. | DATE       | REMARKS    |
|-----|------------|------------|
| #   | 00.00.0000 | ADDENDUM # |

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**Bryant and Stratton  
College**

**BRYANT & STRATTON  
COLLEGE**

1320 Warwick Way  
Mt. Pleasant, WI 53406

SEAL:

**DOOR  
SCHEDULE,  
DETAILS &  
NOTES**

**GREGORY A. TOMSIC  
REGISTERED ARCHITECT**

145 BATHURST DR., TONAWANDA, N.Y. 14150  
716-435-0617

|                       |                          |
|-----------------------|--------------------------|
| SCALE<br>1/8" = 1'-0" | JOB NO.                  |
| DRAWN                 | DWG. NO.<br><b>A-601</b> |
| CHECKED               |                          |
| DATE<br>12.22.2017    | CONTRACT NO.             |

| REVISION RECORD |            |             |
|-----------------|------------|-------------|
| NO.             | DATE       | REMARKS     |
| #1              | 01.03.2018 | ADDENDUM #1 |

IT IS A VIOLATION OF STATE LAW FOR ANY PERSON, UNLESS ACTING UNDER THE DIRECTION OF A NEW YORK STATE ARCHITECT OR ENGINEER, TO ALTER ANY ITEM ON THIS DOCUMENT IN ANY WAY. IF ANY ITEM ON THIS DOCUMENT IS ALTERED, THE ALTERING ARCHITECT OR ENGINEER SHALL AFFIX TO HIS/HER SEAL AND THE NOTATION "ALTERED" FOLLOWED BY HIS SIGNATURE, THE DATE OF SUCH ALTERATION AND A SPECIFIC DESCRIPTION OF SUCH ALTERATION.



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1320 Warwick Way  
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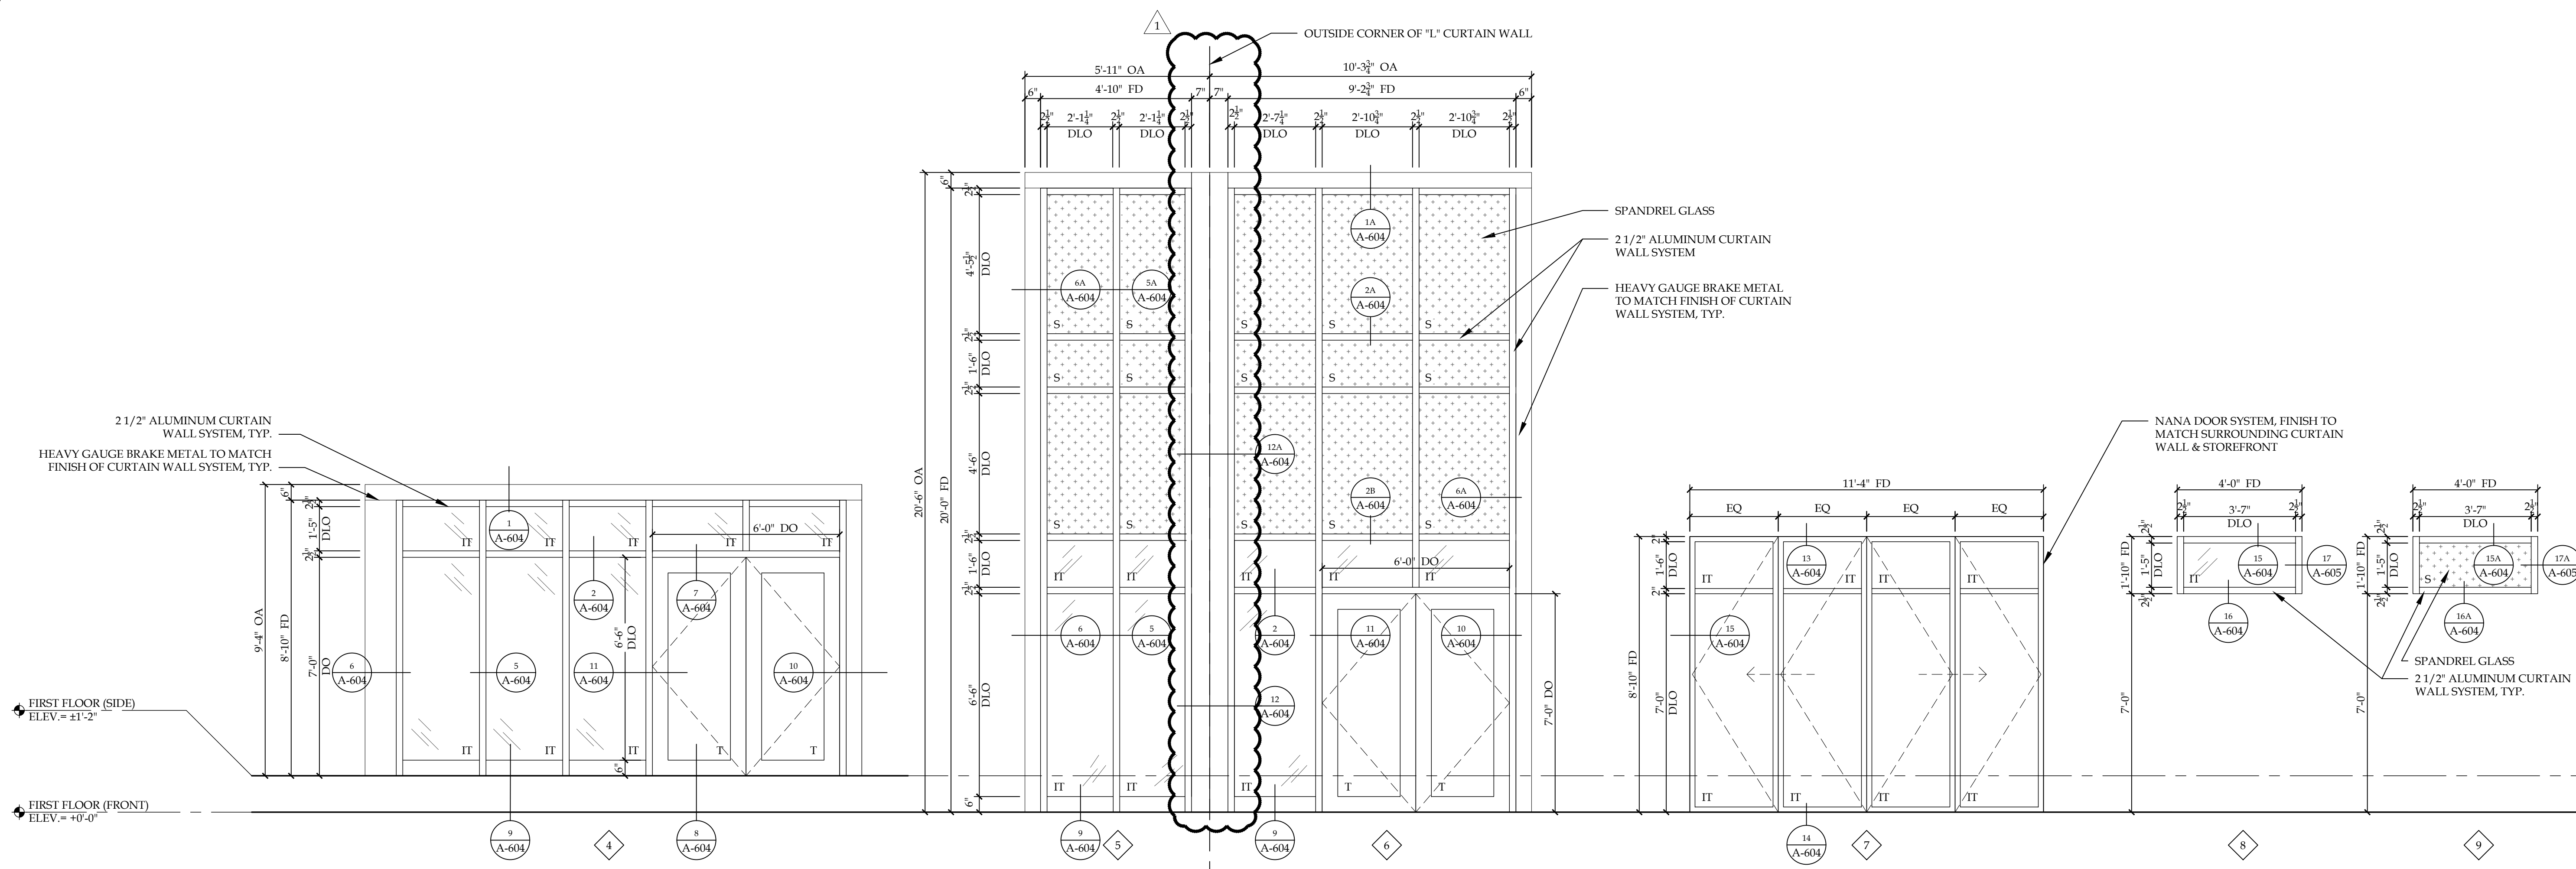
SEAL:

**GLAZING & DOOR/ FRAME DETAILS**





**GREGORY A. TOMSIC**  
REGISTERED ARCHITECT

145 BATHURST DR., TONAWANDA, N.Y. 14150  
716-435-0617

|                       |                          |
|-----------------------|--------------------------|
| SCALE<br>1/8" = 1'-0" | JOB NO.                  |
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| CHECKED               | CONTRACT NO.             |
| DATE<br>12.22.2017    |                          |




**C1 CURTAIN WALL ELEVATIONS**  
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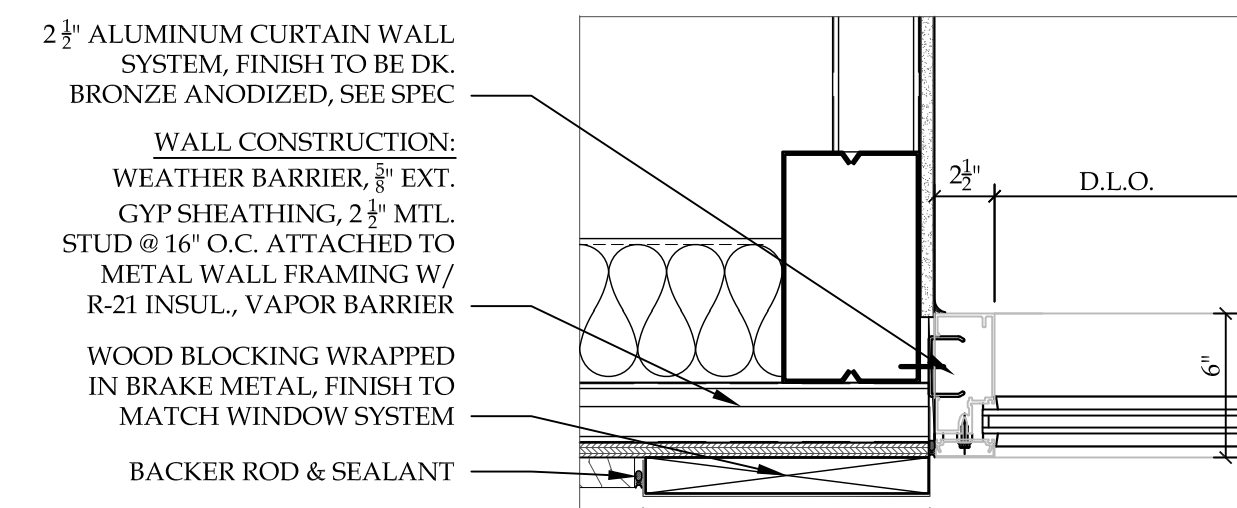


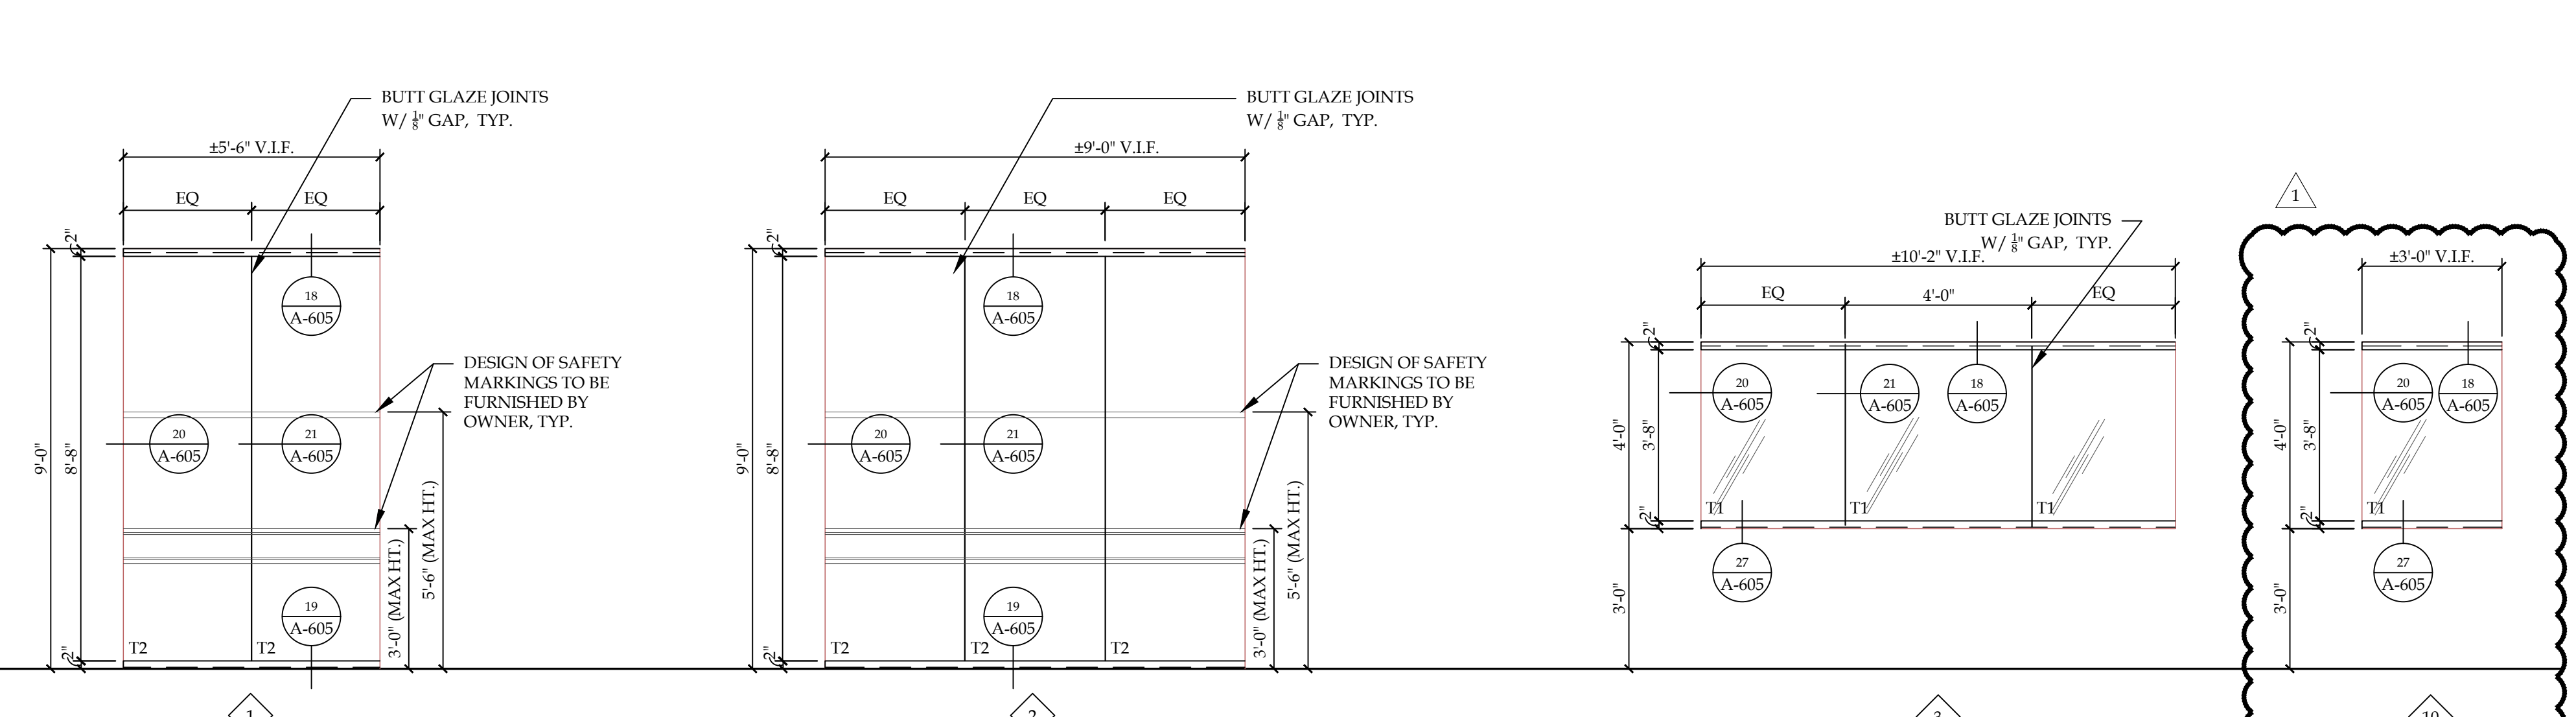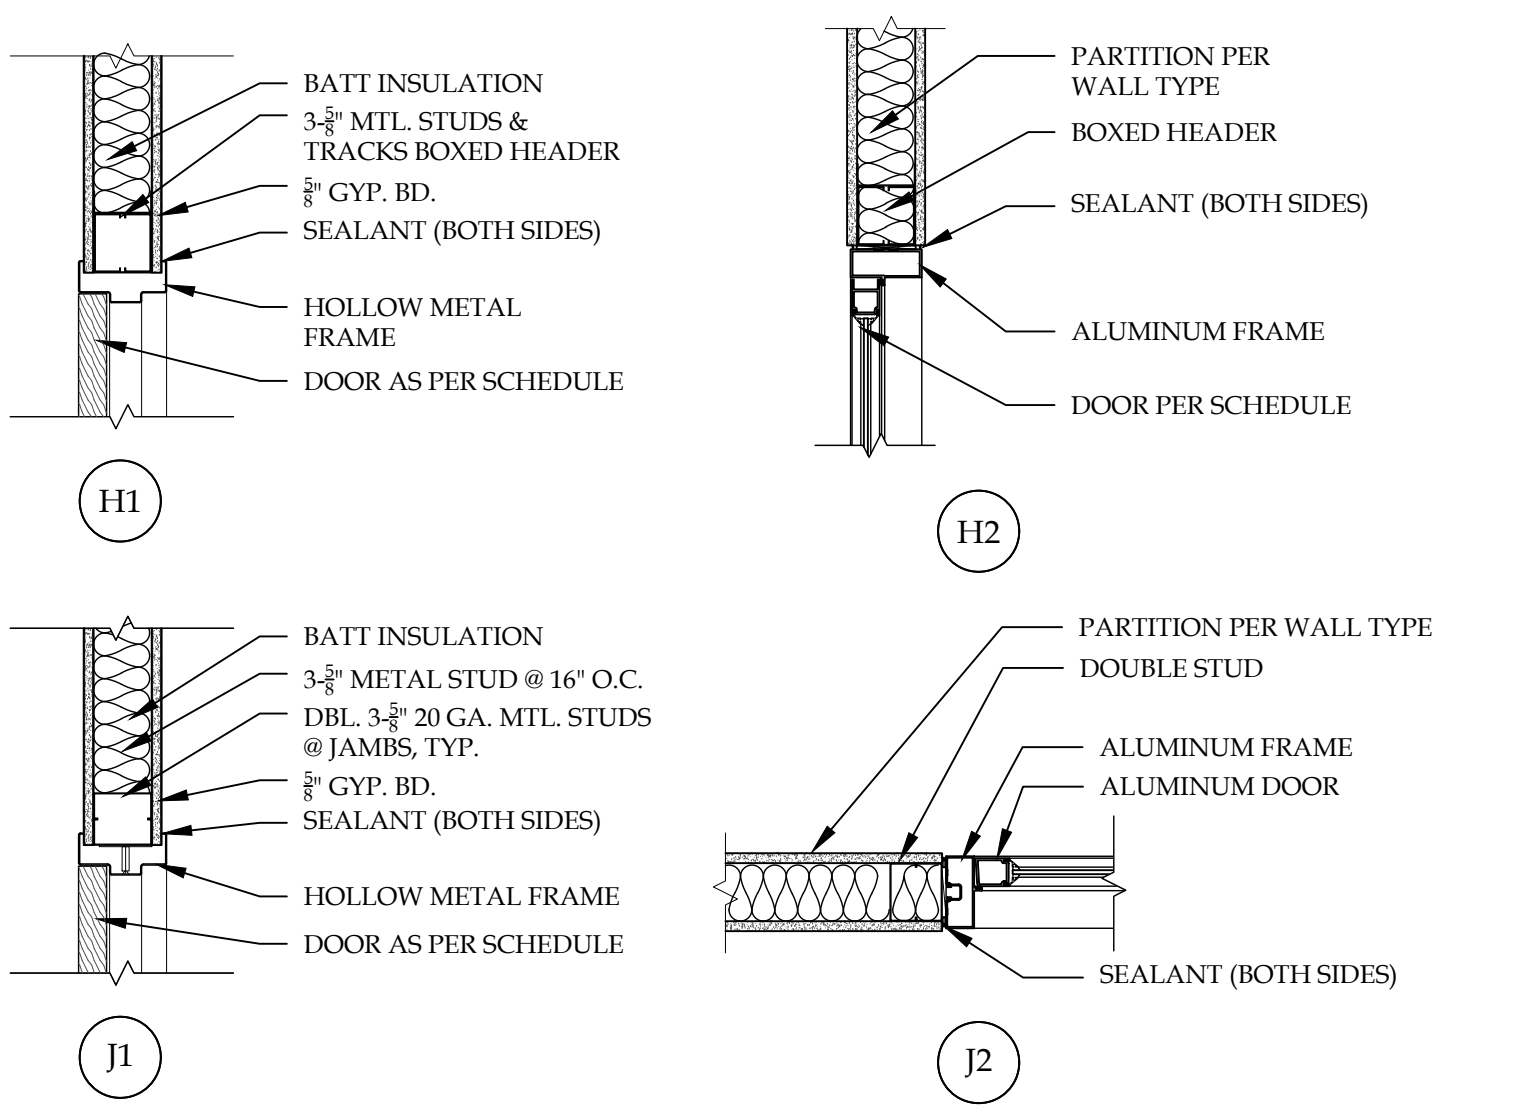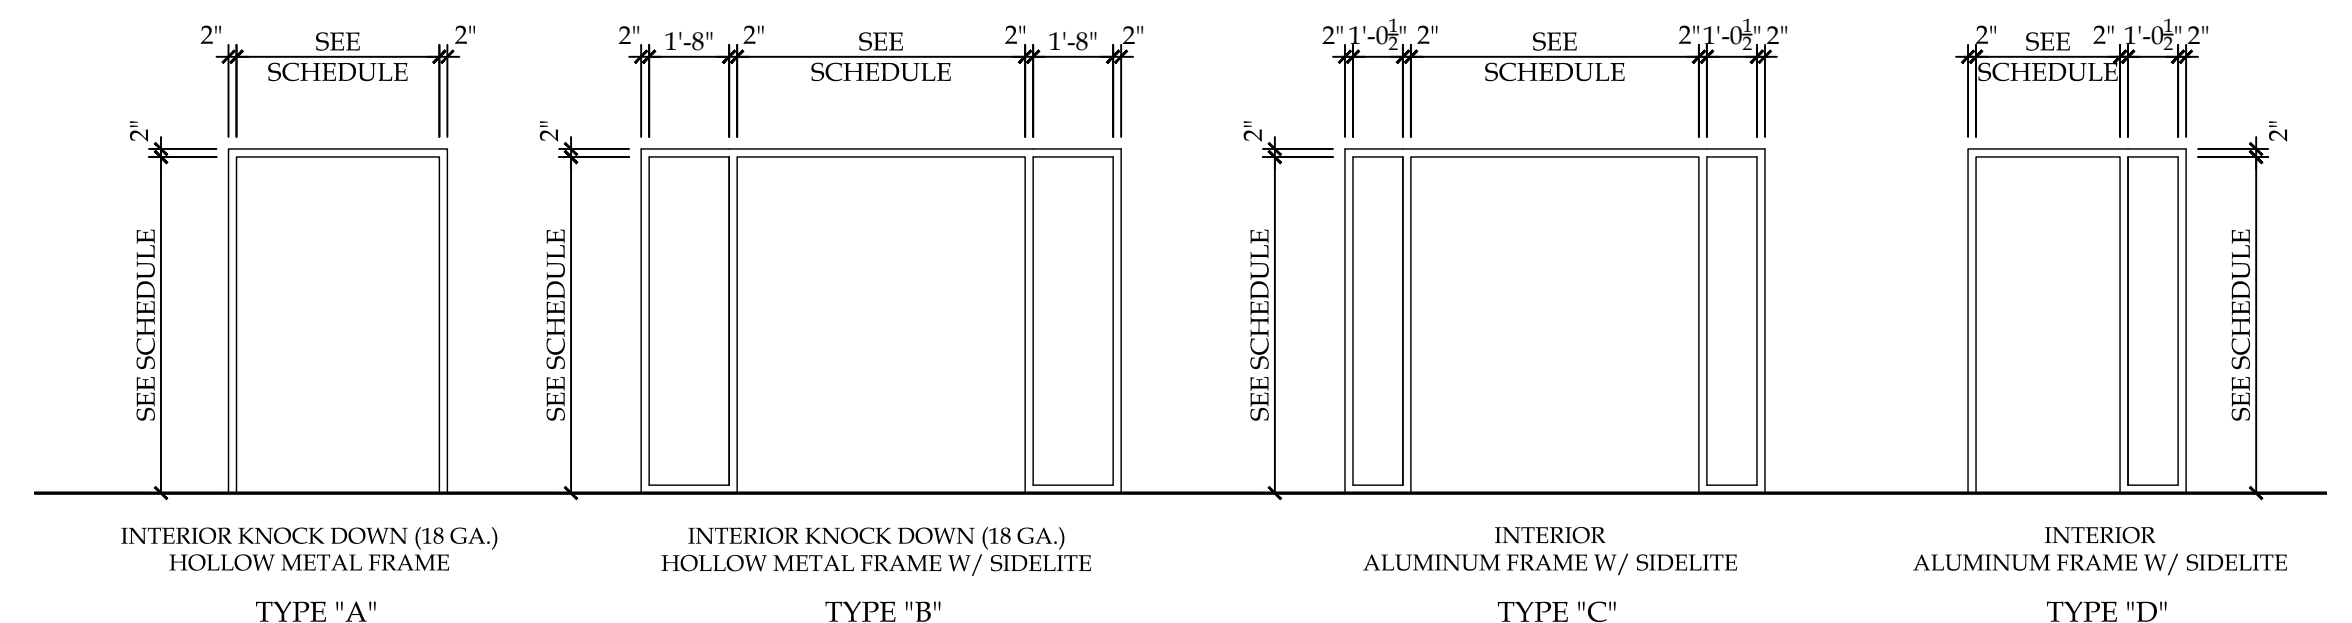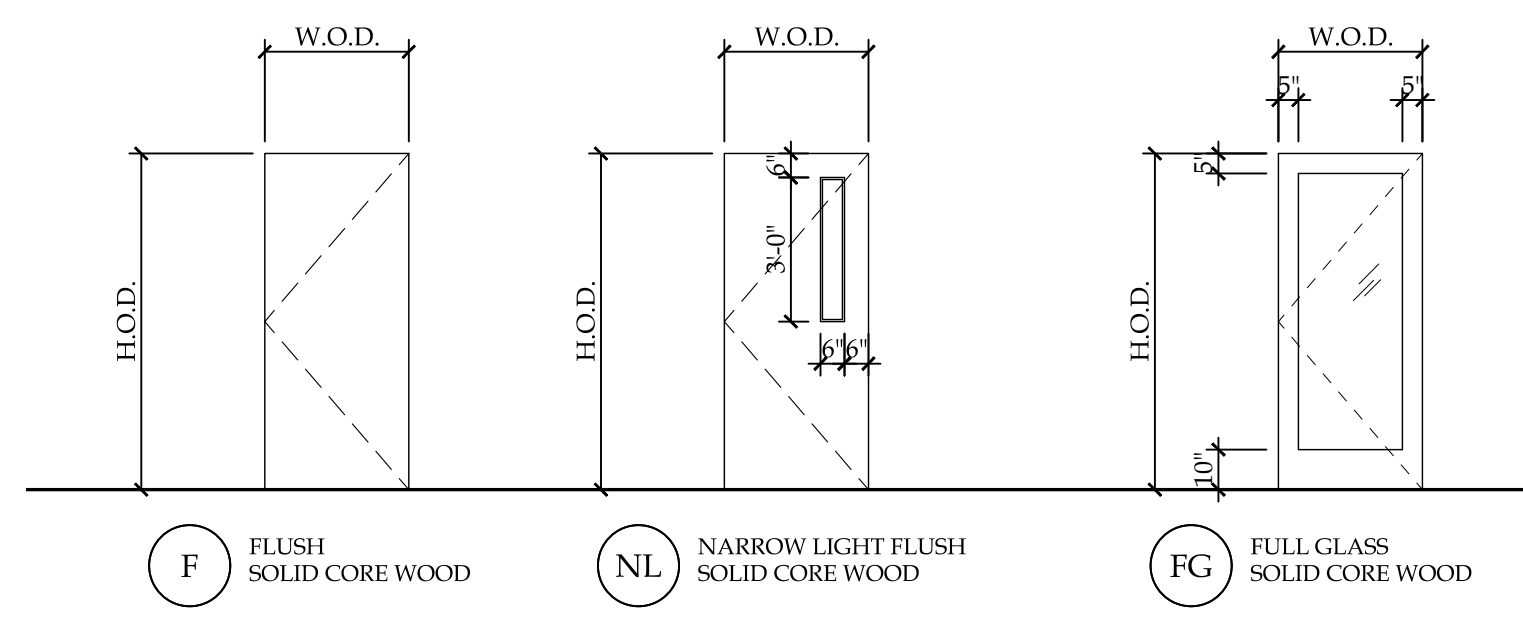


NOTE: ALL EXISTING INSULATION & CORRUGATED METAL SIDING TO REMAIN

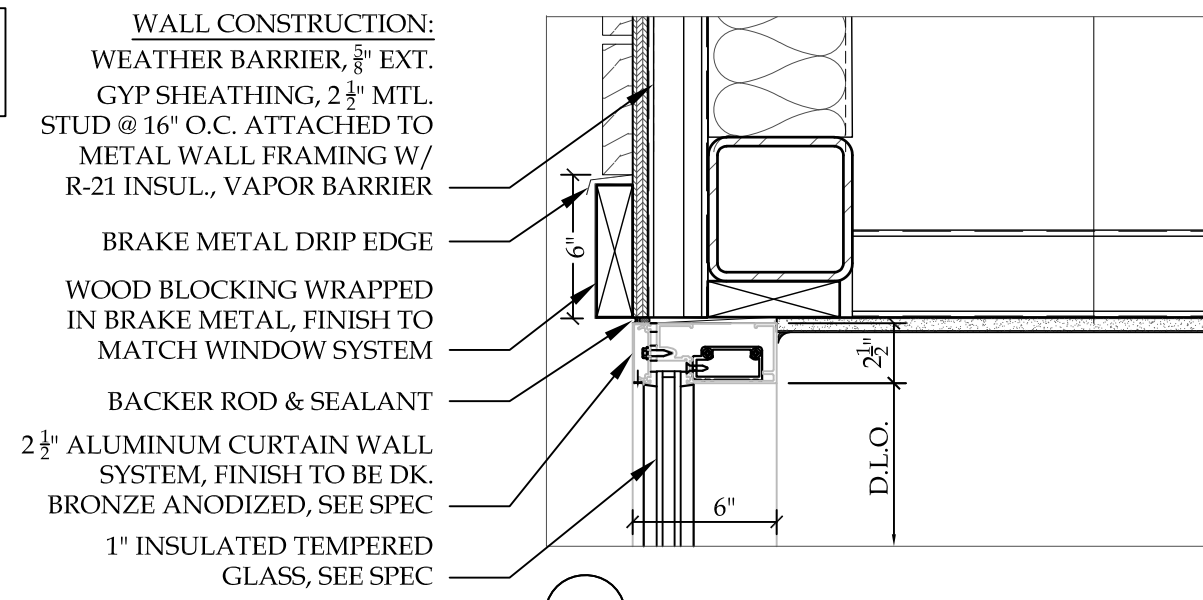


1 HEAD @ CURTAIN WALL




4 JAMB @ CURTAIN WALL (CANOPY SUPPORT)

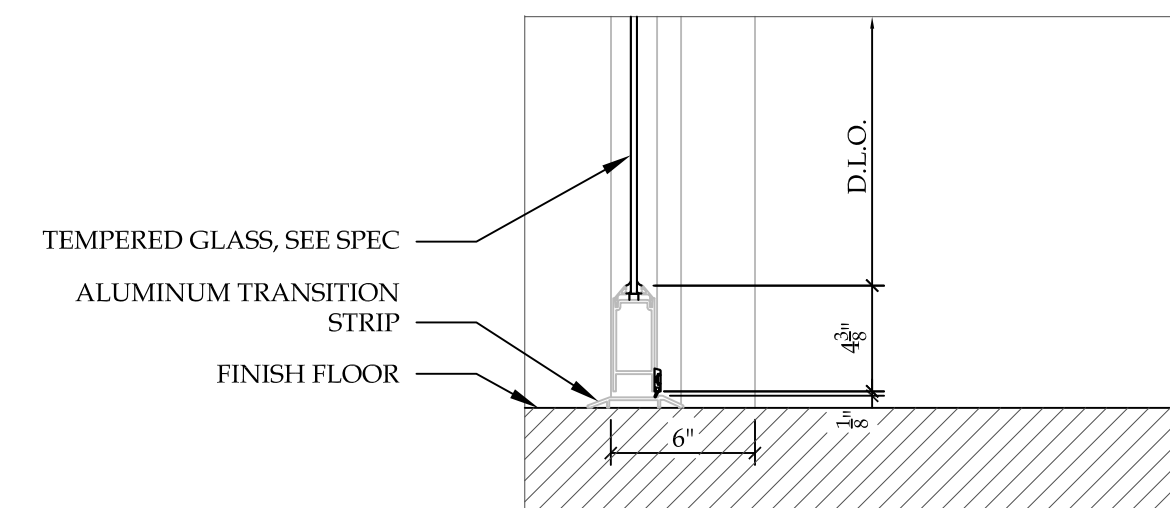


8 DOOR SILL @ CURTAIN WALL

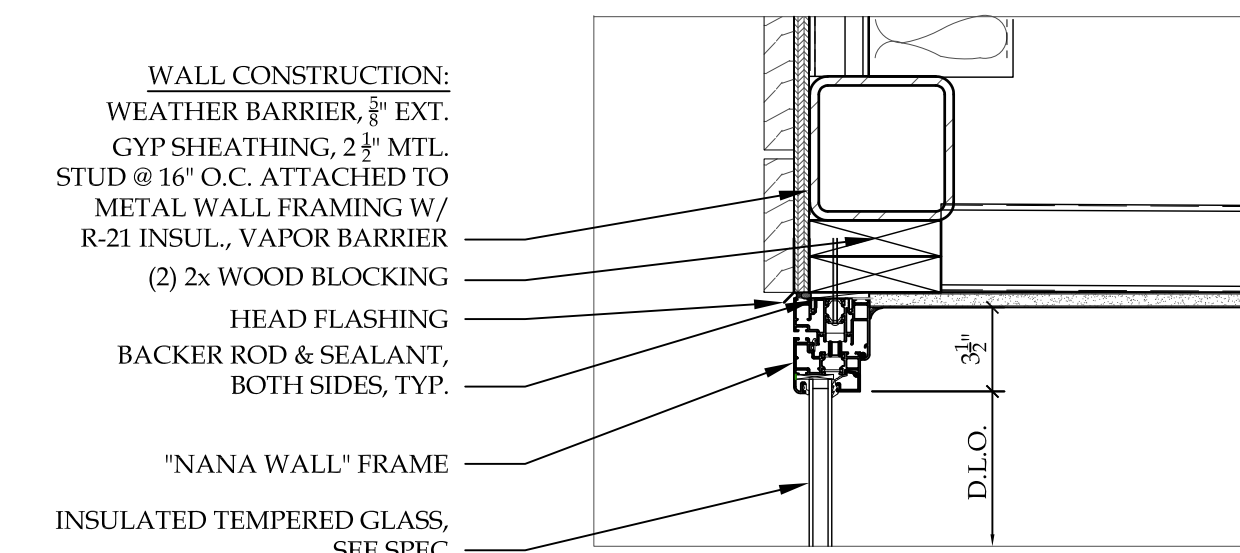


13 \"NANA\" DOOR HEAD

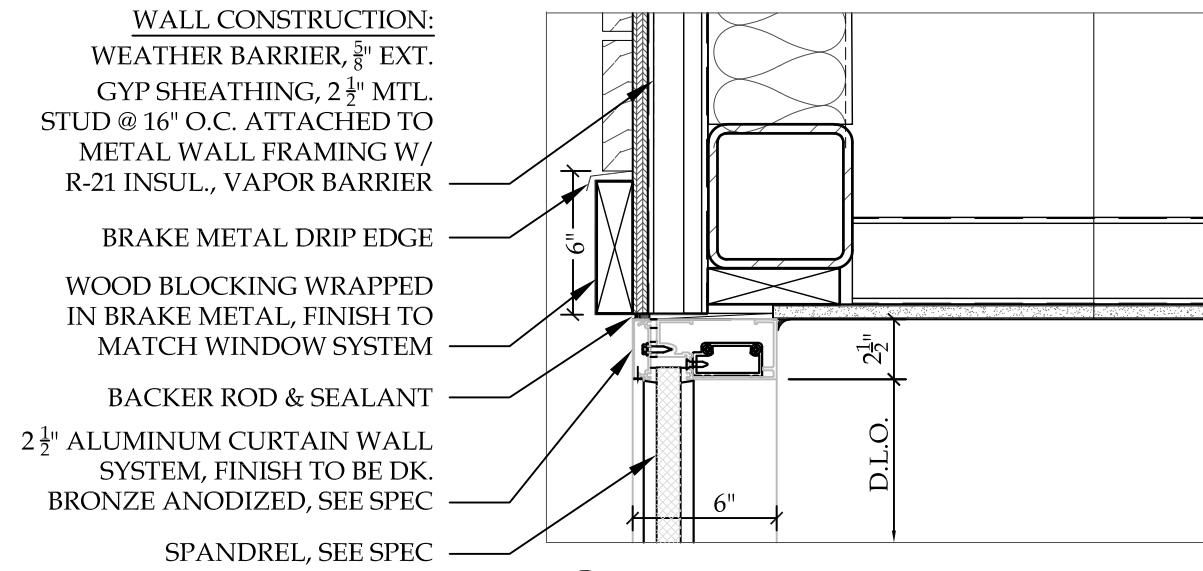


1A HEAD @ CURTAIN WALL (SPANDREL)

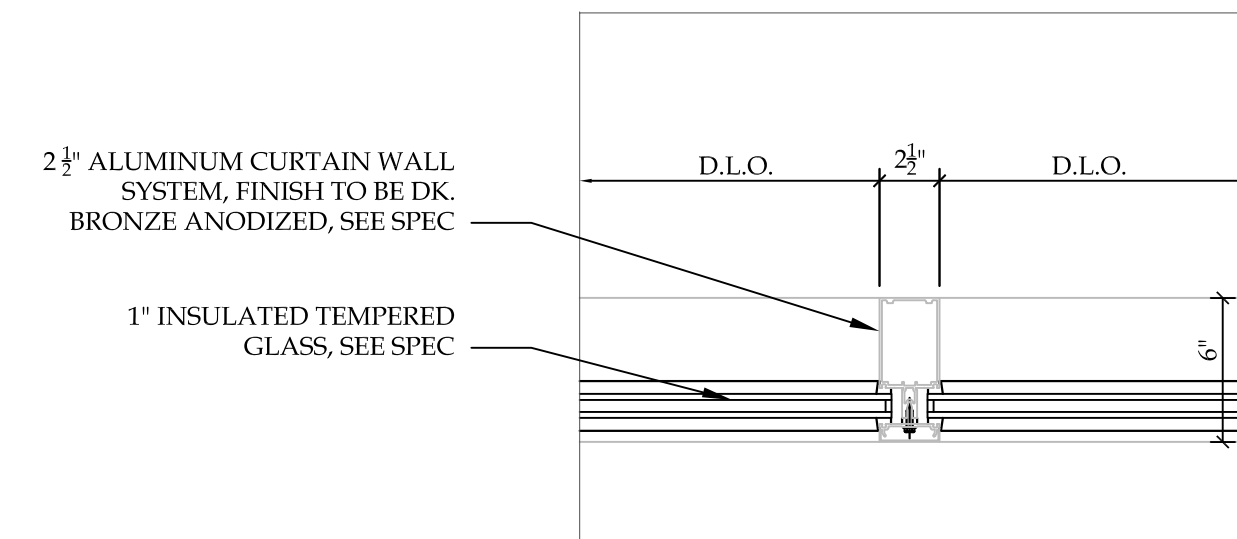


5 VERTICAL MULLION

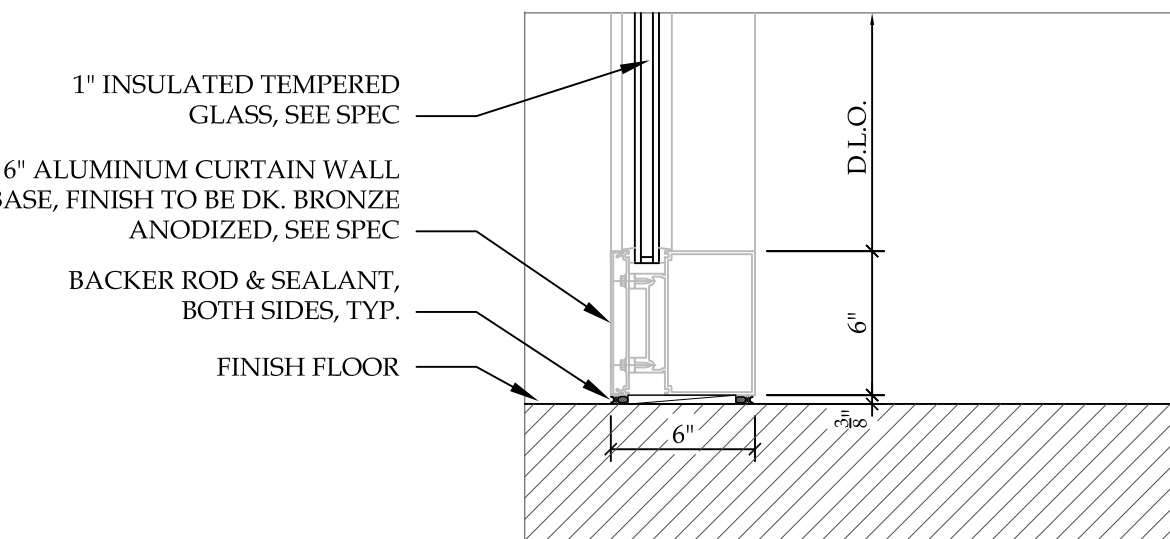


9 SILL BASE @ CURTAIN WALL

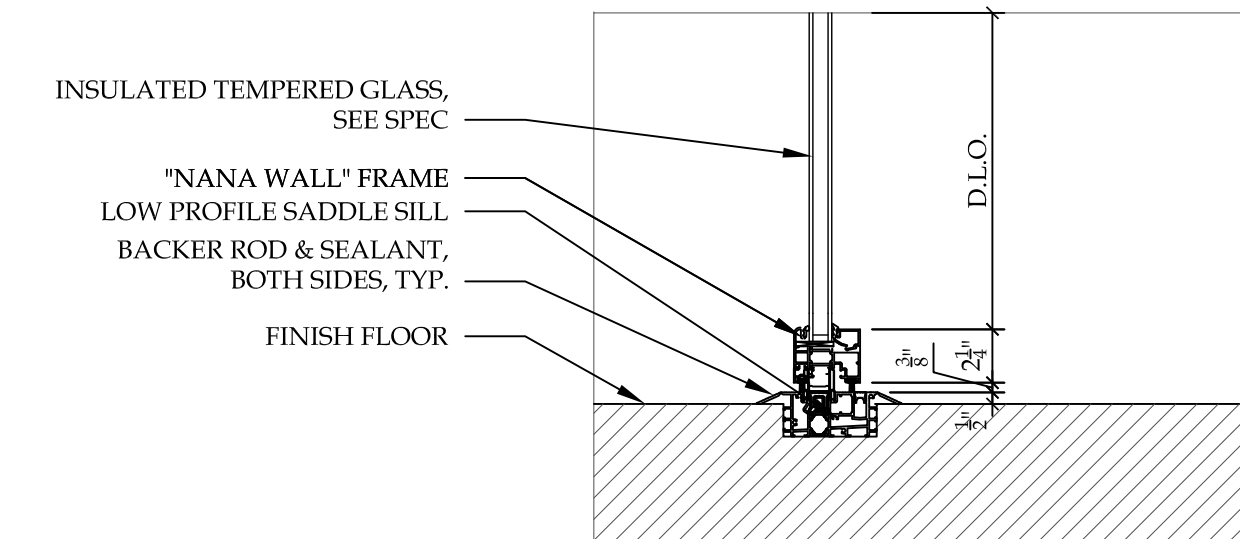


14 \"NANA\" DOOR SILL

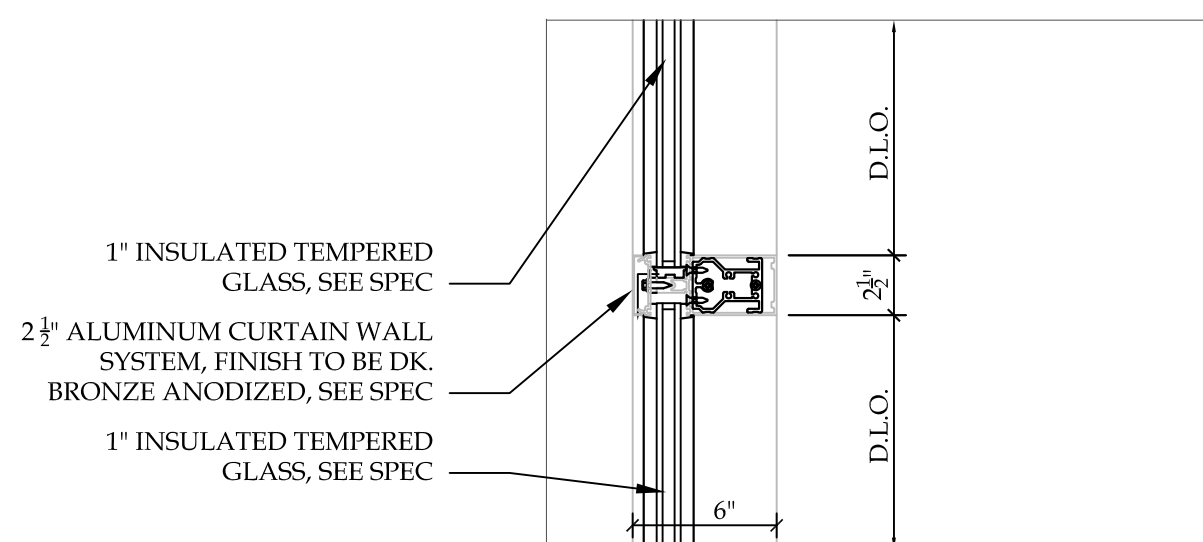


2 HORIZONTAL MULLION

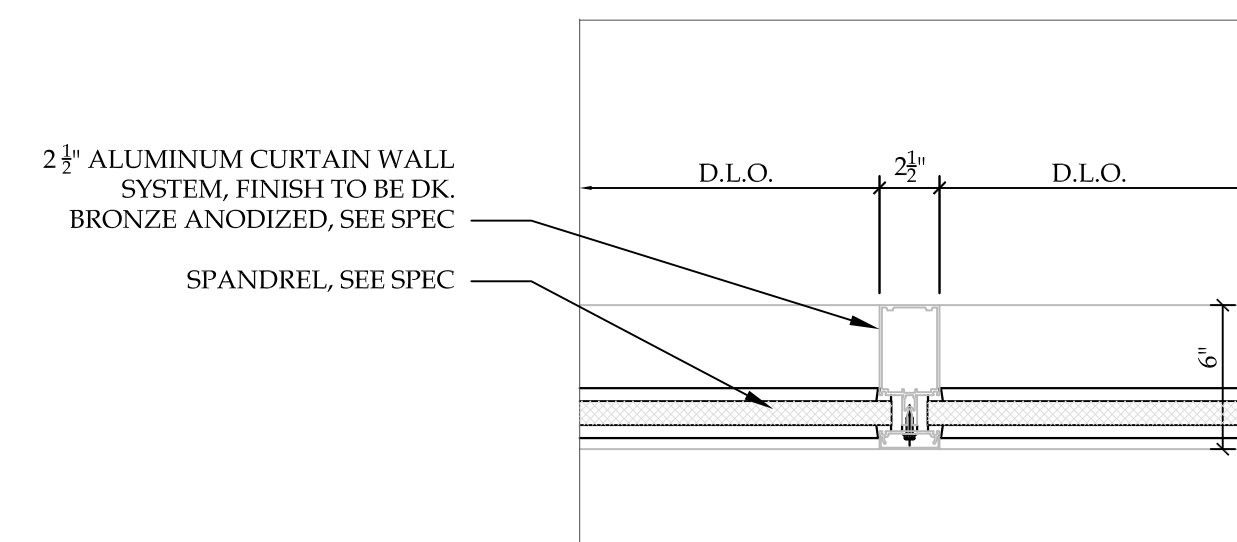


5A VERTICAL MULLION (SPANDREL)

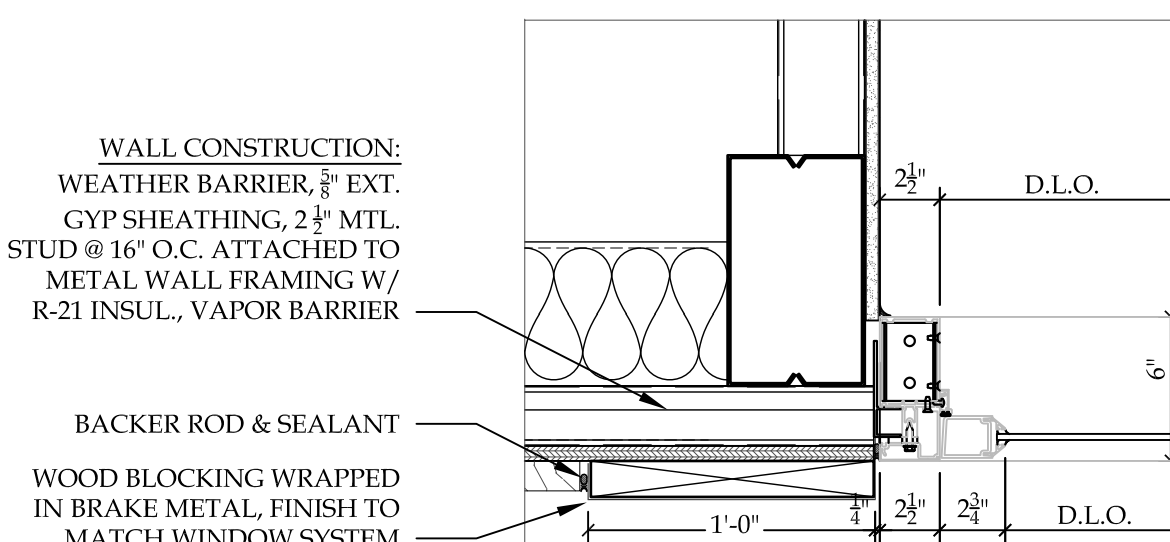


10 DOOR JAMB @ CURTAIN WALL (CANOPY SUPPORT)

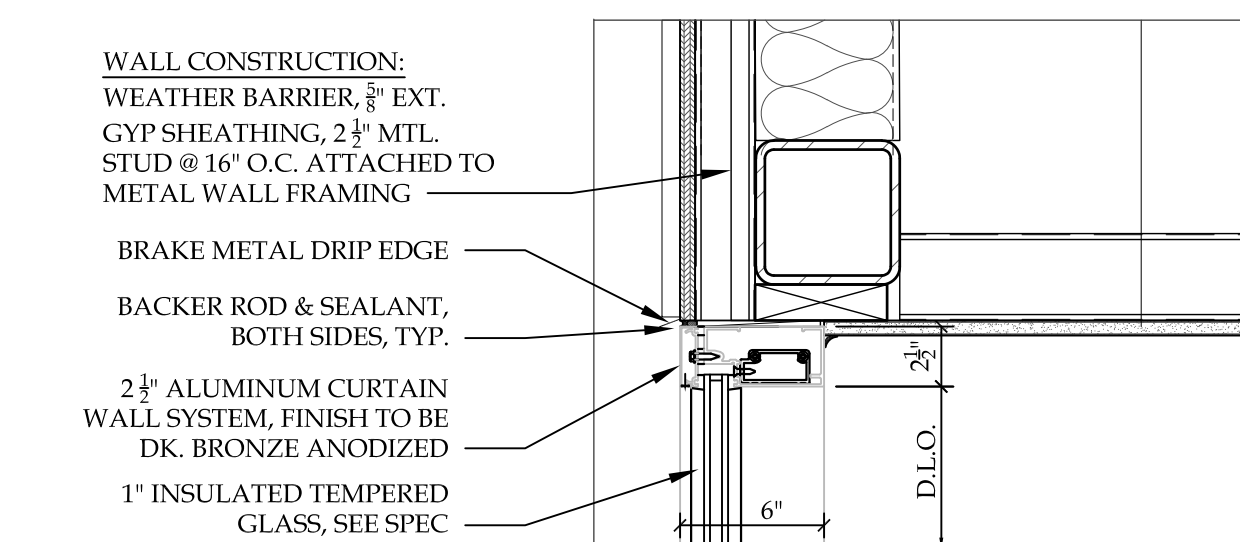


15 HEAD @ CURTAIN WALL

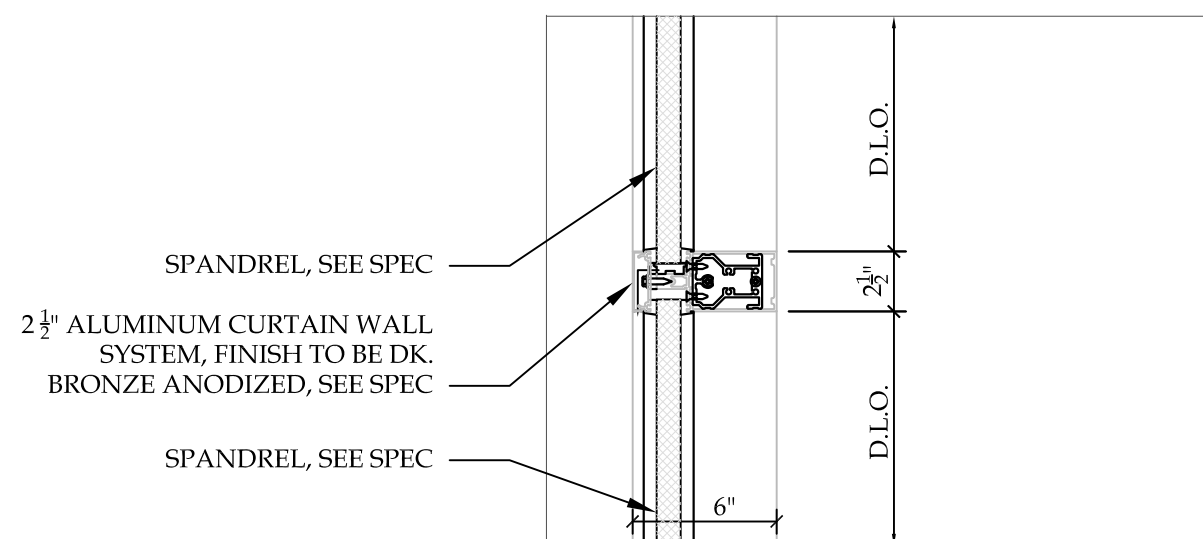


2A HORIZONTAL MULLION (SPANDREL)

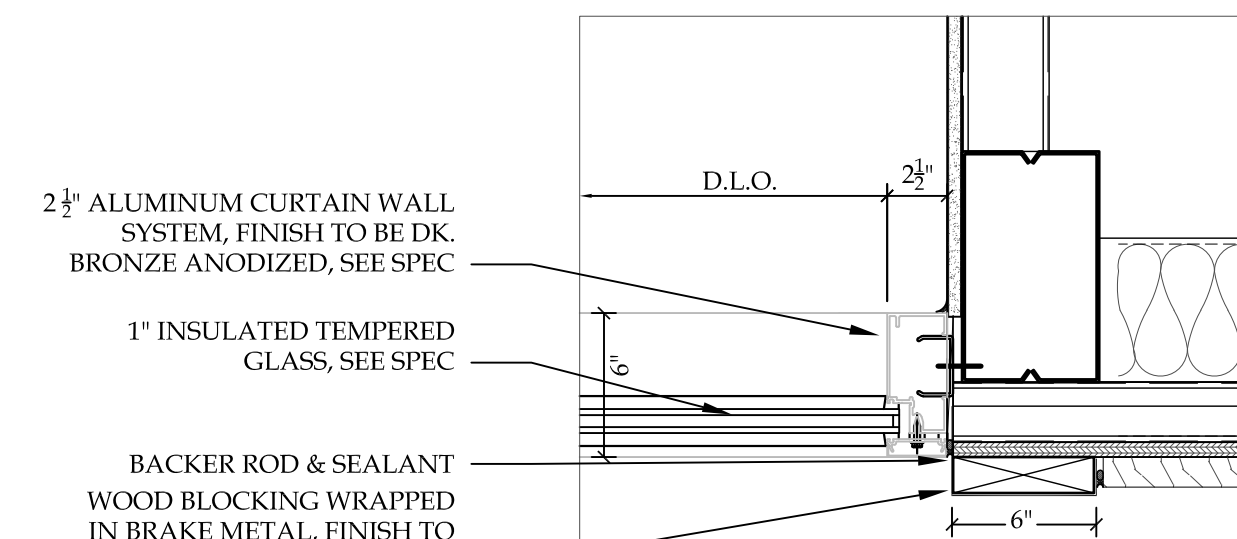


6 JAMB @ CURTAIN WALL

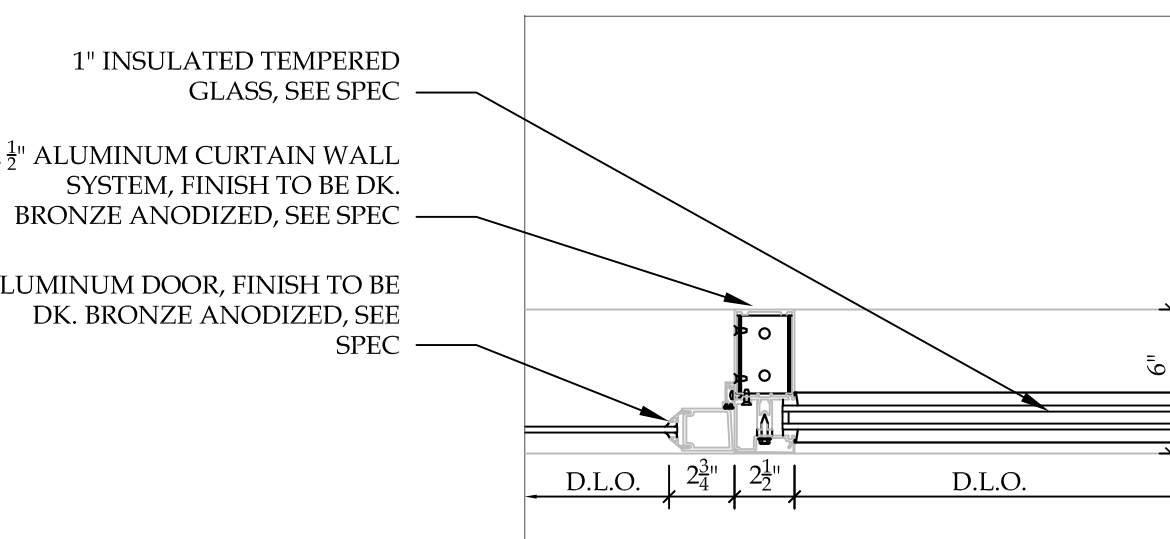


11 VERTICAL MULLION @ DOOR JAMB

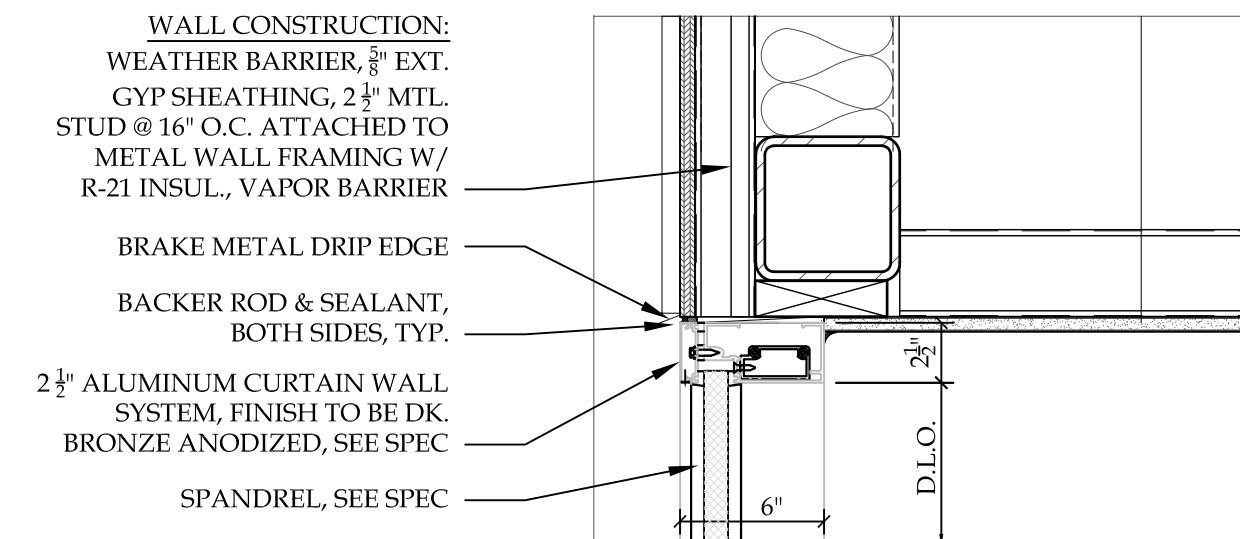


15A HEAD @ CURTAIN WALL (SPANDREL)

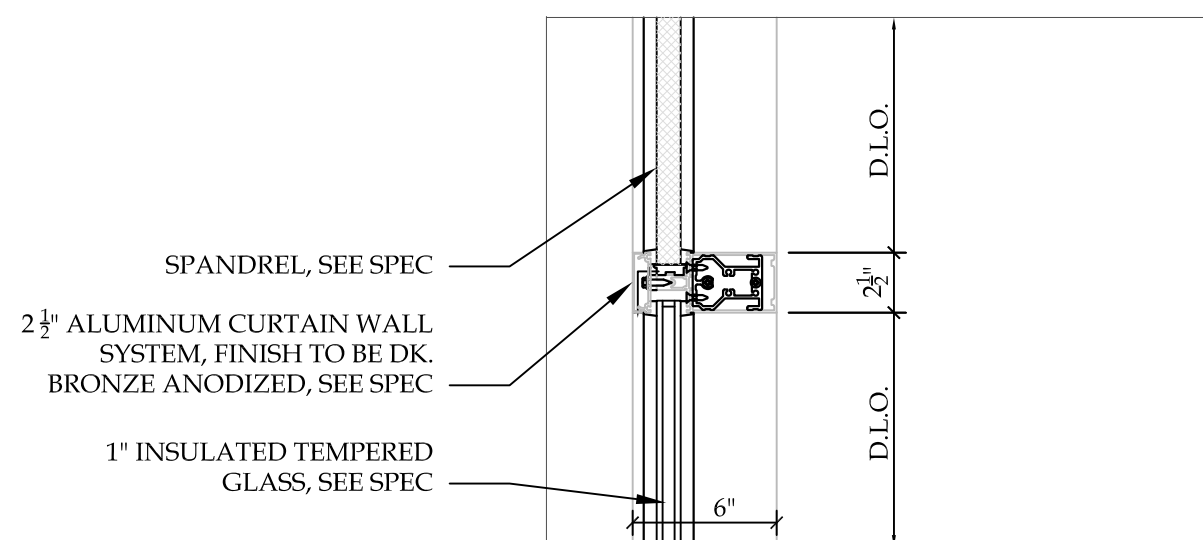


2B HORIZONTAL MULLION (SPANDREL/IG)

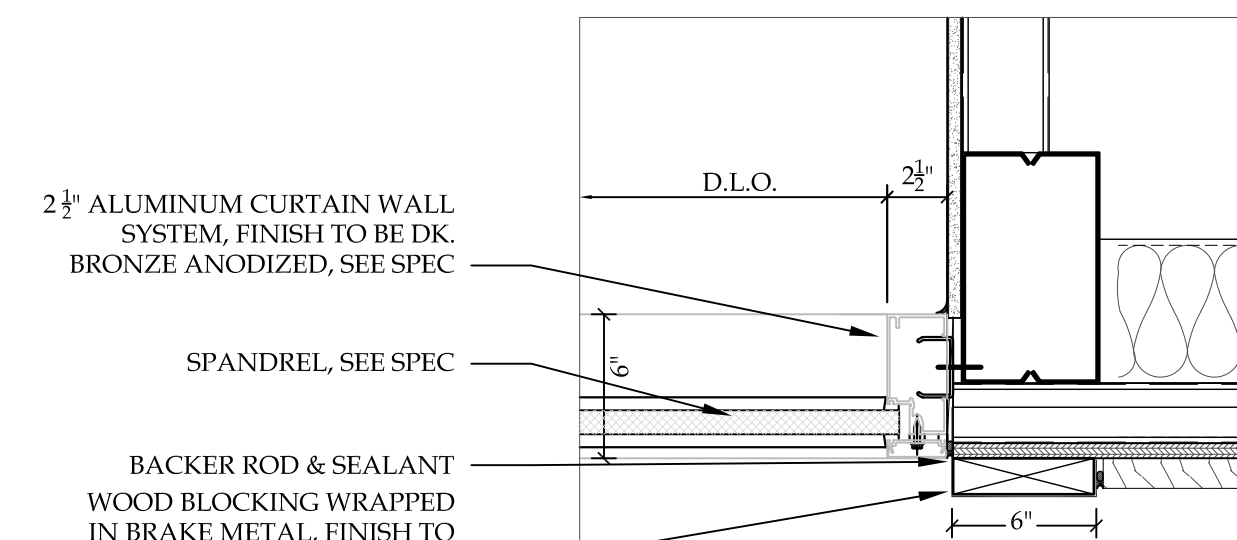


6A JAMB @ CURTAIN WALL (SPANDREL)

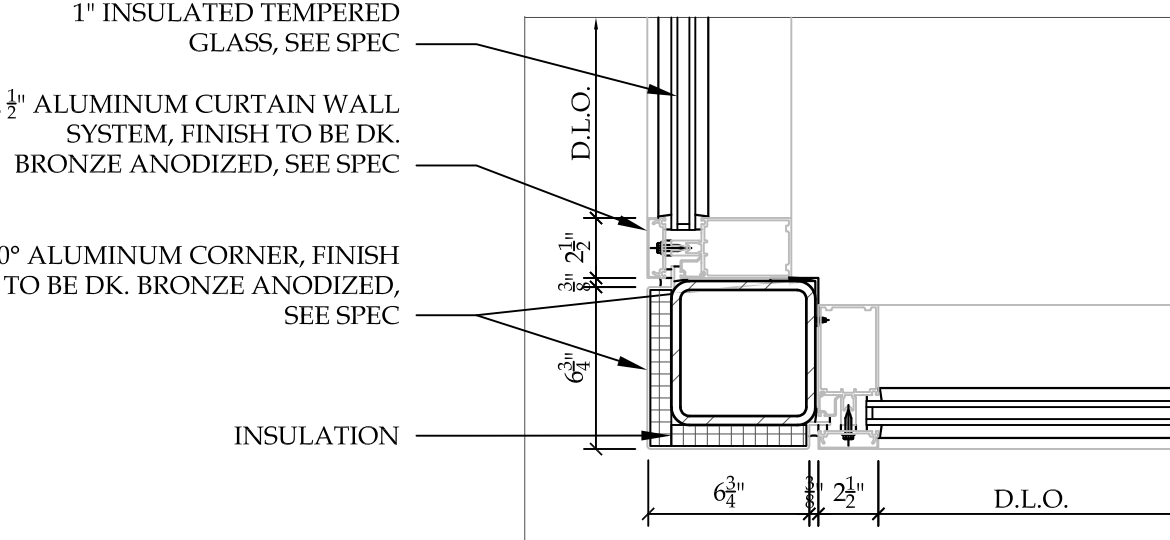


12 90° CORNER @ CURTAIN WALL

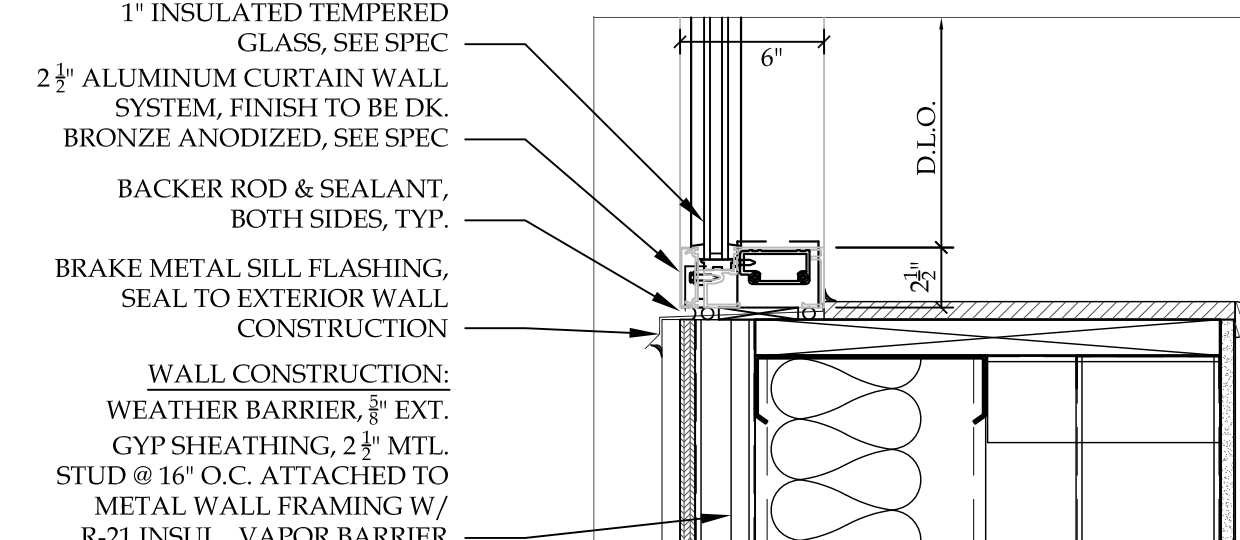


16 SILL @ CURTAIN WALL

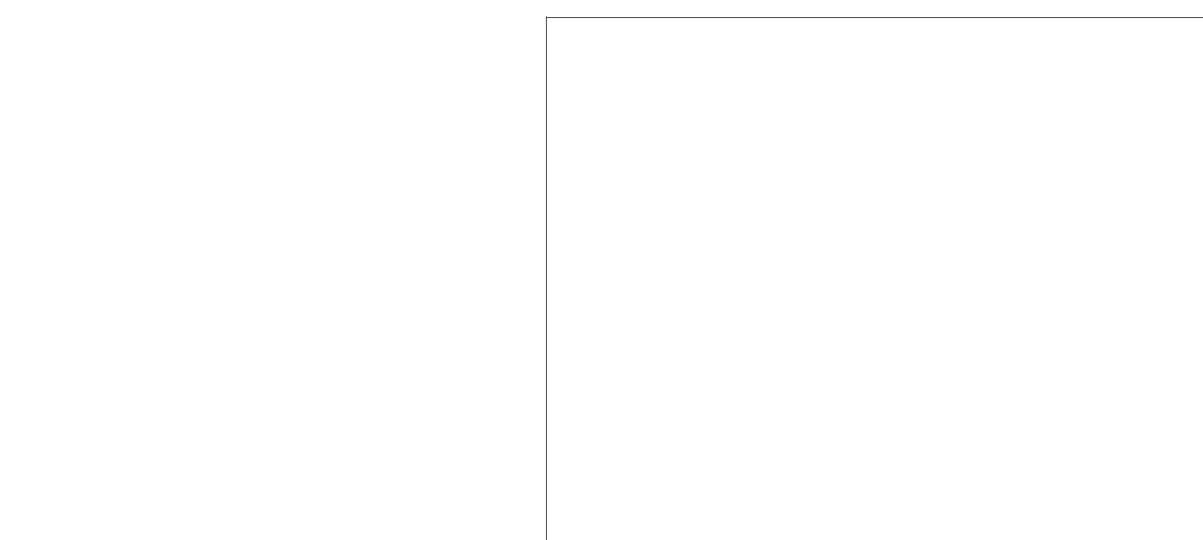


3 NOT USED

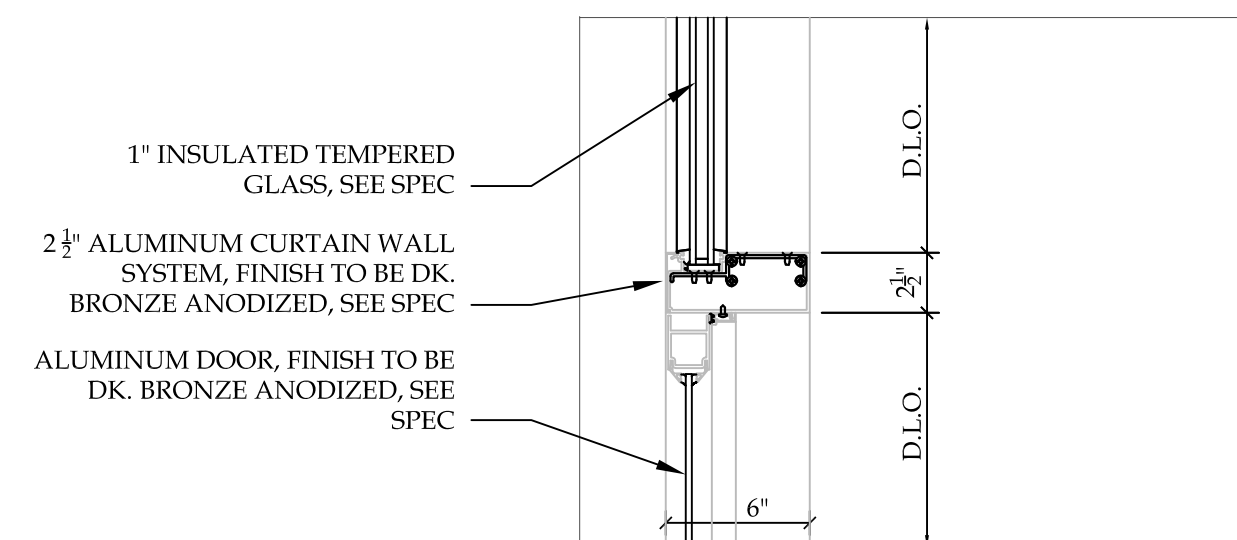

7 DOOR HEAD @ CURTAIN WALL

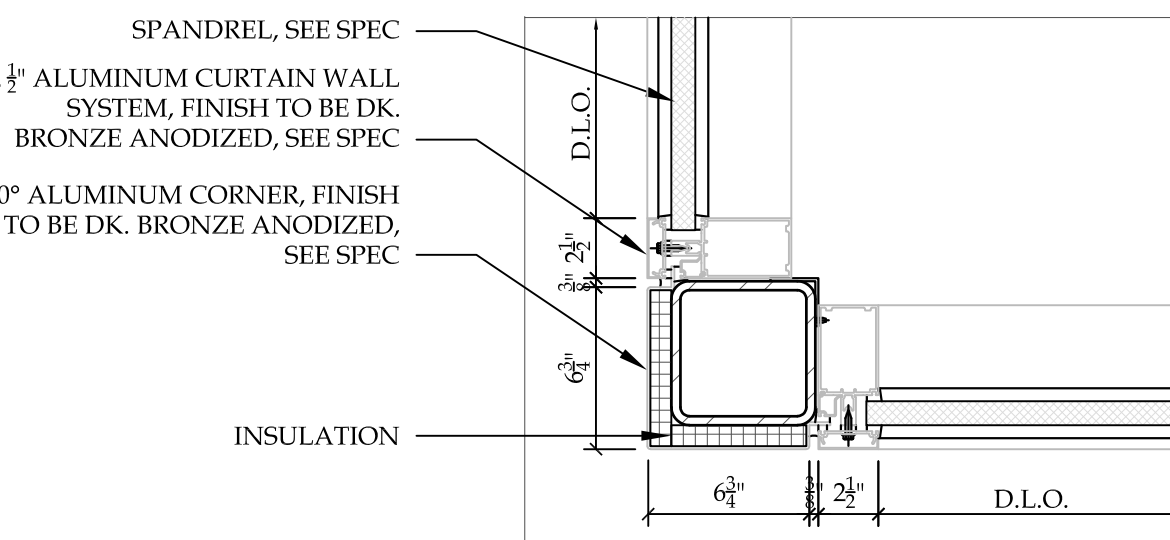

12A 90° CORNER @ CURTAIN WALL (SPANDREL)

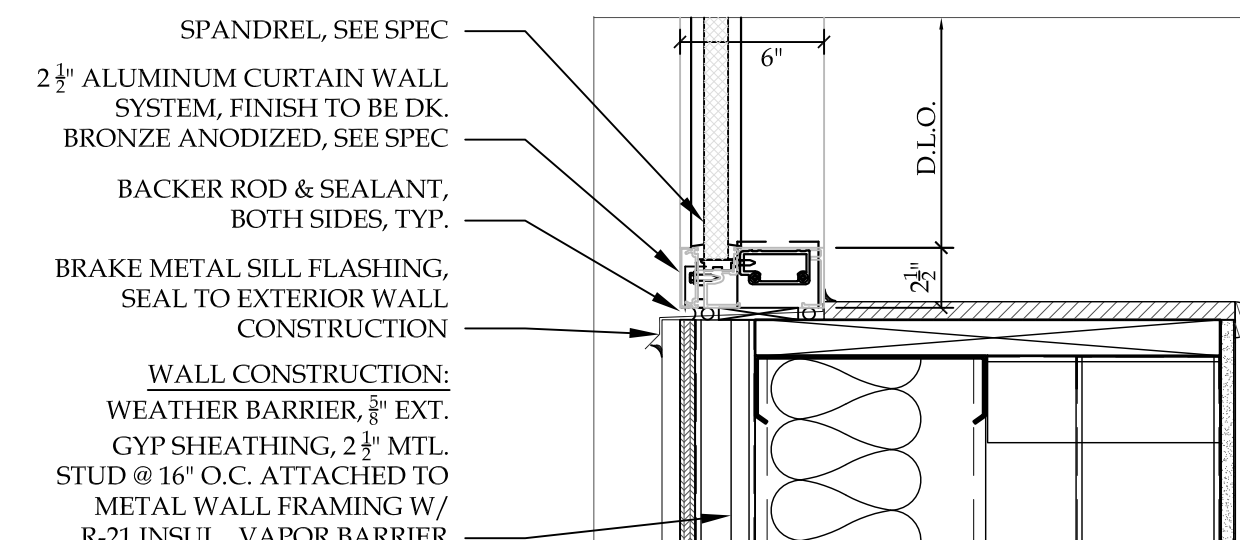

16A SILL @ CURTAIN WALL (SPANDREL)

A1 WINDOW & DOOR DETAILS  
SCALE: 1 1/2\"/>

| REVISION RECORD |            |             |
|-----------------|------------|-------------|
| NO.             | DATE       | REMARKS     |
| #1              | 01.03.2018 | ADDENDUM #1 |

IT IS A VIOLATION OF STATE LAW FOR ANY PERSON, UNLESS ACTING UNDER THE DIRECTION OF A NEW YORK STATE ARCHITECT OR ENGINEER, TO ALTER ANY ITEM ON THIS DOCUMENT IN ANY WAY. IF ANY ITEM ON THIS DOCUMENT IS ALTERED, THE ALTERING ARCHITECT OR ENGINEER SHALL AFFIX TO HIS ITEM HIS SEAL AND THE NOTATION \"ALTERED\" FOLLOWED BY HIS SIGNATURE, THE DATE OF SUCH ALTERATION AND A SPECIFIC DESCRIPTION OF SUCH ALTERATION.



**BRYANT & STRATTON COLLEGE**  
1320 Warwick Way  
Mt. Pleasant, WI 53406

SEAL

**DOOR & WINDOW DETAILS**

**GREGORY A. TOMSIC**  
REGISTERED ARCHITECT  
145 BATHURST DR., TONAWANDA, N.Y. 14150  
716-433-0617

|                       |                          |
|-----------------------|--------------------------|
| SCALE<br>1/8" = 1'-0" | JOB NO.                  |
| DRAWN                 | DWG. NO.<br><b>A-604</b> |
| CHECKED               | CONTRACT NO.             |
| DATE<br>12.22.2017    |                          |



| REVISION RECORD |      |         |
|-----------------|------|---------|
| NO.             | DATE | REMARKS |
|                 |      |         |

IT IS A VIOLATION OF STATE LAW FOR ANY PERSON, UNLESS ACTING UNDER THE DIRECTION OF A NEW YORK STATE ARCHITECT OR ENGINEER, TO ALTER ANY ITEM ON THIS DOCUMENT IN ANY WAY. IF ANY ITEM ON THIS DOCUMENT IS ALTERED, THE ALTERING ARCHITECT OR ENGINEER SHALL AFFIX TO HIS ITEM HIS SEAL AND THE NOTATION "ALTERED BY" FOLLOWED BY HIS SIGNATURE, THE DATE OF SUCH ALTERATION AND A SPECIFIC DESCRIPTION OF SUCH ALTERATION.




**BRYANT & STRATTON COLLEGE**  
 1320 Warwick Way  
 Mt. Pleasant, WI 53406

SCALE


**DOOR & WINDOW DETAILS**

**GREGORY A. TOMSIC**  
 REGISTERED ARCHITECT  
 145 BATHURST DR., TONAWANDA, N.Y. 14150  
 716-435-0617


|                       |                          |
|-----------------------|--------------------------|
| SCALE<br>1/8" = 1'-0" | JOB NO.                  |
| DRAWN                 | DWG. NO.<br><b>A-605</b> |
| CHECKED               | DATE<br>12.22.2017       |
| DATE<br>12.22.2017    | CONTRACT NO.             |

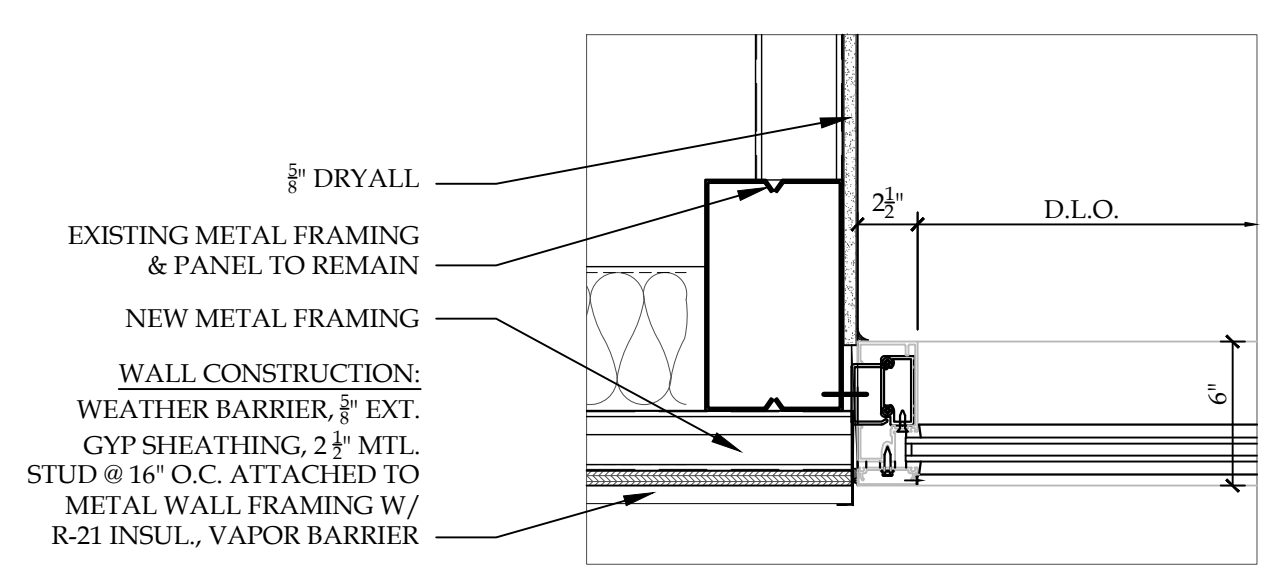


17 JAMB @ CURTAIN WALL

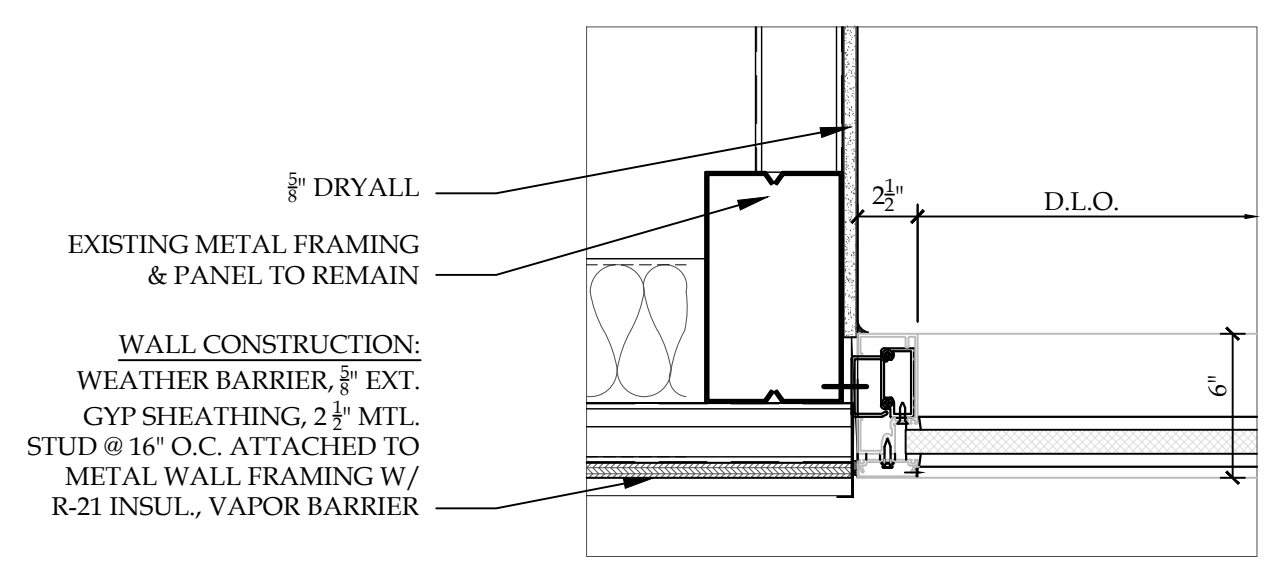


17A JAMB @ CURTAIN WALL (SPANDREL)

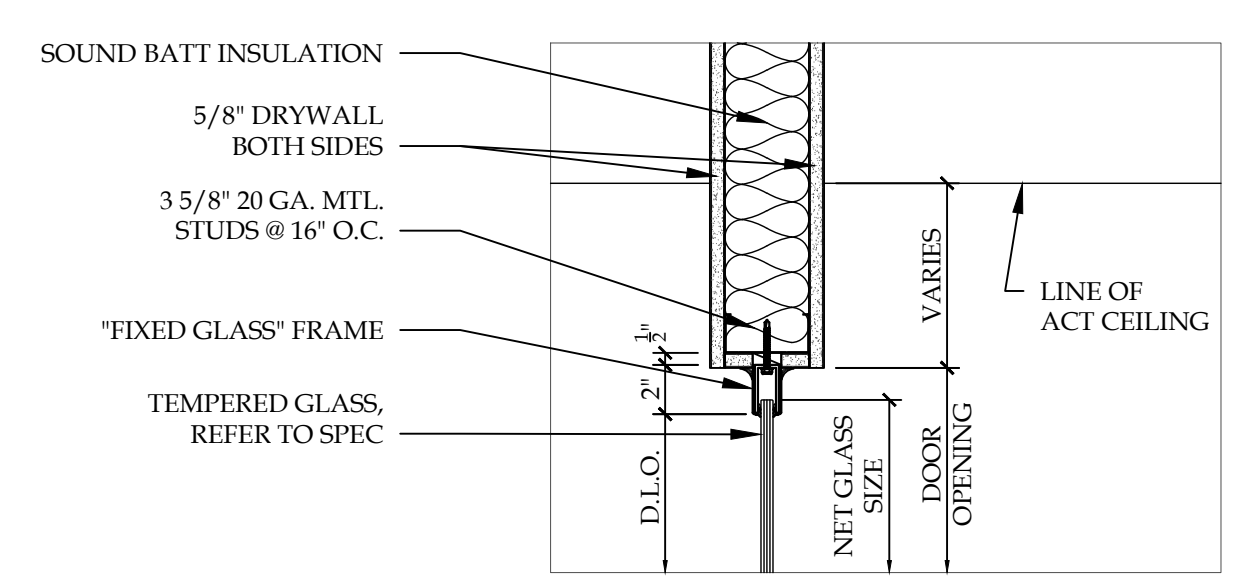


18 HEAD @ FIXED GLASS PARTITION

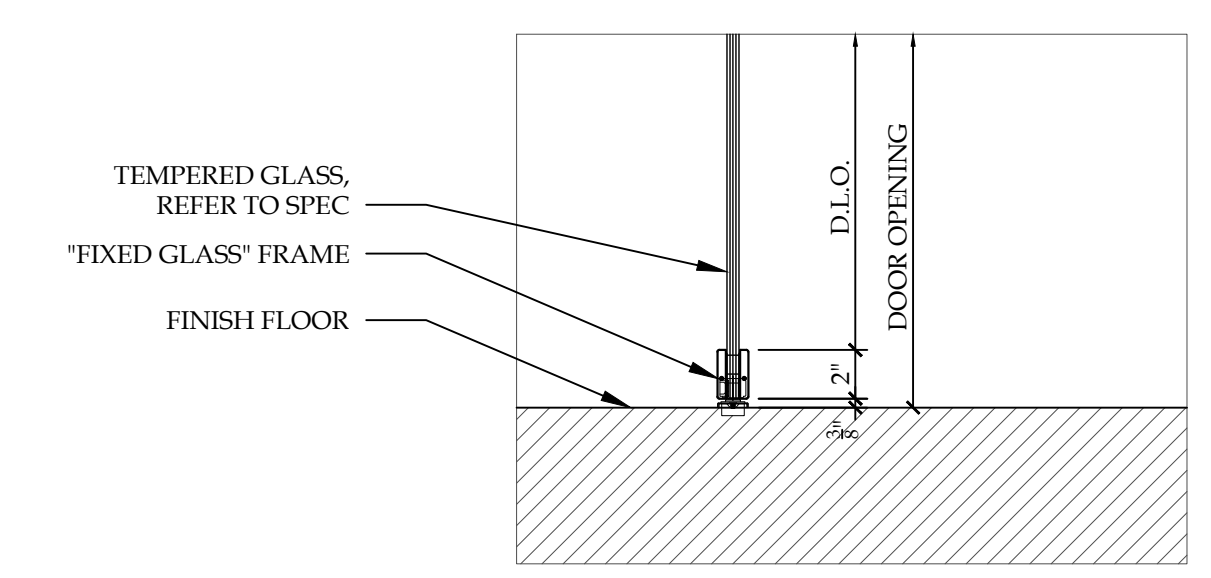


19 SILL @ FIXED GLASS PARTITION (FLOOR MOUNTED)

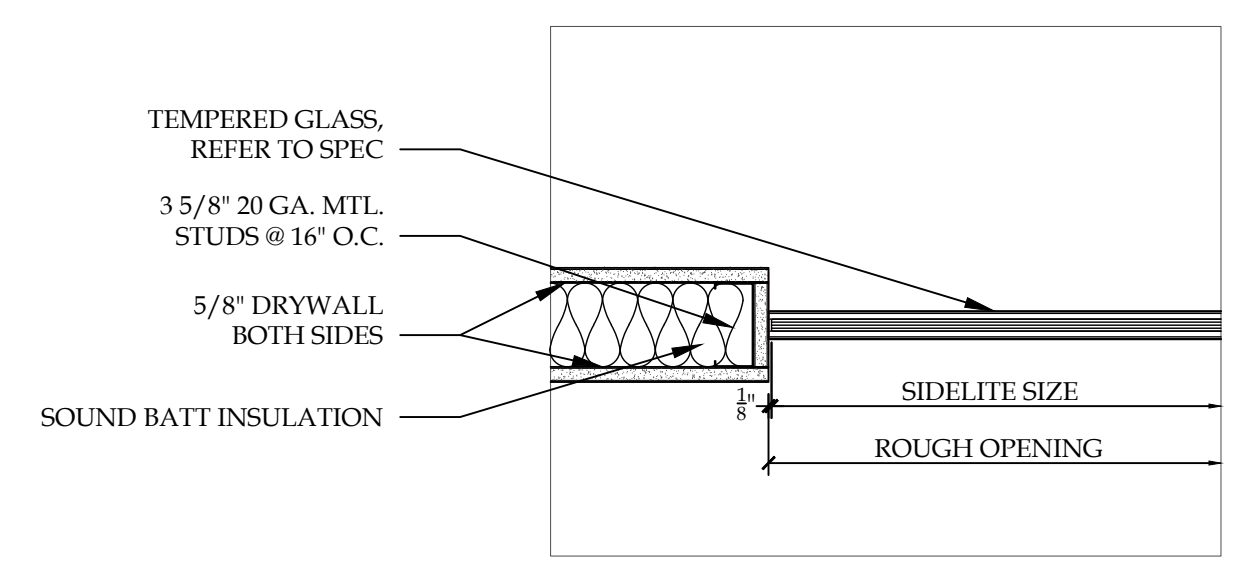


20 JAMB @ FIXED GLASS PARTITION

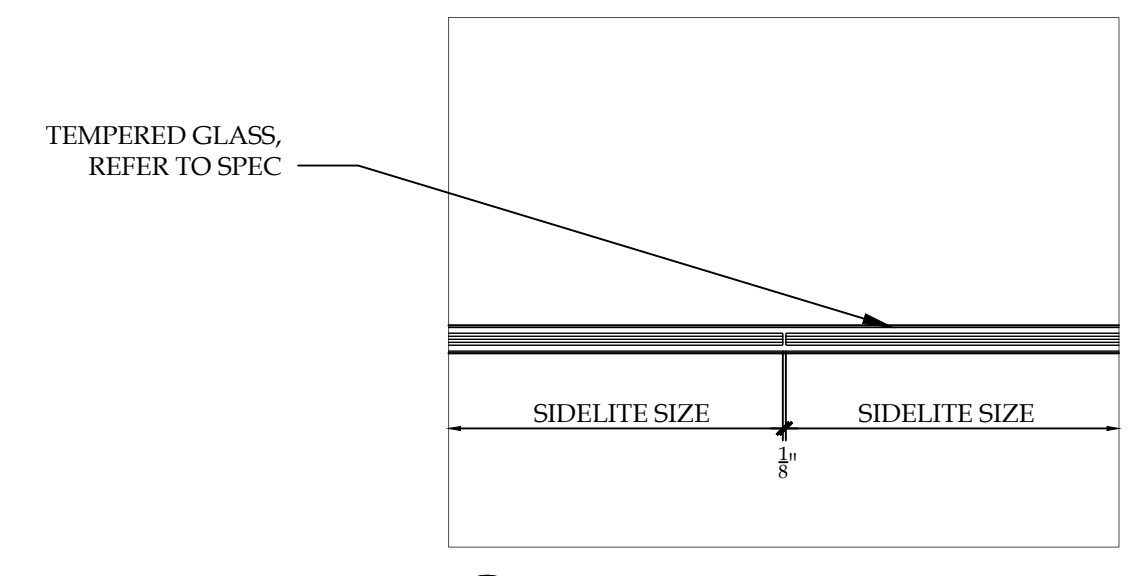


21 BUTT GLAZING @ FIXED GLASS PARTITION

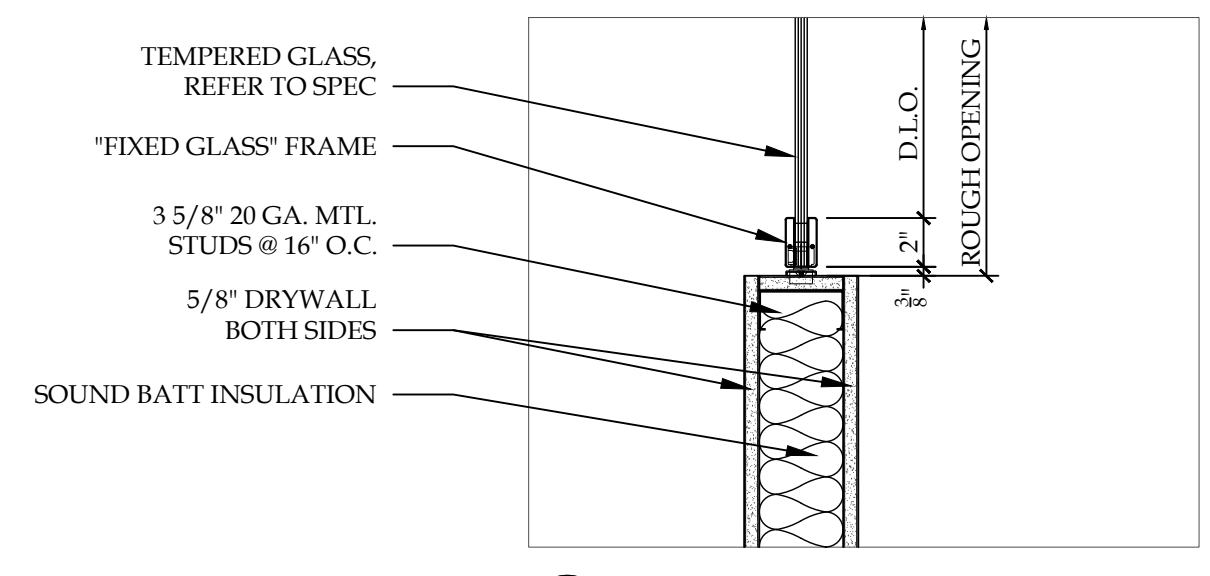


27 SILL @ FIXED GLASS PARTITION (WALL MOUNTED)

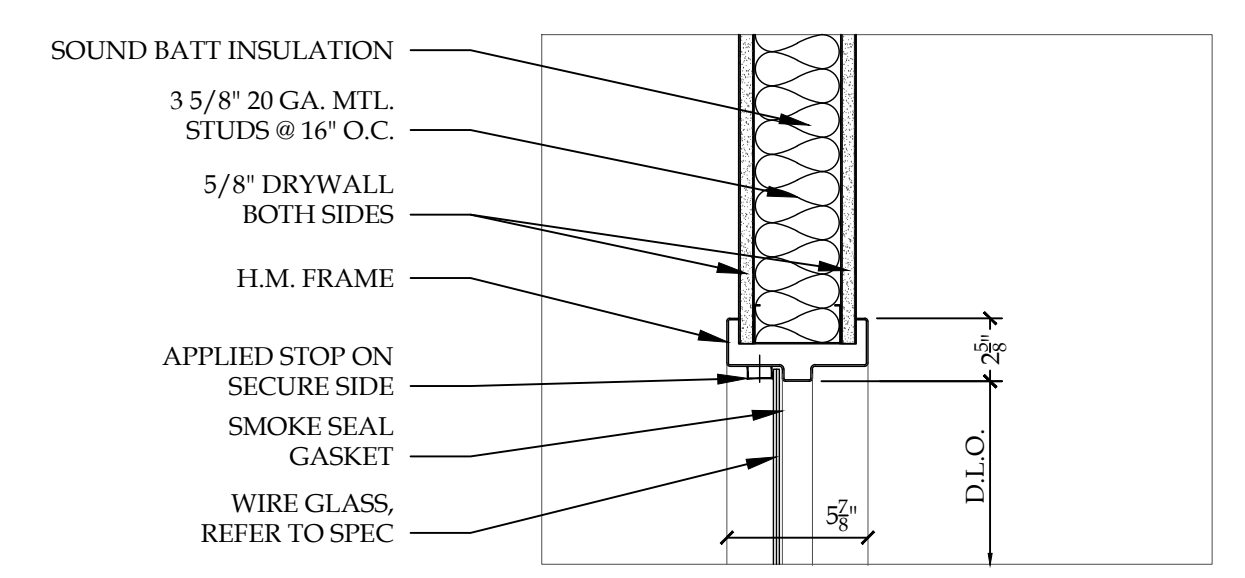


28 HEAD @ HOLLOW METAL WINDOW

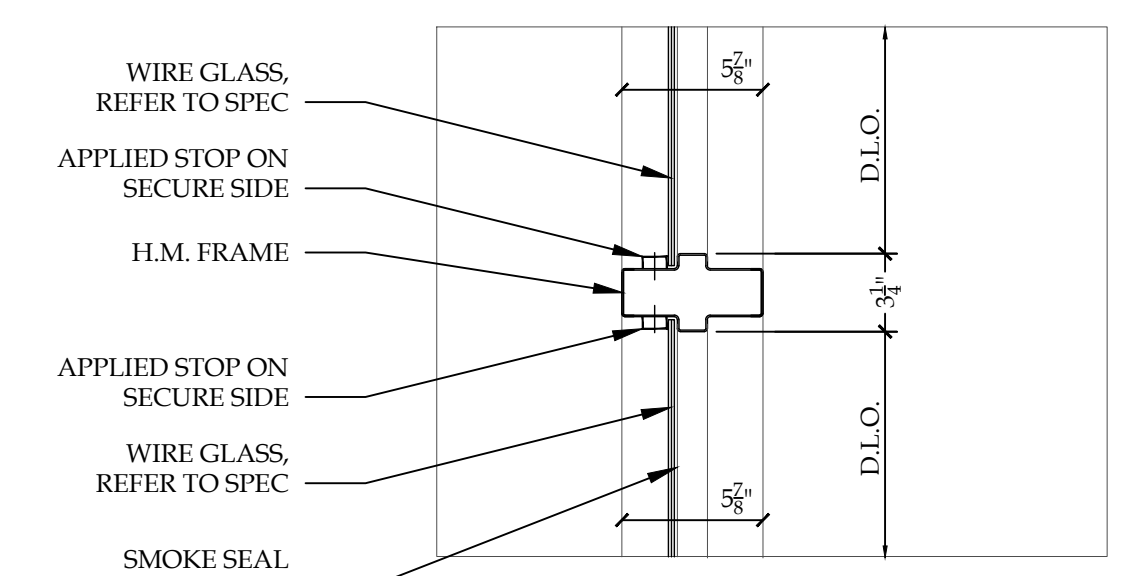


29 HORIZONTAL MULLION @ HOLLOW METAL WINDOW

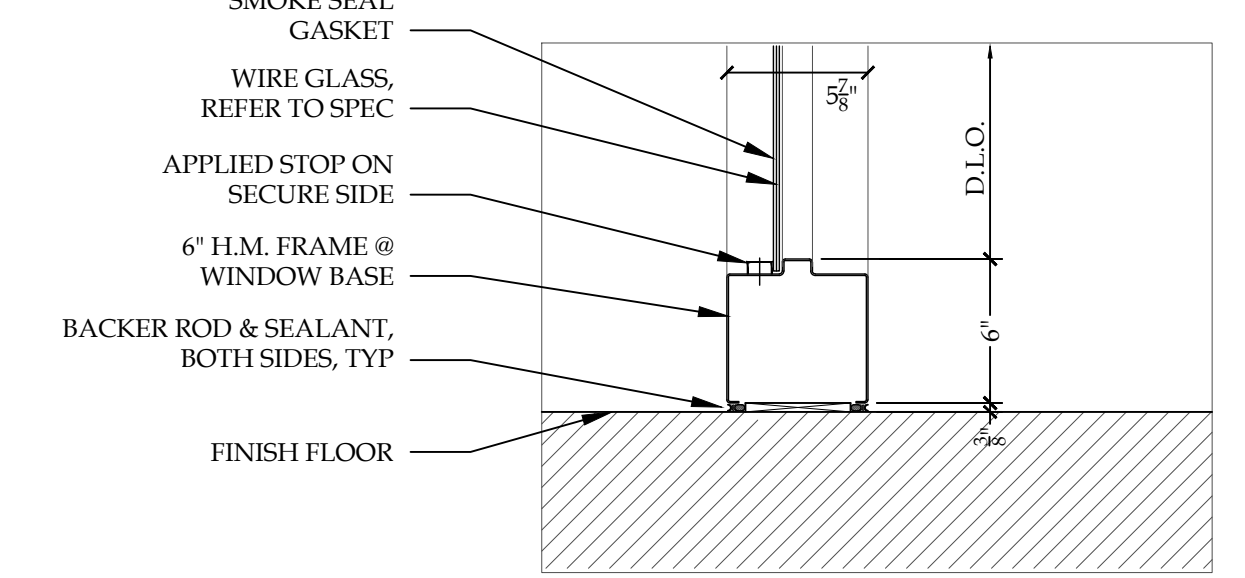


30 SILL @ HOLLOW METAL WINDOW

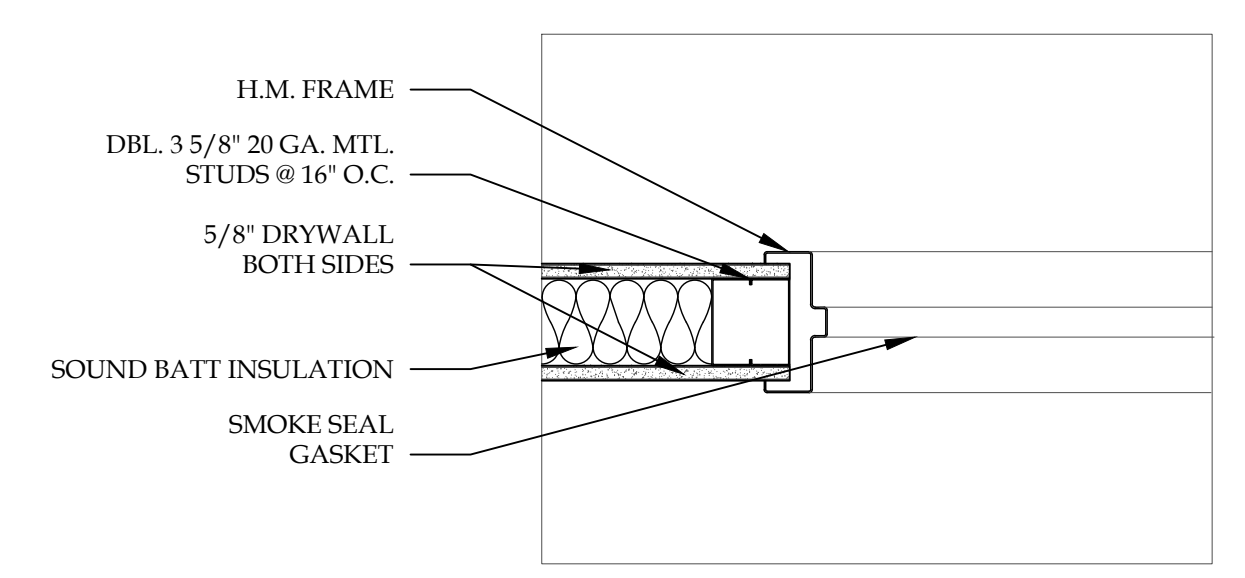

31 JAMB @ HOLLOW METAL WINDOW/ DOOR

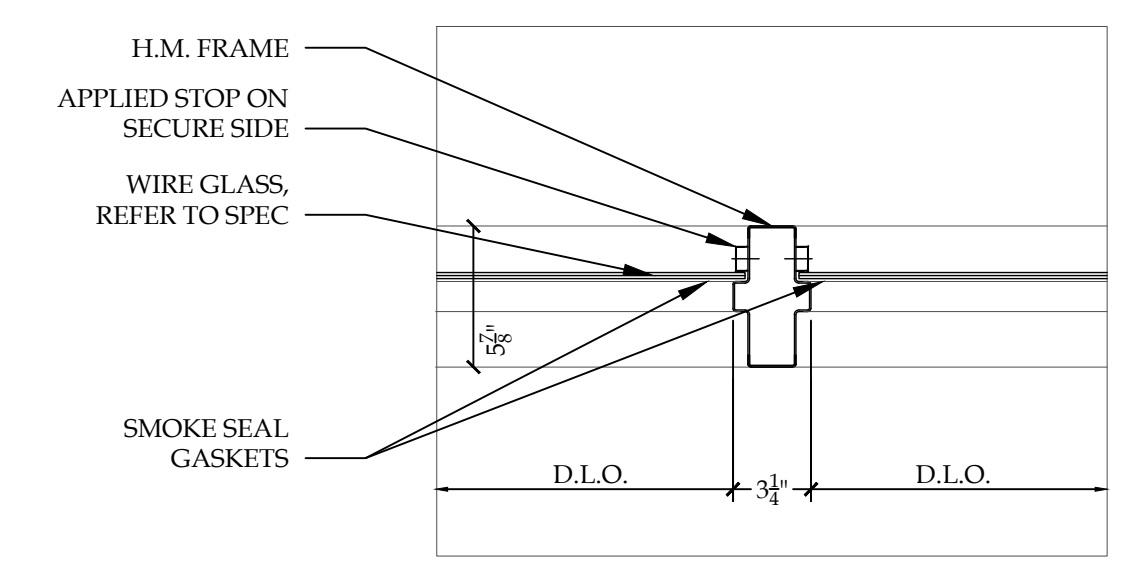

32 VERTICAL MULLION @ HOLLOW METAL WINDOW

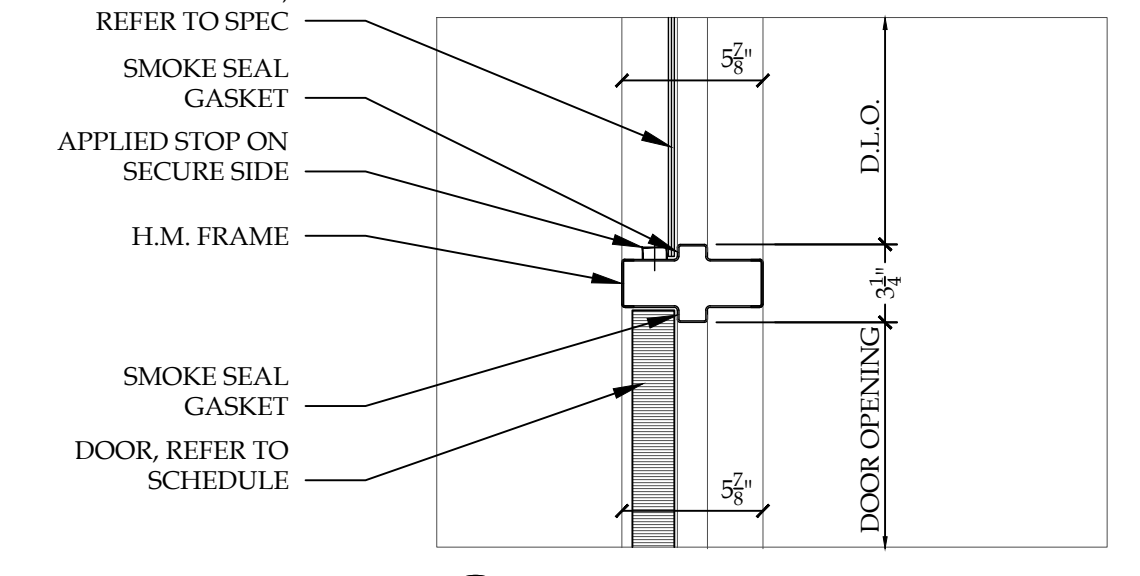

33 TRANSOM @ HOLLOW METAL WINDOW/ DOOR



| FINISH SELECTIONS   |  |
|---|--|
| <b>CARPET (CPT-X):</b>  |  |
| (CPT-1) (TYPICAL)<br>MANUFACTURER:<br>COLLECTION:<br>STYLE:<br>COLOR:<br>INSTALLATION:<br>NOTE:                   | INTERFACE<br>WORLD WOVEN<br>SUMMERHOUSE SHADES<br>FLANNEL 105482<br>VERTICAL ASHLAR<br>CONTACT MARY WEBBER FOR<br>PRICING 716-536-2030   |
| (CPT-2) (LIBRARY)<br>MANUFACTURER:<br>COLLECTION:<br>STYLE:<br>COLOR:<br>INSTALLATION:<br>NOTE:                   | INTERFACE<br>AERIAL<br>AE315<br>MIST/AQUAMARINE<br>CONTACT ARCHITECT<br>CONTACT MARY WEBBER FOR<br>PRICING 716-536-2030                  |
| (CPT-3) (WALK OFF MAT)<br>MANUFACTURER:<br>STYLE:<br>COLOR:<br>LOCATION:  | INTERFACE<br>ENTRY LEVEL<br>BLACK<br>VESTIBULES  |
| <b>TILE (T-X):</b>  |  |
| (T-1) (VESTIBULE/ENTRY)<br>MANUFACTURER:<br>STYLE:<br>COLOR:<br>SIZE:<br>INSTALLATION:<br>GROUT:                  | BEST TILE<br>ATLAS<br>BERMUDA GRIGIO<br>8"X48"<br>1/3 BRICK LAY<br>MAPEI - TBD   |
| (T-2) (RESTROOMS)<br>MANUFACTURER:<br>DISTRIBUTOR:<br>STYLE:<br>COLOR:<br>SIZE:<br>INSTALLATION:<br>GROUT:        | AMERICAN OLEAN<br>BEST TILE<br>THEORETICAL<br>CREATIVE GRAY TH96<br>12"X24"<br>1/3 BRICK LAY<br>MAPEI - TBD                              |
| (T-3) (RESTROOMS ACCENT)<br>MANUFACTURER:<br>DISTRIBUTOR:<br>STYLE:<br>COLOR:<br>SIZE:<br>INSTALLATION:<br>GROUT: | AMERICAN OLEAN<br>BEST TILE<br>THEORETICAL BOLD<br>FORMULA BLUE TH86<br>12"X24"<br>1/3 BRICK LAY<br>MAPEI - TBD                          |
| <b>LUXURY VINYL TILE (LVT-X):</b>   |  |
| (LVT-1)<br>MANUFACTURER:<br>STYLE:<br>COLOR:<br>SIZE:<br>INSTALLATION:<br>NOTE:                                   | INTERFACE<br>NATURAL WOODGRAINS<br>BLACK WALNUT A00201<br>25CMX1M<br>VERTICAL ASHLAR<br>CONTACT MARY WEBBER FOR<br>PRICING 716-536-2030  |
| (LVT-2)<br>MANUFACTURER:<br>STYLE:<br>COLOR:<br>SIZE:<br>INSTALLATION:<br>NOTE:                                   | INTERFACE<br>TEXTURED STONES<br>EMPERADOR GRAY A00304<br>50CMX50CM<br>NON DIRECTIONAL<br>CONTACT MARY WEBBER FOR<br>PRICING 716-536-2030 |
| <b>VINYL SHEET FLOORING (SF-X):</b>   |  |
| (SF-1) (TYPICAL)<br>MANUFACTURER:<br>STYLE:<br>COLOR:<br>HEAT WELD:   | ARMSTRONG<br>MEDITONE HOMOGENEOUS SHEET<br>NATURAL GRAY LIGHT H5304<br>TO MATCH FLOOR COLOR (SF-1)                                       |
| (SF-2) (ACCENT)<br>MANUFACTURER:<br>STYLE:<br>COLOR:<br>HEAT WELD:<br>INSTALLATION:                               | ARMSTRONG<br>MEDITONE HOMOGENEOUS SHEET<br>MAZARINE BLUE H5434<br>TO MATCH SF-1<br>REFER TO A-609 FOR PATTERN                            |
| <b>VINYL COMPOSITION TILE (VCT-X):</b>  |  |
| (VCT-1)<br>MANUFACTURER:<br>STYLE:<br>COLOR:<br>SIZE:   | JOHNSONITE<br>AZROCK VCT<br>SILVER MIST V-207<br>12" X 12"   |
| <b>TILE BASE (TB-X):</b>  |  |
| (TB-1) (VESTIBULE/ENTRY TO BE USED WITH T-1)<br>MANUFACTURER:<br>STYLE:<br>COLOR:<br>HEIGHT:<br>GROUT:            | BEST TILE<br>ATLAS<br>BERMUDA GRIGIO<br>4"<br>MAPEI - TBD  |
| <b>RUBBER BASE (RB-X):</b>  |  |
| (RB-1)<br>MANUFACTURER:<br>SIZE:<br>COLOR:<br>LOCATION:   | JOHNSONITE<br>4" COVE BASE<br>TBD<br>TYPICAL   |
| (RB-2)<br>MANUFACTURER:<br>SIZE:<br>COLOR:<br>LOCATION:   | JOHNSONITE<br>4" COVE BASE<br>MEDIUM GRAY 28<br>LABS, TO BE USED WITH SF-1   |
| (RB-3) (AT NURSING ACCENT WALL ONLY)<br>MANUFACTURER:<br>SIZE:<br>COLOR:  | JOHNSONITE<br>4" COVE BASE<br>TBD  |

| FINISH SELECTIONS  |  |
|--|--|
| <b>PAINT (P-X):</b>  |  |
| (P-1) (TYPICAL)<br>MANUFACTURER:<br>COLOR:<br>FINISH:  | SHERWIN WILLIAMS<br>TBD<br>EGGSHELL  |
| (P-2) (CORRIDOR ACCENT)<br>MANUFACTURER:<br>COLOR:<br>FINISH:  | SHERWIN WILLIAMS<br>TBD<br>EGGSHELL  |
| (P-3) (CLASSROOM ACCENT)<br>MANUFACTURER:<br>COLOR:<br>FINISH:   | SHERWIN WILLIAMS<br>TBD<br>EGGSHELL  |
| (P-4) (OFFICE ACCENT)<br>MANUFACTURER:<br>COLOR:<br>FINISH:  | SHERWIN WILLIAMS<br>TBD<br>EGGSHELL  |
| (P-5) (LIBRARY ACCENT)<br>MANUFACTURER:<br>COLOR:<br>FINISH:   | SHERWIN WILLIAMS<br>TBD<br>EGGSHELL  |
| (P-6) (RECEPTION ACCENT)<br>MANUFACTURER:<br>COLOR:<br>FINISH:   | SHERWIN WILLIAMS<br>TBD<br>EGGSHELL  |
| (P-7) (DOOR FRAMES)<br>MANUFACTURER:<br>COLOR:<br>FINISH:  | SHERWIN WILLIAMS<br>TBD<br>SEMI-GLOSS  |
| <b>WALL TILE (WT-X):</b>   |  |
| (WT-1) (BREAK ROOM BACKPLASH)<br>MANUFACTURER:<br>STYLE:<br>COLOR:<br>INSTALLATION:<br>GROUT:                        | BEST TILE<br>CAPRI<br>BLUE GROTTO<br>SEE A-400S FOR DETAILS<br>MAPEI - TBD   |
| (WT-2) (RESTROOM WALL TILE)<br>MANUFACTURER:<br>DISTRIBUTOR:<br>STYLE:<br>COLOR:<br>SIZE:<br>INSTALLATION:<br>GROUT: | OLYMPIA TILE<br>DOBKIN TILE<br>COLOR & DIMENSION<br>ARCTIC WHITE BRIGHT<br>6"X24"<br>SEE A-400S FOR DETAILS<br>MAPEI - TBD |
| (WT-3) (NURSING BACKPLASH)<br>MANUFACTURER:<br>STYLE:<br>COLOR:<br>INSTALLATION:<br>GROUT:                           | BEST TILE<br>CAPRI MOSAIC<br>BLUE GROTTO<br>SEE A-400S FOR DETAILS<br>MAPEI - TBD  |
| (WT-4) (RESTROOM WALL TILE)<br>MANUFACTURER:<br>DISTRIBUTOR:<br>STYLE:<br>COLOR:<br>SIZE:<br>INSTALLATION:<br>GROUT: | OLYMPIA TILE<br>DOBKIN TILE<br>COLOR & DIMENSION<br>ARCTIC WHITE BRIGHT<br>4"X16"<br>SEE A-400S FOR DETAILS<br>MAPEI - TBD |
| <b>SOLID SURFACE (SS-X):</b>   |  |
| (SS-1) (RESTROOM COUNTERTOP)<br>MANUFACTURER:<br>COLOR:  | DUPONT - CORIAN<br>ARROWROOT   |
| (SS-2) (TYPICAL COUNTERTOP)<br>MANUFACTURER:<br>COLOR:   | DUPONT - CORIAN<br>NATURAL GRAY  |
| (SS-3) (NURSING LAB)<br>MANUFACTURER:<br>COLOR:  | WILSONART - QUARTZ SELECT<br>PAPER LANTERN Q6001   |
| (SS-4) (RECEPTION/CONFERENCE ROOM)<br>MANUFACTURER:<br>COLOR:  | DUPONT - ZODIAQ<br>TBD   |
| (SS-5) (CHEMISTRY LAB)<br>MANUFACTURER:<br>STYLE:<br>COLOR:  | EPOXY TOPS<br>EPOXY RESIN<br>GRAY  |
| <b>PLASTIC LAMINATE (PL-X):</b>  |  |
| (PL-1) (TYPICAL CABINET/NURSING ACCENT WALL)<br>MANUFACTURER:<br>COLOR:  | WILSONART<br>EBONY RECON 7997-38   |
| (PL-2) (RESTROOM APRON)<br>MANUFACTURER:<br>COLOR:   | WILSONART<br>PHANTOM CHARCOAL 8214K-28   |
| (PL-3) (WINDOW SILLS)<br>MANUFACTURER:<br>COLOR:   | PIONITE<br>GRAVEYARD OF THE ATLANTIC   |
| (PL-4) (OFFICE COUNTERTOPS)<br>MANUFACTURER:<br>COLOR:   | PIONITE<br>GRAVEYARD OF THE ATLANTIC   |
| (PL-5) (CHEMISTRY LAB)<br>MANUFACTURER:<br>COLOR:  | CHEMETAL<br>BRUSHED ALUMINUM 702   |
| <b>DOORS (WD-X):</b>   |  |
| (WD-1)<br>MANUFACTURER:<br>SPECIES:<br>STAIN:  | GRAHAM WOOD DOORS<br>MAPLE<br>TBD  |

| FINISH SELECTIONS   |   |
|---|---|
| <b>WOOD TREADS (WDT-X):</b>   |   |
| (WDT-1)<br>SPECIES:<br>STAIN:<br>NOTE:  | MAPLE<br>ST-1<br>SEE STAIR DETAILS IN A-300S  |
| <b>WOOD VENEER (WV-X):</b>  |   |
| (WV-1)<br>SPECIES:<br>STAIN:<br>LOCATION:   | MAPLE<br>ST-1<br>RECEPTION DESK   |
| <b>STAIN (ST-X):</b>  |   |
| (ST-1)<br>STAIN:  | MATCH SAMPLE PROVIDED BY ARCH.  |
| <b>ACOUSTICAL CEILING TILE (ACT-X):</b>   |   |
| (ACT-1)<br>MANUFACTURER:<br>STYLE:<br>EDGE PROFILE:<br>SIZE:<br>THICKNESS:<br>COLOR:<br>SUSPENSION SYS.:      | ARMSTRONG<br>MESA SECOND LOOK 688<br>15" / 16" REGULAR EDGE<br>2" X 4"<br>3/4"<br>WHITE<br>PRELUDE XL 15" / 16" EXPOSED TEE   |
| <b>TRANSITION (TS-X):</b>   |   |
| (TS-1) (GENERAL)<br>MANUFACTURER:<br>STYLE & SIZE:  | SCHLUTER SYSTEMS<br>RENO-TK SIZE TO BE V.I.F. IN<br>ACCORDANCE WITH MATERIAL(S)<br>THICKNESS<br>CLEAR SATIN ANODIZED<br>ALUMINUM<br>FLOORING MATERIAL CHANGES AS<br>NECESSARY.<br>PLEASE SEE GENERAL NOTES RE:<br>TRANSITIONS |
| STYLE:<br>LOCATION(S):<br>NOTE(S):  |   |
| <b>FIBERGLASS REINFORCED PANEL (FRP-X):</b>   |   |
| (FRP-1)<br>MANUFACTURER:<br>STYLE:<br>COLOR:<br>STYLE:<br>LOCATION(S):  | CRANE COMPOSITES<br>GLASS BOARD WITH SURFSEAL<br>PEBBLED EMBOSSED - COLOR: TBD<br>CLASS A FIRE RATED<br>JANITORIAL ROOM   |
| <b>CORNERGUARDS (CG-X):</b>   |   |
| (CG-1)<br>MANUFACTURER:<br>SERIES:<br>STYLE:<br>TEXTURE:<br>COLOR:<br>PROFILE:<br>LOCATION:                   | C/S ACROVYN<br>SM SERIES<br>SM 20N<br>SHADOWGRAIN<br>TBD<br>SQUARE NOSE<br>TYPICAL  |
| <b>ROLLERSHADES (RS-X):</b>   |   |
| (RS-1)<br>MANUFACTURER:<br>STYLE:<br>COLOR:<br>OPENNESS:<br>LOCATION:   | HUNTER DOUGLAS<br>E SCREEN 7510<br>TBD<br>10%<br>ALL EXTERIOR WINDOWS & INTERIOR<br>GLASS WALLS/SIDELIGHTS  |
| <b>DRAPERY (DR-X):</b>  |   |
| (DR-1)<br>MANUFACTURER:<br>STYLE:<br>COLOR:<br>LOCATION:  | D.L. COUCH<br>DAYBREAK<br>TBD<br>NURSING LAB  |
| <b>MISCELLANEOUS (MISC-X):</b>  |   |
| (MISC-1) (TOILET PARTITIONS)<br>MANUFACTURER:<br>FINISH:<br>STYLE:  | GENERAL PARTITIONS<br>STAINLESS STEEL<br>FLOOR ANCHORED/OVERHEAD<br>BRACED  |
| (MISC-2) (3-FORM PLASTIC PANELING)<br>MANUFACTURER:<br>STYLE:<br>COLOR:<br>FINISH:<br>THICKNESS:<br>LOCATION: | 3-FORM<br>VARIA ECORESIN - CHROMA<br>MOONSTONE<br>PATENT<br>+<br>RECEPTION DISK FEATURES  |
| (MISC-3) (NURSING LAB)<br>(CURTAIN TRACK)<br>MANUFACTURER:<br>STYLE:<br>FINISH:<br>MESH:                      | C/S ACROVYN<br>SURFACE MOUNTED TRACK 6062<br>CLEAR ANODIZED ALUMINUM<br>WHITE CUBICLE CURTAIN MESH  |
| (MISC-4) (PVC EDGE BANDING)<br>MANUFACTURER:<br>COLOR:<br>LOCATION:   | DOELLKEN<br>TBD<br>CABINETS WHERE SPECIFIED   |
| (MISC-5) (PVC EDGE BANDING)<br>MANUFACTURER:<br>COLOR:<br>LOCATION:   | DOELLKEN<br>TBD<br>COUNTERTOPS WHERE SPECIFIED  |
| (MISC-6) (CUBICLE CURTAIN CARRIERS)<br>MANUFACTURER:<br>STYLE:  | C/S ACROVYN<br>GENERAL CARRIER #1062N   |
| (MISC-7) (PLASTIC PANELING)<br>MANUFACTURER:<br>STYLE:<br>COLOR:<br>FINISH:<br>THICKNESS:<br>LOCATION:        | 3-FORM<br>VARIA ECORESIN - CHROME<br>HARBOR<br>PATENT<br>+<br>LIBRARY DESK  |

| GENERAL NOTES  |  |
|--|--|
| <ul style="list-style-type: none"> <li>ANY AND ALL FINISH SELECTIONS/ COLORS MUST BE SUBMITTED TO ARCHITECT FOR APPROVAL ACCOUNTING FOR PROPER LEAD TIME. ANY FINISH THAT IS INSTALLED WITHOUT ARCHITECTS APPROVAL MAY BE REQUIRED TO BE REMOVED AND REPLACED BY THE GENERAL CONTRACTOR. IT IS THE RESPONSIBILITY OF THE CONTRACTOR TO ORDER ALL MATERIALS AT THE APPROPRIATE TIME. ANY FEES INCURRED AS A RESULT OF FINISHES NOT BEING ORDERED ON TIME WILL BE THE RESPONSIBILITY OF THE CONTRACTOR.</li> <li>ANY DISCREPANCIES BETWEEN ARCHITECTURAL ELEVATION(S), PLAN(S), SCHEDULE(S) AND NOTES MUST BE BROUGHT TO ARCHITECTS ATTENTION. ARCHITECT MUST BE CONTACTED AND GIVE APPROVAL TO MOVE FORWARD WITH SPECIFIC DIRECTION PRIOR TO ANTICIPATED ACTION.</li> <li>SEE A-500'S DRAWINGS FOR ALL CABINET HARDWARE.</li> <li>ALL INTERIOR PRODUCTS TO MEET/ EXCEED FLAME SPREAD RATING PER CODE</li> <li>ALL FLOOR FINISHES TO EXTEND BENEATH ALL MILLWORK.</li> <li>ALL ELECTRICAL PANEL COVERS AND/OR MECHANICAL EQUIPMENT AND/OR DUCTING TO BE PAINTED TO MATCH ADJOINING WALL.</li> <li>ANY CEILING HVAC SUPPLY/DIFFUSERS ETC. TO BE PAINTED TO MATCH SURROUNDING CEILING FINISH. ANY QUESTIONS OR CONCERN TO BE BROUGHT TO ARCHITECTS ATTENTION FOR FINAL DECISION PRIOR TO ORDER/INSTALL BY CONTRACTOR OR OTHER.</li> <li>GYPSON SOFFIT TO BE EXTEND TO CEILING. HORIZONTAL SURFACE OF ALL SOFFITS TO BE PAINTED TO MATCH ADJOINING WALLS UNLESS OTHERWISE SPECIFIED.</li> </ul> |  |
| <b>CEILING(S):</b>   |  |
| <ul style="list-style-type: none"> <li>ALL GYPSON BOARD CEILINGS TO BE PAINTED IN A FLAT WHITE FINISH UNLESS SPECIFIED.</li> <li>ALL EXPOSED MECHANICAL DUCT COVERS SHALL BE PAINTED TO MATCH THE SURROUNDING WALL/ CEILING COLOR. PRIME AS NECESSARY.</li> </ul>  |  |
| <b>WALLS:</b>  |  |
| <ul style="list-style-type: none"> <li>PROVIDE (1) COAT WALL PRIMER FOLLOWED BY (2) COATS WALL PAINT ON ALL INTERIOR WALL SURFACE UNLESS OTHERWISE NOTED IN SPECIFICATIONS. SEE SPEC FOR DETAILS.</li> <li>WHERE DARK PAINT COLORS ARE APPLIED, USE DEEP GRAY BASE PRIMER TO PREVENT BURNISHING.</li> <li>PROVIDE SPACERS AS NEEDED BEHIND MIRRORING IN RESTROOM TO ACCOUNT FOR TILE THICKNESS.</li> </ul>   |  |
| <b>FLOORS:</b>   |  |
| <ul style="list-style-type: none"> <li>PROVIDE CORIAN OR EQUAL THRESHOLD AT ALL TOILET ROOM TRANSITIONS UNLESS OTHERWISE SPECIFIED. ARCHITECT TO CHOOSE FROM MANUFACTURER FULL RANGE OF COLORS.</li> <li>NO CHANGES OR SUBSTITUTIONS WILL BE MADE TO THE FOLLOWING FINISHES UNLESS DIRECTED BY THE OWNER OR ARCHITECT.</li> <li>CONTRACTOR TO PROVIDE (1S-1) AT ALL FLOORING MATERIAL CHANGES NEEDING THRESHOLDS. NECESSARY SIZES TO BE DETERMINED BY CONTRACTOR AND V.I.F. BASED ON MATERIAL THICKNESS.</li> </ul>  |  |
| <b>MILLWORK:</b>   |  |
| <ul style="list-style-type: none"> <li>PROVIDE CLEAR BEAD OF SILICONE OR CLEAR CALK TO SEAL BETWEEN MILLWORK PIECES (IE: COUNTER TOP AND BACKPLASH) AND MILLWORK AND WALL. (TYPICAL).</li> <li>ALL COLOR SELECTION OF PLASTIC LAMINATE SUPPORTS TO MATCH ADJACENT WALL.</li> </ul>   |  |
| <b>WINDOWS:</b>  |  |
| <ul style="list-style-type: none"> <li>ALL GLAZING FACING EXTERIOR TO RECEIVE RS-1.</li> <li>ALL WINDOW SILLS TO BE PL-3.</li> </ul>   |  |
| <b>BASE:</b>   |  |
| <ul style="list-style-type: none"> <li>WHERE 4" TILE BASE IS LOCATED, USE SCHLUTER SYSTEM, INC. CHROME L-CHANNEL TOP CAP. FINISH SATIN. FINAL COLOR TO BE SELECTED BY ARCHITECT.</li> </ul>  |  |
| <b>DOORS:</b>  |  |
| <ul style="list-style-type: none"> <li>ALL HOLLOW METAL DOOR FRAMES TO BE PAINTED WITH P-7.</li> </ul>   |  |
| <b>OUTLETS:</b>  |  |
| <ul style="list-style-type: none"> <li>ALL OUTLET SWITCHES AND COVERS TO BE WHITE.</li> </ul>  |  |
| <b>SIGNAGE:</b>  |  |
| <ul style="list-style-type: none"> <li>SIGNAGE LOCATIONS WILL NEED TO BE PROVIDED AND INSTALLED BY CONTRACTOR. TO BE SELECTED AND APPROVED BY ARCHITECT AND CLIENT PRIOR TO MANUFACTURER/PURCHASE TO BE PROVIDED BY TAKEFORM.</li> </ul>   |  |

| ACCESSORIES SCHEDULE |   |            |                                 |                                |  |
|----------------------|---|------------|---------------------------------|--------------------------------|--|
| MARK                 | ITEM  | MODEL #    | SUPPLIER                        | BACKUP SUPPORT                 | LOCATION/NOTES   |
| A                    | 42" HORIZONTAL GRAB BAR                             | B-680642   | BOBRICK WASHROOM EQUIPMENT, INC | PER MANUFACTURERS REQUIREMENTS | SEE DRAWING  |
| B                    | 36" HORIZONTAL GRAB BAR                             | B-680636   | BOBRICK WASHROOM EQUIPMENT, INC | PER MANUFACTURERS REQUIREMENTS | SEE DRAWING  |
| C                    | 18" VERTICAL GRAB BAR                               | B-680618   | BOBRICK WASHROOM EQUIPMENT, INC | PER MANUFACTURERS REQUIREMENTS | SEE DRAWING  |
| D                    | 1/4" 18"x36" FRAMELESS PLATE GLASS MIRROR           | TBD        | TBD                             | TBD                            | SPACERS TO BE USED BEHIND MIRROR FOR LEVEL APPLICATION. MIRRORS TO BE MOUNTED ON STAINLESS STEEL STAND 0915.   |
| E                    | SURFACE MOUNTED AUTOMATIC HAND SOAP DISPENSER       | 46100      | TORK                            | PER MANUFACTURERS REQUIREMENTS | SEE DRAWING. OPERABLE POINT LOCATED NO HIGHER THAN 48" AFF. COLOR: STAINLESS   |
| F                    | SURFACE MOUNTED TOILET TISSUE DISPENSER             | B-2888     | BOBRICK WASHROOM EQUIPMENT, INC | PER MANUFACTURERS REQUIREMENTS | SEE DRAWING.   |
| G                    | SURFACE MOUNTED HOT AIR HAND DRYER                  | AIRBLADE V | DYSON                           | PER MANUFACTURERS REQUIREMENTS | SEE DRAWING. CONTRACTOR TO PROVIDE EXACT OR EQUAL PRODUCT TO MEET SAME REQUIREMENTS. TO BE APPROVED BY CLIENT PRIOR TO ORDER/PURCHASE. COLOR: SPRAYED NICKEL |
| H                    | STAINLESS STEEL SURFACE MOUNTED COAT HOOK/DOOR STOP | B-212      | BOBRICK WASHROOM EQUIPMENT, INC | PER MANUFACTURERS REQUIREMENTS | BACK OF RESTROOM TOILET ROOM DOORS   |
| I                    | SURFACE MOUNTED SANITARY WASTE RECEPTACLE           | B-270      | BOBRICK WASHROOM EQUIPMENT, INC | PER MANUFACTURERS REQUIREMENTS | SEE DRAWING  |
| J                    | RECESSED WASTE RECEPTACLE                           | B-4944     | BOBRICK WASHROOM EQUIPMENT, INC | PER MANUFACTURERS REQUIREMENTS | SEE DRAWING  |
| K                    | STAINLESS STEEL TOILET PARTITIONS                   | SERIES 40  | GLOBAL PARTITIONS               | PER MANUFACTURERS REQUIREMENTS | FLOOR ANCHORED/OVERHEAD BRACED. REFER TO DRAWINGS. STAINLESS STEEL FINISH  |
| L                    | SURFACE MOUNTED AUTOMATIC PAPER TOWEL DISPENSER     | 46102      | TORK                            | PER MANUFACTURERS REQUIREMENTS | SEE DRAWING. COLOR: STAINLESS  |

| ROOM FINISH LEGEND         |                              |                             |
|----------------------------|------------------------------|-----------------------------|
| <b>FLOORS</b>              | <b>WALLS</b>                 | <b>MISCELLANEOUS</b>        |
| CPT = CARPET               | P = PAINT                    | PL = PLASTIC LAMINATE       |
| T = TILE                   | WT = WALL TILE               | SS = SOLID SURFACE          |
| LVT = LUXURY VINYL TILE    | FRP = FIBER REINFORCED PANEL | TS = TRANSITION STRIP       |
| VCT = VINYL COMPOSITE TILE | <b>CEILING</b>               | RSM = RUBBER STAIR MATERIAL |
| SF = VINYL SHEET FLOORING  | ACT = ACOUSTIC CEILING TILE  | MISC = MISCELLANEOUS        |
|                            | GYP = GYPSON BOARD           | DR = DRAPERY                |
| <b>BASE</b>                | MCS = METAL CEILING SYSTEM   | RS = ROLLER SHADES          |
| RB = RUBBER BASE           | <b>DOORS</b>                 | WDT = WOOD TREADS           |
| TB = TILE BASE             | WD = WOOD DOOR               | WV = WOOD VENEER            |
|                            |                              | WS = WOOD STAIN             |
|                            |                              | CG = CORNER GUARD           |
|                            |                              | <b>MATERIALS</b>            |
|                            |                              | P.B. = PARTICLE BOARD       |
|                            |                              | GYP. = GYPSON BOARD         |

| REVISION RECORD |            |             |
|-----------------|------------|-------------|
| NO.             | DATE       | REMARKS     |
| #1              | 09.06.2017 | ADDENDUM #1 |
| #2              | 09.07.2017 | ADDENDUM #2 |

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**BRYANT & STRATTON COLLEGE**  
1320 Warwick Way  
Mt. Pleasant, WI 53406

SEAL

**ROOM FINISH LEGEND & GENERAL NOTES**

GREGORY A. TOMSIC  
REGISTERED ARCHITECT  
145 BATHURST DR., TONAWANDA, N.Y. 14150  
716-435-0617

|                       |                          |
|-----------------------|--------------------------|
| SCALE<br>1/8" = 1'-0" | JOB NO.                  |
| DRAWN                 | DWG. NO.<br><b>A-606</b> |
| CHECKED               |                          |
| DATE<br>12.22.2017    | CONTRACT NO.             |

**ROOM FINISH SCHEDULE - FIRST FLOOR**


| ROOM NUMBER | ROOM NAME                    | BASE      | FLOOR       | WALLS         | MILLWORK       |                       | REMARKS |
|-------------|------------------------------|-----------|-------------|---------------|----------------|-----------------------|---------|
|             |                              |           |             |               | CABINET/SHROUD | COUNTERTOP/BACKSPLASH |         |
| 101         | ENTRY VESTIBULE              | TB-1      | T-1 / CPT-3 | P-1 / P-6     |                |                       | 1       |
| 102         | STORAGE                      | TB-1      | T-1         | P-1           |                |                       |         |
| 103         | RECEPTION                    | TB-1      | T-1         | P-1/P-6       | WV-1 / MISC-2  | SS-4                  |         |
| 104         | CORRIDOR                     | RB-1      | CPT-1       | P-1/P-2       |                |                       |         |
| 105         | TESTING                      | RB-1      | CPT-1       | P-1           |                |                       |         |
| 106         | MANAGER SHARED OFFICE        | RB-1      | CPT-1       | P-1 / P-4     |                |                       |         |
| 107         | OPEN OFFICE                  | RB-1      | CPT-1       | P-1/P-2       |                |                       | 6       |
| 108         | DIRECTOR OF ADMISSIONS       | RB-1      | CPT-1       | P-1 / P-4     |                |                       |         |
| 109         | MANAGER SHARED OFFICE        | RB-1      | CPT-1       | P-1 / P-4     |                |                       |         |
| 110         | MARKET MANAGER SHARED OFFICE | RB-1      | CPT-1       | P-1 / P-4     |                |                       |         |
| 111         | SKYPE 5                      | RB-1      | CPT-1       | P-1           |                |                       |         |
| 112         | STORAGE                      | RB-1      | CPT-1       | P-1           |                |                       |         |
| 113         | FACULTY ROOM                 | RB-1      | CPT-1       | P-1           |                |                       |         |
| 114         | STUDENT ADVISMENT            | RB-1      | CPT-1       | P-1           | PL-1           | PL-4                  |         |
| 115         | CONFERENCE ROOM              | RB-1      | CPT-1       | P-1/P-2       | PL-1           | SS-4                  |         |
| 116         | BREAK AREA                   | RB-1      | LVT-2       | P-1/WT-3      | PL-1           | SS-2                  |         |
| 117         | FILES/STORAGE                | RB-1      | CPT-1       | P-1           |                |                       |         |
| 118         | SUPPLIES                     | RB-1      | CPT-1       | P-1           |                |                       | 4       |
| 119         | COPY/MAIL                    | RB-1      | CPT-1       | P-1/P-2       | PL-1           | PL-4                  |         |
| 120         | COATS                        | RB-1      | CPT-1       | P-1           |                |                       |         |
| 121         | MA/RN OFFICE                 | RB-1      | CPT-1       | P-1           | PL-1           | PL-4                  |         |
| 122         | SKYPE 1                      | RB-1      | CPT-1       | P-1/P-3       |                |                       |         |
| 123         | SKYPE 2                      | RB-1      | CPT-1       | P-1/P-3       |                |                       |         |
| 124         | SKYPE 3                      | RB-1      | CPT-1       | P-1/P-3       |                |                       |         |
| 125         | JAN./ROOF ACCESS             | RB-1      | VCT-1       | P-1           |                |                       | 5       |
| 126         | CORRIDOR                     | RB-1      | LVT-1       | P-1/P-2       |                |                       | 3       |
| 127         | NURSING STORAGE              | RB-1      | LVT-1       | P-1           |                |                       |         |
| 128         | LEARNING COMMONS LOUNGE      | RB-1      | CPT-2       | P-1/P-5       |                |                       |         |
| 129         | LIBRARIAN'S OFFICE           | RB-1      | CPT-2       | P-1           |                |                       |         |
| 130         | PRIVATE TESTING              | RB-1      | CPT-2       | P-1           |                |                       |         |
| 131         | LEARNING COMMONS             | RB-1      | CPT-2       | P-1/P-5       | PL-1/MISC-2    | SS-2                  | 6       |
| 132         | CHEM LAB                     | RB-2      | SF-1/SF-2   | P-1           | PL-1           | SS-5                  | 6       |
| 133         | VESTIBULE                    | TB-1      | T-1         | P-1/P-6       |                |                       | 6       |
| 134         | SKYPE 4                      | RB-1      | LVT-2       | P-1/P-3       |                |                       |         |
| 135         | UTILITY ROOM                 | RB-1      | VCT-1       | P-1           |                |                       |         |
| 136         | STUDENT LOUNGE               | RB-1      | LVT-2       | P-1/P-5       | PL-1           | SS-2                  | 6       |
| 137         | RPZ                          | RB-1      | VCT-1       | P-1           |                |                       |         |
| 138         | 20 STUDENT CLASSROOM         | RB-1      | CPT-1       | P-1/P-3       |                |                       |         |
| 139         | 24 STUDENT CLASSROOM         | RB-1      | CPT-1       | P-1/P-3       | PL-1           | SS-2                  |         |
| 140         | CORRIDOR                     | RB-1      | LVT-1       | P-1           |                |                       | 3       |
| 141         | MEN'S RESTROOM               | --        | T-2/T-3     | WT-2/WT-4     | PL-2           | SS-1                  | 2       |
| 142         | WOMEN'S RESTROOM             | --        | T-2/T-3     | WT-2/WT-4     | PL-2           | SS-1                  | 2       |
| 143         | 24 STUDENT CLASSROOM         | RB-1      | CPT-1       | P-1/P-3       |                |                       |         |
| 144         | ELECTRIC                     | RB-1      | VCT-1       | P-1           |                |                       |         |
| 145         | 24 LECTURE                   | RB-1      | CPT-1       | P-1/P-3       |                |                       |         |
| 146         | CORRIDOR                     | RB-1      | LVT-1       | P-1/P-2       |                |                       | 3       |
| 147         | CORRIDOR                     | RB-1      | VCT-1       | P-1/P-2       |                |                       | 3       |
| 148         | NURSING LAB                  | RB-2/RB-3 | SF-1 / SF-2 | P-1/PL-1/WT-3 | PL-1           | SS-3                  | 1,6     |
| 149         | NURSING/MA                   | RB-2/RB-3 | SF-1 / SF-2 | P-1/PL-1      | PL-1           | SS-3                  | 1,6     |
| 150         | MA LAB                       | RB-2/RB-3 | SF-1 / SF-2 | P-1/PL-1/WT-3 | PL-1           | SS-3                  | 1,6     |
| 151         | CORRIDOR                     | RB-1      | LVT-1       | P-1           |                |                       | 3       |
| 152         | PATIO                        | --        | SC-1        |               |                |                       |         |

| ROOM FINISH LEGEND         |                              |                       |
|----------------------------|------------------------------|-----------------------|
| <b>FLOORS</b>              | <b>WALLS</b>                 | <b>MISCELLANEOUS</b>  |
| CPT = CARPET               | P = PAINT                    | PL = PLASTIC LAMINATE |
| T = TILE                   | WT = WALL TILE               | SS = SOLID SURFACE    |
| LVT = LUXURY VINYL TILE    | FRP = FIBER REINFORCED PANEL | TS = TRANSITION STRIP |
| VCT = VINYL COMPOSITE TILE |                              | MISC = MISCELLANEOUS  |
| SF = VINYL SHEET FLOORING  | <b>CEILING</b>               | DR = DRAPERY          |
|                            | ACT = ACOUSTIC CEILING TILE  | RS = ROLLER SHADES    |
| <b>BASE</b>                | GYP = GYPSUM BOARD           | WV = WOOD VENEER      |
| RB = RUBBER BASE           | MCS = METAL CEILING SYSTEM   | WS = WOOD STAIN       |
| TB = TILE BASE             | <b>DOORS</b>                 | CG = CORNER GUARD     |
|                            | WD = WOOD DOOR               |                       |
|                            |                              | <b>MATERIALS</b>      |
|                            |                              | P.B. = PARTICLE BOARD |
|                            |                              | GYP. = GYPSUM BOARD   |

| REMARKS  |
|--|
| 1. REFER TO REFLECTED CEILING PLAN FOR EXACT DETAILS (MATERIALS, HEIGHTS, SIZES, ETC.) FOR CEILING LAYOUT.               |
| 2. WALL TILE IN RESTROOMS WILL ACT AS WALL BASE. REFER TO A-400'S FOR EXACT TILE LAYOUT AND HEIGHTS.                     |
| 3. REFER TO A-608 FOR CORNER GUARD LOCATIONS.  |
| 4. (5) ADJUSTABLE PL-1 SHELVES TO BE INSTALLED AT SUPPLY CLOSET.   |
| 5. FRP-1 TO BE INSTALLED AT 4'-0" A.F.F. P-1 TO BE PAINTED ABOVE FRP.  |
| 6. REFER TO A-608 FINISH FLOOR PLAN FOR EXACT FLOORING PATTERNS. CONTACT ARCHITECT FOR CARPET & LVT INSTALLATION GUIDES. |

| REVISION RECORD |      |         |
|-----------------|------|---------|
| NO.             | DATE | REMARKS |
|                 |      |         |

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**BRYANT & STRATTON  
COLLEGE**  
1320 Warwick Way  
Mt. Pleasant, WI 53406

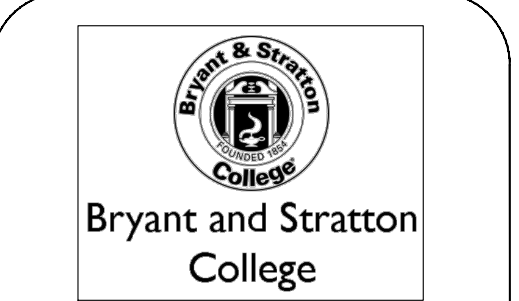
SCALE:

**ROOM FINISH  
SCHEDULE**

GREGORY A. TOMSIC  
REGISTERED ARCHITECT  
145 BATHURST DR., TONAWANDA, N.Y. 14150  
716-435-0617

|                       |                          |
|-----------------------|--------------------------|
| SCALE<br>1/8" = 1'-0" | JOB NO.                  |
| DRAWN                 | DWG. NO.<br><b>A-607</b> |
| CHECKED               |                          |
| DATE<br>12.22.2017    | CONTRACT NO.             |



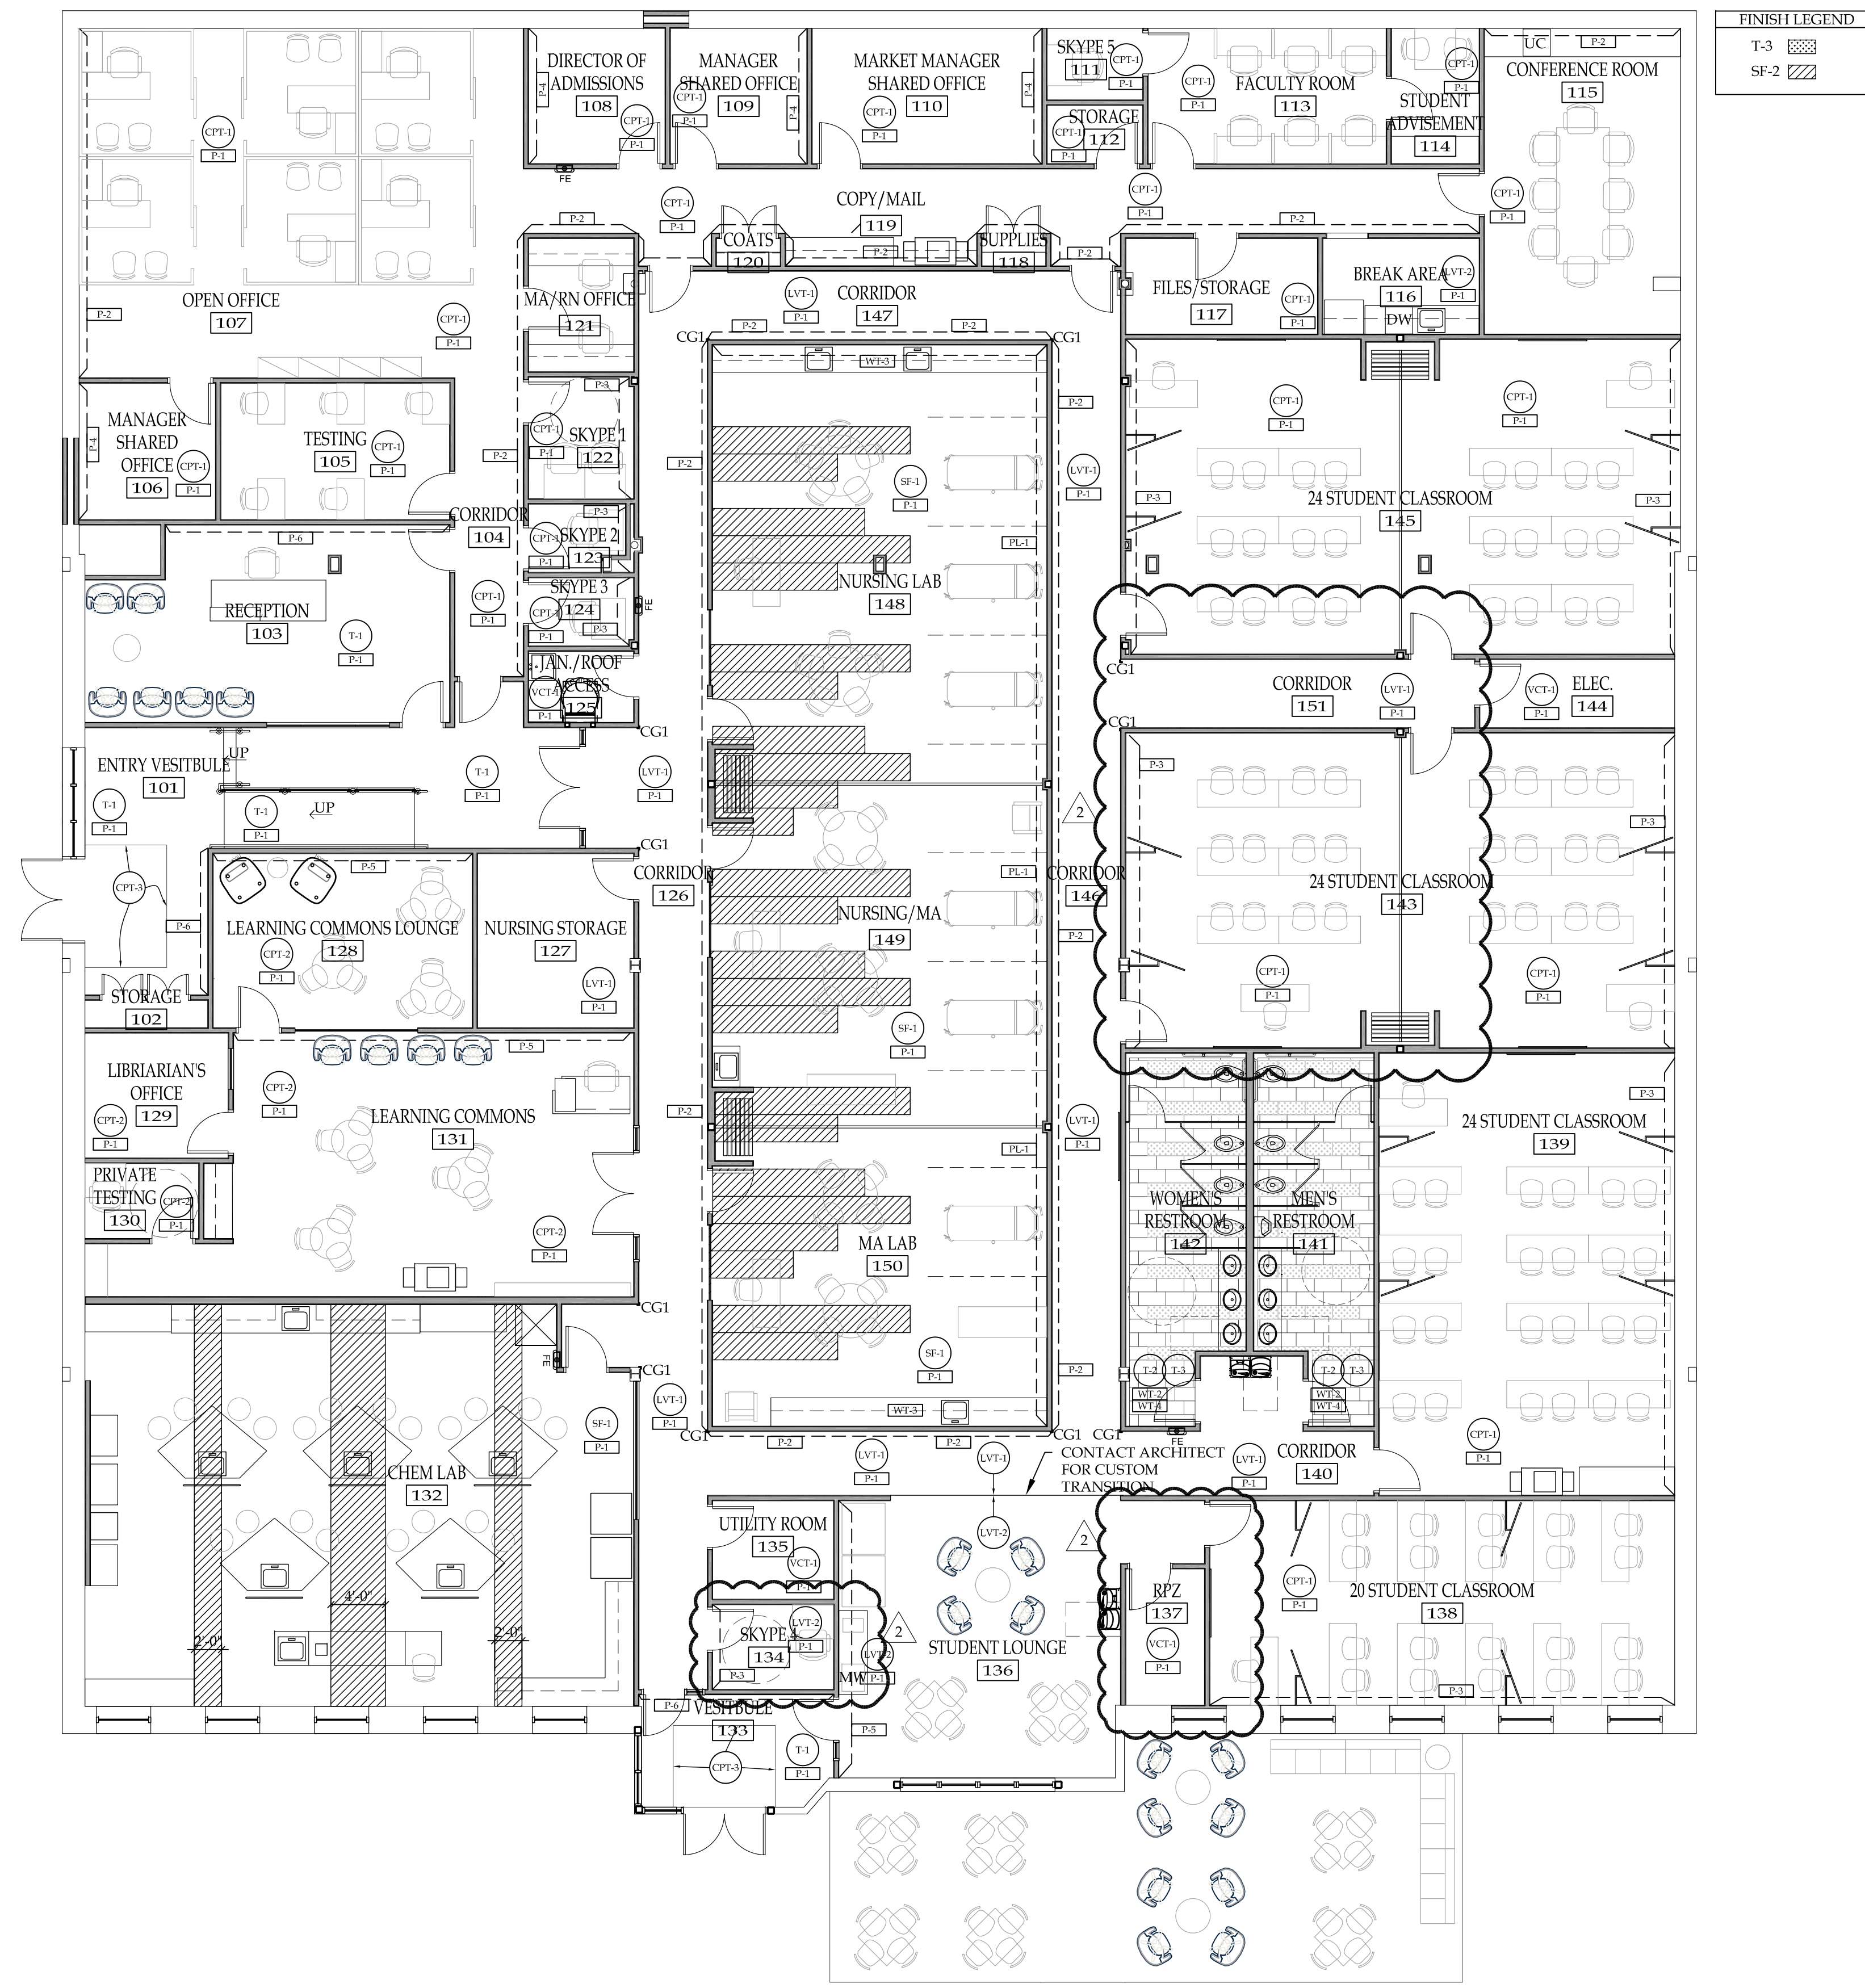

**FINISH LEGEND**

|      |           |
|------|-----------|
| T-3  | [Pattern] |
| SF-2 | [Pattern] |

**A1 FIRST FLOOR FINISH PLAN**  
SCALE: 1/8"=1'-0"


**REVISION RECORD**

| NO. | DATE       | REMARKS     |
|-----|------------|-------------|
| #2  | 01.10.2018 | ADDENDUM #2 |

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**BRYANT & STRATTON COLLEGE**  
1320 Warwick Way  
Mt. Pleasant, WI 53406



**FIRST FLOOR FINISH PLAN**

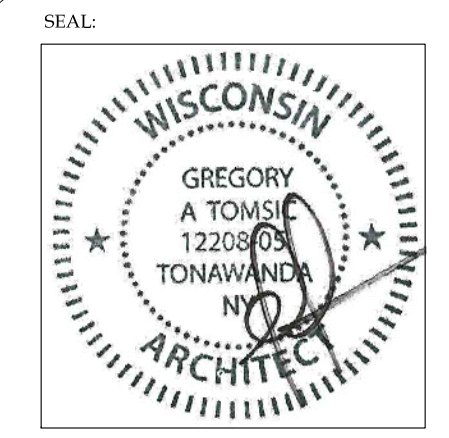**GREGORY A. TOMSIC**  
REGISTERED ARCHITECT  
145 BATHURST DR., TONAWANDA, N.Y. 14150  
716-433-0617

|                       |                          |
|-----------------------|--------------------------|
| SCALE<br>1/8" = 1'-0" | JOB NO.                  |
| DRAWN                 | DWG. NO.<br><b>A-608</b> |
| CHECKED               | CONTRACT NO.             |
| DATE<br>12.22.2017    |                          |